

# DULUTH INTERNATIONAL AIRPORT

**Director of Airports: Brian Ryks 4701 GRINDEN DRIVE - DULUTH INTERNATIONAL AIRPORT DULUTH, MINNESOTA 55811** 

FAA AIP No. - 3-27-0024-48-10 RS&H PROJ. No. - 213.1882.091 CITY OF DULUTH BID No. - 11-4403

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**NEW PASSENGER TERMINAL** BID PACKAGE 2B - ISSUED FOR BID VOLUME 1 OF 3 CIVIL, STRUCTURAL



**Construction Managers: KRAUS-ANDERSON.** 

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**AUGUST 23, 2011** 

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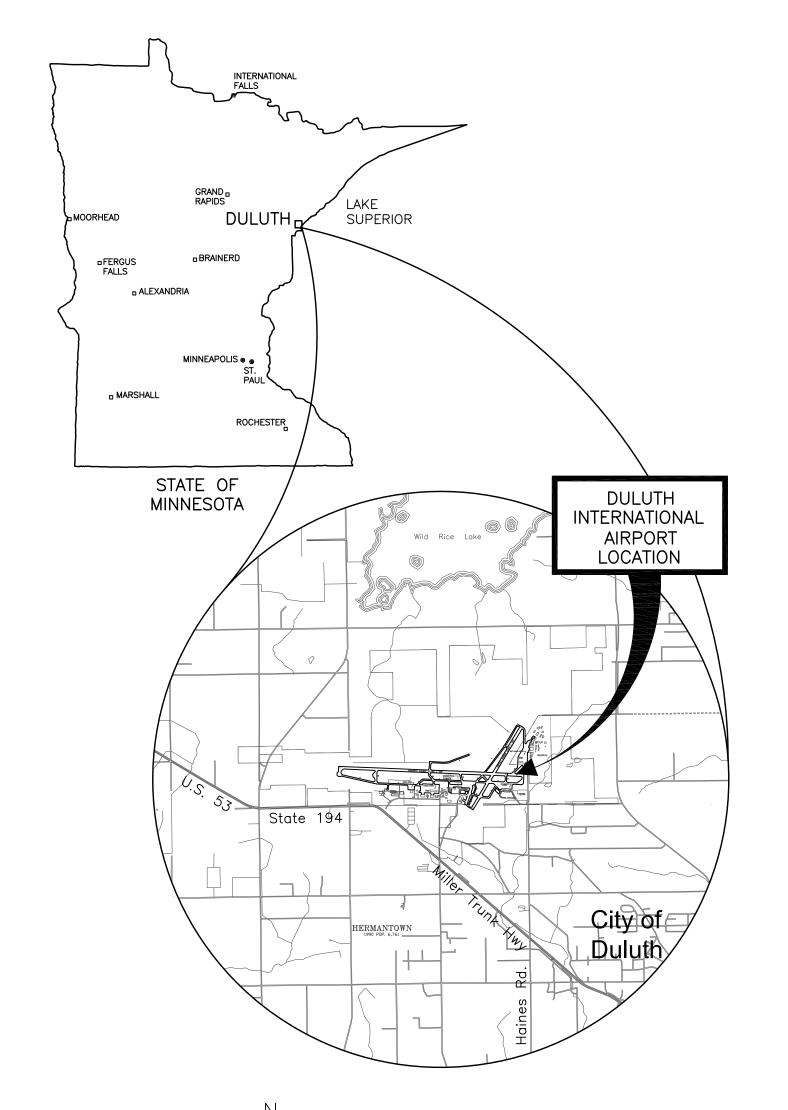
FIRE PROTECTION

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**LOCATION MAP** 



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**NEW PASSENGER** TERMINAL

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BNP ASSOCIATES INC.

ARCHITECTURAL CERTIFICATION I hereby certify that the architectural plans, specifications or report was prepared by me or under my direct supervision and that I am a duly licensed Professional Architect under the laws of the State of Minnesota.

Print Name: Mark Ip

Date: 06-03-10 Reg. No.: 46001

REVISIONS

NO. DESCRIPTION DATE BID PACKAGE 1 5.12.10 6.11.10 FOUNDATION PERMIT 1,2,3 NOT CHANGED CONFORMANCE SET 7.12.10 BUILDING PERMIT 8.16.10 11.12.10 BUILDING PERMIT REVISIONS BID PACKAGE 2A

5.2.11

7.6.11

**DATE ISSUED: 08-23-11** REVIEWED BY: SBS/TC DRAWN BY: MKG/MI

BP2A CONFORMANCE SET

BID PACKAGE 2B REVIEW

DESIGNED BY: SBS/TC **AEP PROJECT NUMBER** 

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> > SHEET TITLE **DRAWING**

SHEET NUMBER

**G101** 

**BID PACKAGE 2B ISSUED FOR BID** 

## SAFETY REQUIREMENTS

- 1. ALL CONTRACTOR VEHICLES SHALL DISPLAY IN FULL VIEW A FLASHING AMBER (YELLOW) DOME—TYPE LIGHT AND/OR ABOVE THE VEHICLE A 3' X 3' OR LARGER, ORANGE AND WHITE CHECKERBOARD FLAG, EACH CHECKERBOARD COLOR BEING 1—FOOT SQUARE, (SEE CONSTRUCTION SAFETY FLAG DETAIL, THIS SHEET).
- 2. DEBRIS, WASTE AND LOOSE MATERIAL CAPABLE OF CAUSING DAMAGE TO AIRCRAFT LANDING GEARS, PROPELLERS OR BEING INGESTED IN JET ENGINES SHALL NOT BE ALLOWED ON AIRSIDE PAVEMENTS. IF THESE MATERIALS ARE OBSERVED TO BE ON AIRSIDE PAVEMENTS, THEY WILL BE REMOVED IMMEDIATELY AND/OR CONTINUOUSLY BY THE CONTRACTOR DURING CONSTRUCTION.
- 3. THE CONTRACTOR IS DIRECTED TO COMPLY WITH AND ACQUAINT HIS/HER EMPLOYEES WITH THE FOLLOWING SAFETY GUIDELINES, RELATED MATERIALS AND FAA ADVISORY CIRCULARS:

150/5200-18C "AIRPORT SAFETY-SELF INSPECTION"
150/5210-5D "PAINTING, MARKING & LIGHTING OF VEHICLES USED ON AIRPORT

150/5210-5D "PAINTING, MARKING & LIGHTING OF VEHICLES USED ON AIRPORTS" 150/5370-2E "OPERATIONAL SAFETY ON AIRPORTS DURING CONSTRUCTION"

COPIES OF THESE DOCUMENTS ARE PROVIDED IN THE CONTRACT SPECIFICATIONS.

4. CONSTRUCTION DURING THE PROJECT MAY BE HALTED AT ANY TIME BY RPR, ENGINEER, AND/OR AIRPORT OPERATIONS IF IT IS DETERMINED TO BE IN THE BEST INTEREST OF AIRPORT OPERATIONS OR SAFETY. THE CONTRACTOR MAY BE DIRECTED TO REMOVE EQUIPMENT AND/OR EVACUATE THE SITE IN ORDER TO ENABLE AIRCRAFT OPERATIONS; COMMERCIAL, MILITARY OR GENERAL AVIATION NECESSARY EXTENSIONS IN CONTRACT TIME WILL BE GRANTED OR A STOP WORK ORDER WILL BE ISSUED DUE TO THESE DELAYS, HOWEVER, THERE WILL BE NO ADJUSTMENTS IN CONTRACT PRICE DUE TO THESE DELAYS.


IN ADDITION TO THE ABOVE, THE FOLLOWING SPECIAL REQUIREMENTS WILL APPLY FOR NIGHT CONSTRUCTION:

- a. A DAILY SAFETY AND PROGRESS MEETING SHALL BE HELD BETWEEN THE ENGINEER AND THE CONTRACTOR'S SUPERINTENDENT TO DISCUSS REQUIREMENTS FOR THE NEXT NIGHTTIME WORK PERIOD.
- b. THE CONTRACTOR SHALL PREPARE A SAFETY PLAN SPECIFIC TO NIGHTTIME CONSTRUCTION OPERATIONS, AS WELL AS A CONTINGENCY PLAN TO ADDRESS CASES OF ABNORMAL FAILURES OR UNEXPECTED DISASTERS USING APPENDIX 3 OF AC 150/5370-2E AS A GUIDE.
- 5. THE CONTRACTOR SHALL INSTALL ALL REQUIRED BARRICADES AT LOCATIONS DESIGNATED BY ENGINEER, HAVE ALL AOA ACCESS GATES GUARDED AND LOCKABLE, HAVE ALL EQUIPMENT EITHER FLAGGED OR FITTED WITH FLASHING YELLOW DOME—TYPE LIGHTS ON TOP OF THE VEHICLES. ALL THESE ITEMS SHALL CONSIST OF THE SAFETY AND SECURITY SYSTEM. THE CONTRACTOR SHALL INSTALL THE COMPONENTS OF THE SYSTEM AT THE APPROPRIATE TIMES AS SPECIFIED IN THE CONTRACT DOCUMENTS. THE CONTRACTOR SHALL INSPECT EVERY ASPECT OF THE SAFETY AND SECURITY SYSTEM ON AT LEAST A DAILY BASIS AND ENSURE ALL COMPONENTS ARE FUNCTIONING PROPERLY. THE RESIDENT PROJECT REPRESENTATIVE (RPR) SHALL ALSO DAILY INSPECT THE SYSTEM AND IF ANY DEFICIENCIES ARE NOTED, THE CONTRACTOR SHALL HAVE THAT DAY'S PRORATED SAFETY AND SECURITY COST DEDUCTED FROM THE CONTRACTOR'S EARNINGS. THE SYSTEM ELEMENTS TO BE INSPECTED AND DEFICIENCIES NOTED ARE AS FOLLOWS:
  - \*BARRICADES SET PROPERLY PER APPROVED CONTRACTOR SAFETY PLAN AND ALL FLASHING WARNING
  - LIGHTS OPERATING PROPERLY.
    \*ALL CONTRACTOR PERSONNEL AND EQUIPMENT ACCESS GATES MANNED OR LOCKED AND SECURITY
  - \*ALL CONTRACTOR PERSONNEL AND EQUIPMENT ACCESS GATES MANNED OR LOCKED AND SECURITY PROCEDURES IN PLACE.
  - \*ALL EQUIPMENT FLAGGED OR OUTFITTED WITH FLASHING YELLOW DOME-TYPE LIGHTS. \*CONTRACTOR USE OF UNAUTHORIZED AIRPORT ACCESS GATES CHECKED.

ANY OF THE ABOVE SAFETY AND SECURITY ITEMS FOUND TO BE DEFICIENT AT THE BEGINNING OF THE DAY BY THE RPR AND/OR AIRPORT OPERATIONS STAFF WILL RESULT IN THAT DAY'S PRORATED SAFETY AND SECURITY BID ITEM LOST AND BEING DEDUCTED PERMANENTLY FROM THE CONTRACTOR'S EARNINGS. THE CONTRACTOR SHALL MAKE A CONCERTED EFFORT TO ENSURE ALL SAFETY AND SECURITY ITEMS ARE IN PROPER WORKING ORDER EACH DAY DUE TO THE HEIGHTENED SECURITY STATUS OF THE AIRPORT AND THE CONSIDERABLE LIABILITY ASSOCIATED WITH THE SAFETY AND SECURITY WORK.

- 6. THE CONTRACTOR SHALL TAKE ALL PRECAUTIONS NECESSARY TO ENSURE THE SAFETY OF THE TRAVELING PUBLIC AS WELL AS HIS OWN EQUIPMENT AND PERSONNEL. SPECIAL CONSIDERATIONS SHOULD BE GIVEN TO FLIGHT SCHEDULES. THE CONTRACTOR SHALL OBEY ALL INSTRUCTIONS AS TO ROUTES TO BE TAKEN BY EQUIPMENT TRAVELING WITHIN THE AIRPORT AREA AND KEEP SUCH VEHICLES AND EQUIPMENT MARKED WITH THE SPECIFIED AIRPORT SAFETY FLAGS. THE CONTRACTOR SHALL MAKE HIS OWN ESTIMATE OF ALL DIFFICULTIES TO BE ENCOUNTERED. EQUIPMENT NOT ACTUALLY IN OPERATION SHALL BE KEPT CLEAR OF LANDING AREAS. PERSONNEL SHALL NOT ENTER AREAS OF THE AIRPORT WHERE AIRCRAFT ARE OPERATING WITHOUT SPECIFIC PERMISSION.
- 7. THE CONTRACTOR SHALL TAKE ALL STEPS TO PROTECT THE EXISTING UNDERGROUND CABLES AND COMMERCIAL, AIRPORT AUTHORITY AND MILITARY UTILITIES DURING CONSTRUCTION TO ASSURE CONTINUOUS OPERATION OF LIGHTS AND NAVIGATIONAL AIDS WHEN NEEDED.
- 8. MATERIALS STORED OR STOCKPILED ON THE AIRPORT SHALL BE SO PLACED AND THE WORK SHALL, AT ALL TIMES, BE SO CONDUCTED AS TO CAUSE NO GREATER OBSTRUCTION TO THE TRAVELING PUBLIC THAN IS CONSIDERED NECESSARY BY THE ENGINEER.
- 9. THE CONTRACTOR SHALL ERECT AND MAINTAIN ALL NECESSARY BARRICADES, SIGNS, DANGER SIGNALS AND LIGHTS FOR THE PROTECTION OF THE WORK AND THE SAFETY OF THE TRAVELING PUBLIC IN ACCORDANCE WITH THE SPECIFICATIONS (AC 150/5370-2E).
- 10. THE CONTRACTOR SHALL HAVE PERSONNEL ON CALL 24 HOURS PER DAY FOR EMERGENCY MAINTENANCE OF HAZARD LIGHTING AND BARRICADES.
- 11. THE AIRPORT DIRECTOR, WORKING THROUGH THE ENGINEER, SHALL, AT ALL TIMES, HAVE COMPLETE JURISDICTION OVER THE SAFETY OF ALL OPERATIONS DURING THE WORK. WHEREVER THE SAFETY OF THE TRAVELING PUBLIC IS CONCERNED, THE DECISIONS OF THE AIRPORT DIRECTOR OR HIS DESIGNATED REPRESENTATIVE, SHALL BE FINAL AS TO METHODS, PROCEDURES AND MEASURES USED.
- 12. THE CONTRACTOR SHALL CONTACT THE MINNESOTA AIRWAY FACILITIES SECTOR POINT OF CONTACT (POC) (ANDY GOMEZ AT 218-722-2826) TO PROVIDE FIELD LOCATIONS OF EXISTING FACILITY CABLES. THE CONTRACTOR SHALL BE RESPONSIBLE FOR HAND DIGGING TO LOCATE FACILITY CABLING, AND PROTECTION OF THOSE CABLES THROUGHOUT THE PROJECT.
- 13. THE CONTRACTOR SHALL CONFINE HIS PERSONNEL, EQUIPMENT, OPERATIONS AND TRAVEL TO THE AREA WITHIN THE DEFINED WORK LIMITS SHOWN ON THE PLANS.
- 14. THE CONTRACTOR SHALL INFORM ALL CONSTRUCTION PERSONNEL AS TO THE PROPER ROUTES, SPEEDS AND PROCEDURES FOR TRANSPORTING EQUIPMENT AND MATERIALS TO THE CONSTRUCTION SITE. ON A DAILY BASIS AND MORE OFTEN IF NECESSARY ALL PERSONNEL SHALL BE ADVISED OF ANY CHANGES IN AIRPORT OPERATIONS THAT MAY FURTHER RESTRICT HIS MOVEMENT.
- 15. ACCESS OR HAUL ROUTES SHALL BE EXISTING ROADWAYS TO THE EXTENT THAT THEY ARE AVAILABLE. THE CONTRACTOR SHALL CORRECT ANY DAMAGE TO THE ROADS USED AND SHALL RESTORE THOSE ROADS TO THE SAME OR BETTER CONDITION AS THEY EXISTED PRIOR TO THE START OF WORK. THE CONTRACTOR MAY ESTABLISH ADDITIONAL HAUL OR ACCESS ROUTES AT HIS OWN EXPENSE AND RESPONSIBILITY IF APPROVED BY THE SPONSOR. UPON COMPLETION OF THE WORK, ANY ADDITIONAL ROADS SHALL EITHER BE LEFT OR GRADED AS DIRECTED SO THAT THEY DO NOT IMPEDE THE EXISTING DRAINAGE OR ACCESS ROUTES. CONTRACTOR IS RESPONSIBLE FOR DOCUMENTING EXISTING DISTRESS WITH PHOTOS, LOCATION, AND/OR VIDEO.

- 16. MEASURES SHALL BE ADOPTED TO PREVENT POTENTIAL POLLUTANTS FROM ENTERING ANY DRAINAGE SYSTEM OR WATERWAY. MATERIALS AND DEBRIS SHALL NOT BE STORED IN THE WORK AREA IN A MANNER THAT WOULD ALLOW THEM TO ENTER THE DRAINAGE SYSTEM AS A RESULT OF SPILLAGE, NATURAL RUNOFF OR FLOODING. IT SHALL BE THE RESPONSIBILITY OF THE CONTRACTOR TO IMMEDIATELY NOTIFY THE SPONSOR SHOULD THERE BY A SPILLAGE OF MATERIAL WHICH MIGHT CONTAMINATE THE DRAINAGE SYSTEM. IT SHALL ALSO BE THE CONTRACTOR'S RESPONSIBILITY TO REMOVE AND CLEAR UP SUCH SPILLAGE IN A MANNER ACCEPTABLE TO THE SPONSOR. MATERIAL SHALL BE SECURED SO THAT IT WILL NOT BE BLOWN BY THE WIND ONTO THE AIRFIELD SURFACES.
- 17. SPECIAL ATTENTION TO DUST CONTROL WILL BE REQUIRED WHEN EARTHWORK OR HAULING OPERATIONS ARE IN PROGRESS OR WHEN WIND AND WEATHER CONDITIONS CAUSE EXCESSIVE BLOWING OF DUST. IN THIS REGARD, THE CONTRACTOR SHALL APPLY WATER OR CALCIUM CHLORIDE SOLUTION TO THE AFFECTED SITES AS DIRECTED.
- 18. VEHICLES WITHIN THE SECURITY FENCE SHALL BE VISIBLY IDENTIFIABLE AS CONTRACTOR VEHICLES WHICH HAVE BEEN PROPERLY CLEARED FOR ENTRY (LOGO AND FLAGS ON AUTHORIZED EQUIPMENT AND VEHICLES WOULD BE ACCEPTABLE.)
- 19. CONSTRUCTION EQUIPMENT SHALL HAVE A MAXIMUM HEIGHT OF TWENTY-FIVE (25) FEET.
- 20. THE CONTRACTOR SHALL SUBMIT A SAFETY AND SECURITY PLAN TO THE ENGINEER FOR REVIEW AND APPROVAL BY THE AIRPORT AUTHORITY PRIOR TO CONSTRUCTION COMMENCING.
- 21. THE CONTRACTOR SHALL BE RESPONSIBLE FOR LOCATING UTILITY LINES AND HAND DIGGING TO LOCATE FAA CABLING AND SHALL PROVIDE ADEQUATE PROVISIONS TO PROTECT ALL FAA CABLES EXPOSED DURING THE PROPOSED WORK. THE SPONSOR/CONTRACTOR SHALL BE RESPONSIBLE FOR NOTIFYING THE AIRWAY FACILITY SMO AT THE PROJECT PRECONSTRUCTION MEETING SHOULD CABLE RELOCATION BE NECESSARY.
- 22. ANY DAMAGE TO FAA CABLES, ACCESS ROADS, OR TO FAA FACILITIES DURING THE CONSTRUCTION WILL REQUIRE THE CONTRACTOR TO REPLACE THE DAMAGED CABLES, ACCESS ROAD, OR FAA FACILITIES TO THE AF SMO'S REQUIREMENTS. AND AT THE CONTRACTORS' EXPENSE.
- 23. IF ANY FAA POWER, CONTROL, OR SIGNAL CABLES ARE DAMAGED, THE SPONSOR/CONTRACTOR SHALL REPLACE THE CABLE IN ITS ENTIRETY. THE SPLICING OF CABLES IS NOT AN ACCEPTABLE FORM OF REPAIR.

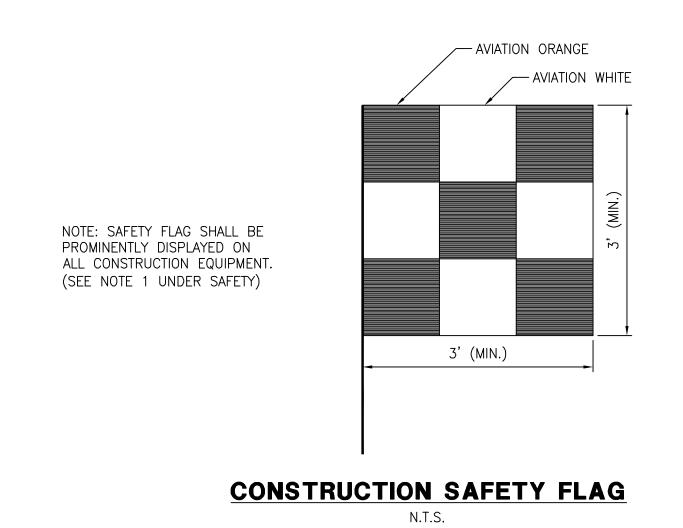

#### SECURITY REQUIREMENTS

- 1. <u>GENERAL INTENT:</u> IT IS INTENDED THAT THE CONTRACTOR SHALL COMPLY WITH ALL REQUIREMENTS OF THE AIRPORT SECURITY PLAN AND WITH THE SECURITY REQUIREMENTS SPECIFIED HEREIN BY AIRPORT OPERATIONS. THE CONTRACTOR SHALL DESIGNATE TO THE ENGINEER AND AIRPORT OPERATIONS, IN WRITING, THE NAME OF HIS "CONTRACTOR SECURITY AND SAFETY OFFICER (CSSO)." THE CSSO SHALL REPRESENT THE CONTRACTOR ON THE SECURITY REQUIREMENTS FOR THE CONTRACT.
- 2. CONTRACTOR PERSONNEL SECURITY ORIENTATION: THE CSSO SHALL BE RESPONSIBLE FOR BRIEFING ALL CONTRACTOR PERSONNEL ON SECURITY REQUIREMENTS. ALL NEW CONTRACTOR EMPLOYEES SHALL BE BRIEFED ON SECURITY REQUIREMENTS PRIOR TO WORKING IN THE CONSTRUCTION AREA. THE AIRPORT SHALL BRIEF AND/OR TRAIN CONSTRUCTION RELATED VEHICLE EQUIPMENT DRIVERS ON OPERATIONS WITHIN AN AIRPORT/AIRCRAFT ENVIRONMENT. AIRPORT MANAGEMENT SHOULD PROVIDE PRINTED MATERIAL TO EACH VEHICLE OPERATOR THAT DEPICTS HAUL ROUTES, PROHIBITED MOVEMENT AREAS, AND DESCRIBES THE CONSEQUENCES FOR NON—COMPLIANCE WITH ESTABLISHED PROCEDURES. THE AIRPORT HAS IMPLEMENTED A ZERO TOLERANCE APPROACH TO DRIVING VIOLATIONS.
- 3. ACCESS TO THE SITE: CONTRACTOR'S ACCESS TO THE SITE SHALL BE AS SHOWN ON THE PLANS. NO OTHER ACCESS POINTS SHALL BE ALLOWED UNLESS APPROVED BY AIRPORT OPERATIONS. ALL CONTRACTOR TRAFFIC AUTHORIZED TO ENTER THE SITE SHALL BE EXPERIENCED IN THE ROUTE OR GUIDED BY CONTRACTOR PERSONNEL. THE CONTRACTOR SHALL BE RESPONSIBLE FOR TRAFFIC CONTROL TO AND FROM THE VARIOUS CONSTRUCTION AREAS ON THE SITE, AND FOR THE OPERATION AND SECURITY OF THE ACCESS GATE TO THE SITE. A CONTRACTOR'S FLAGMAN OR TRAFFIC CONTROL PERSON SHALL MONITOR AND COORDINATE ALL CONTRACTOR TRAFFIC AT THE ACCESS GATE WITH SECURITY. THE CONTRACTOR SHALL NOT PERMIT ANY UNAUTHORIZED CONSTRUCTION PERSONNEL OR TRAFFIC ON THE SITE. ACCESS GATES TO THE SITE SHALL BE LOCKED AND SECURED AT ALL TIMES WHEN NOT ATTENDED BY THE CONTRACTOR. IF THE CONTRACTOR CHOOSES TO LEAVE ANY ACCESS GATE OPEN, IT SHALL BE ATTENDED BY CONTRACTOR PERSONNEL WHO ARE FAMILIAR WITH THE REQUIREMENTS OF THE AIRPORT OPERATIONS SECURITY PROGRAM. THE CONTRACTOR IS RESPONSIBLE FOR THE IMMEDIATE CLEANUP OF ANY DEBRIS DEPOSITED ALONG THE ACCESS ROUTE AS A RESULT OF HIS CONSTRUCTION TRAFFIC. DIRECTIONAL SIGNING FROM THE ACCESS GATE ALONG THE DELIVERY ROUTE TO THE STORAGE AREA, PLANT SITE OR WORK SITE SHALL BE AS DIRECTED BY AIRPORT OPERATIONS.
- 4. MATERIALS DELIVERY TO THE SITE: ALL CONTRACTOR'S MATERIAL ORDERS FOR DELIVERY TO THE WORK SITE WILL USE AS A DELIVERY ADDRESS, THE STREET NAME ASSIGNED TO THE ACCESS POINT AT THE CONTRACTOR'S STAGING SITE AT THE AIRPORT. THE NAME "DULUTH INTERNATIONAL AIRPORT" SHALL NOT BE USED IN THE DELIVERY ADDRESS AT ANY TIME. THIS WILL PRECLUDE DELIVERY TRUCKS FROM ENTERING INTO THE TERMINAL COMPLEX, OR TAKING SHORT CUTS THROUGH THE PERIMETER GATES AND ENTERING INTO AIRCRAFT OPERATIONS AREAS INAPPROPRIATELY.
- 5. <u>CONSTRUCTION AREA LIMITS:</u> THE LIMITS OF CONSTRUCTION, MATERIAL STORAGE AREAS, PLANT SITE, EQUIPMENT STORAGE AREA, PARKING AREA AND OTHER AREAS DEFINED AS REQUIRED FOR THE CONTRACTOR'S EXCLUSIVE USE DURING CONSTRUCTION SHALL BE MARKED BY THE CONTRACTOR. THE CONTRACTOR SHALL ERECT AND MAINTAIN AROUND THE PERIMETER OF THESE AREAS SUITABLE FENCING, MARKING AND/OR WARNING DEVICES VISIBLE FOR DAY/NIGHT USE. TEMPORARY BARRICADES, FLAGGING AND FLASHING WARNING LIGHTS WILL BE REQUIRED AT CRITICAL ACCESS POINTS. TYPE OF MARKING AND WARNING DEVICES SHALL BE APPROVED BY AIRPORT OPERATIONS.
- 6. IDENTIFICATION——PERSONNEL: ALL EMPLOYEES, AGENTS, VENDORS, INVITEES, ETC. OF THE CONTRACTOR OR SUBCONTRACTORS REQUIRING ACCESS TO THE AIRCRAFT OPERATIONS AREA (AOA) SHALL, IN ACCORDANCE WITH THE AIRPORT OPERATIONS SECURITY PROGRAM, BE REQUIRED TO DISPLAY AIRPORT ISSUED IDENTIFICATION OR BE UNDER ESCORT BY PROPERLY BADGED PERSONNEL. THESE BADGES WILL BE IDENTIFIED NUMERICALLY AND ISSUED TO INDIVIDUAL EMPLOYEES WITH A PERMANENT RECORD MAINTAINED ON EACH INDIVIDUAL TO WHOM A BADGE IS ISSUED. AT THE COMPLETION OF THE CONTRACT ALL BADGES WILL BE RETURNED TO THE AIRPORT AND A CHARGE OF \$50 PER BADGE WILL BE ASSESSED FOR ALL BADGES NOT RETURNED. IN ADDITION, A \$65 NON—REFUNDABLE PROCESSING FEE WILL BE REQUIRED FOR EACH BADGE. THIS FEE WILL BE PAID BEFORE BADGE IS ISSUED. NO BADGE WILL BE ISSUED TO ANY PERSON UNTIL A REVIEW OF REQUIRED PAPERWORK BY AIRPORT SECURITY AND ALL REQUIREMENTS ARE MET. PAPERWORK SHALL BE SUBMITTED A MINIMUM OF 24 HOURS BEFORE ISSUANCE OF BADGE. IDENTIFIABLE HARD HATS OR OTHER IDENTIFICATION SHALL ALSO BE WORN AT ALL TIMES IF REQUIRED BY AIRPORT OPERATIONS. THE CONTRACTOR AND ITS STAFF IS RESPONSIBLE FOR ATTENDING TRAINING AND COMPLETING SECURITY BADGE APPLICATIONS, WHICH WILL INCLUDE AIR/GROUND RADIO, TAXIWAY AND AIRPORT FAMILIARIZATION. ESTIMATED TIME FOR COMPLETION IS 2 HOURS.
- . <u>IDENTIFICATION—VEHICLES:</u> THE CONTRACTOR, THROUGH THE CSSO, SHALL ESTABLISH AND MAINTAIN A LIST OF CONTRACTOR AND SUBCONTRACTOR VEHICLES AUTHORIZED TO OPERATE ON THE SITE AND SHALL ISSUE A PERMIT TO EACH VEHICLE TO BE MADE AVAILABLE UPON DEMAND BY AIRPORT OPERATIONS THE RPR OR ANY AIRPORT REPRESENTATIVES. A BLOCK OF VEHICLE PERMITS SHALL BE ISSUED BY AIRPORT OPERATIONS TO THE CONTRACTOR AND AT THE COMPLETION OF THE CONTRACT ALL PERMITS WILL BE RETURNED TO THE AIRPORT AND A CHARGE OF \$25 PER PERMIT WILL BE ASSESSED FOR ALL PERMITS NOT RETURNED. CONTRACTOR EMPLOYEE VEHICLES SHALL BE RESTRICTED TO THE CONTRACTOR'S EMPLOYEE PARKING AREA AND ARE NOT ALLOWED ON THE AOA AT ANY TIME.
- 8. <u>FINES:</u> PAYMENT OF ALL FINES ASSESSED TO DULUTH INTERNATIONAL AIRPORT DUE TO VIOLATIONS BY THE CONTRACTOR OF FAA/TSA SECURITY OR SAFETY REQUIREMENTS SHALL BE THE SOLE RESPONSIBILITY OF THE CONTRACTOR AND SHALL BE DEDUCTED FROM MONIES DUE THE CONTRACTOR.
- A. IF THE RESTRICTED AREA GATE IS FOUND TO BE OPEN OR UNLOCKED AND UNATTENDED, AIRPORT SECURITY POLICE AND/OR TSA MAY ISSUE THE CONTRACTOR A CITATION. THE CONTRACTOR SHALL BE RESPONSIBLE FOR ALL COURT COSTS IMPOSED FINES. IN ADDITION, A CHARGE OF UP TO \$10,000.00 MAY BE LEVIED BY THE DULUTH AIRPORT AUTHORITY AND/OR TSA FOR EACH VIOLATION SO DOCUMENTED AND UPON THE REQUEST FOR FINAL PAYMENT THE TOTAL OF ANY SUCH CHARGES WILL BE DEDUCTED FROM MONIES DUE THE CONTRACTOR.
- B. IN THE EVENT THE CONTRACTOR DEVIATES FROM THE IDENTIFIED CONSTRUCTION LIMITS AND/OR DESIGNATED HAUL ROUTES ONTO AN ACTIVE RUNWAY OR TAXIWAY THE CONTRACTOR WILL BE FINED \$1,000 PER OCCURRENCE WHICH WILL BE DEDUCTED FROM THE FINAL CONTRACT AMOUNT DUE THE CONTRACTOR
- 9. A MINIMUM OF 48 HOURS IN ADVANCE OF ANY EXCAVATION OR BORINGS, THE CONTRACTOR SHALL CONTACT THE FOLLOWING LOCAL CABLE OWNERS AS WELL AS A PRIVATE LOCATOR TO VERIFY ALL UNDERGROUND CABLE LOCATIONS IN THE VICINITY OF THE PROPOSED WORK:

CABLE OWNERCONTACT PERSONPHONE NUMBERFEDERAL AVIATION ADMINISTRATION<br/>Mn AIR NATIONAL GUARD<br/>DULUTH AIRPORT AUTHORITYANDY GOMEZ<br/>WORK CONTROL<br/>TOM WERNER<br/>GOPHER STATE ONE-CALL218-727-2826<br/>218-727-6522<br/>218-727-6522<br/>GOPHER STATE ONE-CALL

10. RESPONSIBILITY FOR TEMPORARY LIGHTING AND MARKING

THE CONTRACTOR WILL BE RESPONSIBLE FOR FURNISHING AND MAINTAINING THE NECESSARY BARRICADES AND HAZARD LIGHTING AS REQUIRED BY THE SPECIFICATIONS TO MARK CONSTRUCTION AREAS, HAZARDS, ETC. REFLECTORIZED ORANGE PLASTIC BARRELS WITH ATTACHED FLASHING RED LIGHTS FOR NIGHT USE ARE THE PREFERRED TYPE OF BARRICADE FOR USE ON THE AIRPORT.

11. CONSTRUCTION ACTIVITY IN THE VICINITY OF NAVIGATIONAL AIDS

48 HOURS PRIOR TO THE PRE CONSTRUCTION CONFERENCE AND/OR CONSTRUCTION START, THE CONTRACTOR SHALL CONTACT THE LOCAL AIRWAY FACILITIES MANAGER AT (218) 727—2826. HE OR HIS REPRESENTATIVE WILL MEET WITH THE CONTRACTOR TO IDENTIFY FAA FACILITIES AND FAA CABLES.

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**AUTHORITY** 

DULUTH INTERNATIONAL AIRPORT

NEW PASSENGER TERMINAL

DULUTH, MN

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DESIGNED BY: JEH

AEP PROJECT NUMBER
213-1882-091

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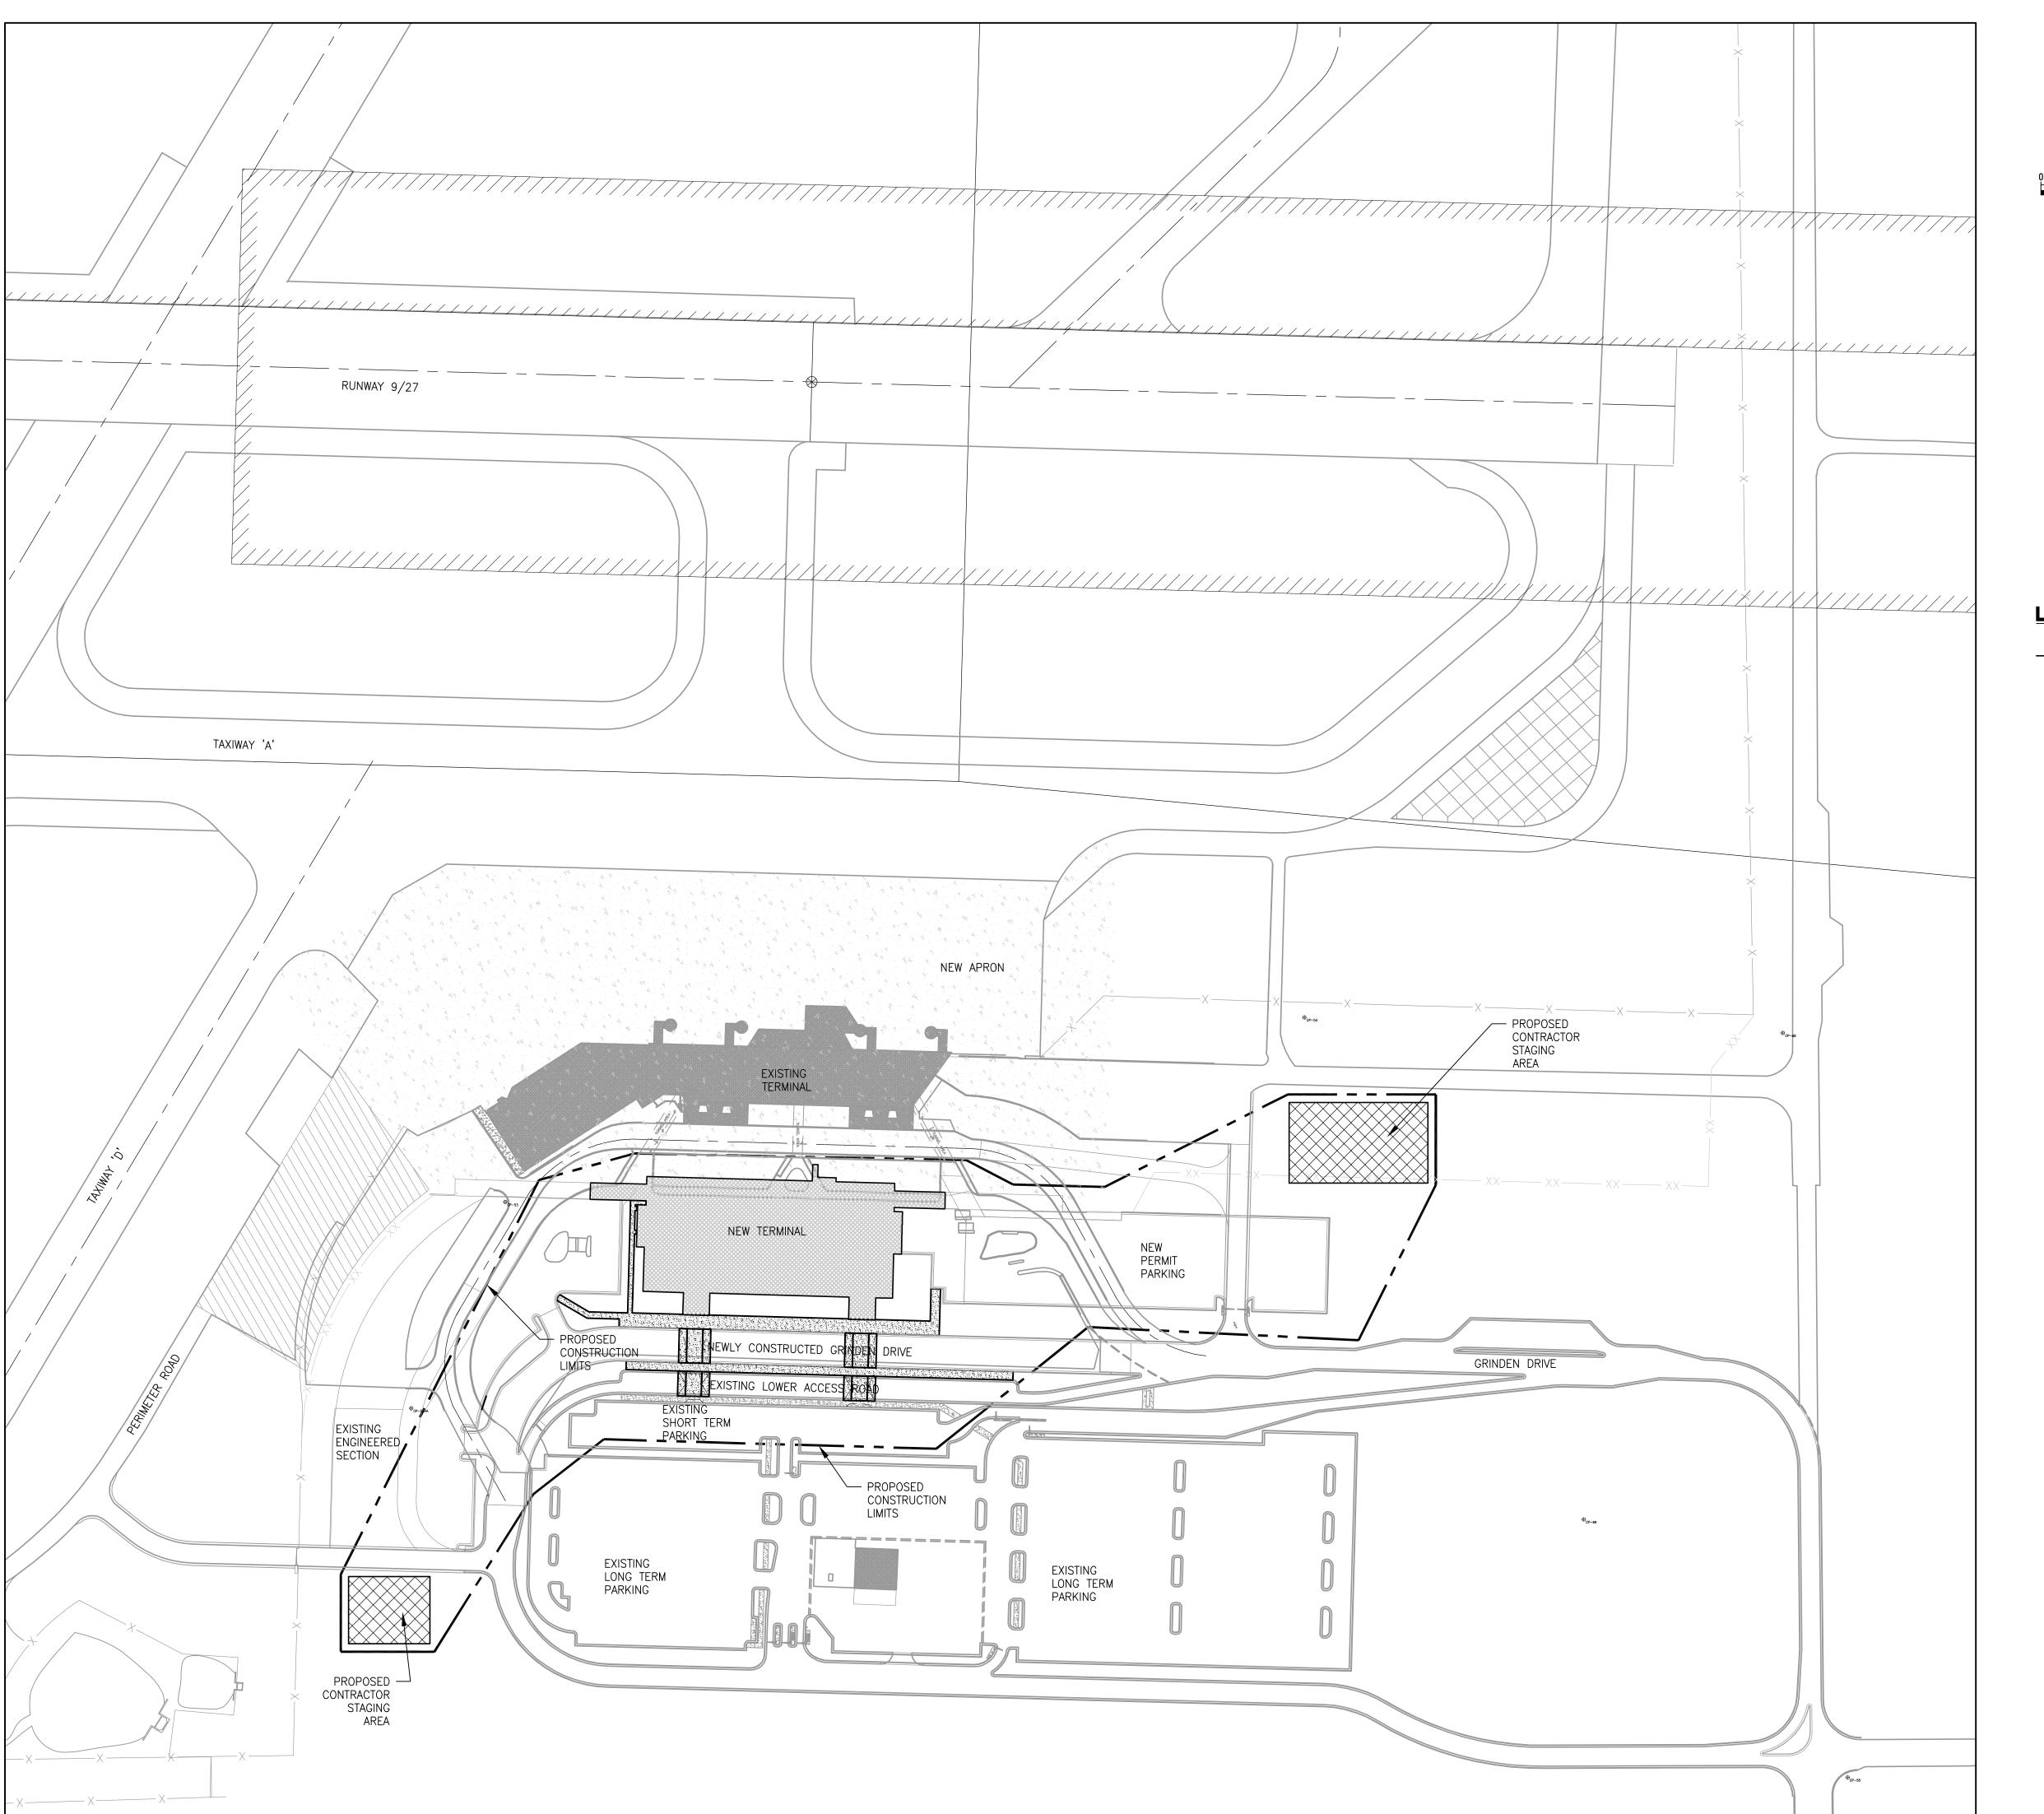
SAFETY AND SECURITY NOTES AND DETAILS


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C002

BID PACKAGE 2B ISSUED FOR BID FOR REFERENCE ONLY

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## **LEGEND**

PROPOSED GRADING LIMITS

PROPOSED CONTRACTOR STAGING AREA

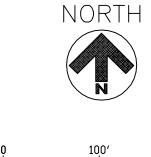PROPOSED TERMINAL



EXISTING TERMINAL & BUILDINGS



PROPOSED CONCRETE PAVEMENT

FUTURE APRON (N.I.C.)

## **CSPP NOTES**

- 1. GRINDEN DRIVE WILL BE THE ONLY HAUL ROUTE USED BY THE CONTRACTOR.
- 2. ALL CONSTRUCTION FOR BID PACKAGE 2A WILL TAKE PLACE OUTSIDE OF THE AIRPORT OPERATIONS AREA.
- 3. NORTHINGS AND EASTINGS GIVEN IN PROJECT ARE IN MINNESOTA STATE PLANE NORTH COORDINATES.

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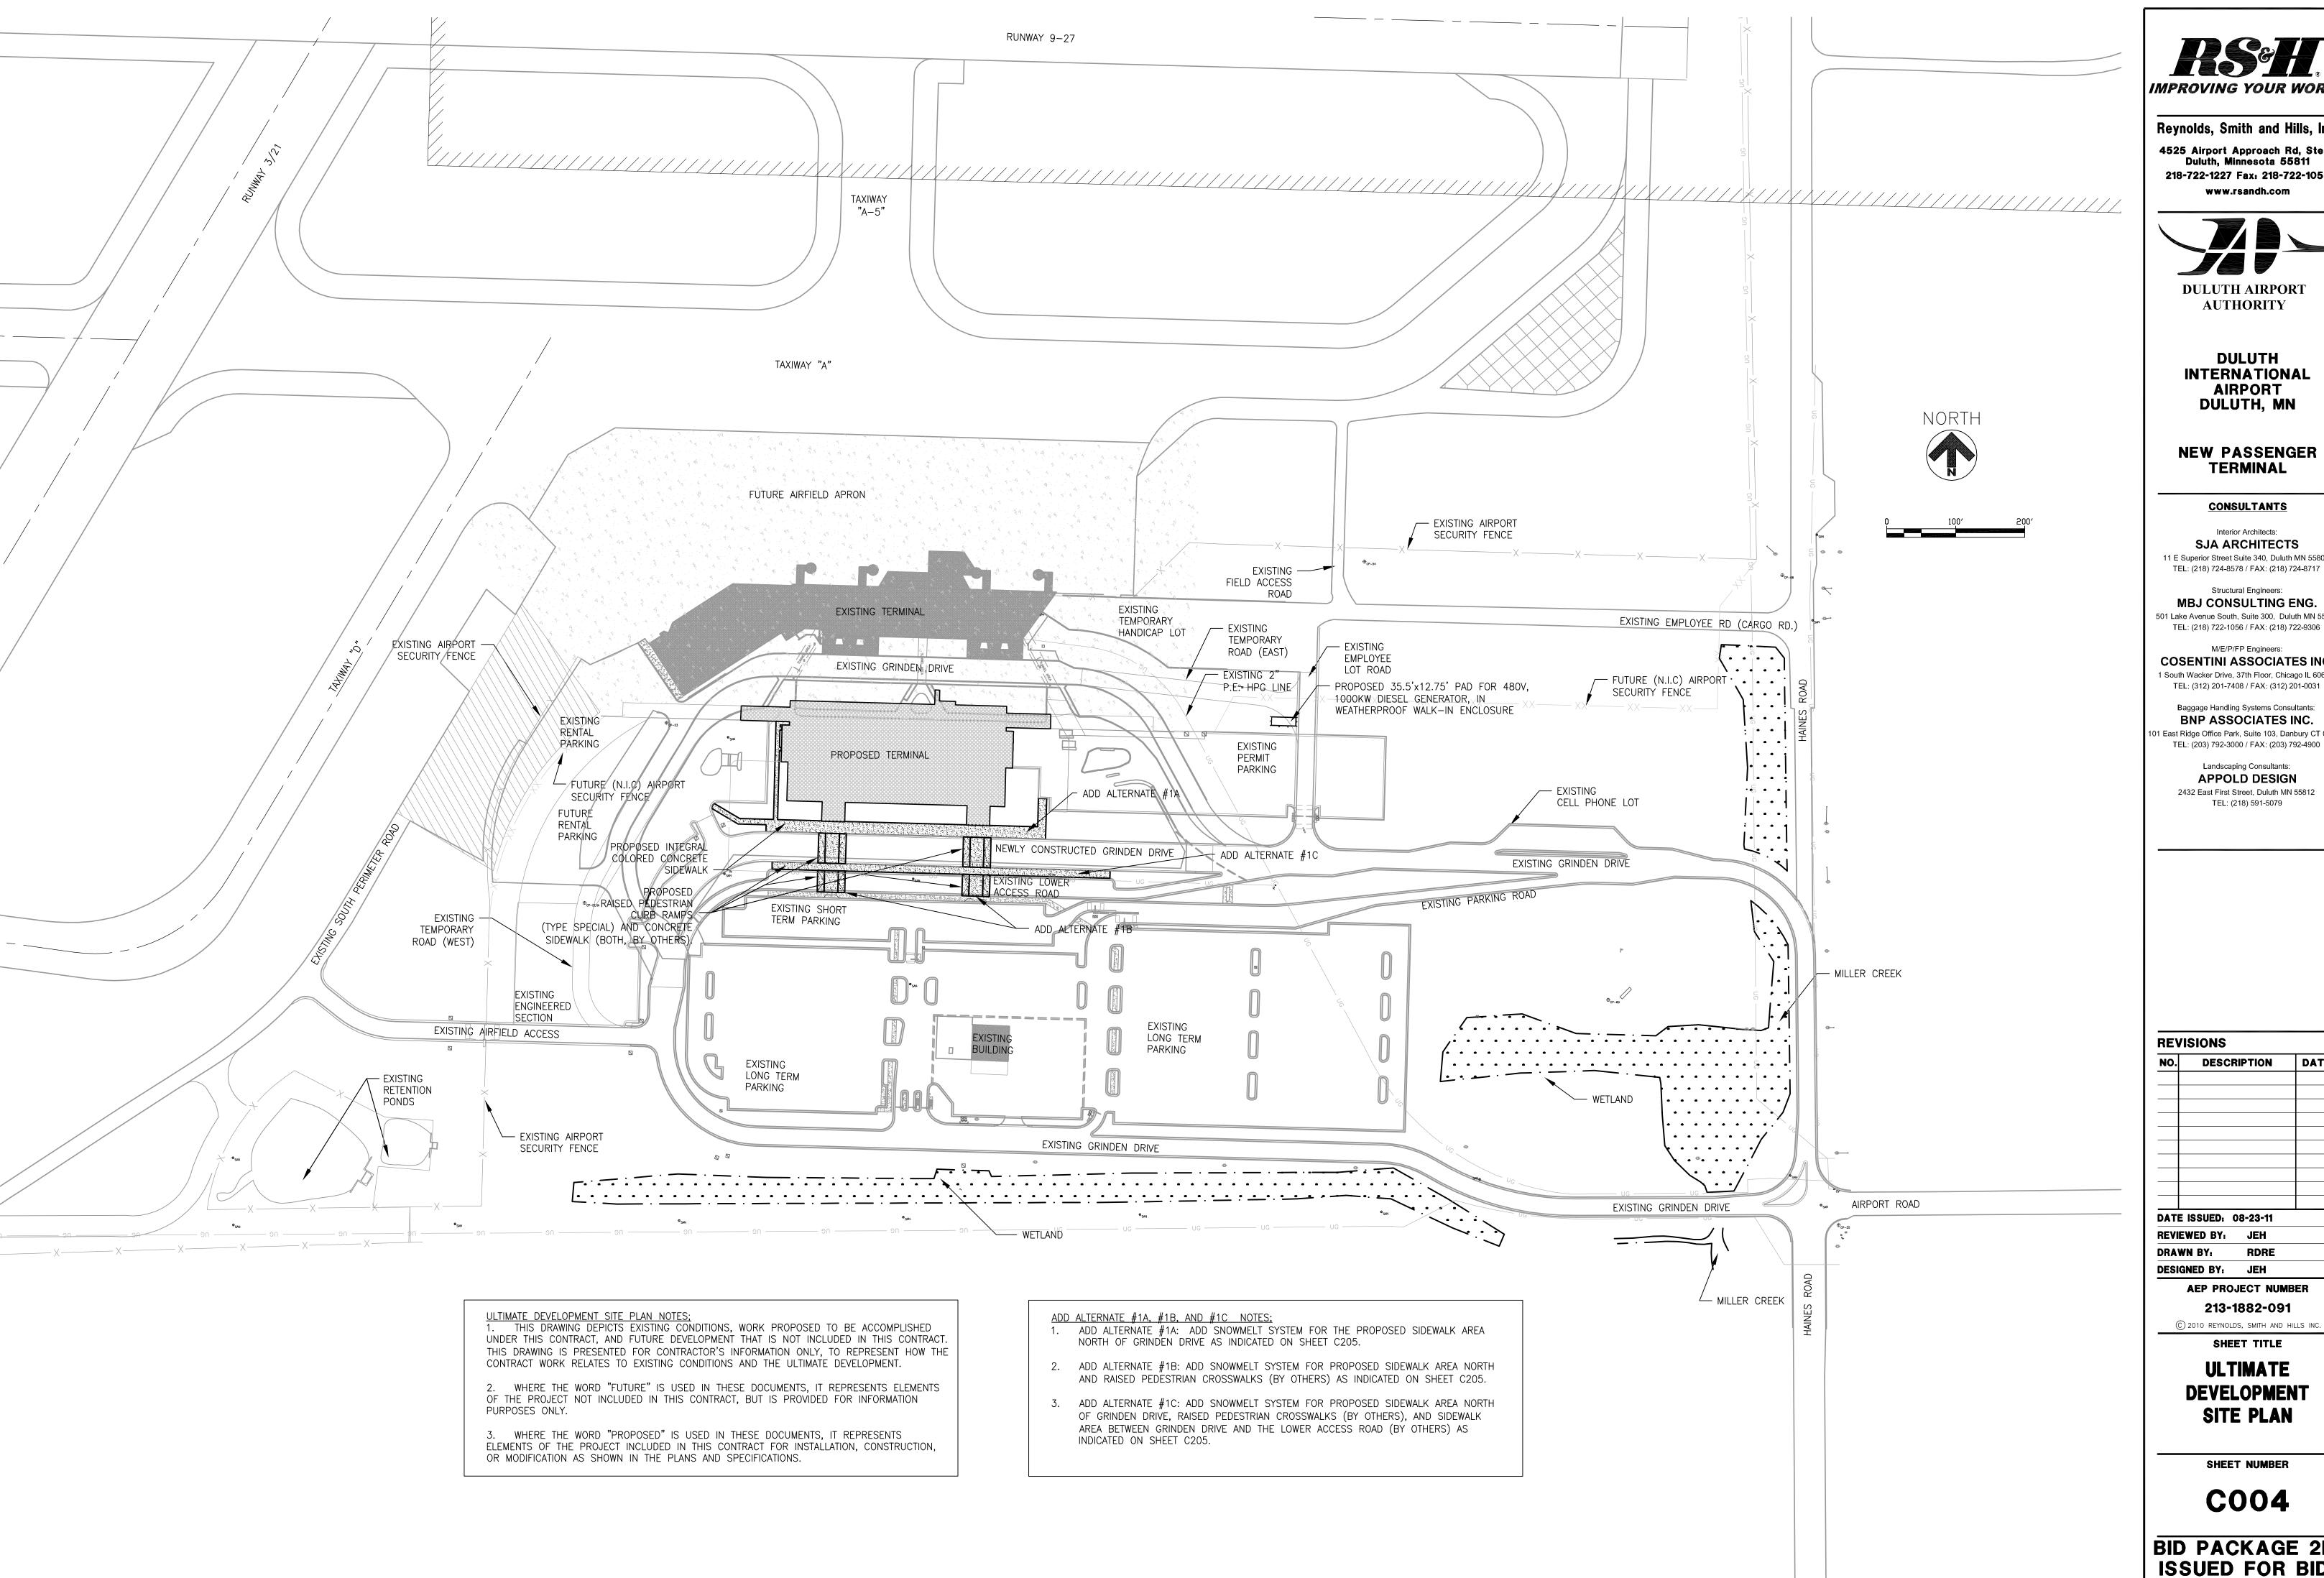
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SHEET TITLE

CONSTRUCTION
SAFETY
PHASING
PLAN

SHEET NUMBER

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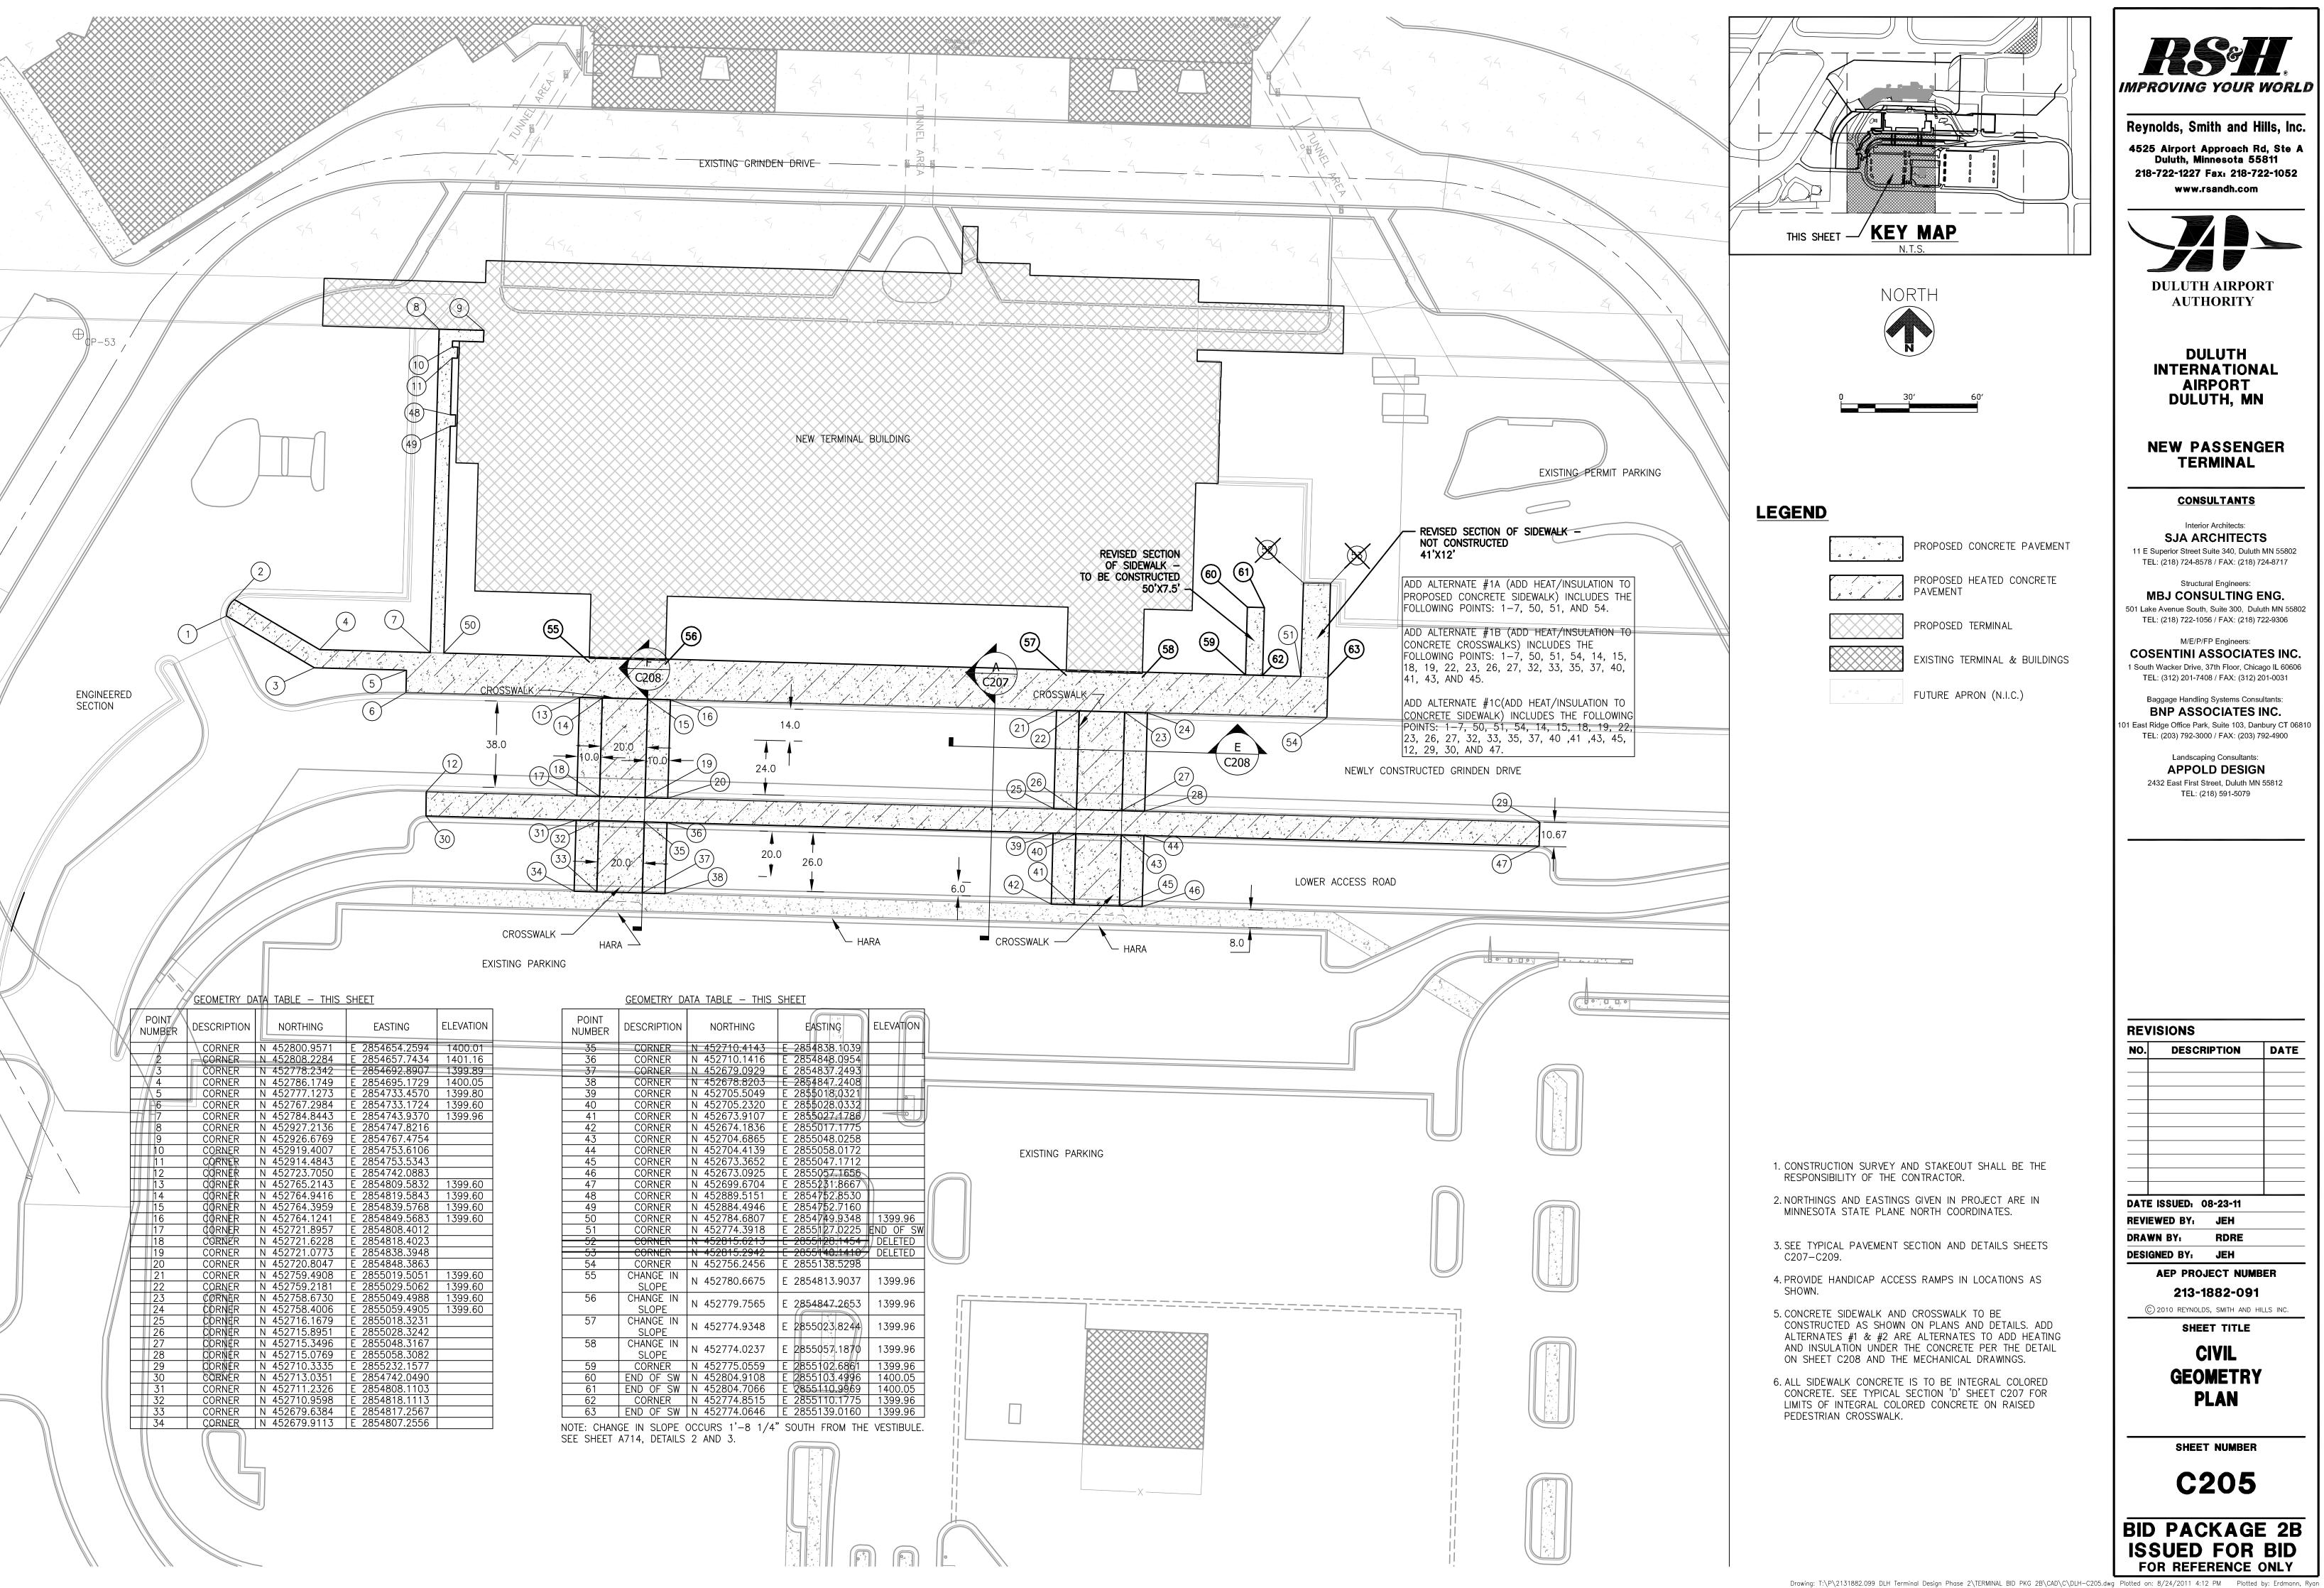
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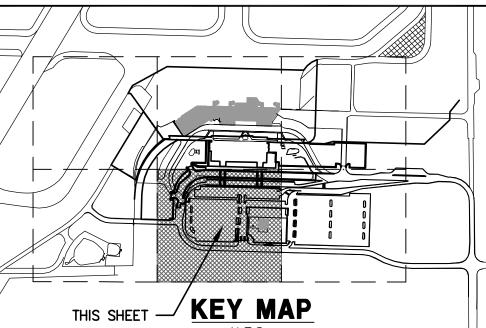
ULTIMATE **DEVELOPMENT** SITE PLAN

SHEET NUMBER

C004


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PROPOSED CONCRETE PAVEMENT

- 1. CONSTRUCTION SURVEY AND STAKEOUT SHALL BE THE RESPONSIBILITY OF THE CONTRACTOR.
- 2. NORTHINGS AND EASTINGS GIVEN IN PROJECT ARE IN MINNESOTA STATE PLANE NORTH COORDINATES.
- 3. SEE TYPICAL PAVEMENT SECTION AND DETAILS SHEETS C207-C209.
- 4. PROVIDE HANDICAP ACCESS RAMPS IN LOCATIONS AS SHOWN.
- 5. CONCRETE SIDEWALK AND CROSSWALK TO BE CONSTRUCTED AS SHOWN ON PLANS AND DETAILS. ADD ALTERNATES #1 & #2 ARE ALTERNATES TO ADD HEATING AND INSULATION UNDER THE CONCRETE PER THE DETAIL ON SHEET C208 AND THE MECHANICAL DRAWINGS.
- 6. ALL SIDEWALK CONCRETE IS TO BE INTEGRAL COLORED CONCRETE. SEE TYPICAL SECTION 'D' SHEET C207 FOR LIMITS OF INTEGRAL COLORED CONCRETE ON RAISED PEDESTRIAN CROSSWALK.



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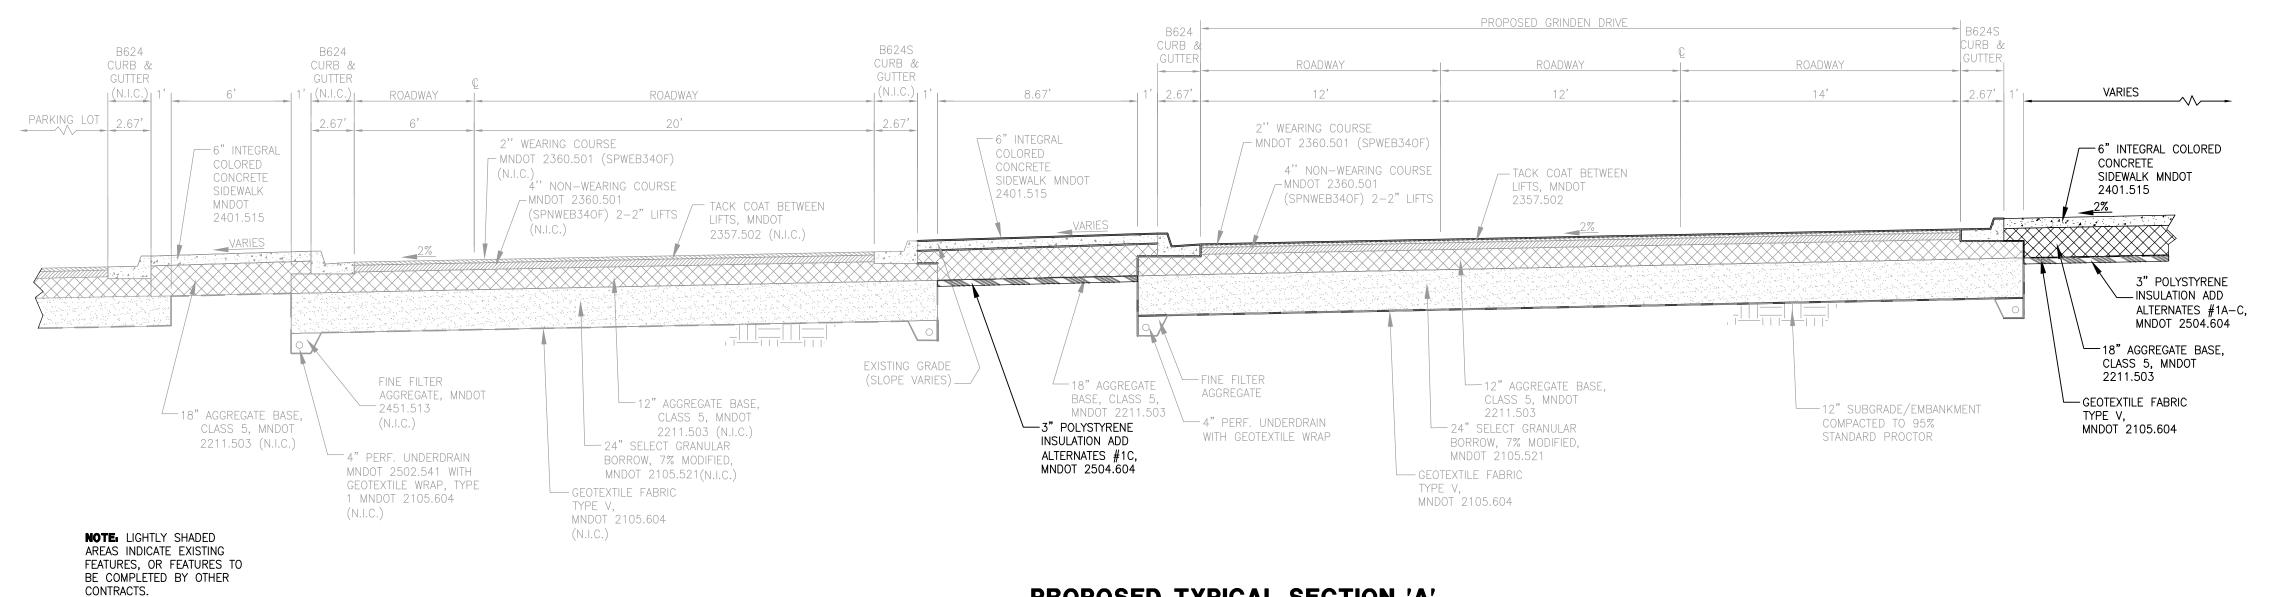
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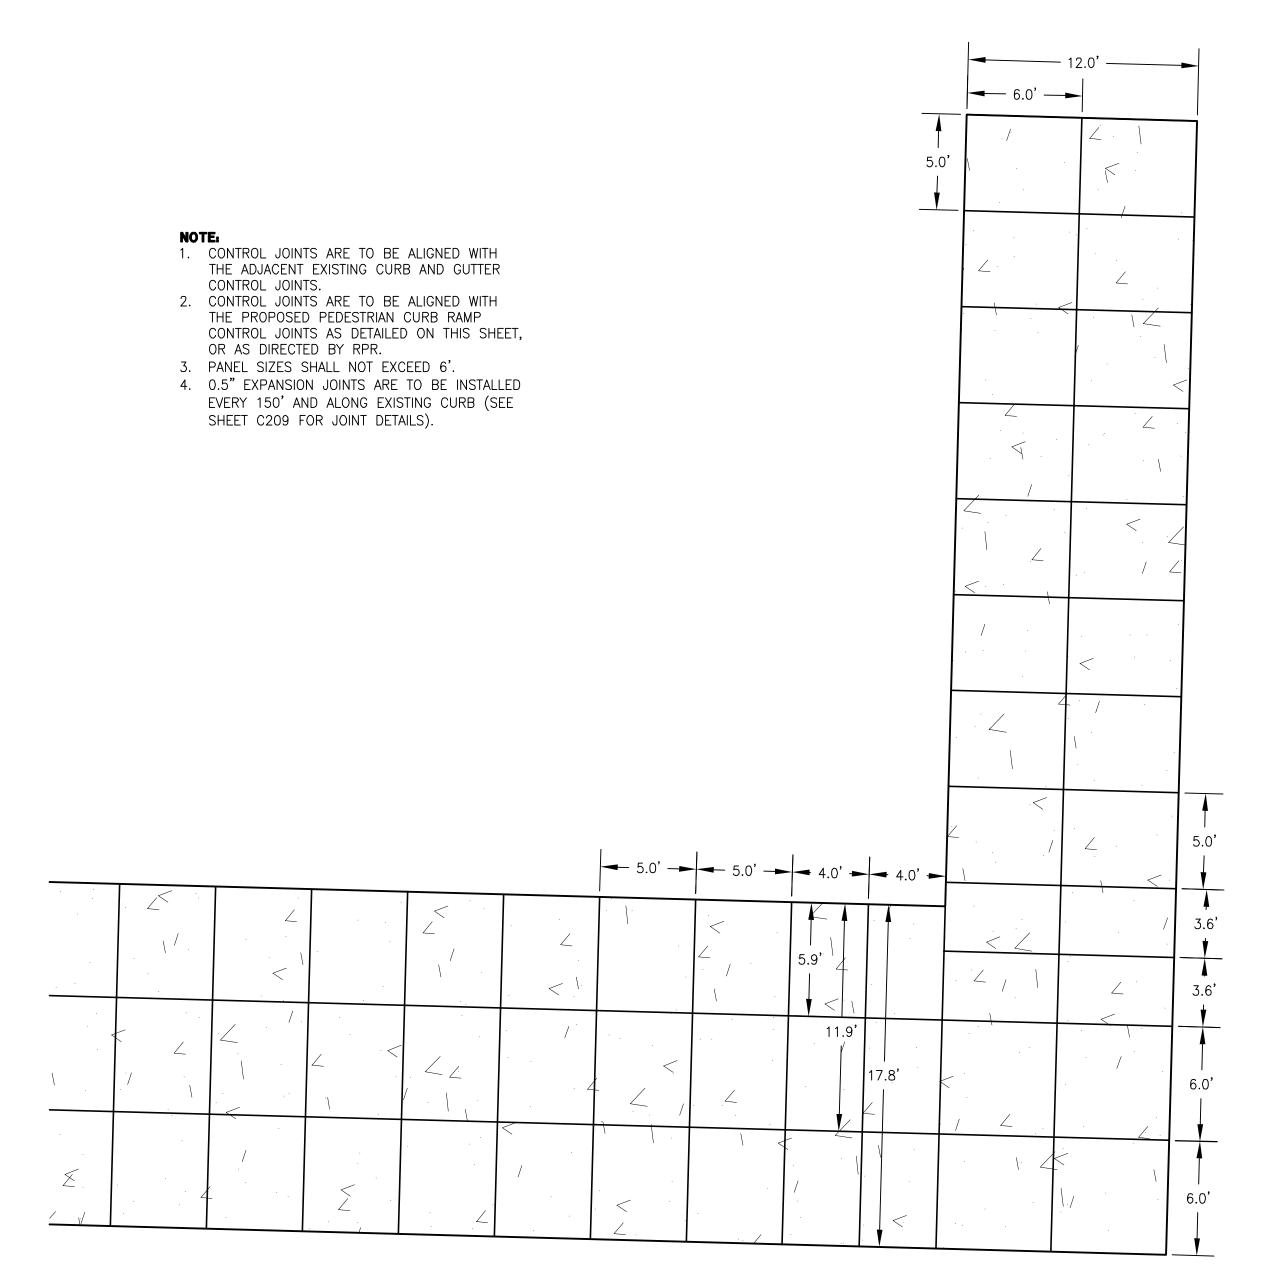
**GEOMETRY PLAN** 

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C205

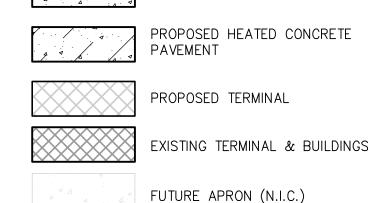


PROPOSED TYPICAL SECTION 'A'
PROPOSED SIDEWALK ADJACENT
TO NORTH SIDE OF GRINDEN DRIVE



PROPOSED JOINT LAYOUT FOR SIDEWALK

N.T.S.

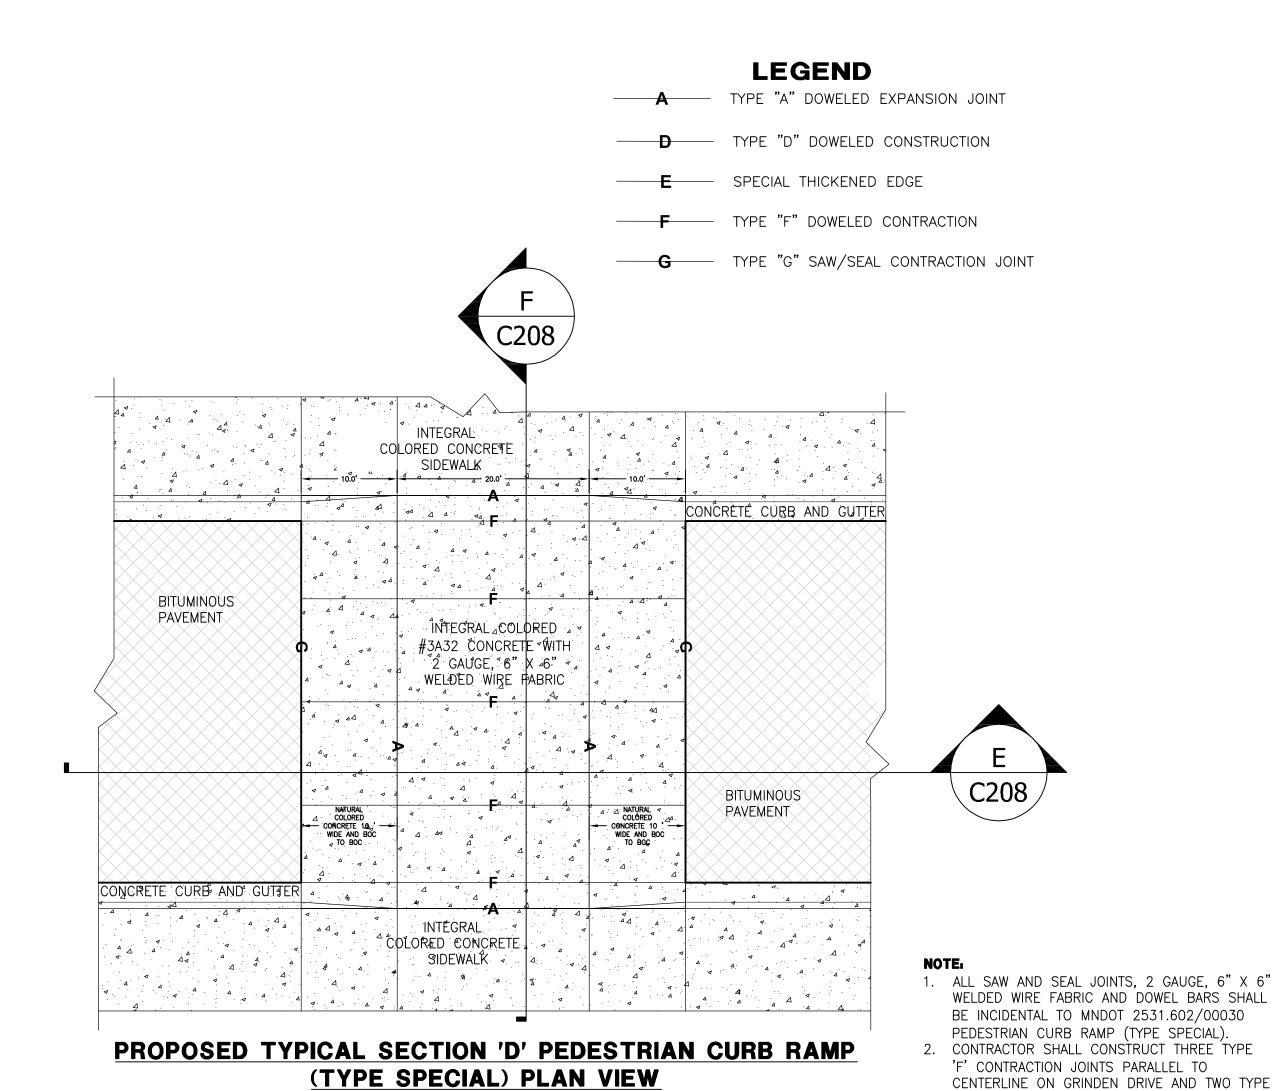

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'F' CONTRACTION JOINTS ON LOWER ACCESS

PEDESTRIAN CURB RAMPS TO BE CONSTRUCTED

ACROSS GRINDEN DRIVE AND LOWER ACCESS ROAD SHALL BE PAID FOR UNDER MNDOT

2531.602/00030. AGGREGATES REQUIRED FOR

CURB RAMPS SHALL BE USED ON CENTER 20' ONLY. NATURAL COLORED CONCRETE SHALL BE

SIDE OF THE CENTER 20' AND FROM BACK OF

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USED ON THE 10' WIDE SECTIONS TO EACH

CURB (BOC) TO BACK OF CURB.

BASE AND SUBBASE WILL BE PAID AT THEIR CORRESPONDING MNDOT NUMBER AND UNIT

5. INTEGRAL COLORED CONCRETE ON PEDESTRIAN

3. TYPE 'D' DOWELED JOINTS SHOWN FOR

4. THE 10" INTEGRAL COLORED CONCRETE

CONSTRUCTION PURPOSES.

DESIGNED BY: JEH

AEP PROJECT NUMBER

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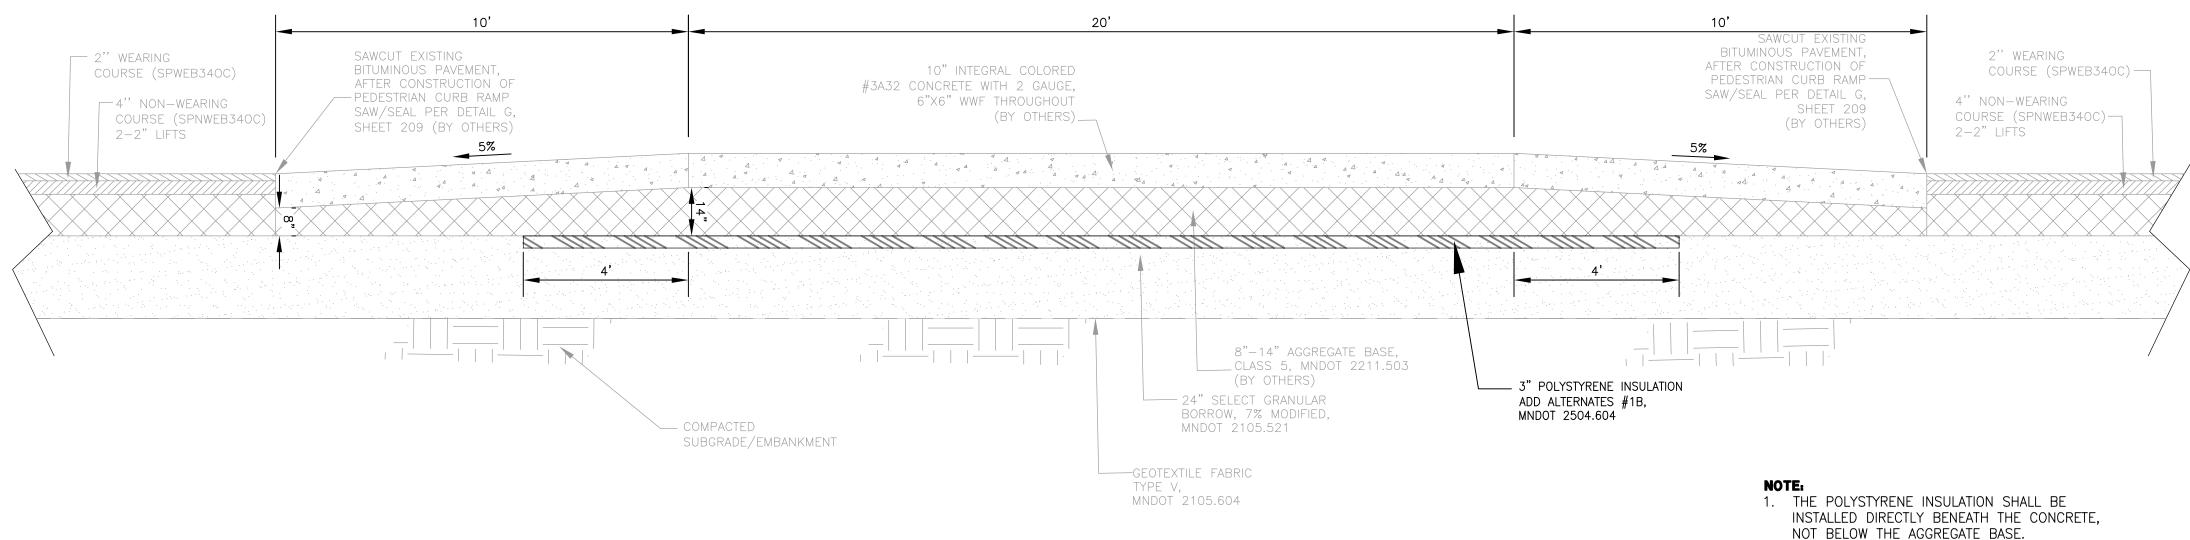
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SIDEWALK/CROSSWALK
TYPICAL SECTION
AND JOINT

**LAYOUT** 

SHEET NUMBER


C207



## PROPOSED HEATED PAVEMENTS TYPICAL SECTION 'E' PEDESTRIAN CURB RAMP - LOWER ACCESS ROAD (TYPE SPECIAL)

#### ROADWAY ROADWAY ROADWAY CURB & VARIES PARKING LOT 2.67' 10" INTEGRAL COLORED 6" INTEGRAL COLORED -#3A32 CONCRETE WITH 2 GAUG 10" INTEGRAL COLORED CONCRETE 6" INTEGRAL 6" INTEGRAL COLORED SIDEWALK MNDOT 6"X6" WWF THROUGHOUT -#3A32 CONCRETE WITH 2 GAUGE, COLORED 2401.515 (BY OTHERS) 6"X6" WWF THROUGHOUT (BY OTHERS) (BY OTHERS) CONCRETE CONCRETE SIDEWALK MNDOT 2401.515 SIDEWALK MNDOT 2401.515 INSULATION ADD ALTERNATES #1A-C, MNDOT 2504.604 12" AGGREGATE BASE, 3" POLYSTYRENE 8"-14" AGGREGATE ∠ 3" POLYSTYRENE INSULATION FINE FILTER CLASS 5, MNDOT -3" POLYSTYRENE 18" AGGREGATE BASE. 2211.503, (BY OTHERS) ADD ALTERNATES #1B, AGGREGATE, MNDOT INSULATION AGGREGATE └─ 18" AGGREGATE BASE, INSULATION BASE, CLASS 5, CLASS 5, MNDOT ADD ALTERNATES #1B, ADD ALTERNATES #1C, MNDOT 2211.503 <sup>-</sup> 2451.513 -12" SUBGRADE/EMBANKMENT MNDOT 2504.604 CLASS 5, MNDOT 2211.503 \_\_\_\_\_20"-26" SELECT EXISTING 18" 2211.503 — 4" PERF. UNDERDRAIN COMPACTED TO 95% MNDOT 2504.604 MNDOT 2504.604 " AGGREGATE BASE, GRANULAR (BY OTHERS) WITH GEOTEXTILE WRAP STANDARD PROCTOR BORROW, 7% MODIFIED, CLASS 5, MNDOT EXISTING 24" SELECT MNDOT 2105.521, (BY -4" PERF. UNDERDRAIN 2211.503 (N.I.C.) GRANULAR MNDOT 2502.541 WITH OTHERS) BORROW, 7% MODIFIED, GEOTEXTILE WRAP, TYPE MNDOT 2105.521 (N.I.C.) — GEOTEXTILE FABRIC 1 MNDOT 2105.604 TYPE V, EXISTING GEOTEXTILE (N.I.C.) MNDOT 2105.604 FABRIC TYPE V. MNDOT 2105.604 (N.I.C.)

# PROPOSED HEATED PAVEMENTS TYPICAL SECTION 'F' PEDESTRIAN CURB RAMP (TYPE SPECIAL)

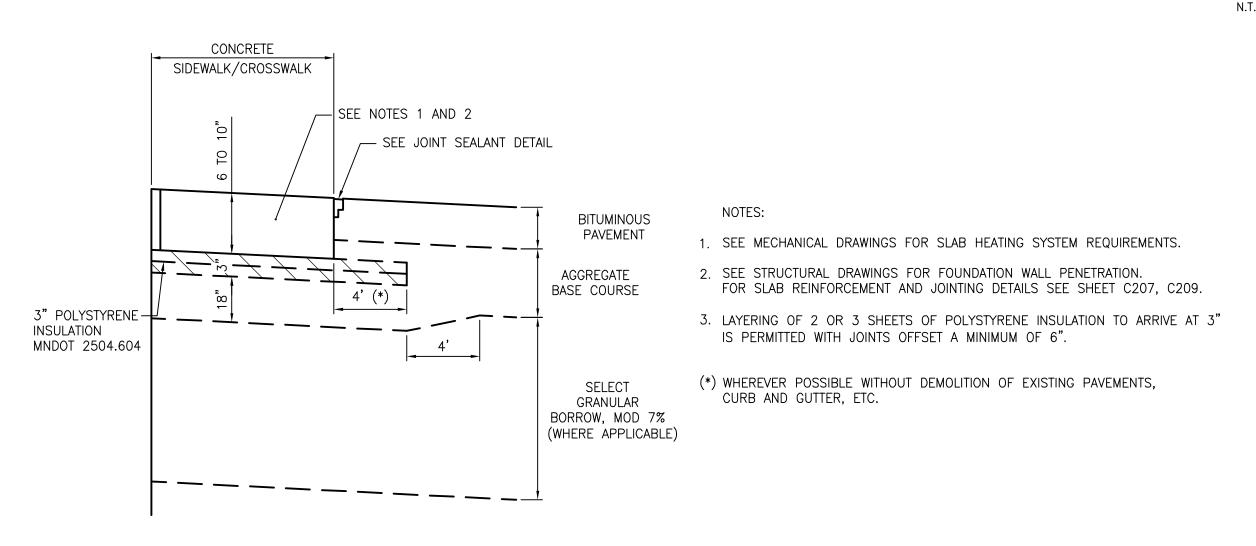

CONSTRUCTION DETAIL - HEATED CONCRETE

(ADD ALTERNATES #1A-C)

#### NOT

1. THE POLYSTYRENE INSULATION SHALL BE

NOT BELOW THE AGGREGATE BASE.

INSTALLED DIRECTLY BENEATH THE CONCRETE,

- 1. ALL SAW AND SEAL JOINTS, 2 GAUGE, 6" X 6" WELDED WIRE FABRIC AND DOWEL BARS SHALL BE INCIDENTAL TO MNDOT 2531.602/00030 PEDESTRIAN CURB RAMP (TYPE SPECIAL), BY OTHERS.
- 2. SEE SHEET C207 FOR JOINT TYPE, AND JOINT SPACING.
- 3. THE 10" INTEGRAL COLORED CONCRETE PEDESTRIAN CURB RAMPS TO BE CONSTRUCTED ACROSS GRINDEN DRIVE AND LOWER ACCESS ROAD SHALL BE PAID FOR UNDER MNDOT 2531.602/00030. AGGREGATES REQUIRED FOR BASE AND SUBBASE WILL BE PAID AT THEIR CORRESPONDING MNDOT NUMBER AND UNIT COST, (BY OTHERS).

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Reynolds, Smith and Hills, Inc.

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Duluth, Minnesota 55811

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DULUTH AIRPORT AUTHORITY

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DULUTH, MN

NEW PASSENGER TERMINAL

CONSULTANTS

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Structural Engineers:

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Landscaping Consultants:

APPOLD DESIGN

2432 East First Street, Duluth MN 55812

TEL: (218) 591-5079

REVISIONS

	NO.	DESCRIPTION	DATE
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1			
	DATE	ISSUED: 08-23-11	

DATE ISSUED: 08-23-11
REVIEWED BY: JEH

DRAWN BY:

DESIGNED BY: JEH

RDRE

AEP PROJECT NUMBER

**213-1882-091**© 2010 REYNOLDS, SMITH AND HILLS INC.

SHEET TITLE


TYPICAL PAVEMENT SECTIONS

SHEET NUMBER

**C208** 

BID PACKAGE 2B
ISSUED FOR BID
FOR REFERENCE ONLY


Drawing: T:\P\2131882.099 DLH Terminal Design Phase 2\TERMINAL BID PKG 2B\CAD\C\DLH-C208.dwg Plotted on: 8/24/2011 4:27 PM Plotted by: Erdmann, Ryan

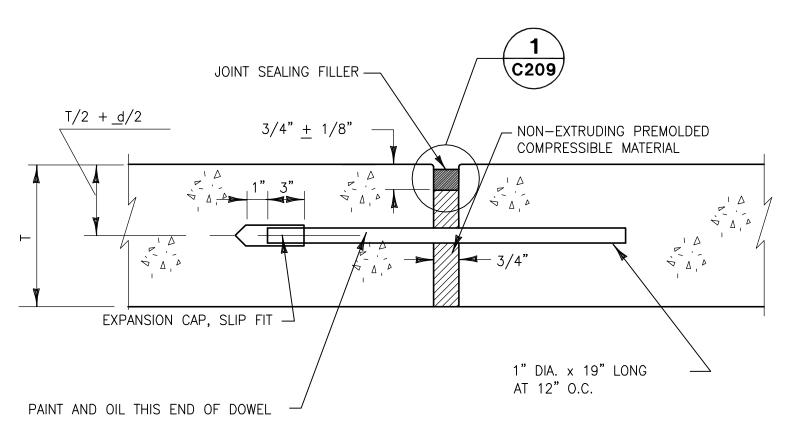


# A TYPE A - DOWELED JOINT

NOTE:


ALL JOINTS MUST BE ADEQUATELY CLEANED AFTER SAWCUTTING,
IMMEDIATELY PRIOR TO THE INSTALLATION OF JOINT SEALANT.

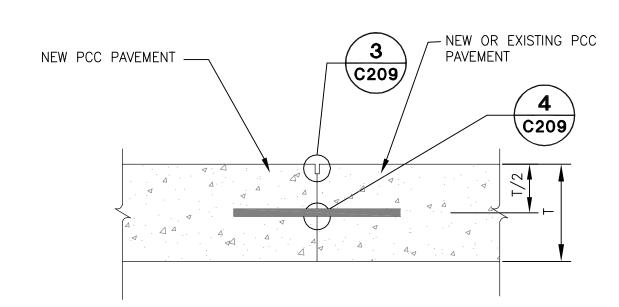

## D TYPE D CONSTRUCTION JOINT DETAIL N.T.S.

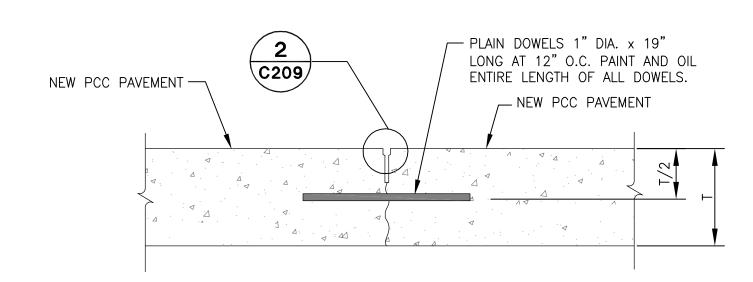


## F TYPE F CONTRACTION JOINT DETAIL

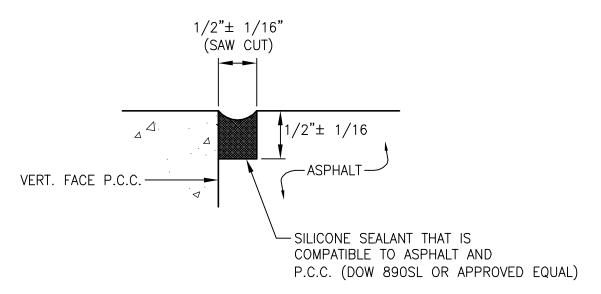


# G TYPICAL SAW/SEAL CONTRACTION JOINT DETAIL

THE CONTRACTOR SHALL FORM THE P.C.C. TO PROVIDE A VERTICAL FACE AFTER PLACEMENT OF ASPHALT, THE CONTRACTOR SHALL SAW AND SEAL, AS SHOWN.

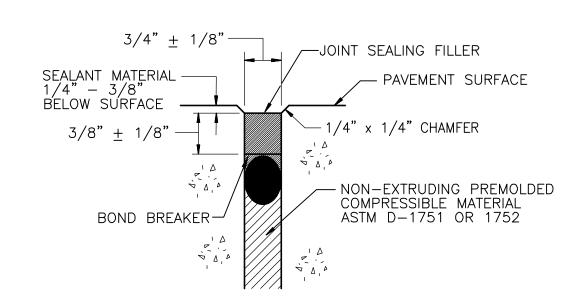


**DETAIL 1 - EXPANSION JOINT** 

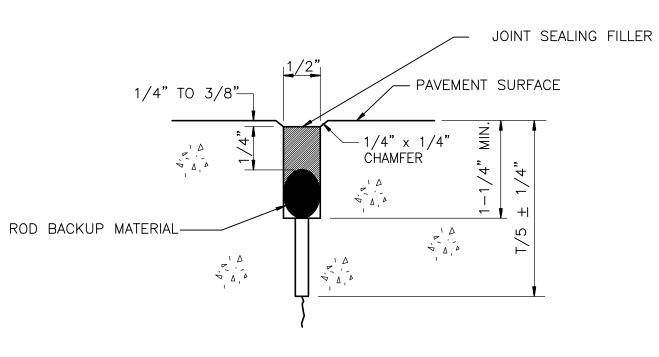


**DETAIL 2 - CONTRACTION JOINT** 

N.T.S.

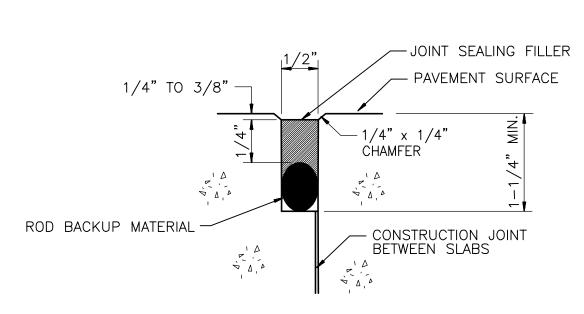



**DETAIL 3 - CONSTRUCTION JOINT**N.T.S.

NOTE: ALL SEALANT SHALL BE DOW 890SL OR APPROVED EQUAL.

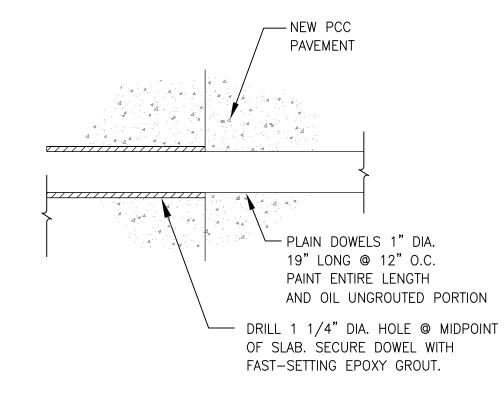

**DETAIL 4 - DOWEL DETAIL** 

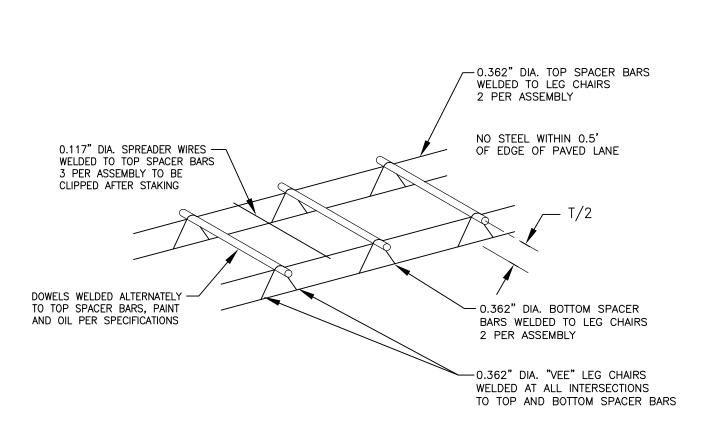

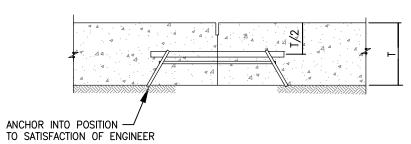

## TYPICAL DOWEL AND TIE-BAR BASKET

N.T.S.

NOTES:

1. BASKET MUST BE FIRMLY ATTACHED TO EXISTING OR NEW BASE PRIOR TO PLACING PCC.

2. ALL WIRE SIZES SHOWN ARE MINIMUM SIZE.

3. DOWELS SHALL BE HELD FIRMLY IN THE ABOVE WELDED ASSEMBLY.

4. THE TOLERANCE FOR DOWEL ALIGNMENT IN EITHER HORIZONTAL OR VERTICAL PLANE IS 1/4"/FT.

5. DOWEL BARS SHALL BE EVENLY SPACED ACROSS EACH PANEL WITH NO BAR BEING LESS THAN ONE FOOT FROM THE PANEL EDGE.



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DATE ISSUED: 08-23-11
REVIEWED BY: JEH

DRAWN BY: RDRE
DESIGNED BY: JEH

AEP PROJECT NUMBER

213-1882-091

213-1882-091

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SHEET TITLE
CONCRETE


PAVEMENT JOINT DETAILS

SHEET NUMBER

C209

BID PACKAGE 2B
ISSUED FOR BID
FOR REFERENCE ONLY

Drawing: T:\P\2131882.099 DLH Terminal Design Phase 2\TERMINAL BID PKG 2B\CAD\C\DLH-C209.dwg Plotted on: 8/24/2011 4:28 PM Plotted by: Erdmann, Ryan

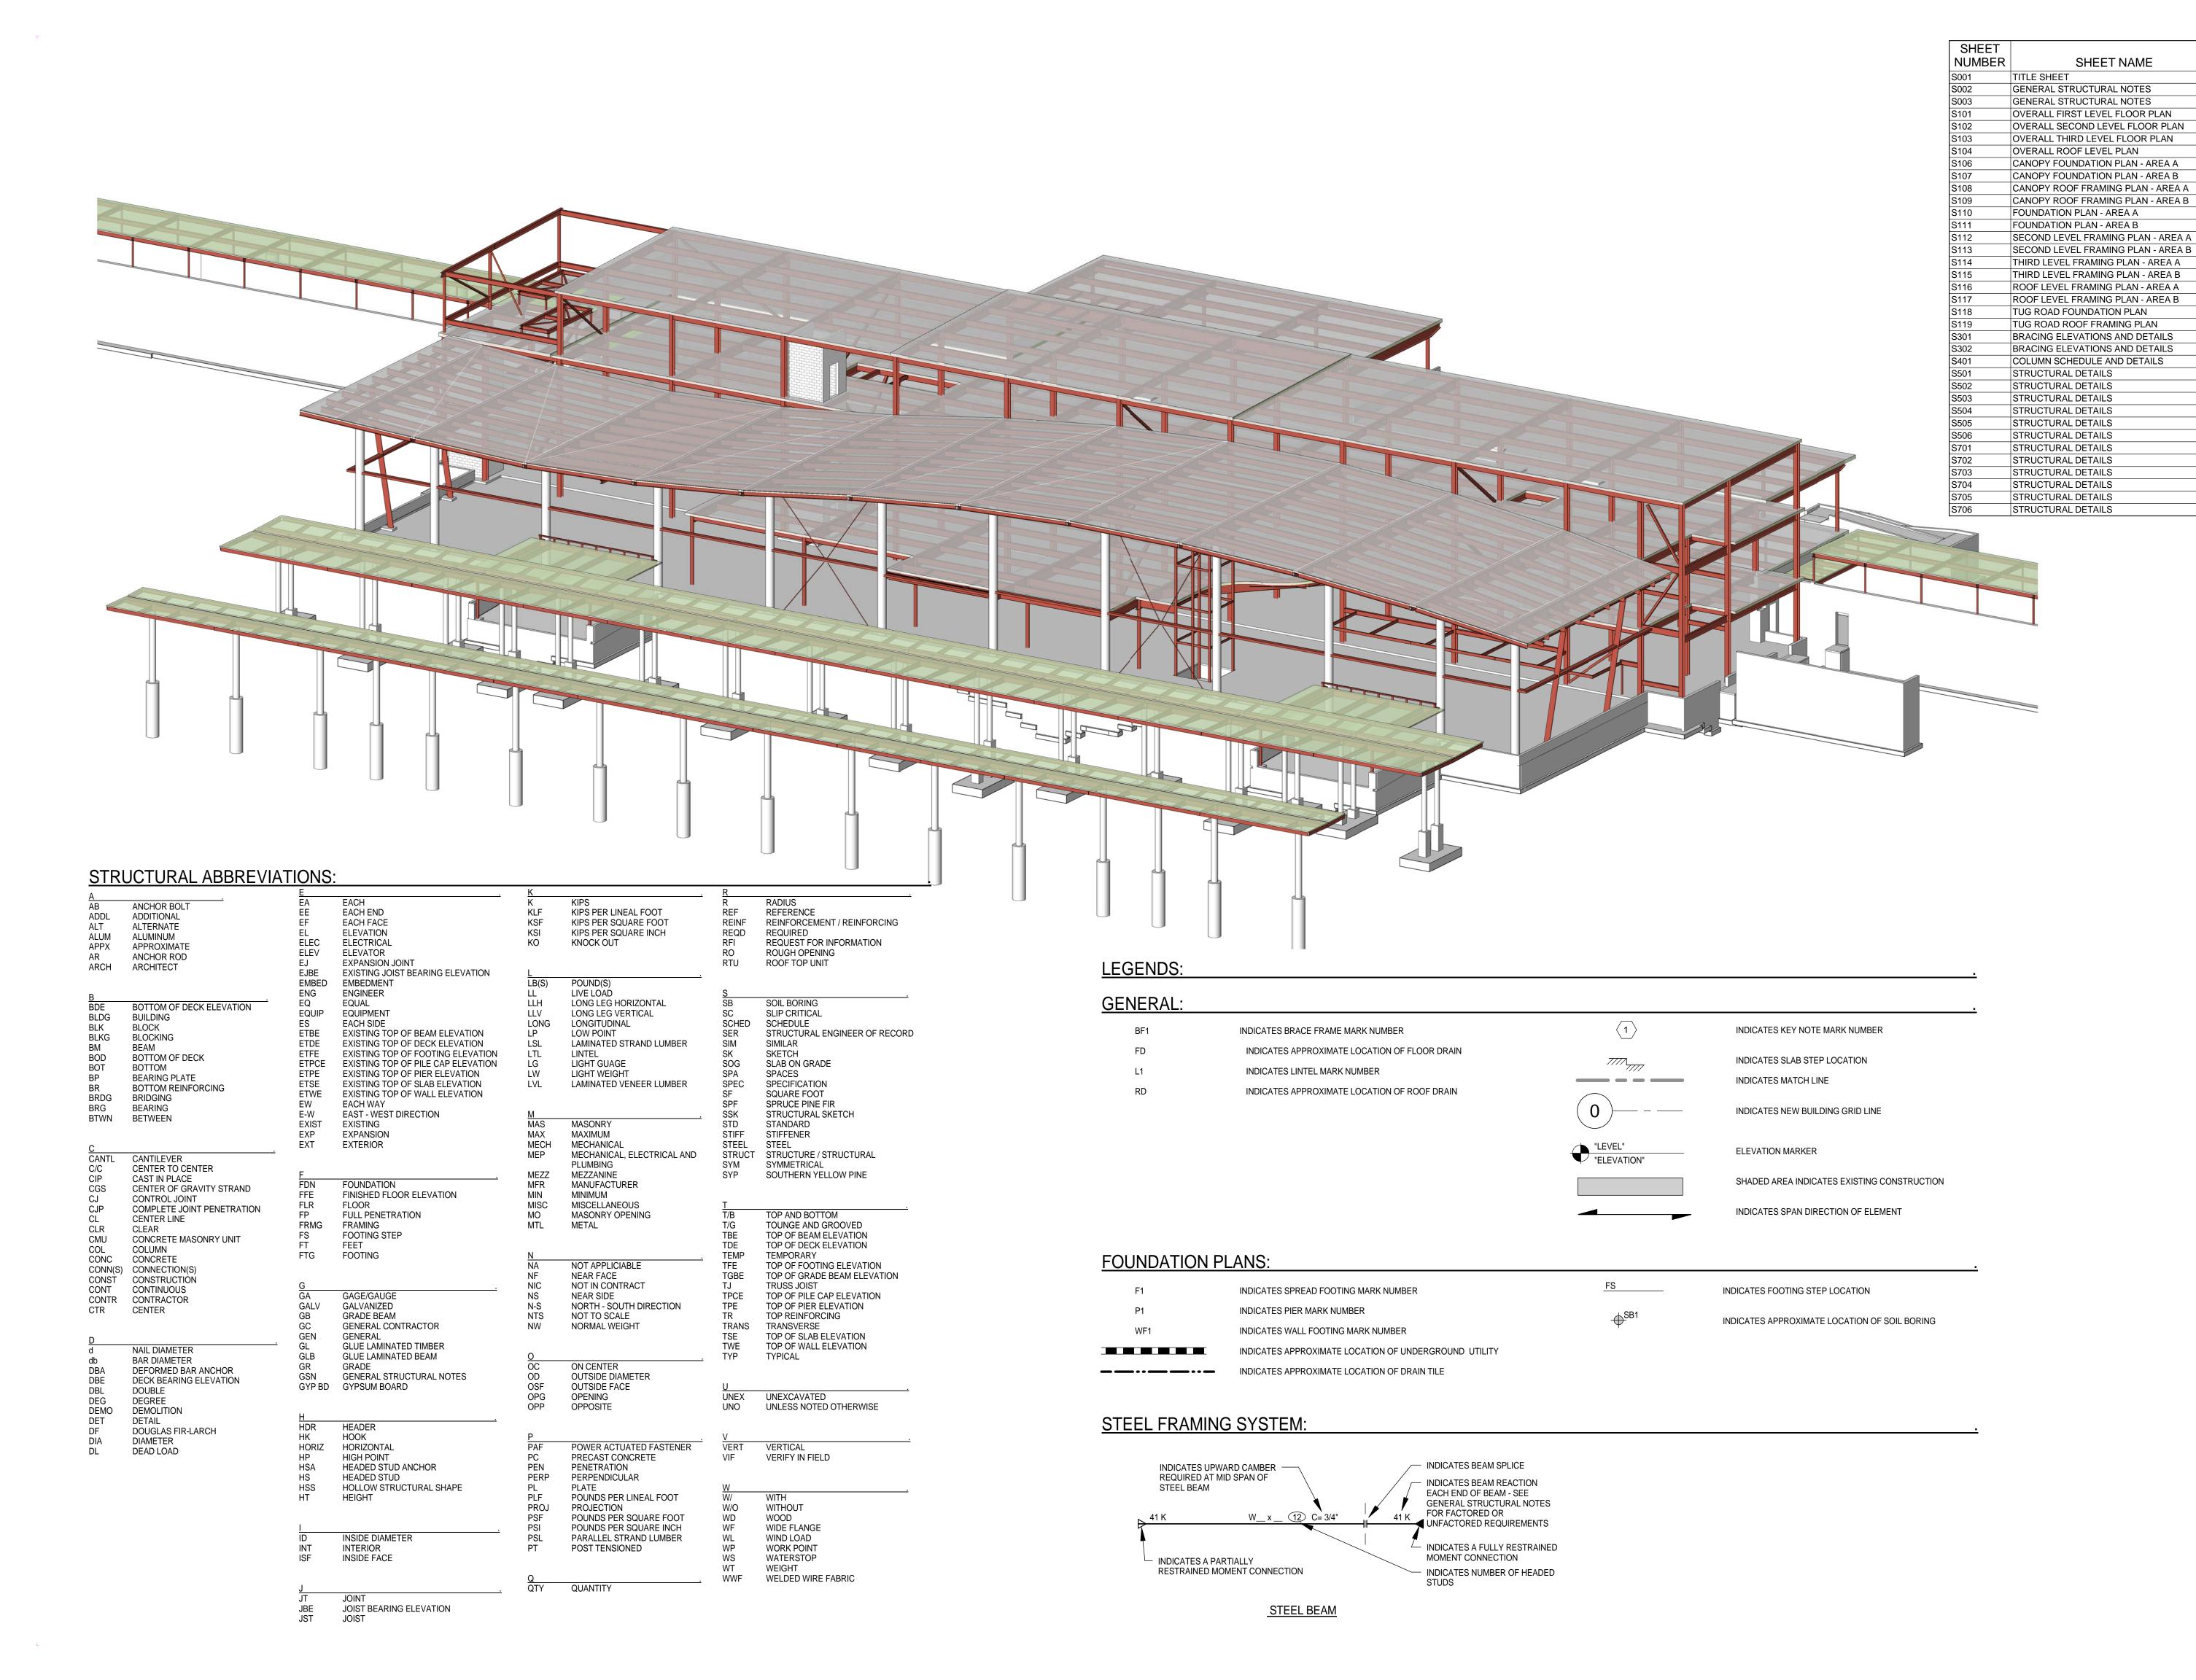



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DULUTH INTERNATIONAL **AIRPORT** DULUTH, MN

**NEW TERMINAL DESIGN** 

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> Landscape Consultants: **APPOLD DESIGN** 2432 East First Street, Duluth MN 55812 TEL: (218) 591-5079

I hereby certify that this plan, specification, or report was prepared by me or under my direct supervision and that I am a duly licensed Professional Engineer under the laws of the State of Minnesota.

Print Name: Paul A. Johnson

Signature:

Date: June 3, 2010 Reg. No.: 20379

REVISIONS			
NO.	DATE		
	BID PACKAGE 1	5.12.10	

140.	DEGOINI HON	DATE
	BID PACKAGE 1	5.12.10
	FOUNDATION PERMIT	6.4.10
1,2,3	NOT CHANGED	
	CONFORMANCE SET	7.12.10
	BUILDING PERMIT	8.6.10
5	100% REVIEW	12.15.10
	BID PACKAGE 2A	01.24.11
	BP 2A CONFORMANCE	05.02.11

**DATE ISSUED:** 08-23-11 **REVIEWED BY:** PAJ / CWB DRAWN BY: SJL

**DESIGNED BY:** CWB AEP PROJECT NUMBER

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SHEET TITLE

TITLE SHEET

**SHEET NUMBER S001** 

The contractor shall verify all dimensions and existing conditions in the field that affect construction prior to commencing work on the affected element or shop drawing submittals. Resolve any discrepancies with the architect prior to construction.

The contract structural drawings and specifications represent the completed structure. The contractor is responsible for bracing and shoring (without overstressing) all structural elements as necessary at any stage of construction until completion of the project. The Structural Engineer is not responsible for the contractor's means, methods, sequences or procedures of construction. Contractor shall recognize and consider effects of thermal movements of structural elements during construction period.

The contractor is solely responsible for site safety including all temporary precautionary measures and safety programs. Site observation visits by the Structural Engineer do not include review of the contractor's safety precautions.

Refer to architectural, mechanical and electrical drawings for locations, elevations, dimensions, and details of sleeves, inserts, openings, recesses, curbs, housekeeping pads, etc. that are not shown on the structural drawings and do not damage structural members.

Information shown in the structural drawings regarding existing conditions represents the current and general field conditions related to the new work, to the best of our knowledge. Report all discrepancies to the Architect for resolution prior to performing related new work.

Requests for information shall be submitted in writing and shall reference the part of the construction documents that is in question.

Contractor shall read and understand their duties in the specification and under the building code for special inspections and coordinate as necessary the owner's responsibilities.

The special inspectors shall be provided and shall only use approved shop drawings.

Special inspection reports are to be submitted immediately to the SER, Architect, and Contractor daily when inspections are performed

The general contractor shall provide timely notice to the special inspector and sufficient time for the inspector to perform their inspection

SHOP DRAWINGS:

All engineering design provided by others and submitted for review shall bear the certification stamp and signature of a qualified professional engineer who is licensed in the state of Minnesota.

Submit shop drawing schedule with construction schedule that includes consideration for review period. See specification for additional information.

**DEFERRED SUBMITTALS:** The following items shall be issued as deferred submittals per IBC: Steel Connections

Light gage metal framing

All items issued as deferred submittals shall be issued a minimum of 30 days prior to installation and shall not be installed until their design and submittal documents have been reviewed for general conformance to the drawings by the general contractor, the engineer of record and the building official. A copy of the deferred submittal shall be forwarded to the city after the engineer of record has reviewed the documents and prior to erection of the deferred submittal items.

**DESIGN CODES AND STANDARDS:** Minnesota State Building Code, MSBC 2007

2006 International Building Code, as amended and adopted by the MSBC 2007

ACI 318-05 Building Code Requirements for Reinforced Concrete

ACI 530-05 Building Code Requirements for Masonry Structures, Allowable Stress Design

ACI 530.1-05 Masonry Structures

AISC 360-05 Specification for Structural Steel Buildings

AISI NAS-01 North American Specification for the design of Cold-Formed Steel Structural Members including 2004 supplement.

ASCE 7-05 Minimum design loads for buildings and other structures including supplement NO. 1 and excluding Chapter 14 and Appendix 11A.

ASCE 3-01 Structural Design of Composite Slabs

MATERIAL PROPERTIES: Reinforcing Steel (Fy):

Structural Steel (Fy):

Threaded Rods

Cold-formed Light Gauge Metal Framing (Fy):

Track, Channels and Accessories

ATSM A615 Grade 60 Typical ASTM A706 Grade 60 Weldable 60,000 psi

ASTM A36

ASTM F959

ASTM A653

ASTM A653

ASTM A653

36,000 psi

33,000 psi

Cast-in-Place Concrete (f'c) at 28 days, UNO:

Controlled Low Strength Material (CLSM) Footings Piers and Walls Columns Concrete placed over Metal Floor Deck Slabs on Grade Exterior Concrete Masonry Corefill Concrete All Concrete not otherwise noted	1,200 psi (at 5 days) 500 psi (at 5 days) 4,000 psi 4,000 psi 4,000 psi 4,000 psi 4,000 psi 4,000 psi 3,000 psi 4,000 psi	Maximum Minimum
te Masonry- Prism (f'm): Typical Units:	2,000 psi	

	(. )/.		
	Wide Flanges	50,000 psi	ASTM A992
	Angles, Channels	36,000 psi	ASTM A36
	Grade B Rectangular HSS	46,000 psi	ASTM A500
	Grade B Round HSS	42,000 psi	ASTM A500
	Grade B Steel Pipe	35,000 psi	ASTM A53
	Plates, Bars	50,000 psi	ASTM A572 or A36 as indicated
Structu	ıral Fasteners:		
	Typical High-Strength Bolts	92,000 psi	ASTM A325
	High-Strength Bolts as noted on plan	150,000 psi	ASTM A490
	Grade 36 Anchor Rods, UNO	36,000 psi	ASTM F1554

Direct -Tension Indicator Washers as noted on plan

Studs, Joists, Braces-16 ga. and heavier 50,000 psi

Studs, Joists, Braces-18 ga. and lighter 33,000 psi

**DESIGN LOADS LATERAL LOADS** Primary Frame Wind Data: Basic Wind Speed: 90 mph Wind Importance Factor: 1.15 Exposure:

Primary Seismic Data: No design required

Component Loads: Exterior Component/Cladding: Supplier to develop based on MSBC 2007 and to indicate on shop drawings.

**GRAVITY LOADS:** Roof Snow Load:

Ground Snow Load, Pg 60 psf 46 psf Flat-Roof Snow Load, Pf: 0.70 Snow Exposure Factor, Ce: Snow Load Importance Factor, I: As required by ASCE 7 Unbalanced/Drift Snow Load:

Floor Loads: Live Load

100 psf (not reducible) Hanging loads at underside of 2nd floor: 40 psf superimposed Stairs, Corridors and Lobbies: 100 psf (not reducible)

Design for one story expansion of 3rd floor office space north of grid "G".

Stair Tread Concentrated Load: 300 lbs Mechanical Rooms: 150 psf (not reducible) 4 Light Storage: 125 psf (not reducible)

Exterior Site Surcharge Loads: Fire Trucks: 250 psf Sidewalk: 250 psf North terminal retaining wall and north

HS20-44 axle load as defined by IBC 2006 table 1607.6 at a tug tunnel retaining wall: distance of 5 feet from the north wall edge.

Provisions For Future Expansion: Design for additional 30' bay (3 story) between grids "E" and "G", east of grid 12 and west of grid 1.

Refer to Geotechnical report number AET #07-04216.2 by American Engineering Testing, Inc., dated October 14, 2009 and the subsequent addendum (AET project #07-04216.3) dated January 29, 2010.

The contractor shall verify the location of all existing and new underground utilities and tanks prior to beginning excavation and contact Gopher State One Call.

The minimum dimension from exterior grade to bottom of footing and foundation shall be 72" in unheated areas.

For underground utilities adjacent to foundations and through foundations reference drawings for detail showing step footings below utilities as required to avoid undermining of structure by utilities.

See geotechnical report for water table elevations. Contractor to make adequate provisions for dewatering as

Footings are designed for a maximum allowable soil bearing pressure of 8000 pounds per square foot on undisturbed native soil or lean mix concrete/controlled low strength material fill. Soil bearing pressure is to be verified in the field during construction by a qualified Geotechnical Engineer.

All topsoil, fill, organic swamp deposits, and/or other unsuitable bearing material shall be removed below the footings and/or within the building area to the depths indicated in the geotechnical engineering report and extent of removal shall be field verified by the Geotechnical Engineer.

All excavations shall be observed by a qualified geotechnical engineer to verify removal of unsuitable material and confirm the proper preparation of bearing conditions.

For footings that do not bear on natural undisturbed soil, extend engineered fill laterally beyond bottom edge of footing for a distance equal to the depth of engineered fill. Reference drawings for details.

Foundation and retaining walls shall be back filled with free draining fill approved by the Geotechnical Engineer. Provide drain tile required by the contract documents and verify with architect and civil engineer.

Backfill equally on both sides of foundation walls to prevent overturning or lateral wall movement, or temporarily brace

as necessary until permanent bracing elements are complete and cured to design strength. All temporary bracing, cribbing, shoring or underpinning not fully designed or detailed on these drawings shall be

designed by a licensed specialty engineer engaged directly by the contractor. For stepping of wall footings reference drawings for detail.

The detailing, fabrication and erection of all reinforcing shall be done in accordance with the latest edition of ACI-315, "Manual of Standard Practice for Detailing Reinforced Concrete Structures and ACI-318, "Building Code

All reinforcing bars are deformed and continuous, unless noted otherwise. Refer to drawings for reinforcing lap length schedule.

Provide suitable wire spacers, chairs, etc. for support of reinforcing steel in proper position while placing concrete. All bars shall be tied to prevent displacement while placing concrete. All chairs and slab bolsters shall be plastic or steel with plastic tips. When reinforcing steel is epoxy coated or p/t tendons are fully encapsulated, all chairs and slab bolsters shall be epoxy coated or plastic and all support bars shall be epoxy coated. Chairs are to be stable and resist tipping. Acceptable products are GTI or approved equal.

The fabricator shall submit a complete list of accessories and placing details with the shop drawings.

No horizontal construction joints shall be placed in beams, joists, or slabs, unless shown on drawings.

Locate vertical construction joints in beams and slabs at central one third of span. Refer to drawings for details. Submit proposed construction joint locations to the Structural Engineer of Record for review prior to placement of concrete. Where new concrete is placed against existing concrete, the existing concrete shall be roughened to a minimum 1/4" amplitude.

Refer to drawings and ACI 318 Chapter 6 for placement guidelines of embedded pipes, sleeves, and conduits. Conduits are not permitted in slabs 3 inches or less in thickness. The maximum size of conduits within any slab shall be 1 1/4" outside diameter and shall be spaced no closer (to each other or any reinforcing steel) than 4" unless prior approval is obtained from the structural engineer. Additional reinforcing steel and chairs may be required to support embedded conduit. All conduit shall be placed in the middle 1/3 of the slab thickness above the metal deck, typical. Conduit may <u>not</u> be tied to parallel reinforcing steel. Conduit may <u>not</u> be paced in deck flutes. Conduit may not cross within slabs 5" or less in thickness. Conduit placement drawings may be required in areas of high conduit concentricity.

Provide a 3/4 inch chamfer for all exposed concrete corners. See Architectural drawings for details and additional

The general contractor shall notify the Special Inspector a sufficient period in advance of placing concrete to allow required inspections and testing to occur in a timely fashion.

Formwork and all shoring for flatwork shall be left in place until the concrete reaches at least 75 percent of the 28day compressive strength. Design of shoring and reshoring is the responsibility of the contractor and shall conform

Aluminum conduit, aluminum sleeves and aluminum embeds are not permitted in concrete.

Exterior concrete to have 6% +/- 1% entrained air.

Calcium chloride is not permitted as a concrete additive

Concrete Cover on Reinforcing:

Topping Slab: 3/4" clear top. See drawings for cover at composite slabs Slab on Grade: 3" bottom

Footings: 3" clear bottom and sides 2" clear top

Walls: #5 and smaller 1 1/2" clear earth or weather face #6 and greater 2" clear earth or weather face 3/4" interior face Columns and Beams: 1 1/2" clear to ties or stirrups

CONCRETE SLABS ON GRADE: Slabs on grade shall be place in lane fashion.

The control or construction joints shall be placed as shown on the drawings. The joints shall align with the column grids and be spaced as noted below:

Exterior slabs 24 times slab thickness, maximum; Interior slabs 36 times slab thickness, maximum; Interior slabs 48 times slab thickness, maximum, with carpeting

The panels formed by control or construction joints shall not be "L" shaped and a rectangular panel's aspect ratio shall not exceed 1.5.

Refer to the drawings for the typical slab on grade construction and saw cut control joint detail. Control and construction joints must be continuous and not offset.

Refer to drawings for detail of isolation diamonds or circles at columns.

Refer to drawings for reinforcing at re-entrant corners. Bend bars as necessary at obstructions.

Refer to the specification for the existence, type, and thickness of interior ground vapor retarder. Locate a vapor retarder directly beneath the slab on grade on top of a 6 inch compactable granular base. Refer to the specification for requirements for the compactable granular base.

Mechanically vibrate concrete around trench drains, floor ducts, construction joint dowels, loading docks, architectural features and other embedded items.

Refer to the specification for slab on grade pre-placement meeting.

Refer to the specification for acceptable methods of curing the concrete

Refer to flooring manufacturer's specification for levelness, flatness and curing of concrete slabs on grade to receive special architectural floor finishes.

REINFORCED MASONRY: All masonry units are placed in running bond fashion. Corners shall have a standard bond by overlapping units.

Special shapes shall be provided for jambs, columns, pilasters, control joints, corners, and lintels

All masonry walls shall have horizontal joint reinforcing spaced at 16" o.c. Horizontal joint reinforcing shall be truss style and fabricated with galvanized nine-gauge wire and shall include corner and intersecting wall pieces. Provide minimum 6" laps at all splices.

Vertical reinforcing shall be held in place by rebar positioners, crossties, chairs, or tying to every other layer of horizontal reinforcing steel. Refer to the detail in the drawings for vertical reinforcing bar location in a core.

Provide concrete cover of minimum 1/2" to face shell.

Refer to detail in the drawings for reinforcing bar lap lengths.

Extend vertical reinforcing from footings to 2" clear top of wall or to beam bearing. Extend vertical reinforcing into the next level of construction and lap in accordance with the lap schedule.

When typical vertical wall reinforcing is interrupted by long wall openings, provide typical vertical wall reinforcing above and below opening, and extend into horizontal bond beams. Refer to the schedule on the drawings, for masonry wall opening lintels. Refer to the detail in the drawings for masonry openings minimum jamb reinforcing.

Provide vertical reinforcing at the ends of walls and at wall intersections to match specified reinforcing. Run reinforcing full height of walls.

All masonry units shall be placed with full face shell mortar coverage on horizontal and vertical face shells. Webs shall also have full mortar coverage around all grouted cells.

Fill block core at vertical reinforcing (8" minimum length along wall) with concrete grout. Filling cores with mortar is not allowed. Vibrate in place. Rodding and puddling are not allowed.

Maximum lift height is four feet. For concrete core fill pour height up to maximum 8'-0", provide cleanouts if pour height exceeds 5'-0".

Masonry cement mortar is not allowed.

Calcium chloride or admixtures containing chloride shall not be used in mortar or grout.

For reinforced masonry bond beams, provide bent corner bars at corners and intersections that match reinforcing. Step bond beams as necessary to match roof slopes. Lap reinforcing bars per schedule.

For construction of masonry control joints refer to detail in drawings.

Unless noted otherwise on the drawings place control joints in masonry walls such that no straight run of wall exceeds 24'-0" and within 4'-0" of corners. Do not place control joints within 48 inches of a masonry opening jamb or

Place bond beam reinforcing continuously through control joints. Do not splice bond beam reinforcing within 6'-0" of

Provide bond beam with reinforcing at all floor lines, roof lines, and top of walls. Refer to details in the drawings. Grout below steel bearing plate and refer to the drawings for additional information.

Refer to drawings for reinforcing schedule, top of wall bracing, thickened bearing slab and lintel schedule for nonbearing masonry walls. Refer to Architectural drawings for location and extent.

For all masonry beams use lintel blocks.

MASONRY BEAMS (HIGH-LOW BOND BEAMS):

Masonry beams are to bear 8" minimum at jambs. Extend vertical reinforcing through masonry beam bearing.

Extend horizontal reinforcing full length.

Grout masonry beams solid. Mechanically vibrate grout in place.

**EXPANSION AND ADHESIVE ANCHORS:** 

Anchors in concrete or concrete masonry when not exposed to earth, weather, or corrosive environment shall be as noted below:

> Expansion anchors shall be stud type with a single piece three section wedge and zinc plated in accordance with ASTM B633.

Threaded anchor rod for adhesive anchors in concrete shall be ASTM A193, Grade B7, or ASTM A36, as noted in the drawings. The adhesive used for anchors shall be a structural grade, two part epoxy or acrylic material that meets the requirement of ASTM C-881 Types I, II, IV, and V, Grade 3, Classes B and C as noted on plans.

Holes shall be drilled with a bit and cleaned using a method that complies with the manufacturer's guidelines, and specifications. Do not cut or damage reinforcing steel or P-T tendons.

Upon the request of the structural engineer the anchors shall be proof tested by the manufacturer to verify capacity of anchors that do not meet the conditions in the construction documents.

Minimum embedment depths in concrete and concrete masonry for expansion and adhesive anchors shall be as noted below

For 1/2", 5/8", and 3/4" diameter expansion anchors provide 4 3/4"embed, UNO on plan.

For 1/2" and 5/8" diameter adhesive anchors provide 5" embed. For 3/4" diameter adhesive anchors provide 7" embed, UNO on plan.

Grouted solid concrete masonry unit material: For 1/2", 5/8", and 3/4" diameter expansion anchors provide 4 3/4" embed, UNO on plan.

For adhesive anchors refer to the product's ICBO Report.

Pre-approved manufacturer are as follows: HILTI, ITWR Ramset/Redhead, Powers Fasteners, and Simpson Strong-Tie. For review of alternate products, submit manufacture's product data and product's current ICBO eport prior to construction.

Anchors in concrete or concrete masonry when exposed to earth, weather, or corrosive environment shall be manufactured from AISI 304/316 Stainless Steel.

Structural steel shall be detailed, fabricated and erected in compliance with AISC Specification for the design, fabrication, erection of structural steel for building, and Code of standard practice, and OSHA steel erection standards.

All beams and girders shall be cambered at mid-span as indicated on the structural drawings. The cambers indicated shall be present in the beam in its erected position after completion of the end connections and shall be verified prior to placing concrete. Cambering tolerances shall be (-0", +1/4"). No center point cambering allowed.

Splicing structural members where not detailed on the drawings is prohibited without prior approval of the

Modification of structural steel members in the field is not allowed without written approval by the structural

All composite beams using the concrete slab as a compression flange are designed for unshored construction unless noted otherwise.

Anchor rods shall be minimum 3/4" diameter or as detailed in drawings.

unfactored, working loads.

All steel connections shall be designed by the steel fabricator for the criteria indicated on the drawings unless noted or detailed otherwise. Connection design shall conform to the requirements of the AISC Specifications for the design, fabrication, erection of structural and OSHA regulations. Submit calculations certified by a Professional Engineer who is licensed in the state of Minnesota. All loads indicated on the drawings are

Non-composite beams: Unless noted otherwise, design simple beam shear connections per the AISC Manual connection tables. The required end reaction shall be based on the reactions indicated on the plans. Design connections for the reactions indicated on plan or for the minimum connection requirements indicated in the Connection Schedule, whichever provides the greater capacity.

Composite beams: Design simple composite beam shear connections per the AISC Manual connection tables UNO. Design connections for the reactions indicated on the plans or the minimum connection requirements indicated in the Connection Schedule, whichever provides the greater capacity.

Unless detailed otherwise, beam shop connections may be welded or bolted and field connections are to be bolted. Bolts shall be a minimum 3/4" diameter for connections specified or detailed in the drawings. The fabricator may submit an alternate connection with the calculations that is certified by a professional engineer

All beam web copes must be made to a 1 inch minimum radius.

Welded connections shall be made in accordance with ANSI/AWS D1.1 Structural Welding Code using E70XX electrodes unless noted otherwise. Weld sizes not shown or controlled by the required forces shall be AWS code minimum size. Welds shall be visually inspected for compliance with the AWS code visual inspection criteria. Welders shall be qualified in accordance with ANSI/AWS D1.1 and shall be experienced in weld in structural steel.

Full penetration welds shall be tested using NDT methods such as ultrasonic, magnetic particle or other methods referenced in the AWS code. Welds subject to NDT methods shall also have been found compliant with the AWS visual inspection criteria.

STRUCTURAL STEEL STAIRS: Structural steel stair stringers, components, railings, posts, hangers, and connections to be designed by the fabricator's Qualified Professional Engineer for the loads indicated in the specifications. Configuration of stringers and railings shall be as indicated on the architectural drawings. Channel stringers to have a minimum

12" depth and a minimum 1 1/2" flange width.

STEEL ROOF DECK:

Manufacturer shall be a current member of the Steel Deck Institute (SDI). Detail, manufacture and install steel roof deck and accessories in accordance with the SDI specifications and

codes and OSHA requirements.

Steel roof deck shall be as noted on plan. Welding shall be in accordance with AWS D1.3. Welders shall be qualified in accordance with AWS D1.3.

Where spray-on fireproofing of the deck is required, the contractor shall verify that the deck finish is compatible with the proposed fireproofing material to ensure proper bonding of the fireproofing. Coordinate fireproofing locations and requirements with the architect.

All steel deck shall span a minimum of three spans, unless otherwise approved by the engineer. Deck ends are to be lapped over supports

Contractor shall verify the location and extent of acoustical steel deck with the architectural drawings. Reference drawings for detail on steel roof deck fastening requirements unless noted otherwise. Powder actuated or pneumatically driven fasteners are not allowed.

Provide reinforcement or frames for deck openings as indicated on the drawings.

LIMITATIONS ON M/E SUPPORT FROM PRIMARY STRUCTURE: All M/E systems shall be supported from the primary structural frame, unless noted otherwise. Do not connect to roof deck, floor slabs, or secondary members unless specifically allowed on the structural construction

All M/E support systems, hangers, brackets and connections to the primary structural frame shall be designed,

provided and installed by the M/E contractor, unless noted otherwise on the structural construction documents. All M/E supports and connections for loads in excess of 300 lbs shall be designed by a structural engineer licensed in the state of Minnesota and engaged by the M/E contractor.

**COMPOSITE STEEL FLOOR DECK:** Manufacturer shall be a current member of the Steel Deck Institute (SDI).

documents.

Composite steel floor deck shall be as noted on plan. Detail, manufacture and install composite steel floor deck and accessories in accordance with the SDI

specifications, codes and OSHA steel erection standards. Refer to drawings for composite steel floor deck fastening requirements unless noted otherwise. Powder actuated

as required by the SDI unless otherwise indicated or detailed.

Provide and install pour stops, column closures, end closures, cover plates and girder fillers and other accessories

Where spray-on fireproofing of the deck is required, the contractor shall verify that the deck finish is compatible with the proposed fireproofing material to ensure proper bonding of the fireproofing. Coordinate fireproofing locations and requirements with the architect.

Provide reinforcement or frames for deck openings as indicated on the drawings. Do not cut control joints in structural slabs on metal deck.

or pneumatically driven fasteners are not allowed.

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DULUTH INTERNATIONAL **AIRPORT** DULUTH, MN

**NEW TERMINAL** DESIGN

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Structural Engineers: MBJ CONSULTING ENG. 501 Lake Avenue South, Suite 300, Duluth MN 55802 TEL: (218) 722-1056 / FAX: (218) 722-9306

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TEL: (218) 591-5079

Landscape Consultants: **APPOLD DESIGN** 2432 East First Street, Duluth MN 55812

I hereby certify that this plan, specification, or report was prepared by me or under my direct supervision and that I am a duly licensed Professional Engineer under the

Print Name: Paul A. Johnson

laws of the State of Minnesota.

Signature:

REVISIONS DESCRIPTION DATE **BID PACKAGE 1** 5.12.10 FOUNDATION PERMIT 6.4.10 ADDENDUM 1 6.11.10 NOT CHANGED 7.12.10 CONFORMANCE SET **BUILDING PERMIT** 8.6.10

BUILDING PERMIT REVISIONS 11.12.10

12.15.10

01.24.11

05.02.11

Date: June 3, 2010 Reg. No.: 20379

BP 2A CONFORMANCE **DATE ISSUED:** 08-23-11 **REVIEWED BY:** PAJ / CWB

100% REVIEW

**DESIGNED BY:** CWB

DRAWN BY:

BID PACKAGE 2A

AEP PROJECT NUMBER 213-1882-091

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SJL

SHEET TITLE **GENERAL STRUCTURAL** 

**SHEET NUMBER** 

NON-COMPOSITE STEEL FLOOR DECK:

Manufacturer shall be a current member of the Steel Deck Institute (SDI).

Non-composite steel floor deck shall be as noted on plan.

18 gauge and as noted on the drawings.

Detail, manufacture and install non-composite steel floor deck and accessories in accordance with the SDI specifications and codes and OSHA steel erection standards.

Refer to drawings for non-composite steel floor deck fastening requirements. Powder actuated or pneumatically driven fasteners are not allowed.

Where spray-on fireproofing of the deck is required, the contractor shall verify that the deck finish is compatible with the proposed fireproofing material to ensure proper bonding of the material. Coordinate locations and

Provide reinforcement or frames for deck openings as indicated on the drawings.

#### **LIGHT GAUGE METAL FRAMING:**

requirements with the architect.

The design and connection detailing of all light gage material including, but not limited to exterior studs, bearing studs, headers, jambs, joists, rafters and anchorage shall be by the Light Gauge Supplier. The design for systems other than bearing framing shall meet the following criteria:

Stud in exterior walls shall be minimum 600S162-43 (6"-18 gauge) studs at 16" OC. See architectural for additional spacing requirements at exterior finishes.

Studs shall be cold rolled steel, galvanized, C shape, with minimum 1 5/8" flange and minimum 1/2" return. They are to be punched for utility access and galvanized to G60 coating per ASTM 525.

At all openings in exterior and bearing walls provide a minimum two studs full wall height each side of opening and a minimum one additional stud each side for lintel bearing.

Anchor bottom track to concrete or masonry with minimum 5/32" x 1 1/4" power driven fasteners at 16" OC.

Top and bottom tracks shall be cold rolled or break formed steel, galvanized U shaped and minimum

Light gauge metal framing fasteners shall be minimum #10 self-drilling sheet metal screws, 16 threads per inch, with low profile head. Provide a minimum of two screws per connection unless noted

Fasten light gage framing to wood with minimum #10 x 1 7/8" bugle head wood screws. Pre-drill holes in metal studs. Provide a minimum of two screws per connection unless noted otherwise.

All framing components shall be squarely cut for attachment to perpendicular members. Stud ends must seat tightly into tracks for all bearing applications.

At all wall elements, provide 1 1/2"-16 gauge horizontal channel bridging to prevent stud rotation. For all axial loaded walls, space bridging at 4'-0" OC. For all non-load bearing exterior walls, space bridging at 5'-0" OC.

#### Wall stud deflection criteria:

For wall studs providing lateral support to masonry veneer and cementitious stucco, provide L/600.

For wall studs providing lateral support to other materials, provide L/360.

### Joist and rafter deflection criteria:

Live Load Deflection is L/360.

Total Load Deflection is L/240.

An additional joist shall be provided under parallel non-load bearing partition walls.

The light gauge supplier shall submit certified shop drawings and design calculations prepared by a qualified Professional Engineer registered in the state of Minnesota. See project specification manual for additional submittal requirements.

All light gauge designations are in accordance with the Steel Stud Manufacturers Association (SSMA).

Refer to architectural drawings and specification for size, minimum gage, extent, and location of interior nonbearing light gage framing not shown on the structural drawings. Interior light gauge framing is to be designed for 5 psf lateral pressure by the light gauge supplier.

Temporary bracing shall be furnished by the light gauge supplier and framing installer and maintained until permanent systems providing lateral stability are in place.

Welding shall conform to the American Welding Society (AWS) "Structural Welding Code - Sheet Steel, D1.3 - Current Edition." Welders shall be qualified in accordance with AWS D1.3 and shall be experienced in light gage welding.

All light gage material to be welded must be nominal 16 gauge or thicker.

Touch up all light gage material at welds with zinc-rich paint.

Align load bearing wall studs with floor or roof joists.

Splices in studs, joists, and headers, are not permitted, unless approved in writing by the structural engineer.

Framing components may be pre-assembled into panels prior to erecting. Prefabricated panels shall be square, with components attached in a manner that prevents racking.

## SPECIAL INSPECTION SCHEDULE:

SPECIAL INSPECTIONS REQUIRED OF STRUCTURAL ELEMENTS (PER IBC 2006, CHAPTER 17):

	Continuous	Periodic	Not Reg'd	See Arch.	
1. Steel *			'		Table 1704.3
1.1 Welding					
1.2 Details					
1.3 High-strength Bolts					
2. Concrete					Table 1704.4
<ol> <li>Reinforcing steel including Prestressing tendons</li> </ol>					
2.2 Bolts installed in concrete					
2.3 Required design mix					
2.4 Sampling					
2.5 Shotcrete					
2.6 Curing techniques					
2.7 Prestressed concrete					
forces and grouting					
2.8 Erection of precast concrete members					
2.9 Verification of IN-SITU concrete strength					
3. Masonry					
3.1 Level 1 Special Inspection *					1704.5.1, 1704.5.2, Table 1704.5.1
3.2 Level 2 Special Inspection					1704.5.3, Table 1704.5.3
4. Wood					1704.6
5. Soils					1704.7
<ol><li>Pile Foundations</li></ol>					1704.8
<ol><li>Pier Foundations</li></ol>					1704.9
<ol><li>Wall Panel and Veneers</li></ol>					1704.10
<ol><li>Sprayed Fire-Resistant Materials</li></ol>					1704.11
<ol> <li>Exterior Insulation and Finish Systems (EIFS)</li> </ol>					1704.12
11. Special Cases					1704.13
<ol><li>Smoke Control Systems</li></ol>					1704.14

<sup>\*</sup> Please see referenced tables for exceptions.



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laws of the State of Minnesota.

Signature:

Date: June 3, 2010 Reg. No.: 20379

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1,2,3	NOT CHANGED			
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5	100% REVIEW	12.15.10		
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	BP 2A CONFORMANCE	05.02.11		

DATE ISSUED: 08-23-11

REVIEWED BY: PAJ / CWB

DRAWN BY: SJL

DESIGNED BY: CWB

AEP PROJECT NUMBER

213-1882-091


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GENERAL STRUCTURAL NOTES

SHEET NUMBER

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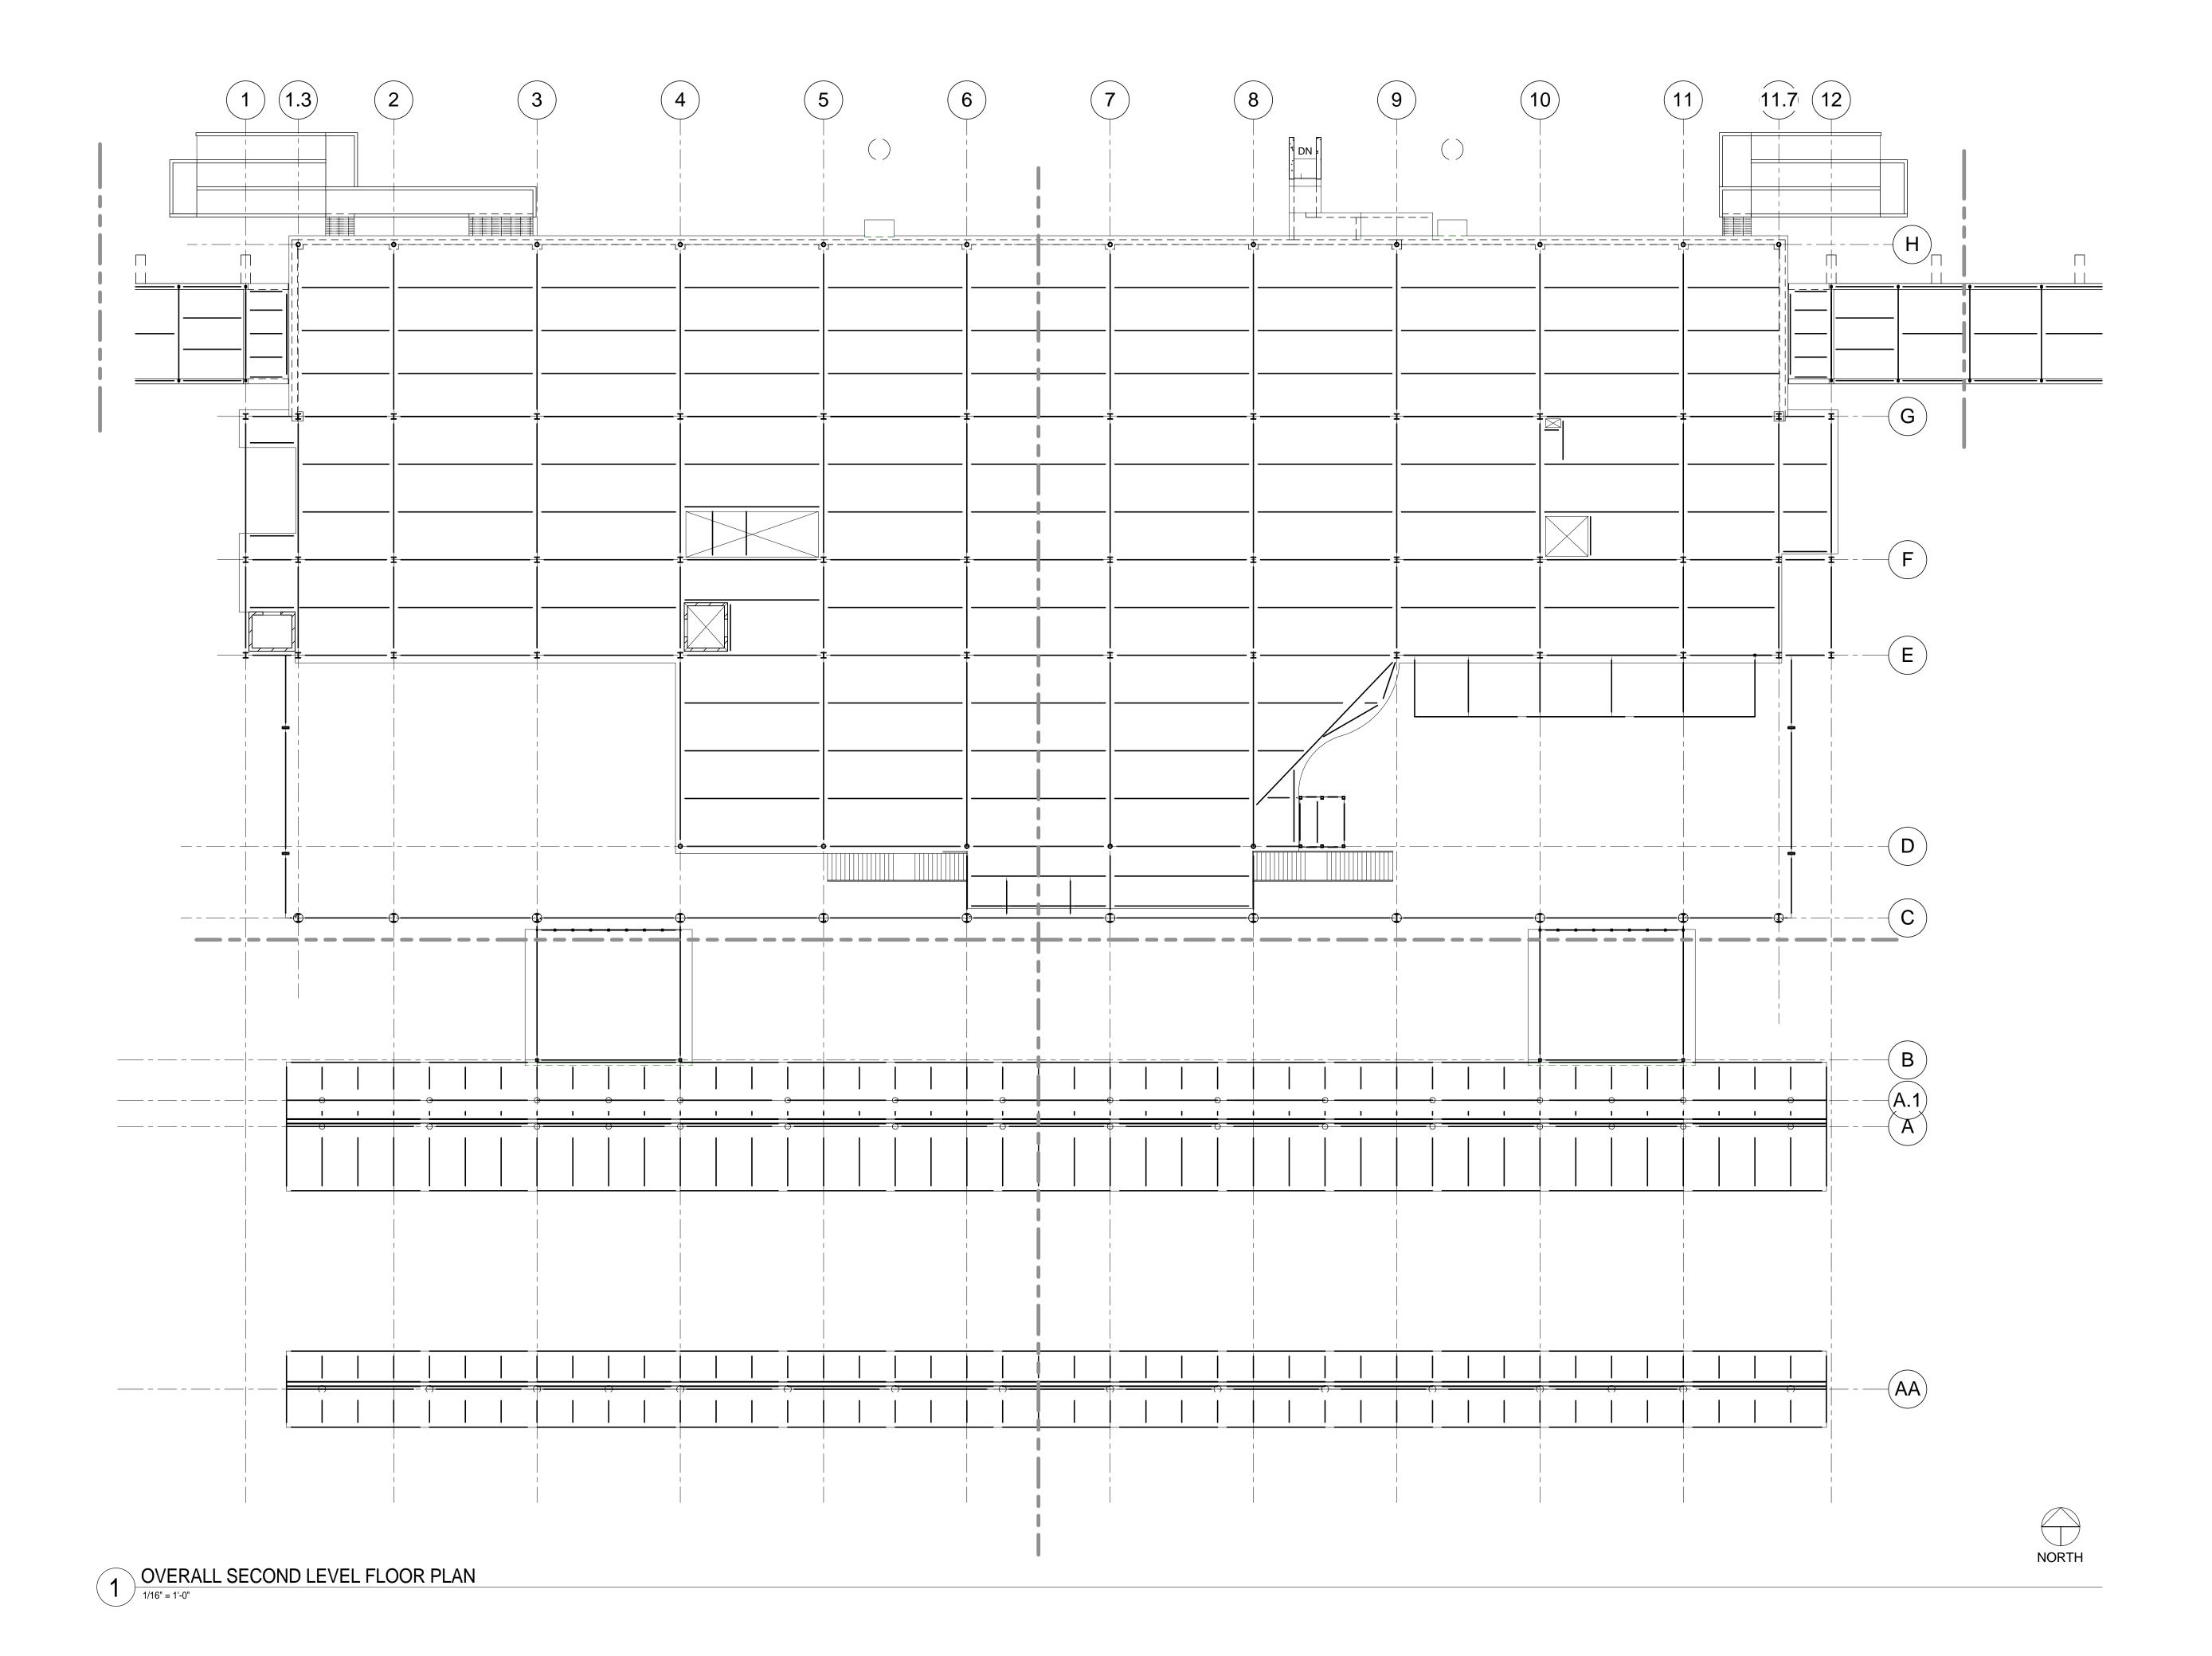
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OVERALL FIRST
LEVEL FLOOR
PLAN

SHEET NUMBER **S101** 



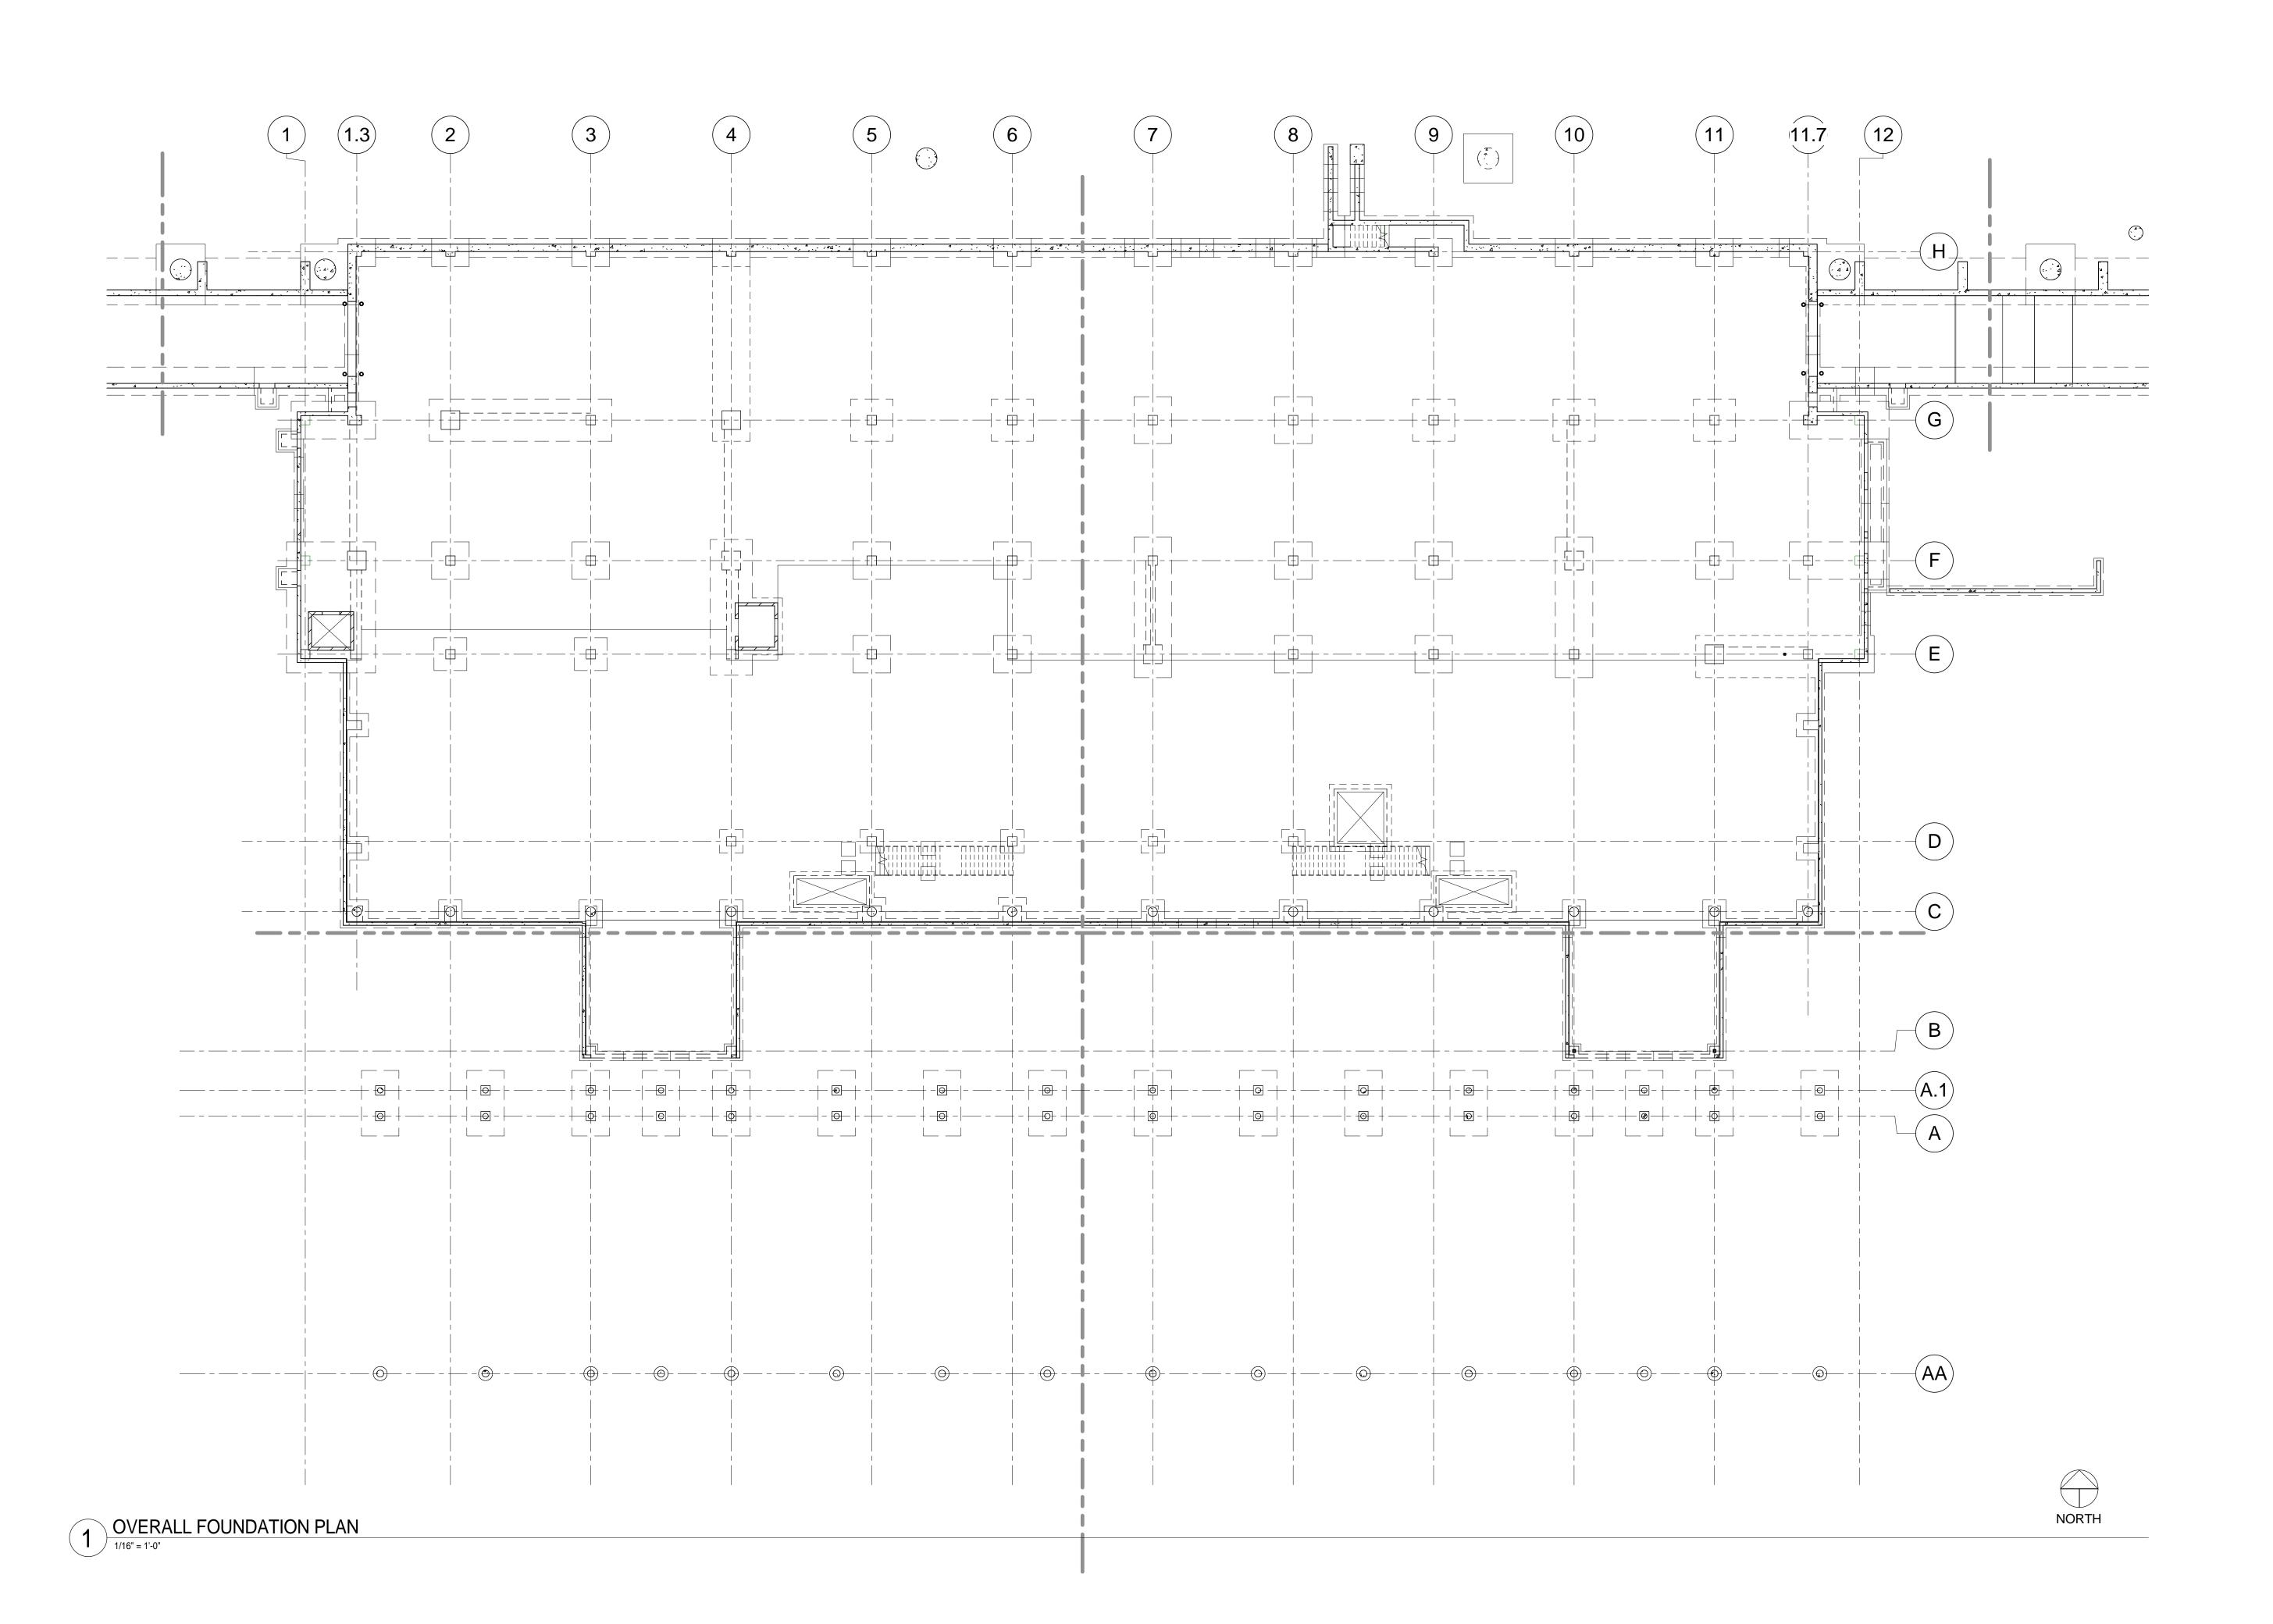

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BID PACKAGE 2A

BP 2A CONFORMANCE


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213-1882-091

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**OVERALL SECOND LEVEL FLOOR PLAN** 

> SHEET NUMBER **S102**



NORTH

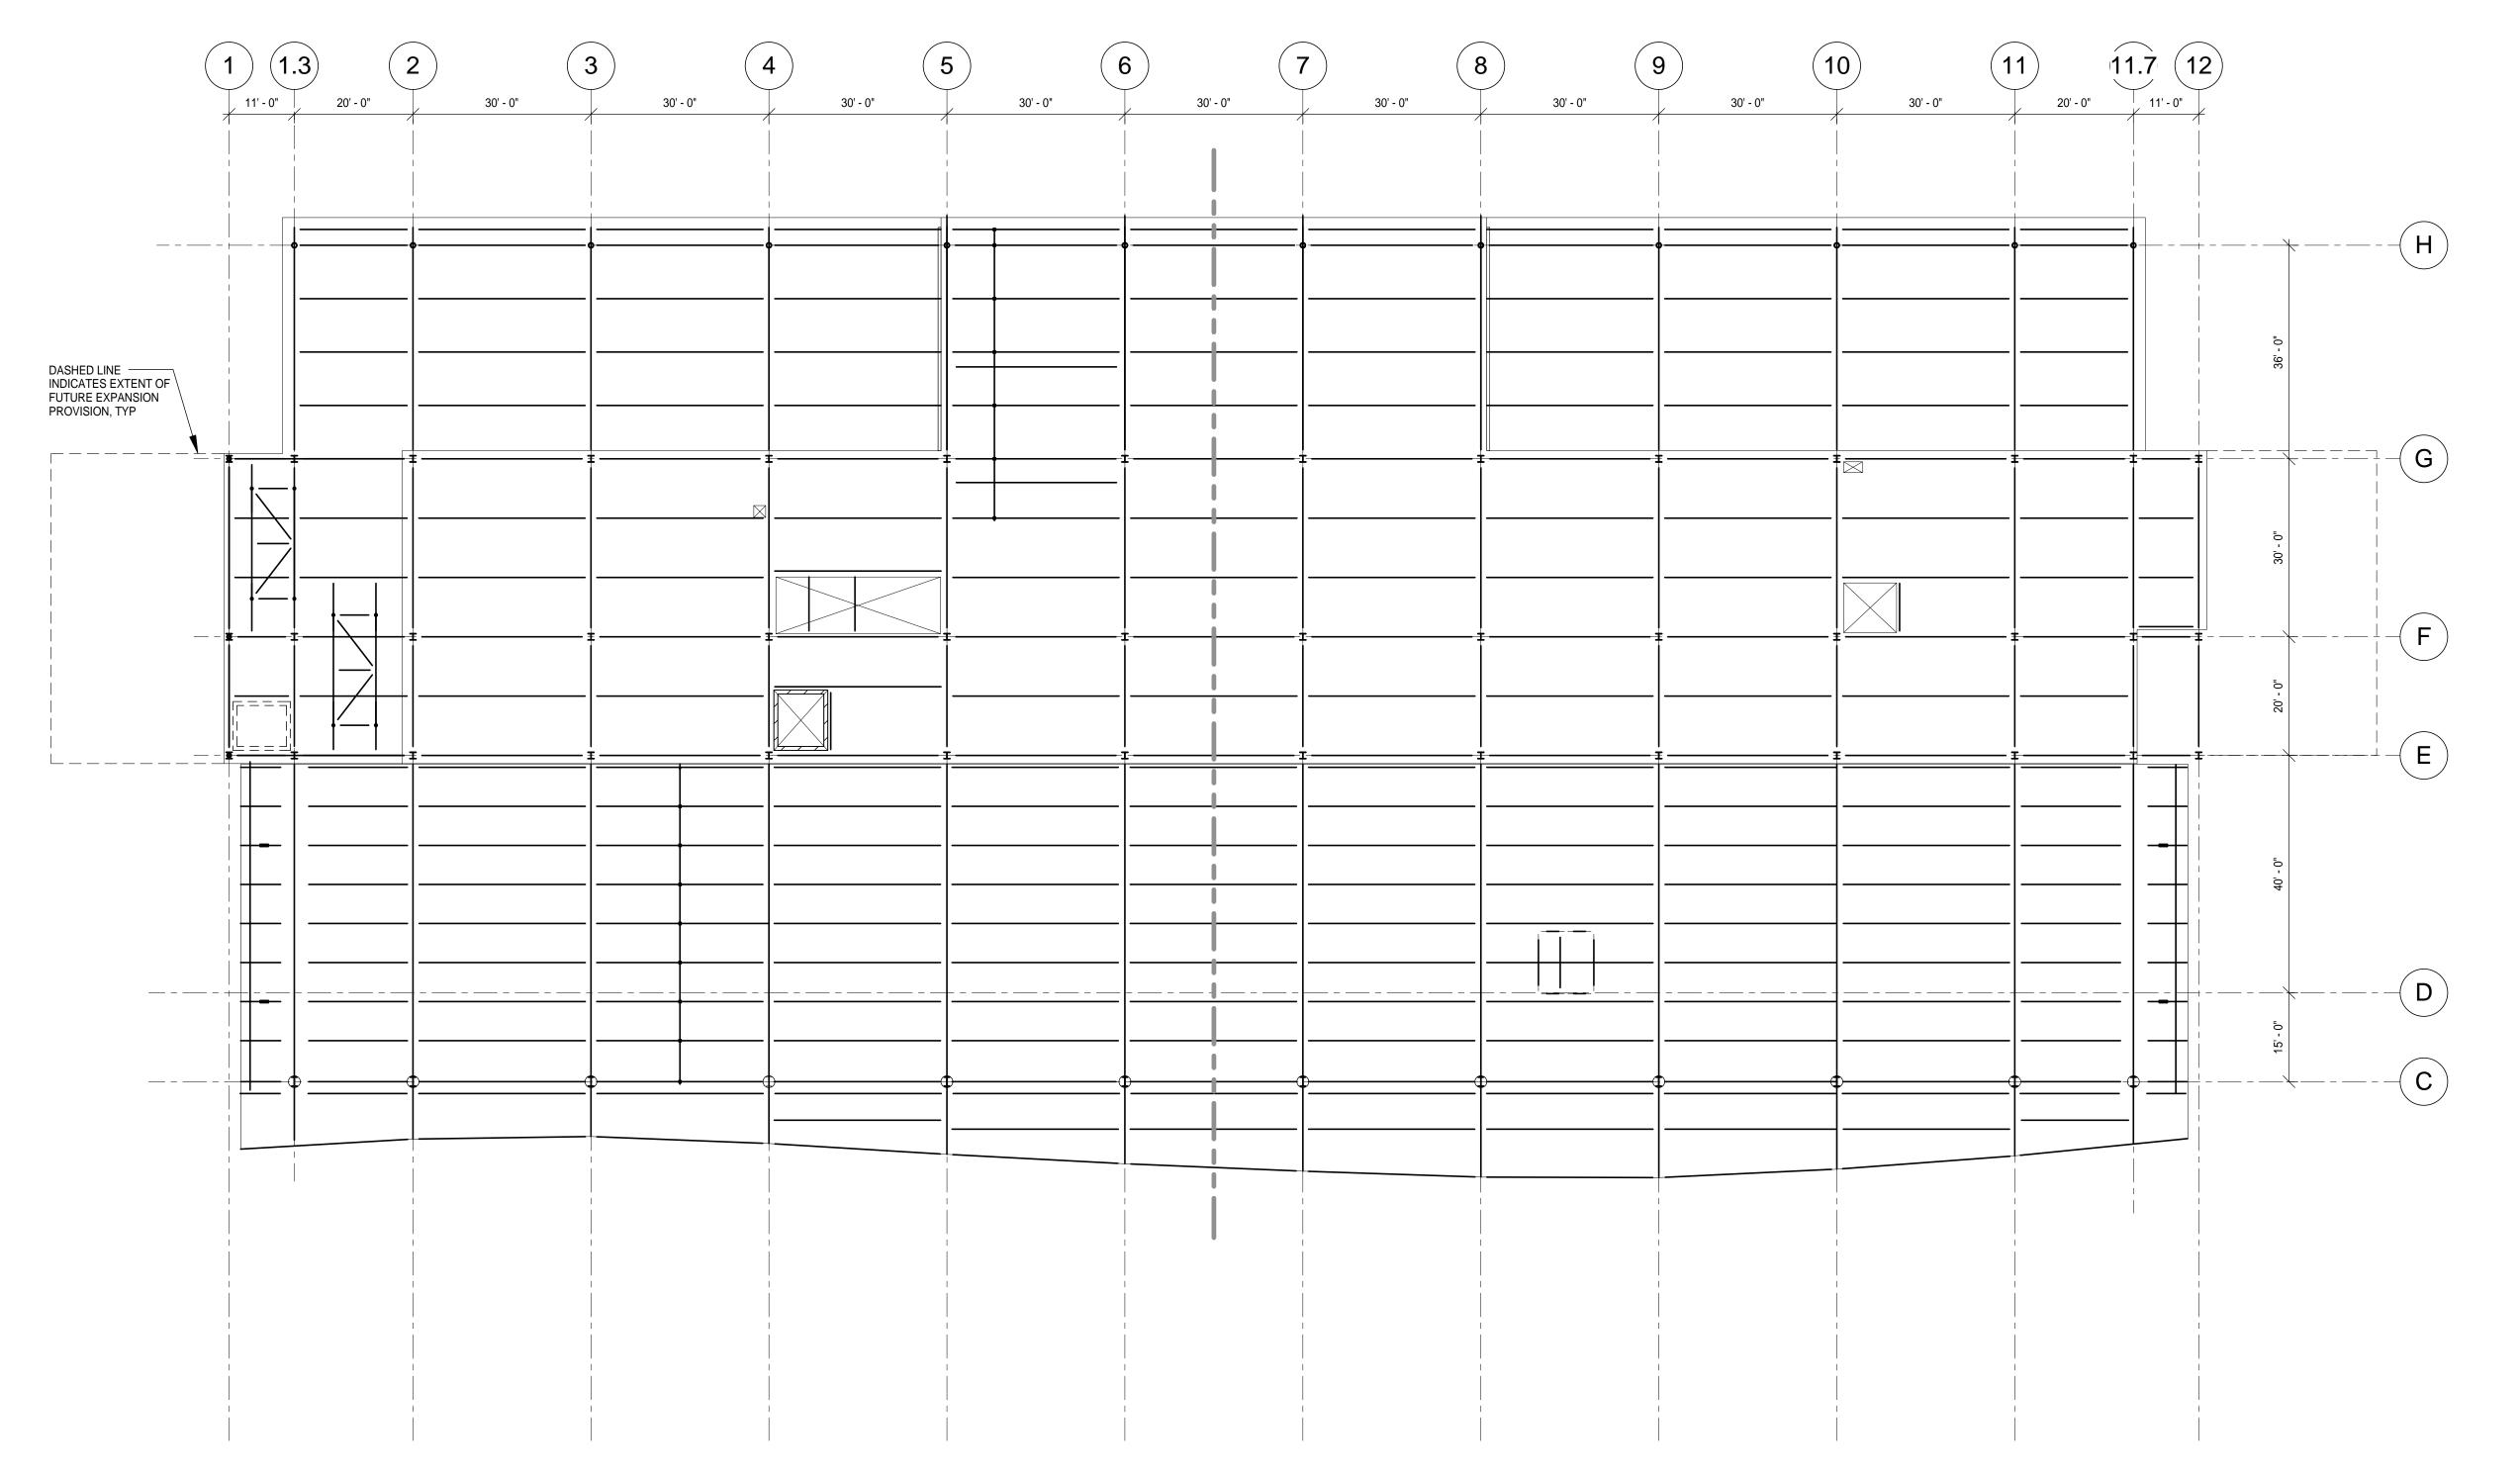1 OVERALL THIRD LEVEL FLOOR PLAN

1/16" = 1'-0"

N

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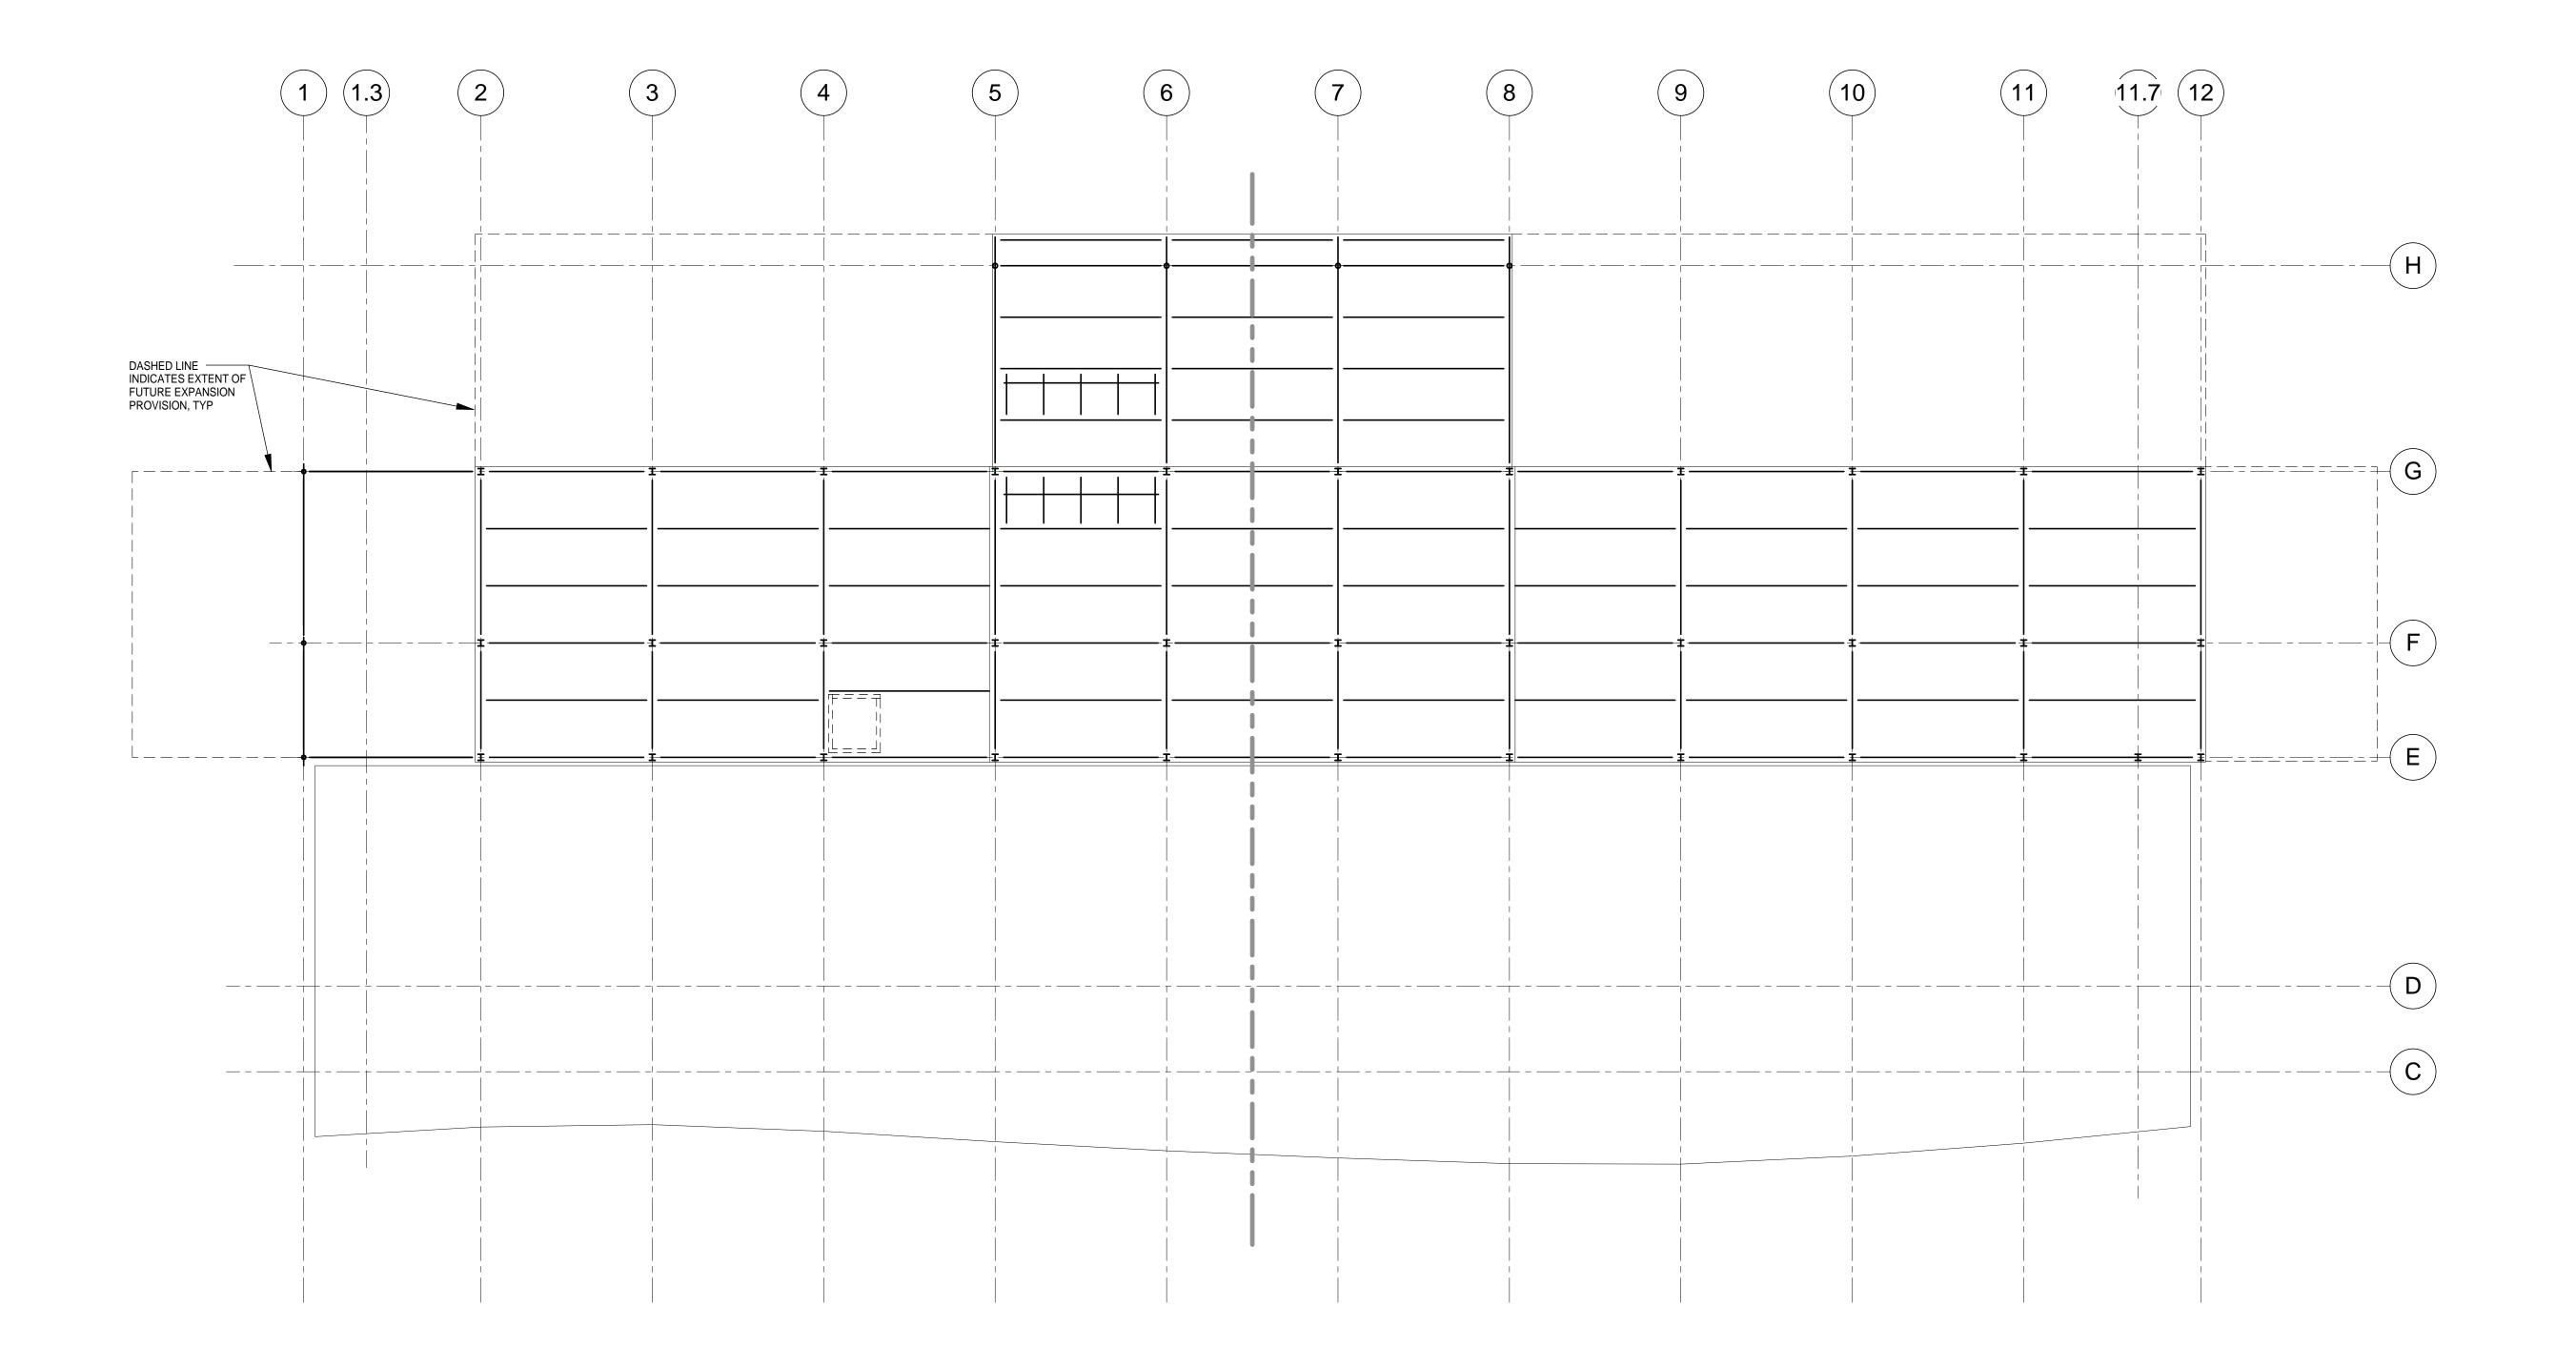
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## OVERALL THIRD LEVEL FLOOR PLAN

SHEET NUMBER S103









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NEW TERMINAL DESIGN

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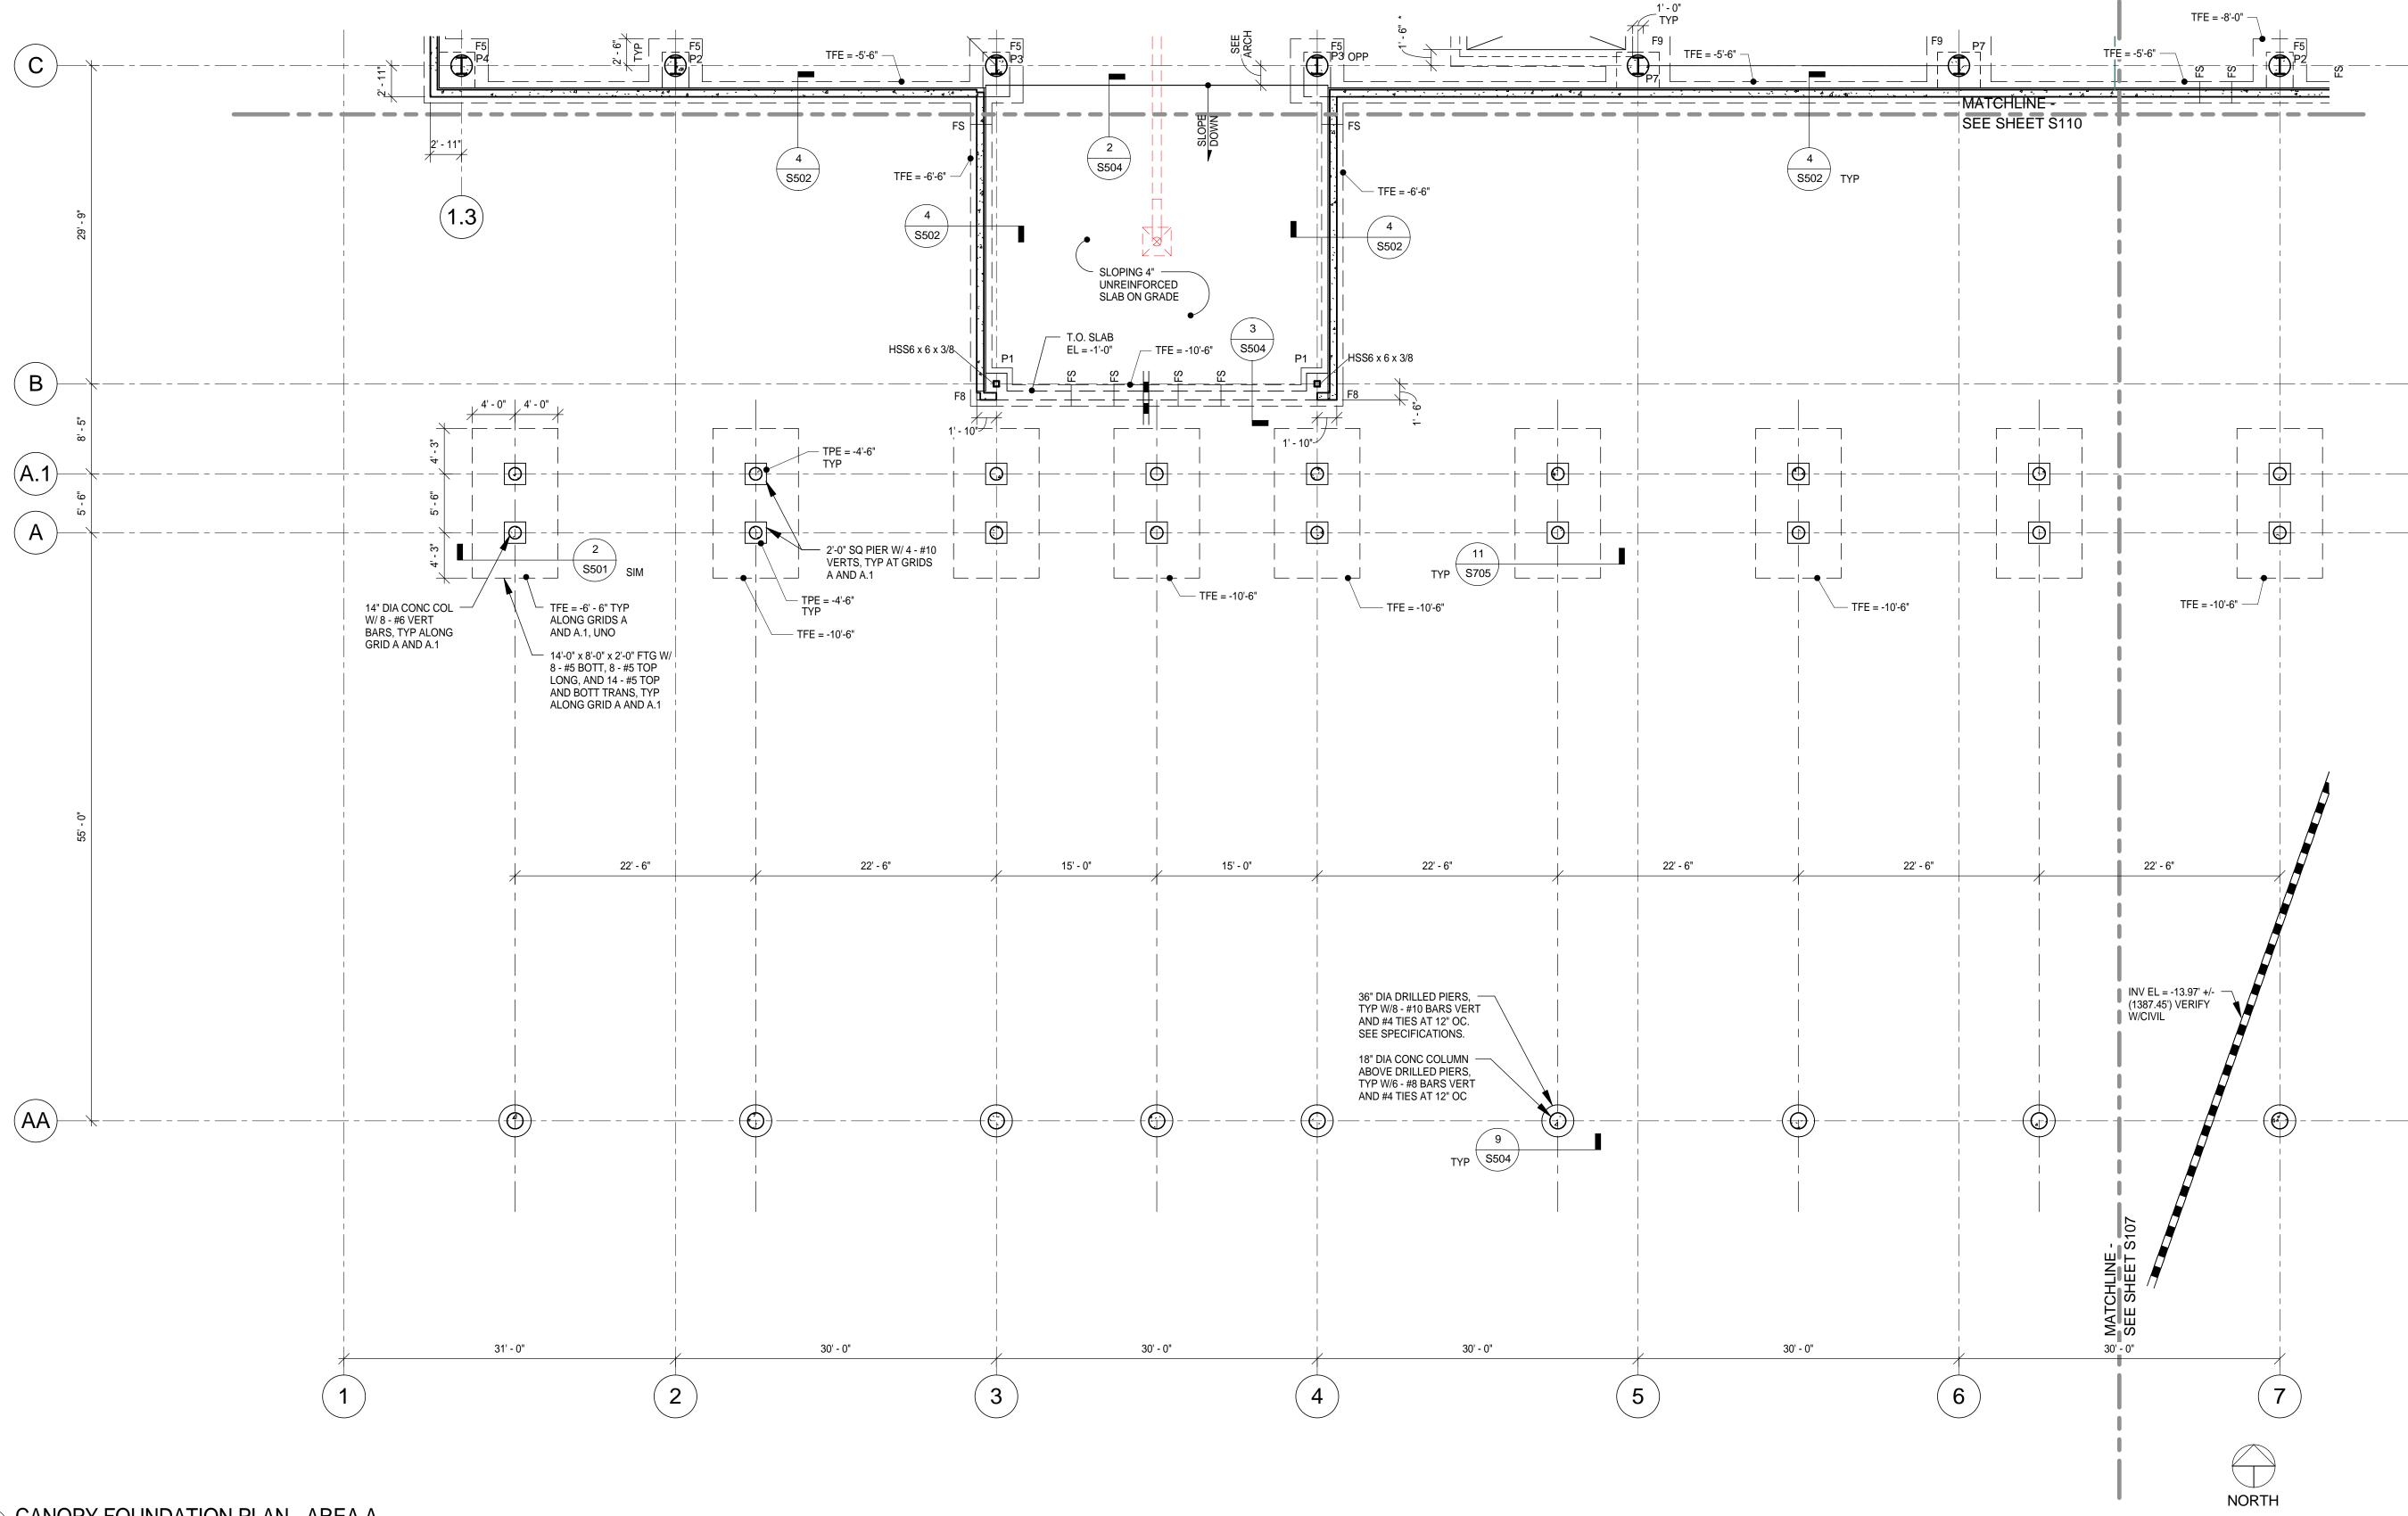
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OVERALL ROOF LEVEL PLAN

SHEET NUMBER S104



1 CANOPY FOUNDATION PLAN - AREA A

NOTES:
1. REFER TO \$110 FOR TYPICAL PLAN NOTES.



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laws of the state of Millinesota.

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01.24.11 05.02.11

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4	BUILDING PERMIT REVISIONS	11.12.1
5	100% REVIEW	12.15.1

DATE ISSUED:	08-23-11
REVIEWED BY:	PAJ / CWB
DRAWN BY:	SJL
DESIGNED BY:	CWB
AEP PI	ROJECT NUMBER

BID PACKAGE 2A


BP 2A CONFORMANCE

213-1882-091

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CANOPY
FOUNDATION
PLAN - AREA A

SHEET NUMBER
S106

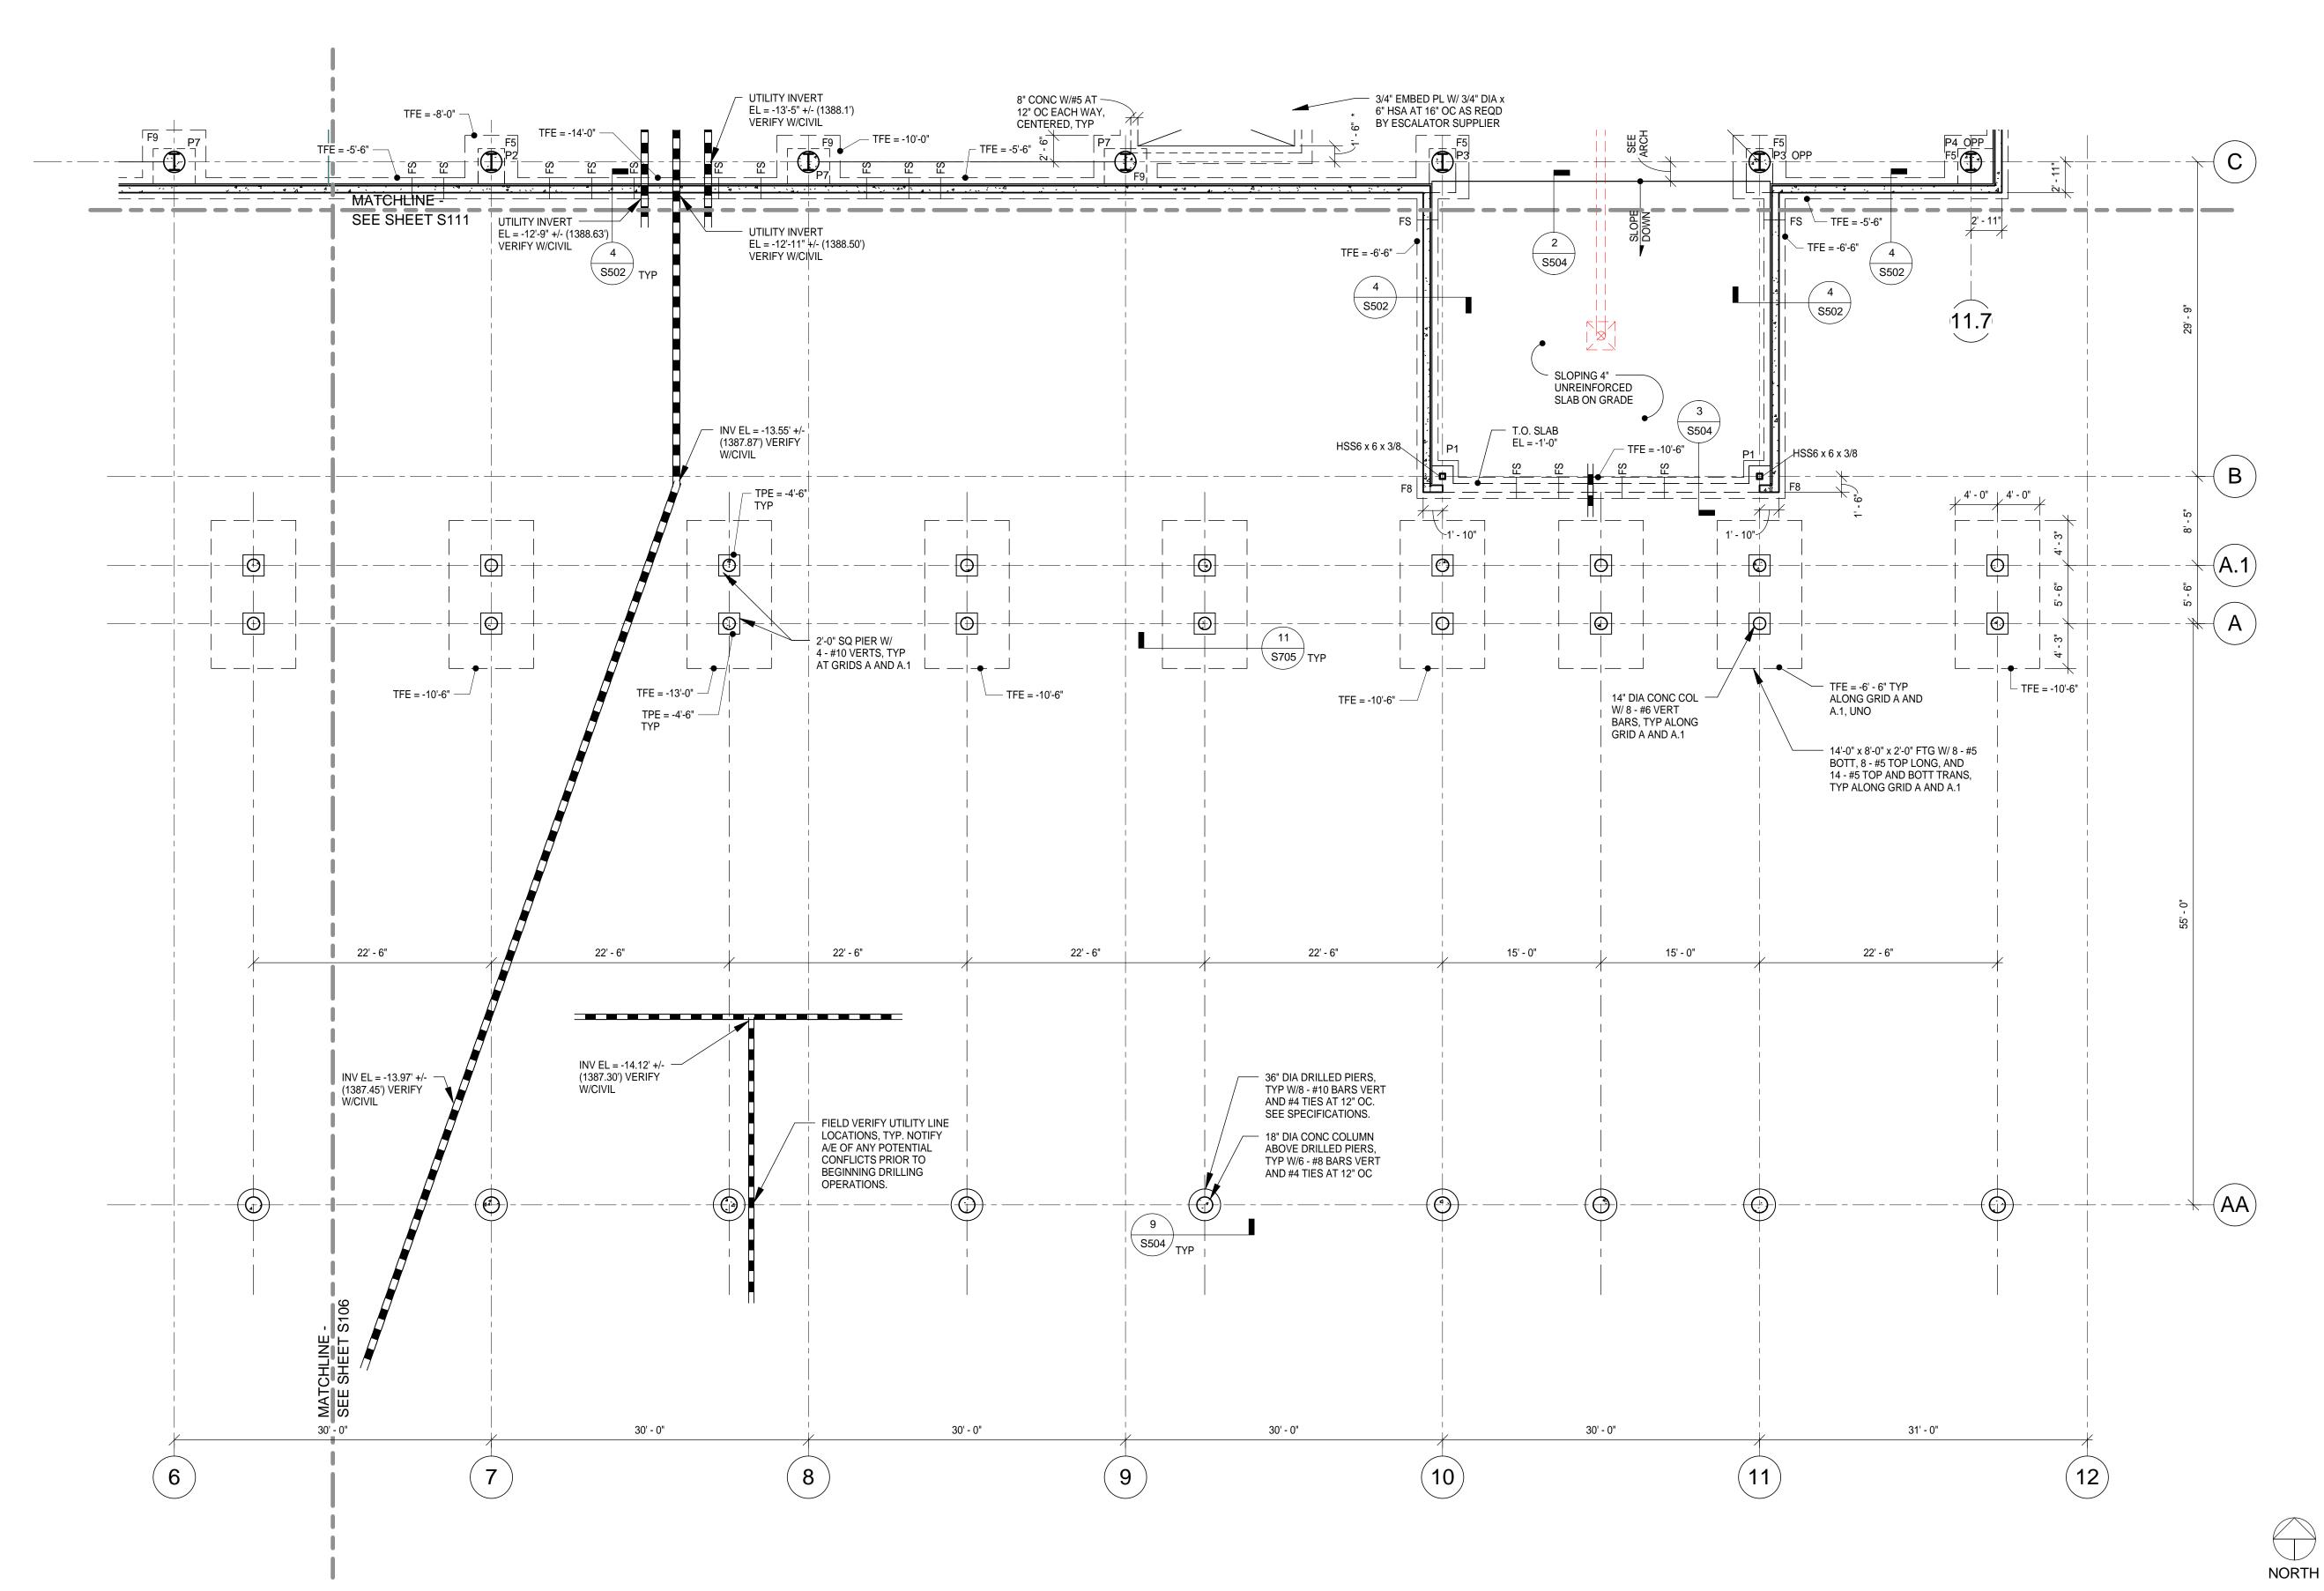

CANOPY FOUNDATION PLAN - AREA B

NOTES:
1. REFER TO S110 FOR TYPICAL PLAN NOTES.



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DULUTH INTERNATIONAL AIRPORT DULUTH, MN

NEW TERMINAL DESIGN

## CONSULTANTS

Interior Architects:

SJA ARCHITECTS

11 E Superior Street Suite 340 Duluth MN 55802
TEL: (218) 724-8578 / FAX: (218) 724-8717

## Structural Engineers: MBJ CONSULTING ENG. 501 Lake Avenue South, Suite 300, Duluth MN 55802

## TEL: (218) 722-1056 / FAX: (218) 722-9306 M/E/P/FP Engineers:

COSENTINI

1 East Wacker Drive, Suite 103, Chicago IL 60601 TEL: (312) 670-1800 / FAX: (312) 670-1801

Baggage Handling Systems Consultants: BNP ASSOCIATES INC.

101 East Ridge Office Park, Suite 103, Danbury CT 06810

# TEL: (203) 792-3000 / FAX: (203) 792-4900 Landscape Consultants: APPOLD DESIGN

2432 East First Street, Duluth MN 55812

TEL: (218) 591-5079

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Print Name: Paul A. Johnson

Signature:

Date: June 3, 2010 Reg. No.: 20379

REVISIONS			
DESCRIPTION	DATE		
BID PACKAGE 1	5.12.10		
FOUNDATION PERMIT	6.4.10		
NOT CHANGED			
CONFORMANCE SET	7.12.10		
BUILDING PERMIT	8.6.10		
BUILDING PERMIT REVISIONS	11.12.10		
100% REVIEW	12.15.10		
BID PACKAGE 2A	01.24.11		
BP 2A CONFORMANCE	05.02.11		
	DESCRIPTION BID PACKAGE 1 FOUNDATION PERMIT NOT CHANGED CONFORMANCE SET BUILDING PERMIT BUILDING PERMIT REVISIONS 100% REVIEW BID PACKAGE 2A		


DATE ISSUED:	08-23-11
REVIEWED BY:	PAJ / CWB
DRAWN BY:	SJL
DESIGNED BY:	CWB

AEP PROJECT NUMBER 213-1882-091

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CANOPY
FOUNDATION
PLAN - AREA B

SHEET NUMBER **S107** 

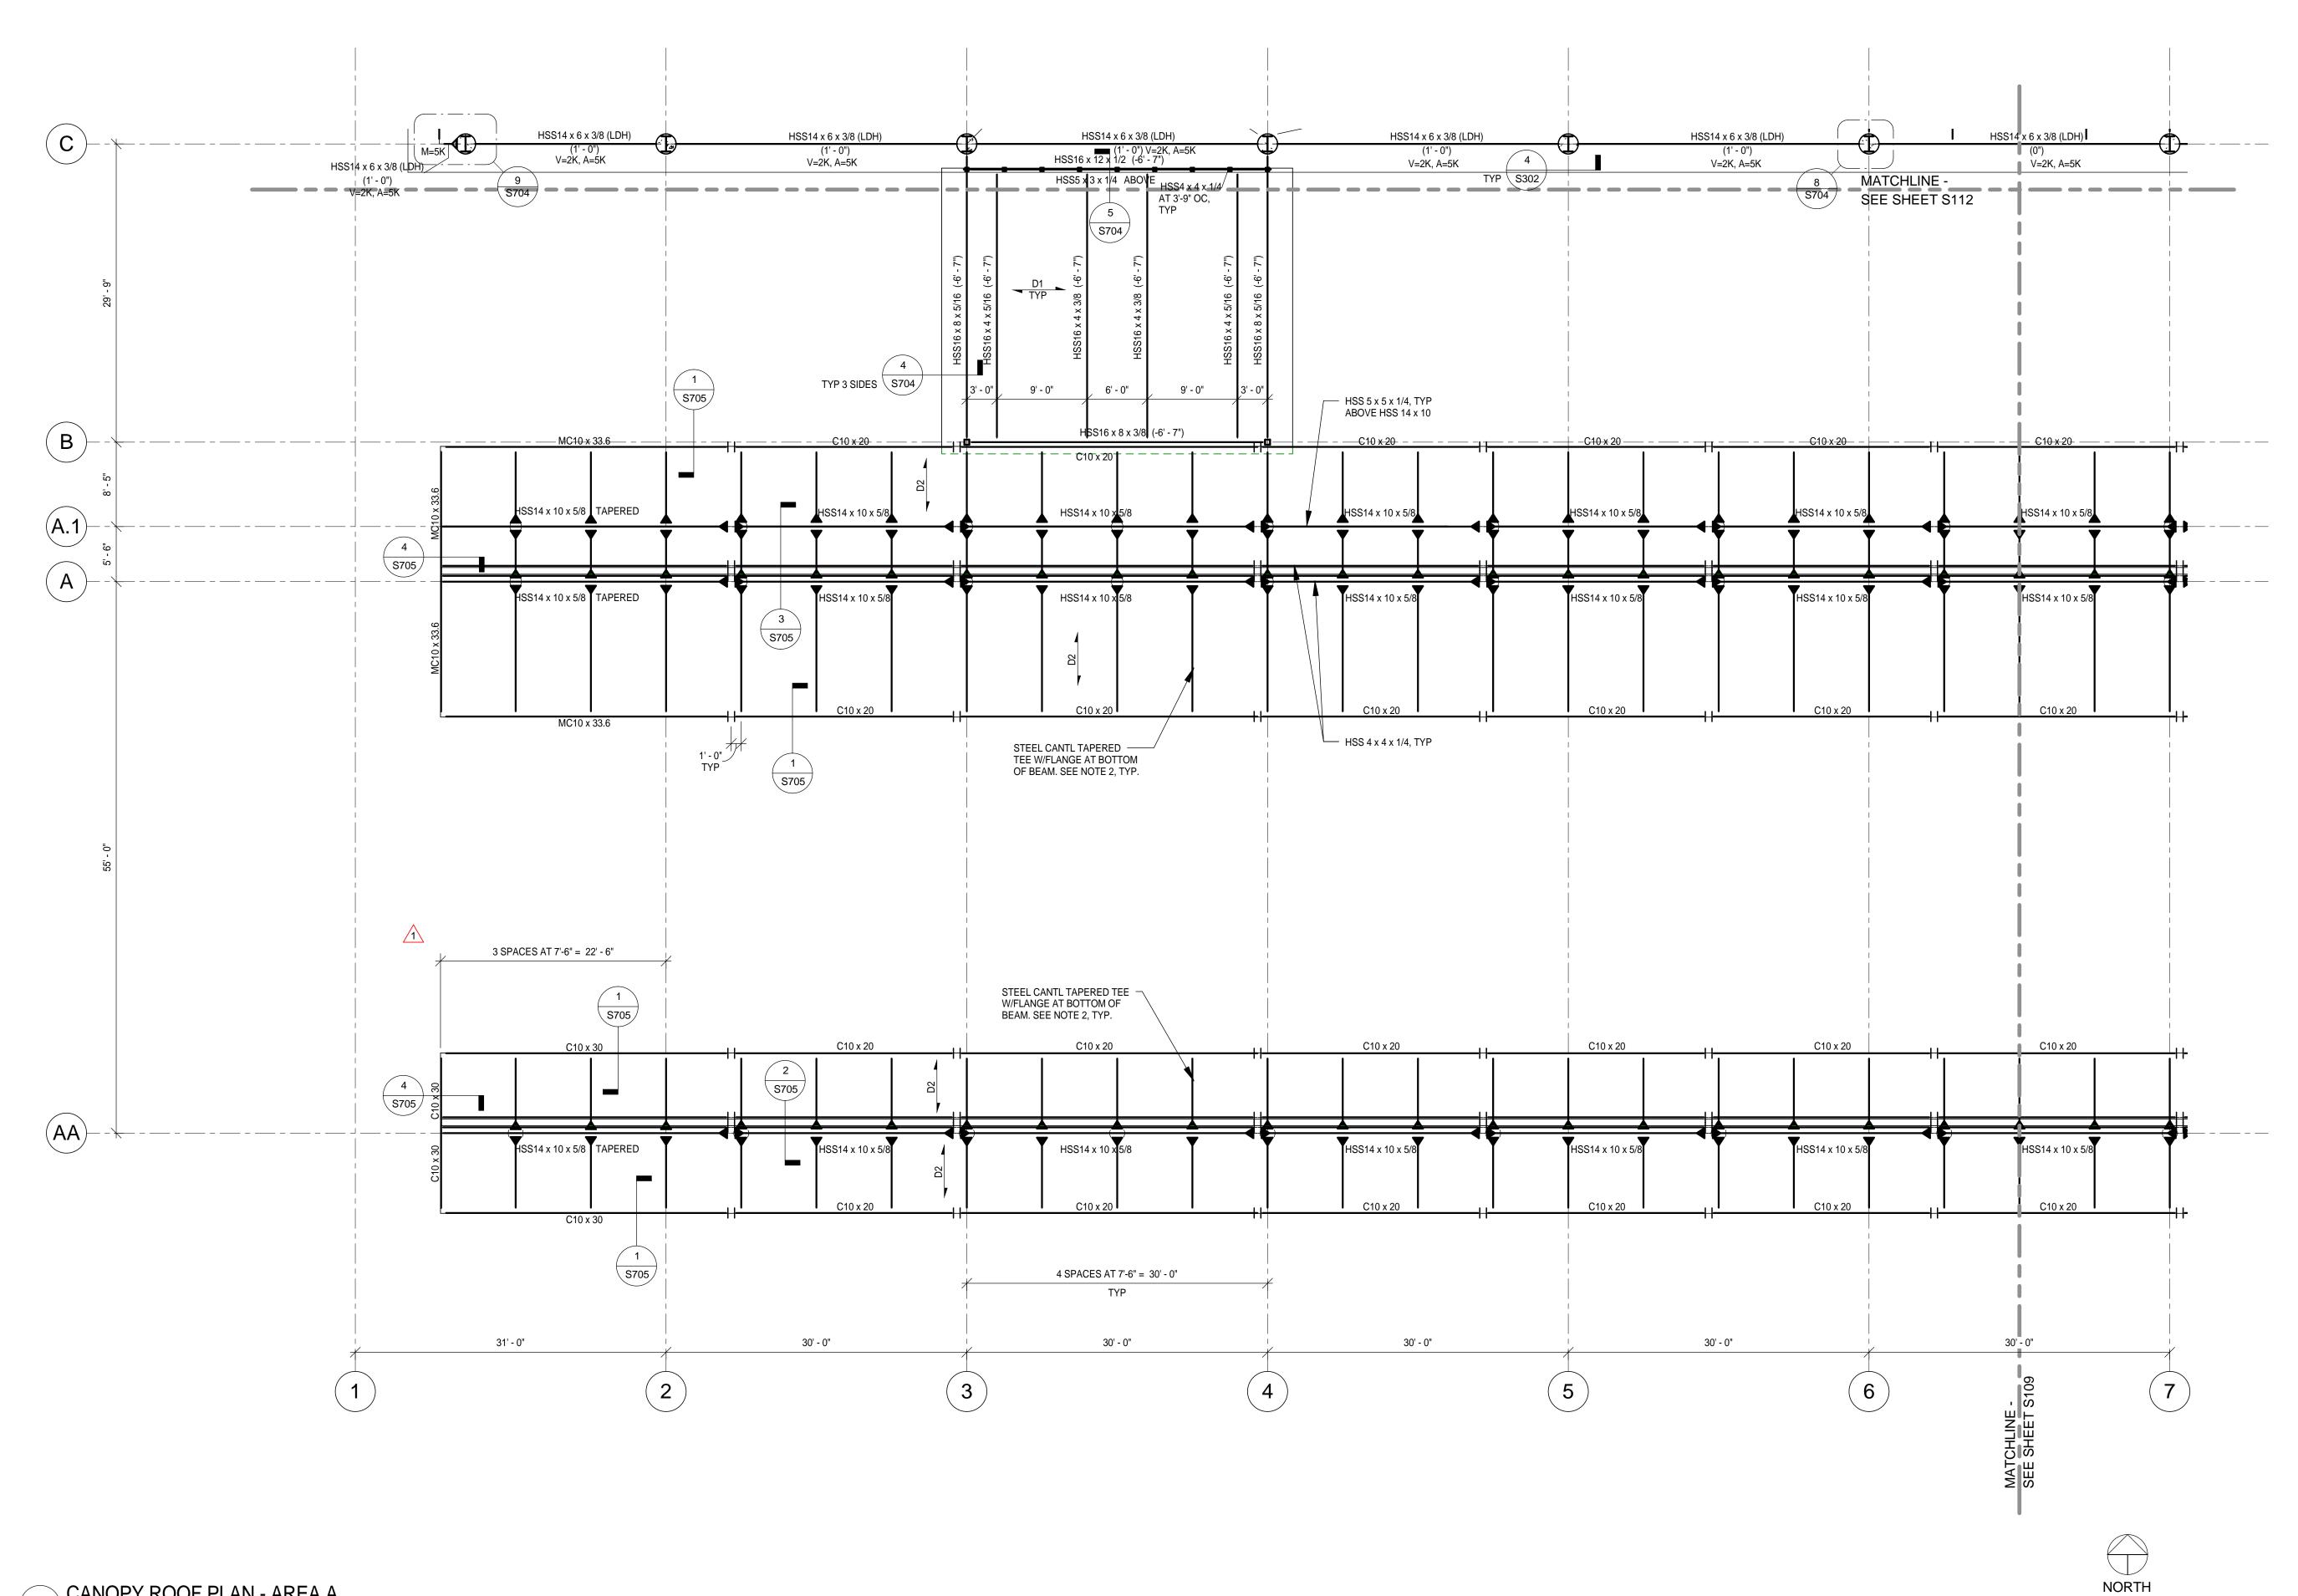

CANOPY ROOF PLAN - AREA A

1/8" = 1'-0"

NOTES:

1. REFER TO S115 FOR TYPICAL PLAN NOTES.
2. FABRICATOR TO PROVIDE SECTION (BUILT UP PLATE SECTION OR CUT WT OR CUT WIDE

FLANGE) WITH THE FOLLOWING DIMENSIONAL PROPERTIES:

d max = 14" d min = 6" bf = 12"tf = 1 3/8" tw = 3/4"

Fy = 50 ksi



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Landscape Consultants: **APPOLD DESIGN** 2432 East First Street, Duluth MN 55812 TEL: (218) 591-5079

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Signature:

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**REVISIONS** DESCRIPTION

	NO.	DESCRIPTION	DATE
		BID PACKAGE 1	5.12.10
		FOUNDATION PERMIT	6.4.10
	1	ADDENDUM 1	6.11.10
	2,3	NOT CHANGED	
		CONFORMANCE SET	7.12.10
		BUILDING PERMIT	8.6.10
	5	100% REVIEW	12.15.
		BID PACKAGE 2A	01.24.
		BP 2A CONFORMANCE	05.02.

**DATE ISSUED:** 08-23-11 **REVIEWED BY:** PAJ / CWB

DRAWN BY: SJL DESIGNED BY: CWB


AEP PROJECT NUMBER 213-1882-091

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SHEET TITLE

**CANOPY ROOF** FRAMING PLAN -**AREA A** 

> SHEET NUMBER **S108**

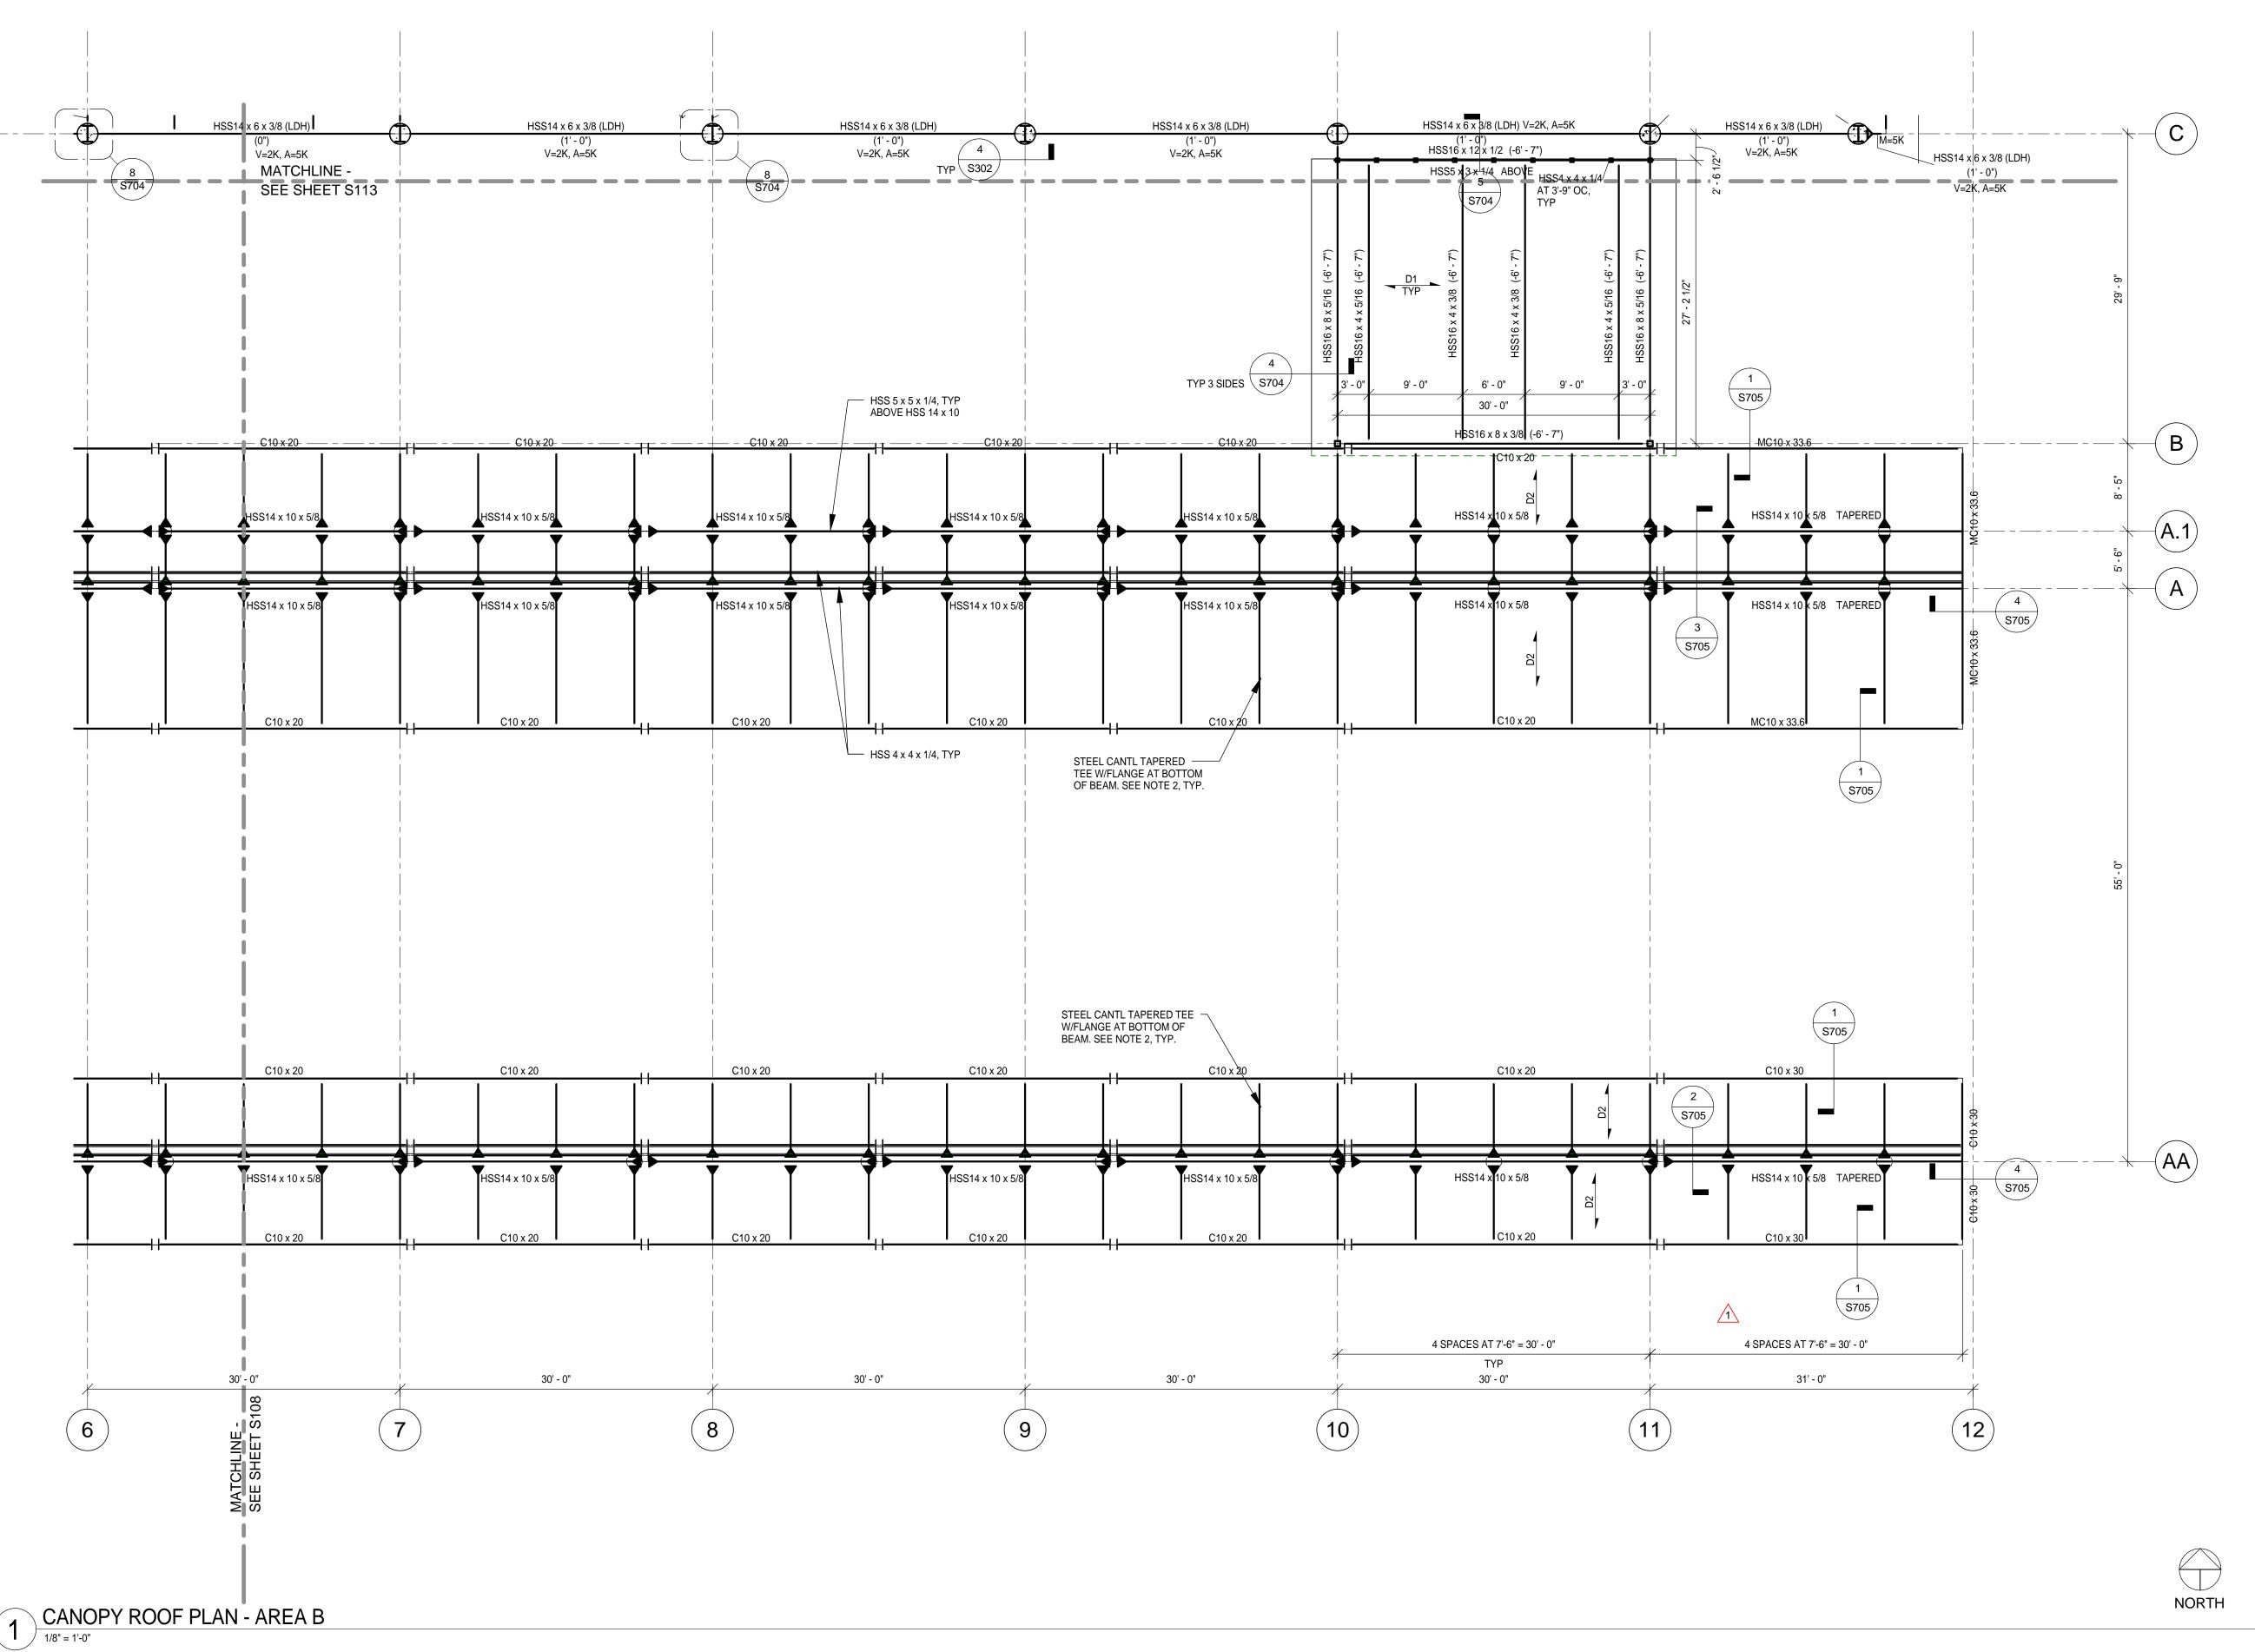

NOTES:

1. REFER TO S115 FOR TYPICAL PLAN NOTES.

2. FABRICATOR TO PROVIDE SECTION (BUILT UP PLATE SECTION OR CUT WT OR CUT WIDE FLANGE) WITH THE FOLLOWING DIMENSIONAL PROPERTIES:

d max = 14"
d min = 6"
bf = 12"
tf = 1 3/8"
tw = 3/4"

Fy = 50 ksi

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2,3	NOT CHANGED	
	CONFORMANCE SET	7.12.10
	BUILDING PERMIT	8.6.10
5	100% REVIEW	12.15.10
	BID PACKAGE 2A	01.24.11

05.02.11

DATE ISSUED:	08-23-11
REVIEWED BY:	PAJ / CWB
DRAWN BY:	SJL
DESIGNED BY:	CWB

BP 2A CONFORMANCE


AEP PROJECT NUMBER 213-1882-091

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SHEET TITLE

CANOPY ROOF FRAMING PLAN -AREA B

SHEET NUMBER S109

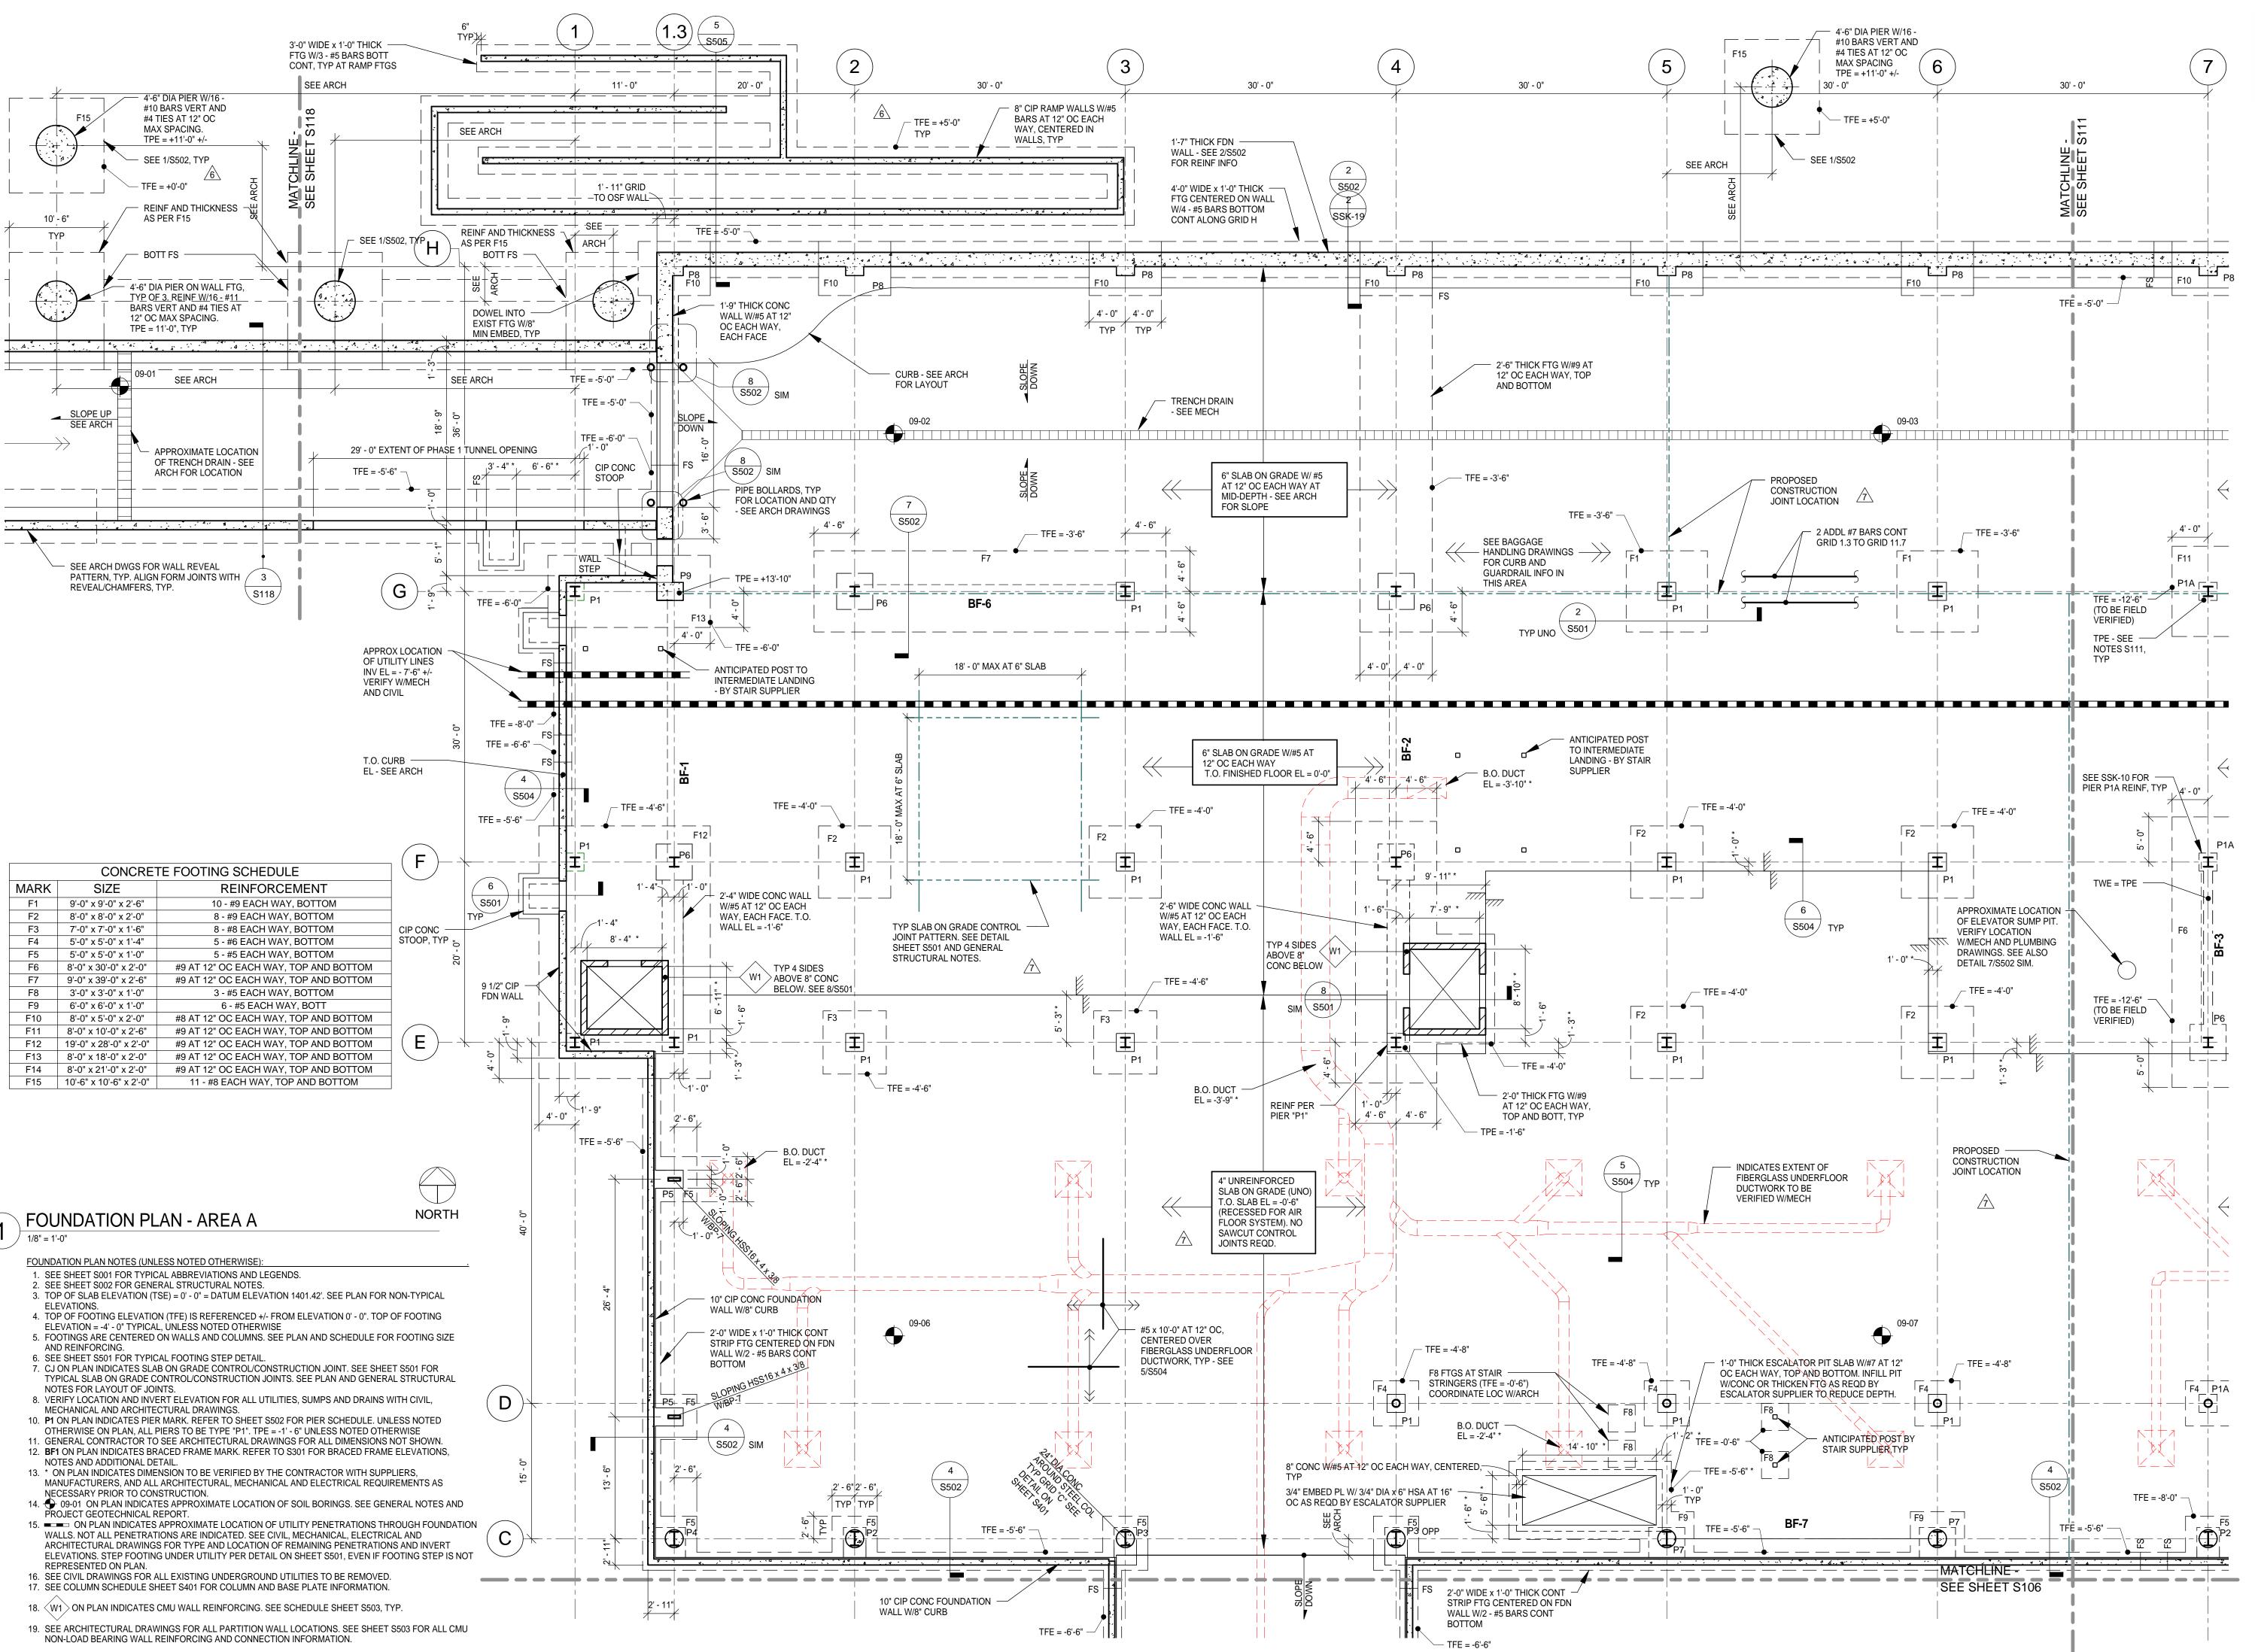

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NO.	DESCRIPTION	DATE
	BID PACKAGE 1	5.12.10
	FOUNDATION PERMIT	6.4.10
1,2,3	NOT CHANGED	
	CONFORMANCE SET	7.12.10
	BUILDING PERMIT	8.6.10
5	100% REVIEW	12.15.10
	BID PACKAGE 2A	01.24.11
6	BP2A ADDENDUM 2	02.25.11
7	RFP 90	04.06.11

DATE ISSUED: 08-23-11

REVIEWED BY: PAJ / CWB

DRAWN BY: SJL

DESIGNED BY: CWB

AEP PROJECT NUMBER


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BP 2A CONFORMANCE

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FOUNDATION PLAN - AREA A

SHEET NUMBER S110



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Paul A. Johnson Print Name:

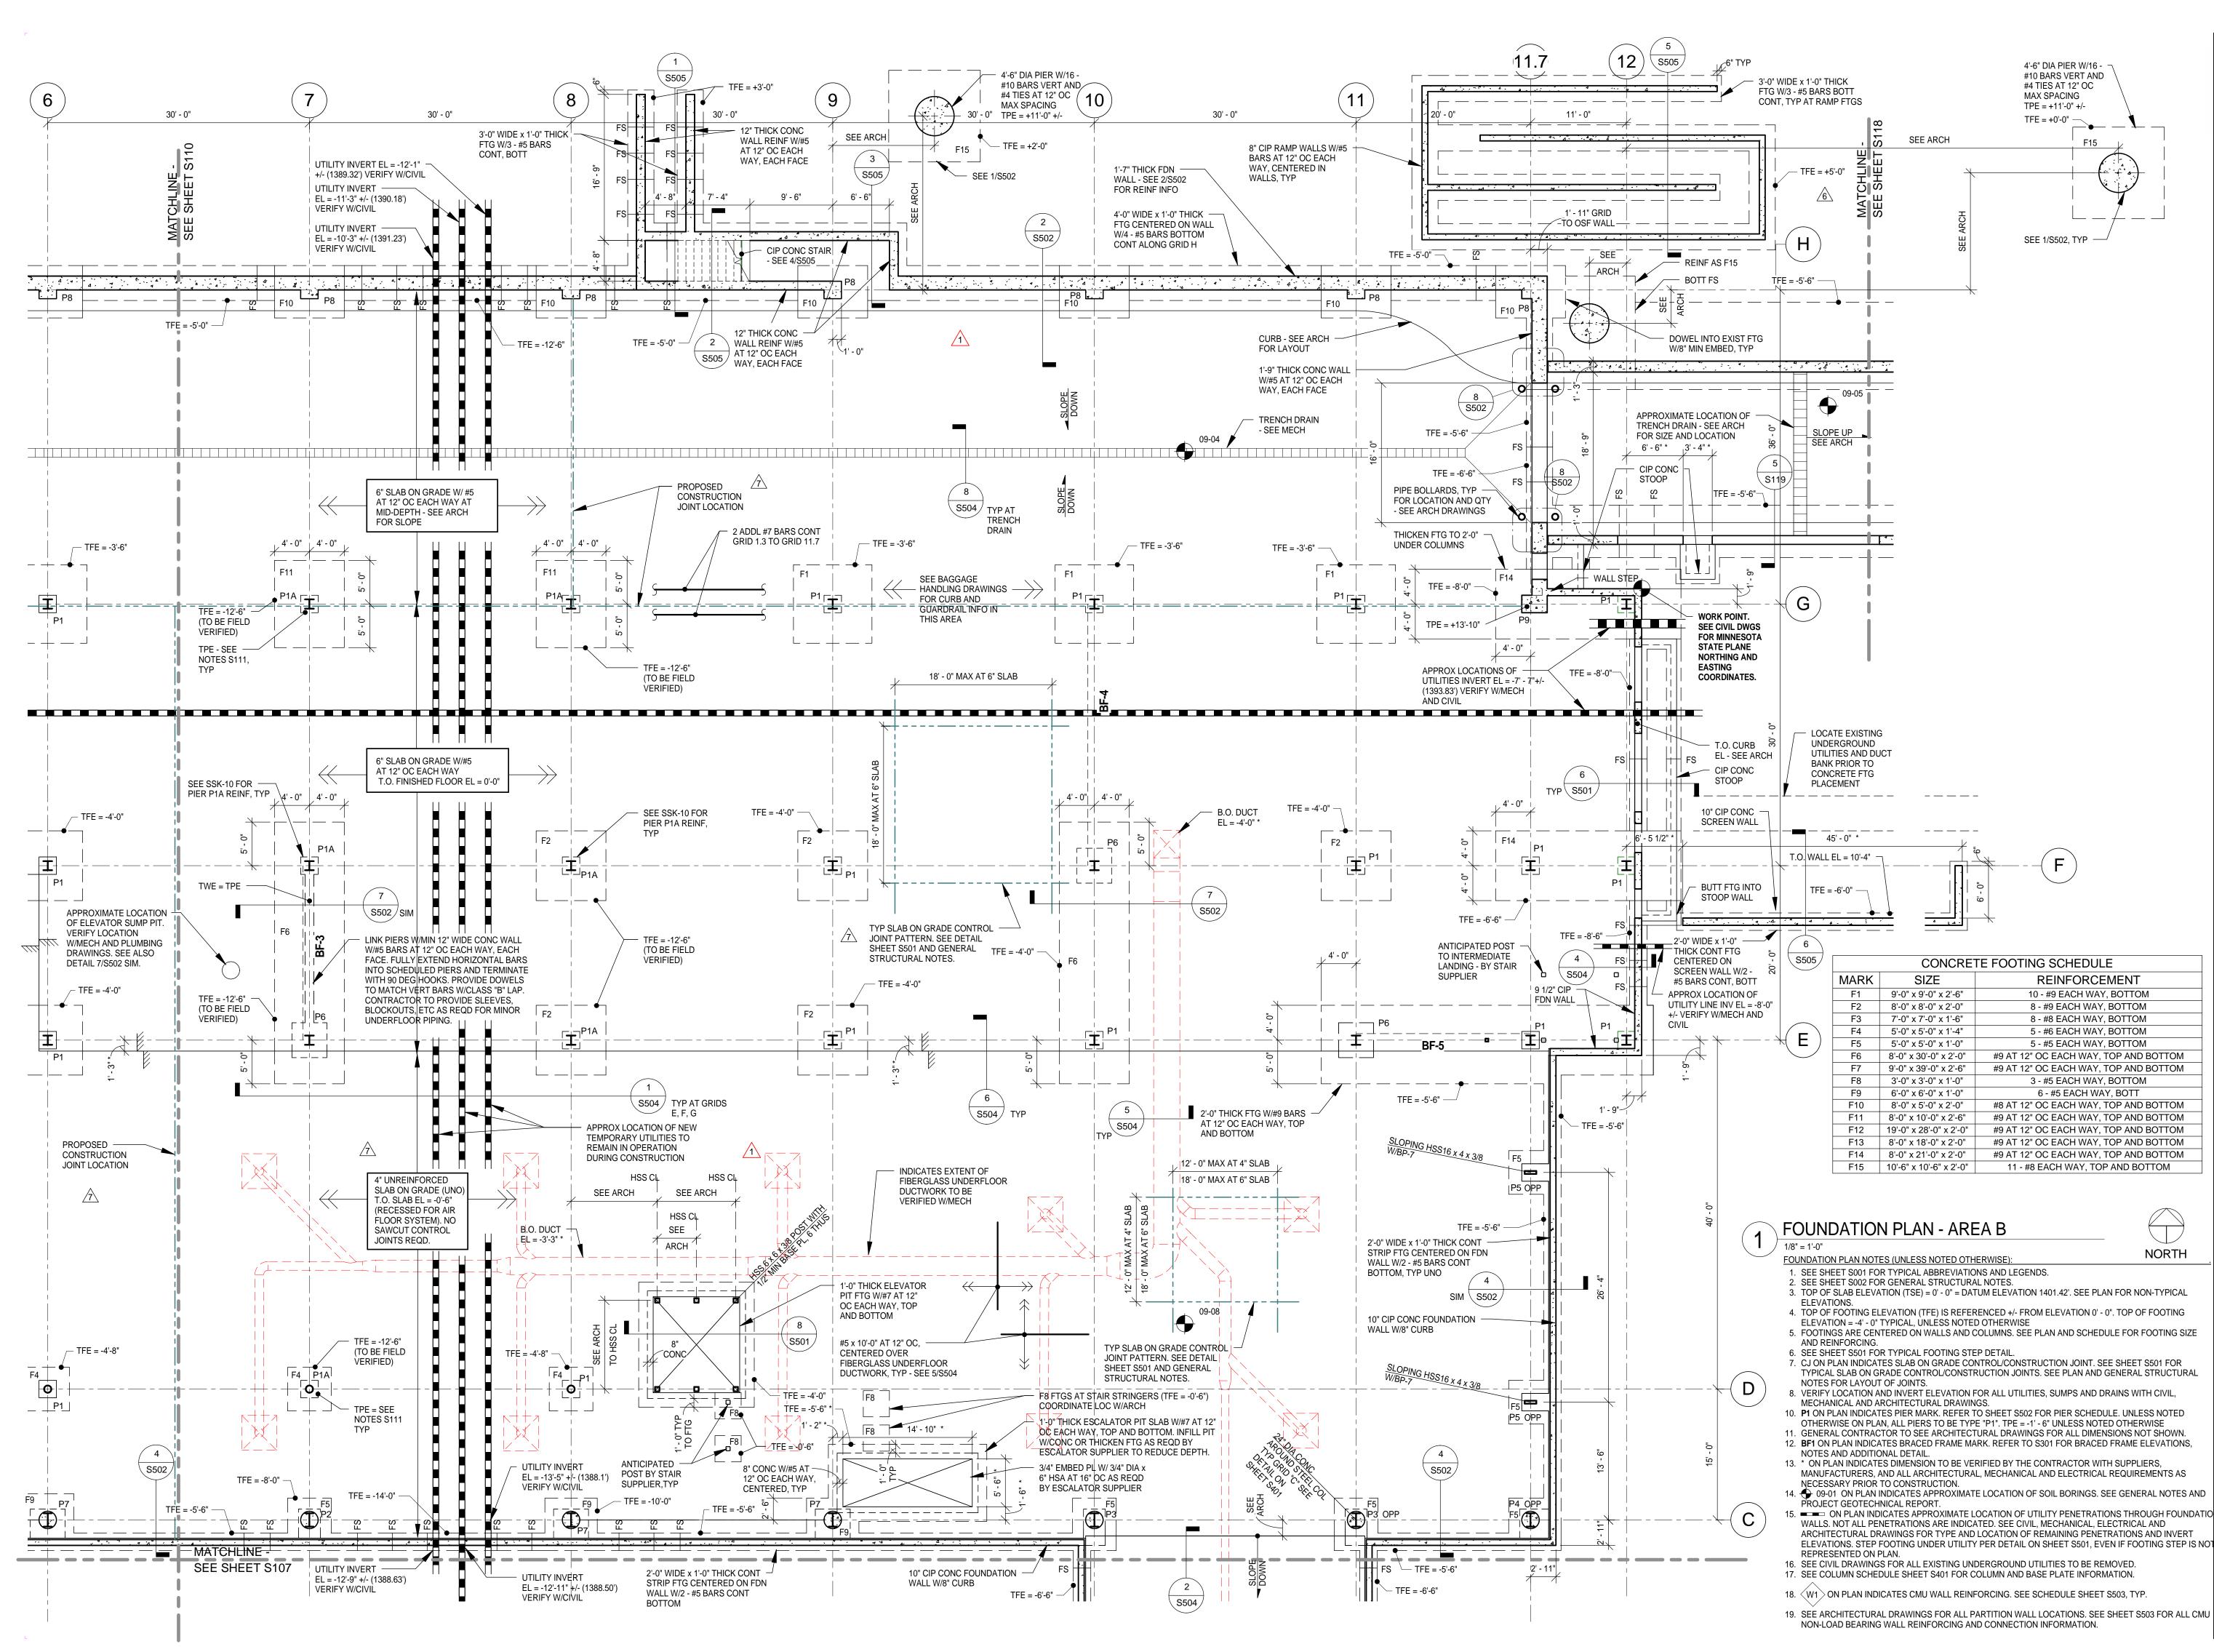Date: June 3, 2010 Reg. No.: 20379

## **REVISIONS**

Signature:

10.	DESCRIPTION	DATE
	BID PACKAGE 1	5.12.10
	FOUNDATION PERMIT	6.4.10
	ADDENDUM 1	6.11.10
,3	NOT CHANGED	
	CONFORMANCE SET	7.12.10
	BUILDING PERMIT	8.6.10
	100% REVIEW	12.15.10
	BID PACKAGE 2A	01.24.11
	BP2A ADDENDUM 2	02.25.11
	RFP 90	04.06.11

BP 2A CONFORMANCE 05.02.11 **DATE ISSUED:** 08-23-11

**REVIEWED BY:** PAJ / CWB

DRAWN BY: SJL **DESIGNED BY:** CWB

AEP PROJECT NUMBER

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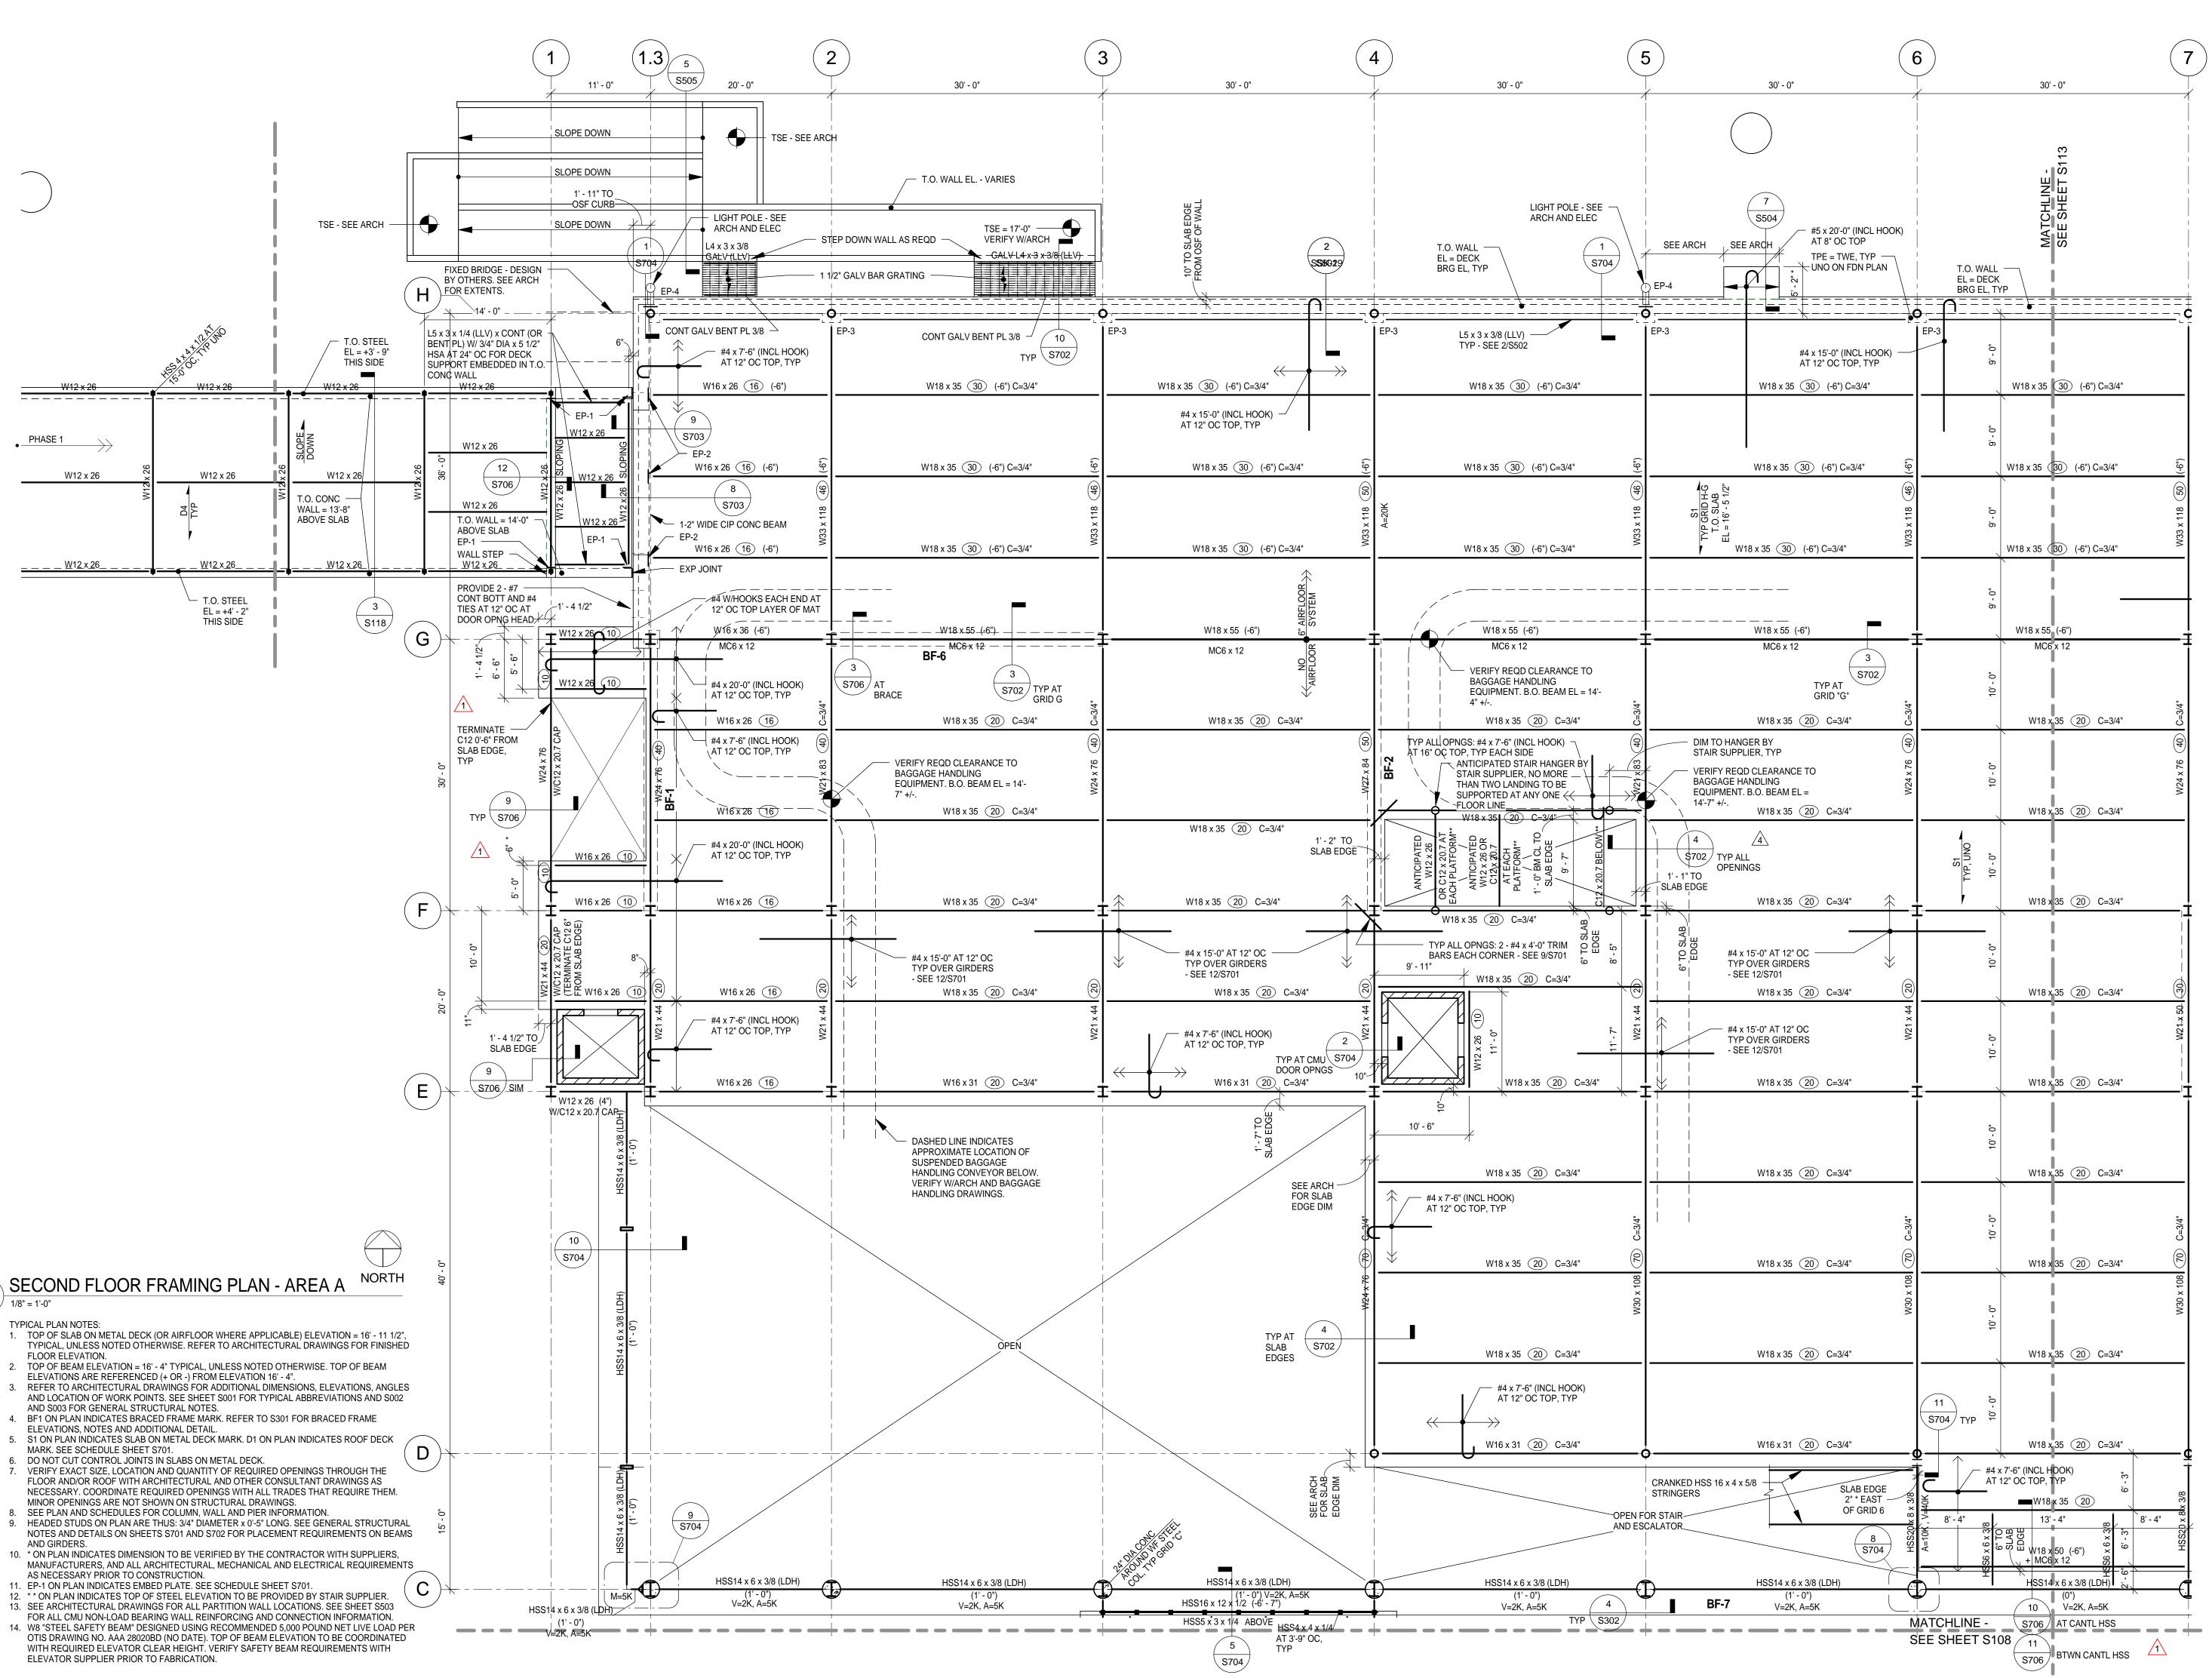
SHEET TITLE **FOUNDATION** 

**PLAN - AREA B** 

**SHEET NUMBER S111** 

**BID PACKAGE 2B ISSUED FOR BID** 

FOR REFERENCE ONLY





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Signature:

Date: June 3, 2010 Reg. No.: 20379

## **REVISIONS**

NO.	DESCRIPTION	DATE
	BID PACKAGE 1	5.12.10
	FOUNDATION PERMIT	6.4.10
1	ADDENDUM 1	6.11.10
2,3	NOT CHANGED	
	CONFORMANCE SET	7.12.10
	BUILDING PERMIT	8.6.10
4	BUILDING PERMIT REVISIONS	11.12.10
5	100% REVIEW	12.15.10
	BID PACKAGE 2A	01.24.11
	BP 2A CONFORMANCE	05.02.11
	4	BID PACKAGE 1 FOUNDATION PERMIT  ADDENDUM 1 2,3 NOT CHANGED CONFORMANCE SET BUILDING PERMIT  BUILDING PERMIT REVISIONS  100% REVIEW BID PACKAGE 2A


**DATE ISSUED:** 08-23-11 **REVIEWED BY:** PAJ / CWB DRAWN BY: SJL **DESIGNED BY:** CWB AEP PROJECT NUMBER

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## SHEET TITLE

**SECOND LEVEL** FRAMING PLAN -**AREA A** 

> SHEET NUMBER **S112**



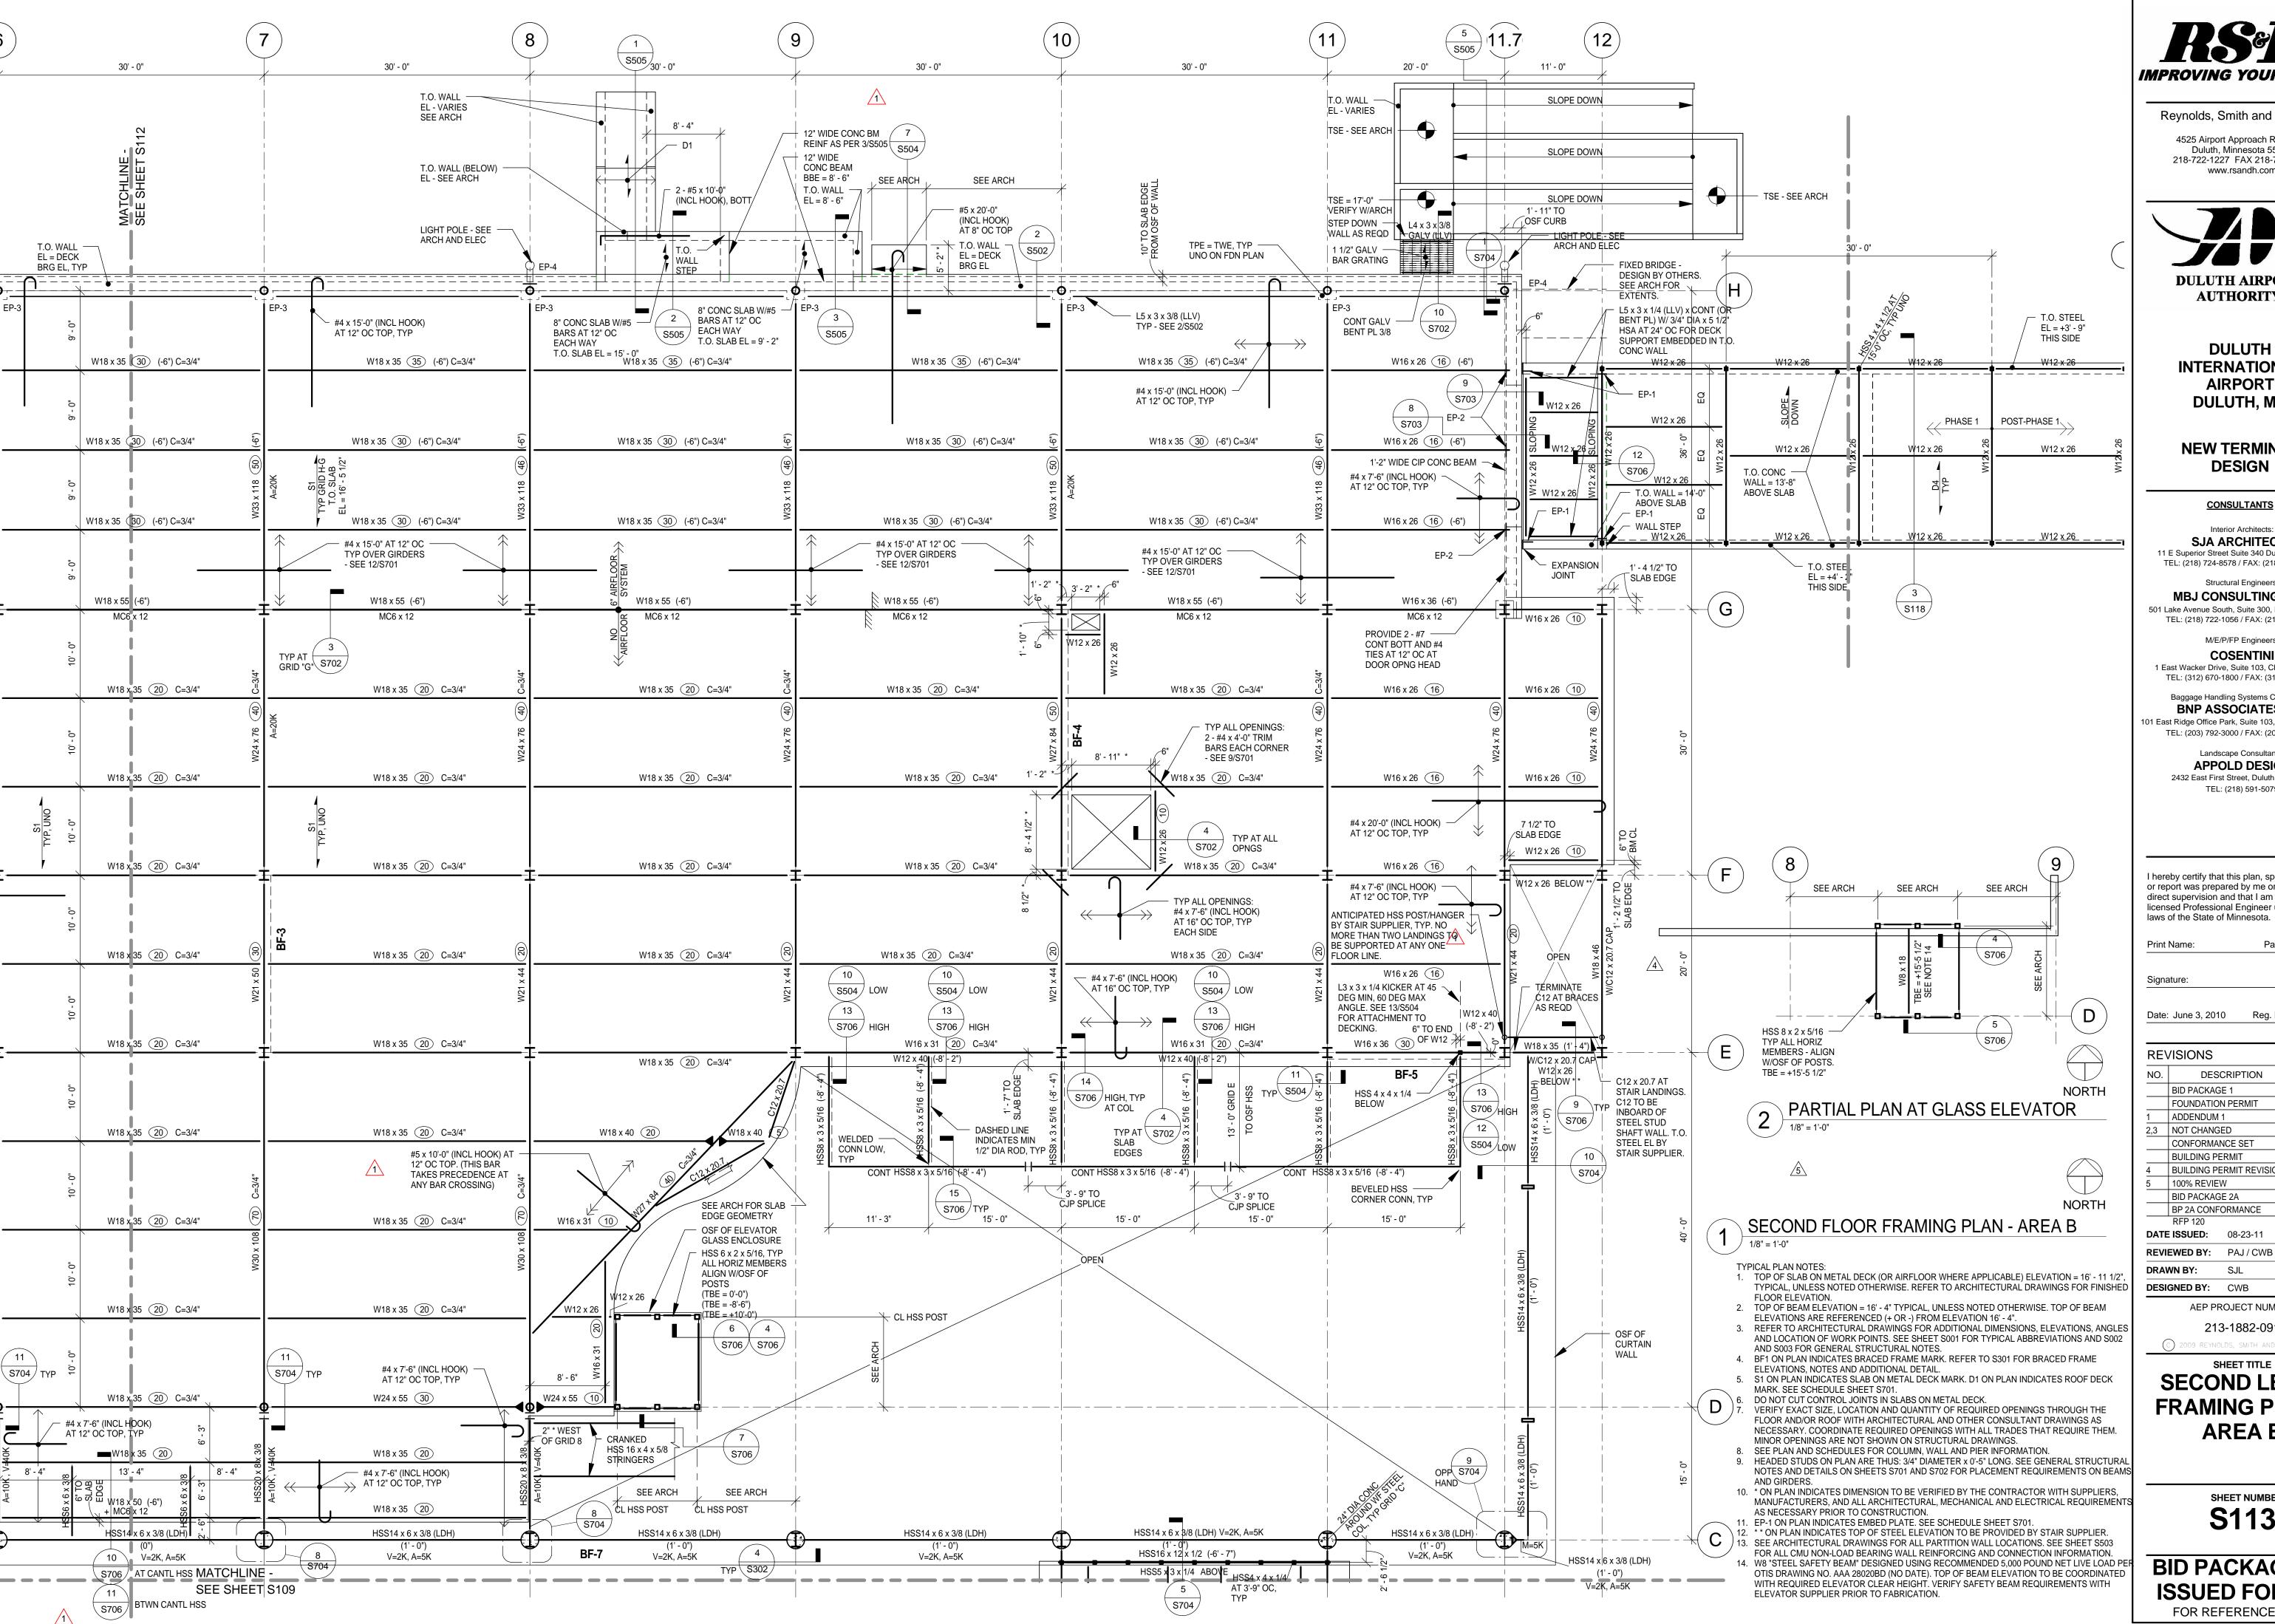

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Structural Engineers: MBJ CONSULTING ENG.

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BNP ASSOCIATES INC. 101 East Ridge Office Park, Suite 103, Danbury CT 06810 TEL: (203) 792-3000 / FAX: (203) 792-4900

> Landscape Consultants: **APPOLD DESIGN** 2432 East First Street, Duluth MN 55812 TEL: (218) 591-5079

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Print Name: Paul A. Johnson

Signature:

Date: June 3, 2010 Reg. No.: 20379

**REVISIONS** 

NO.	DESCRIPTION	DATE
	BID PACKAGE 1	5.12.10
	FOUNDATION PERMIT	6.4.10
1	ADDENDUM 1	6.11.10
2,3	NOT CHANGED	
	CONFORMANCE SET	7.12.10
	BUILDING PERMIT	8.6.10
4	BUILDING PERMIT REVISIONS	11.12.
5	100% REVIEW	12.15.
	BID PACKAGE 2A	01.24.
	BP 2A CONFORMANCE	05.02.

**DATE ISSUED:** 08-23-11 **REVIEWED BY:** PAJ / CWB

**DRAWN BY:** SJL **DESIGNED BY:** CWB AEP PROJECT NUMBER


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SHEET TITLE **SECOND LEVEL** 

FRAMING PLAN -**AREA B** 

> SHEET NUMBER **S113**



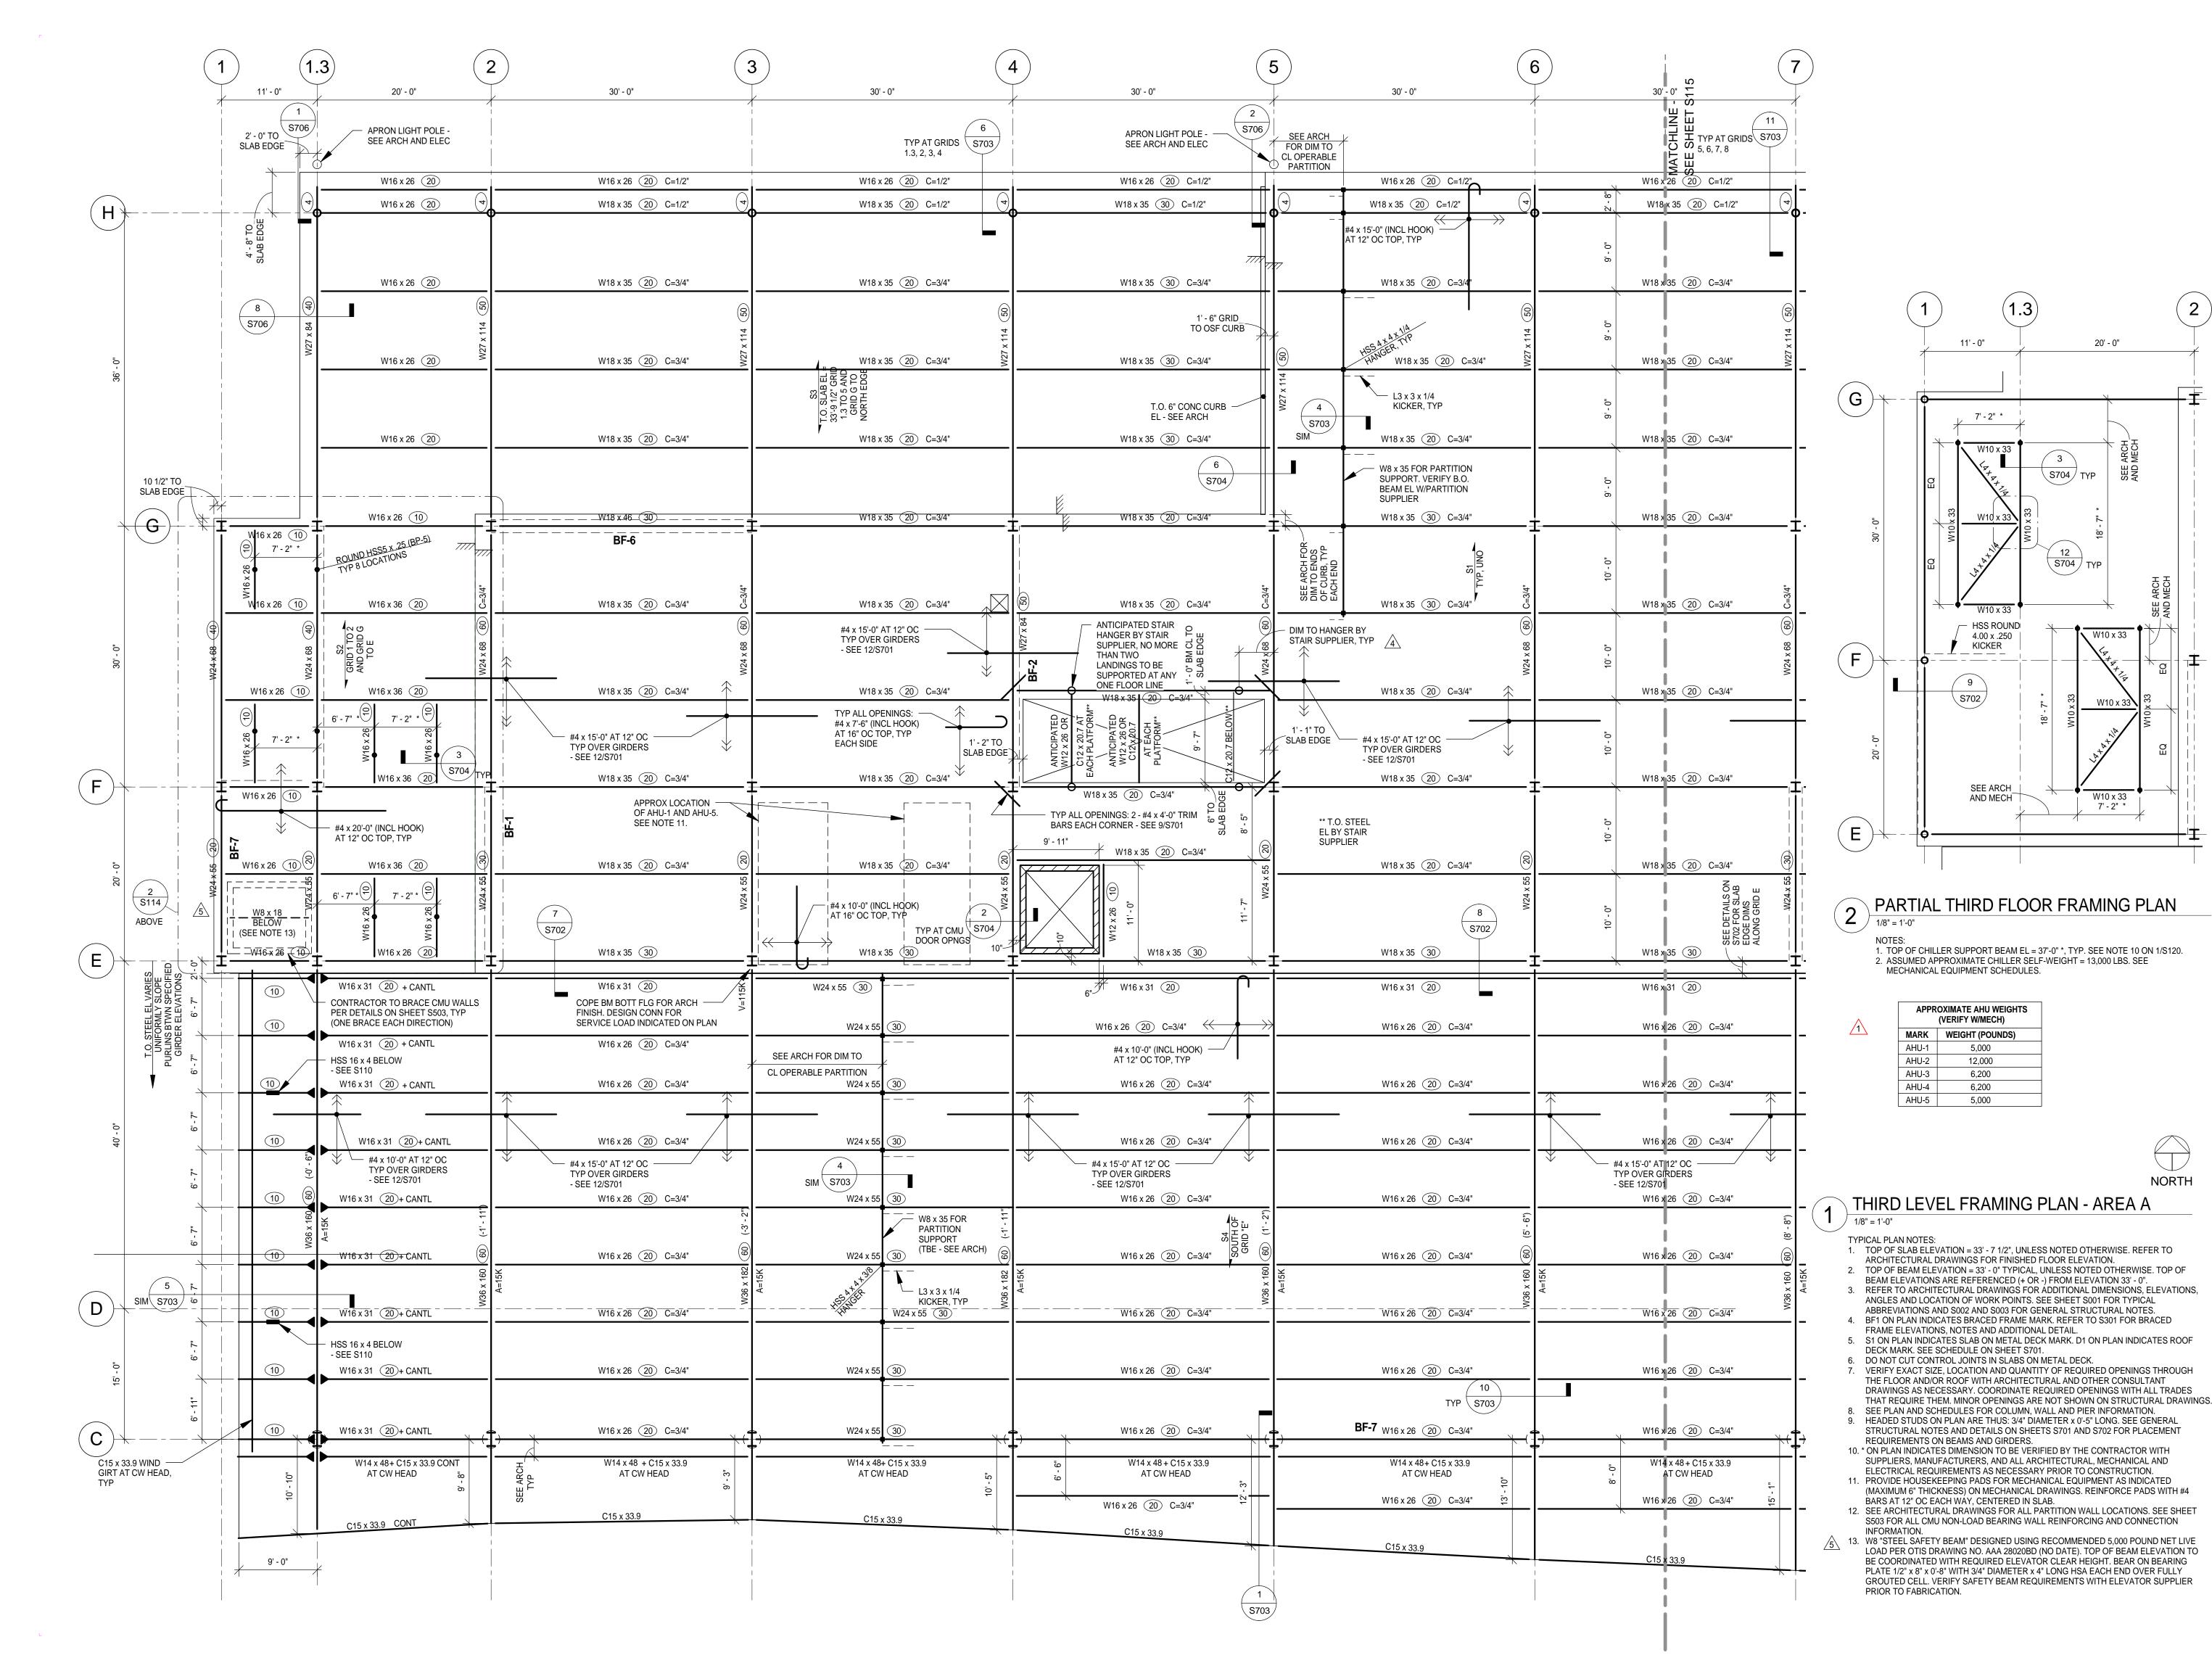

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2

(1.3)

20' - 0"

\ S704 / TYP

S704 TYP

W10 x 33

W10 x 33

W10 x 33

7' - 2" \*

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**CONSULTANTS** 

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Signature:

**REVISIONS** 

Print Name: Paul A. Johnson

Date: June 3, 2010 Reg. No.: 20379

IO.	DESCRIPTION	DATE
	BID PACKAGE 1	5.12.10
	FOUNDATION PERMIT	6.4.10
	ADDENDUM 1	6.11.10
3	NOT CHANGED	

7.12.10 CONFORMANCE SET **BUILDING PERMIT** 8.6.10 BUILDING PERMIT REVISIONS 11.12.10 100% REVIEW 12.15.10 01.24.11 BID PACKAGE 2A BP 2A CONFORMANCE 05.02.11

**DATE ISSUED:** 08-23-11 **REVIEWED BY:** PAJ / CWB DRAWN BY: SJL

**DESIGNED BY:** CWB AEP PROJECT NUMBER

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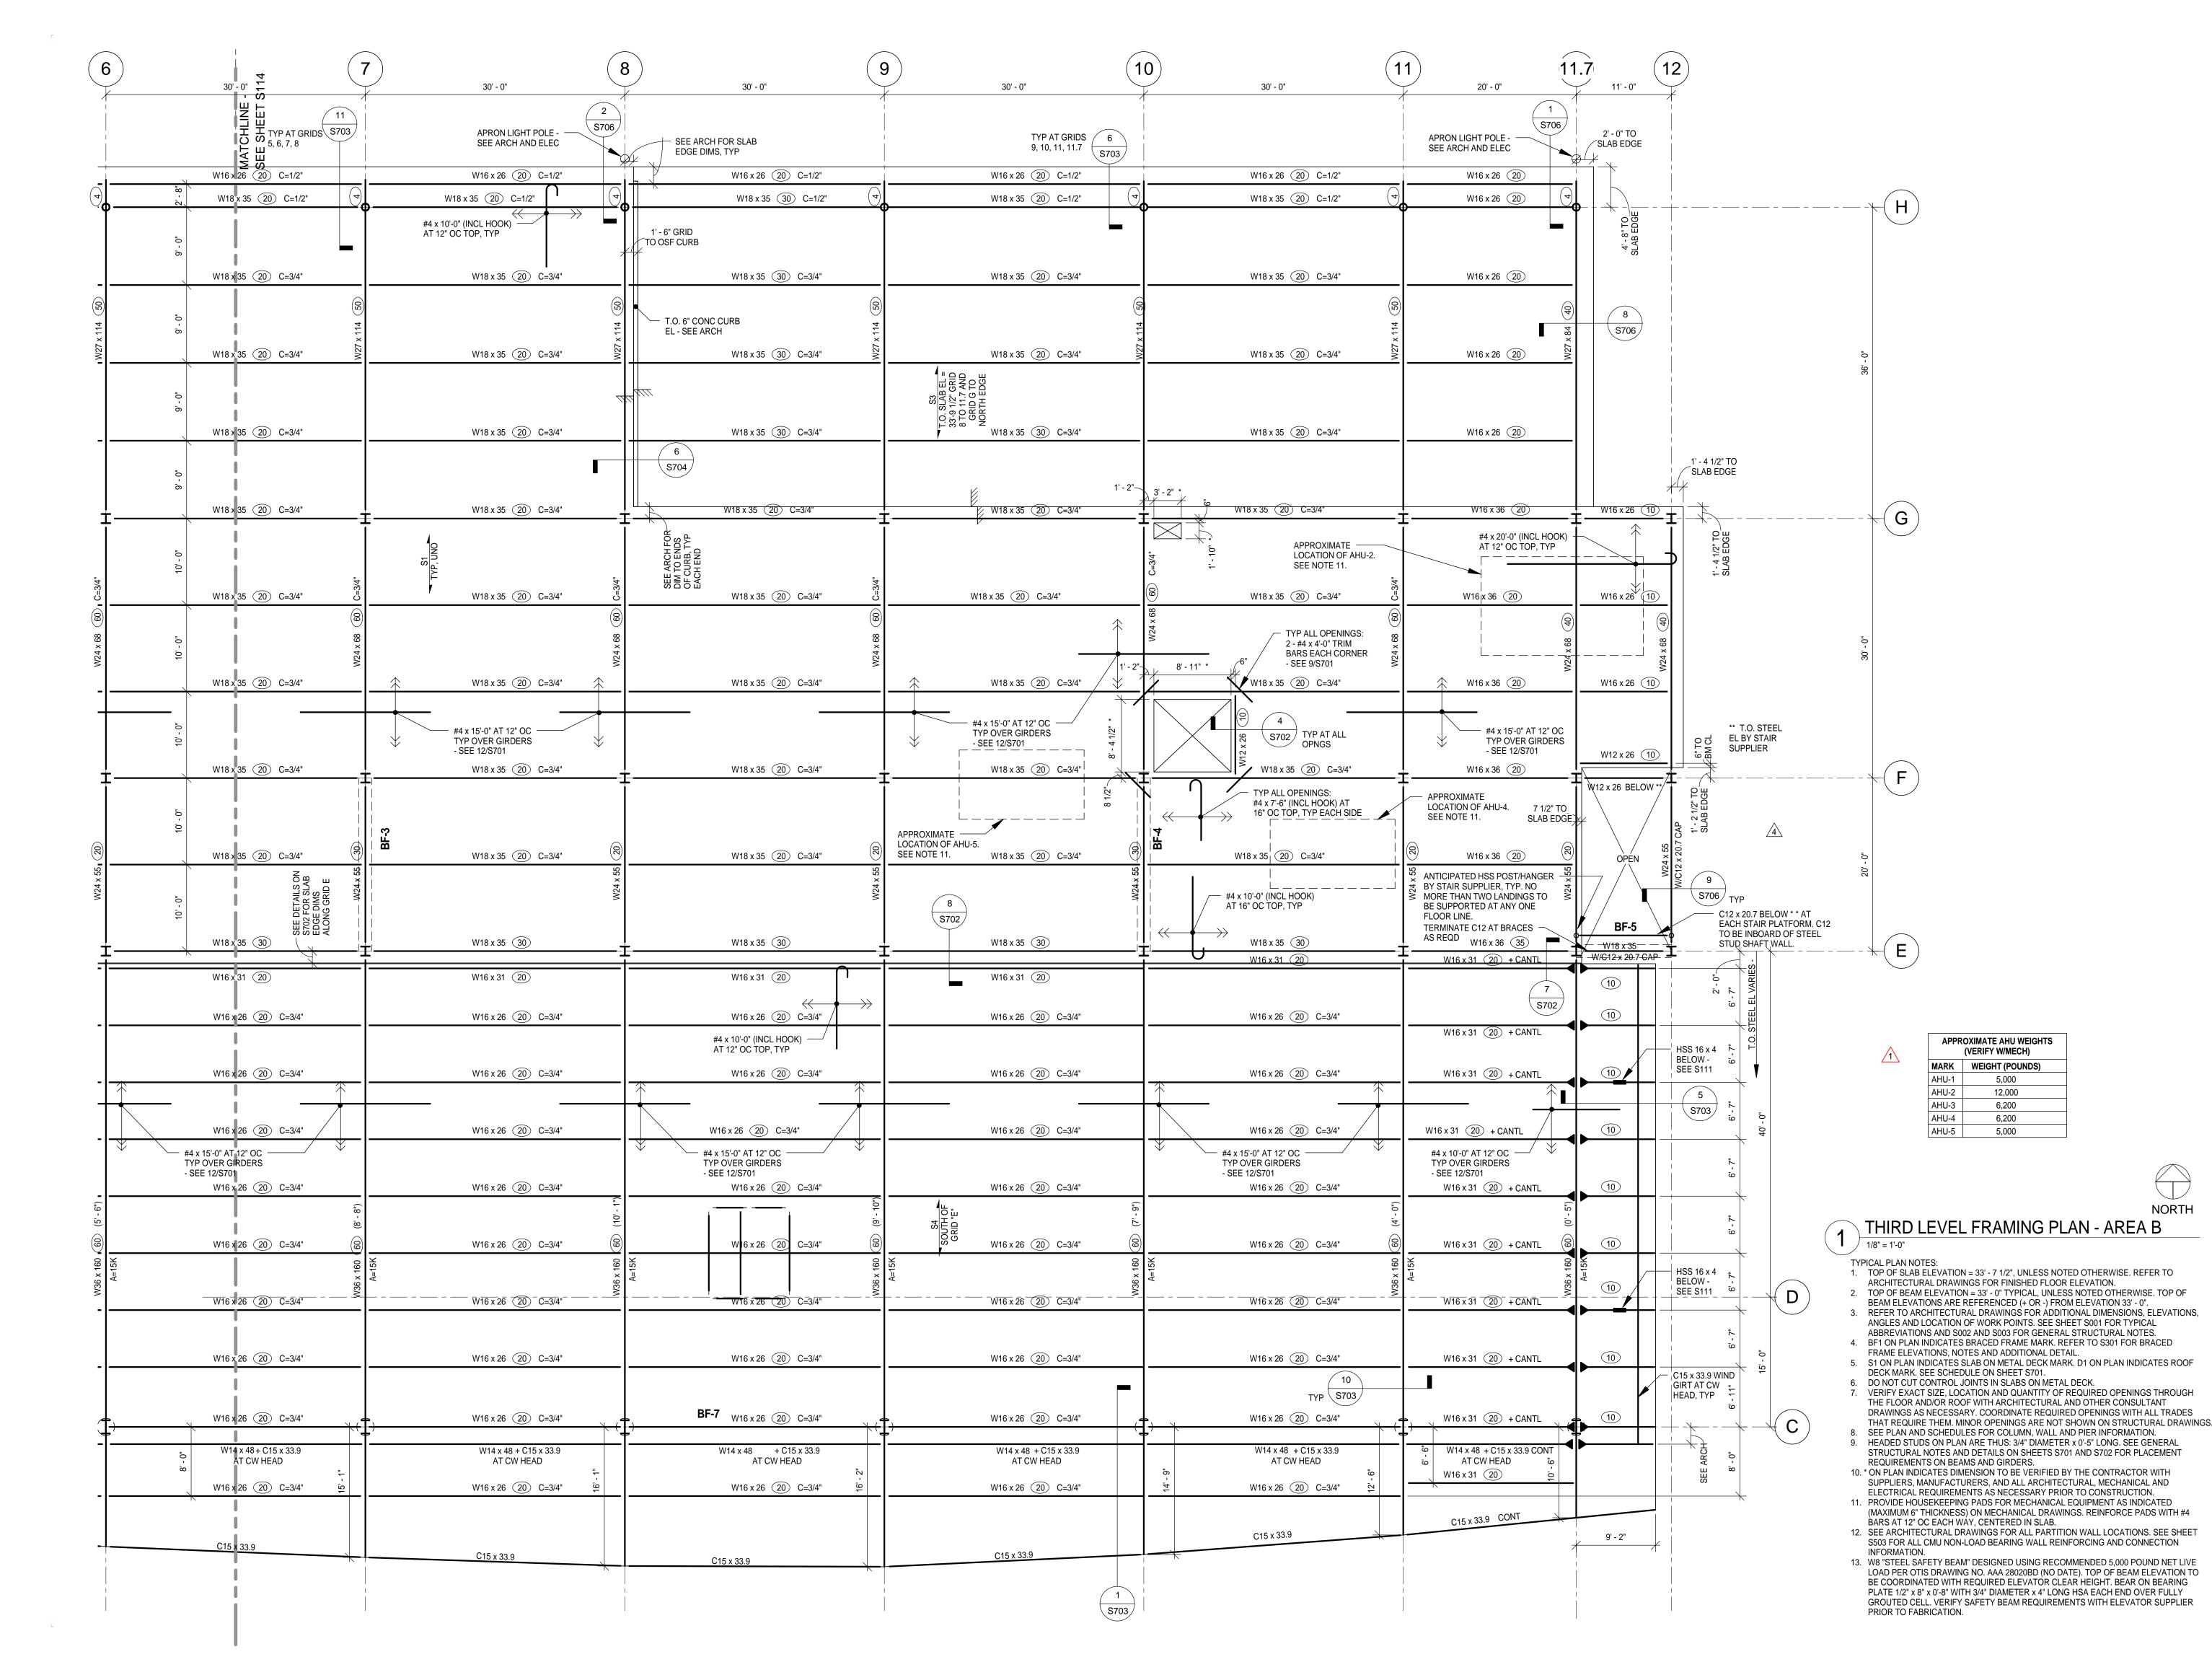
SHEET TITLE

## THIRD LEVEL FRAMING PLAN -**AREA A**

**SHEET NUMBER S114** 

**BID PACKAGE 2B ISSUED FOR BID** 

FOR REFERENCE ONLY





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DULUTH INTERNATIONAL AIRPORT DULUTH, MN

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## Landscape Consultants: APPOLD DESIGN 22 Foot First Street Dulyth MN 55

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Print Name: Paul A. Johnson

Signature:

Date: June 3, 2010 Reg. No.: 20379

## REVISIONS

DRAWN BY:

NO.	DESCRIPTION	DATE
	BID PACKAGE 1	5.12.10
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1	ADDENDUM 1	6.11.10
2,3	NOT CHANGED	
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5	100% REVIEW	12.15.10
	BID PACKAGE 2A	01.24.11

DATE ISSUED: 08-23-11
REVIEWED BY: PAJ / CWB

BP 2A CONFORMANCE

DESIGNED BY: CWB

AEP PROJECT NUMBER

SJL

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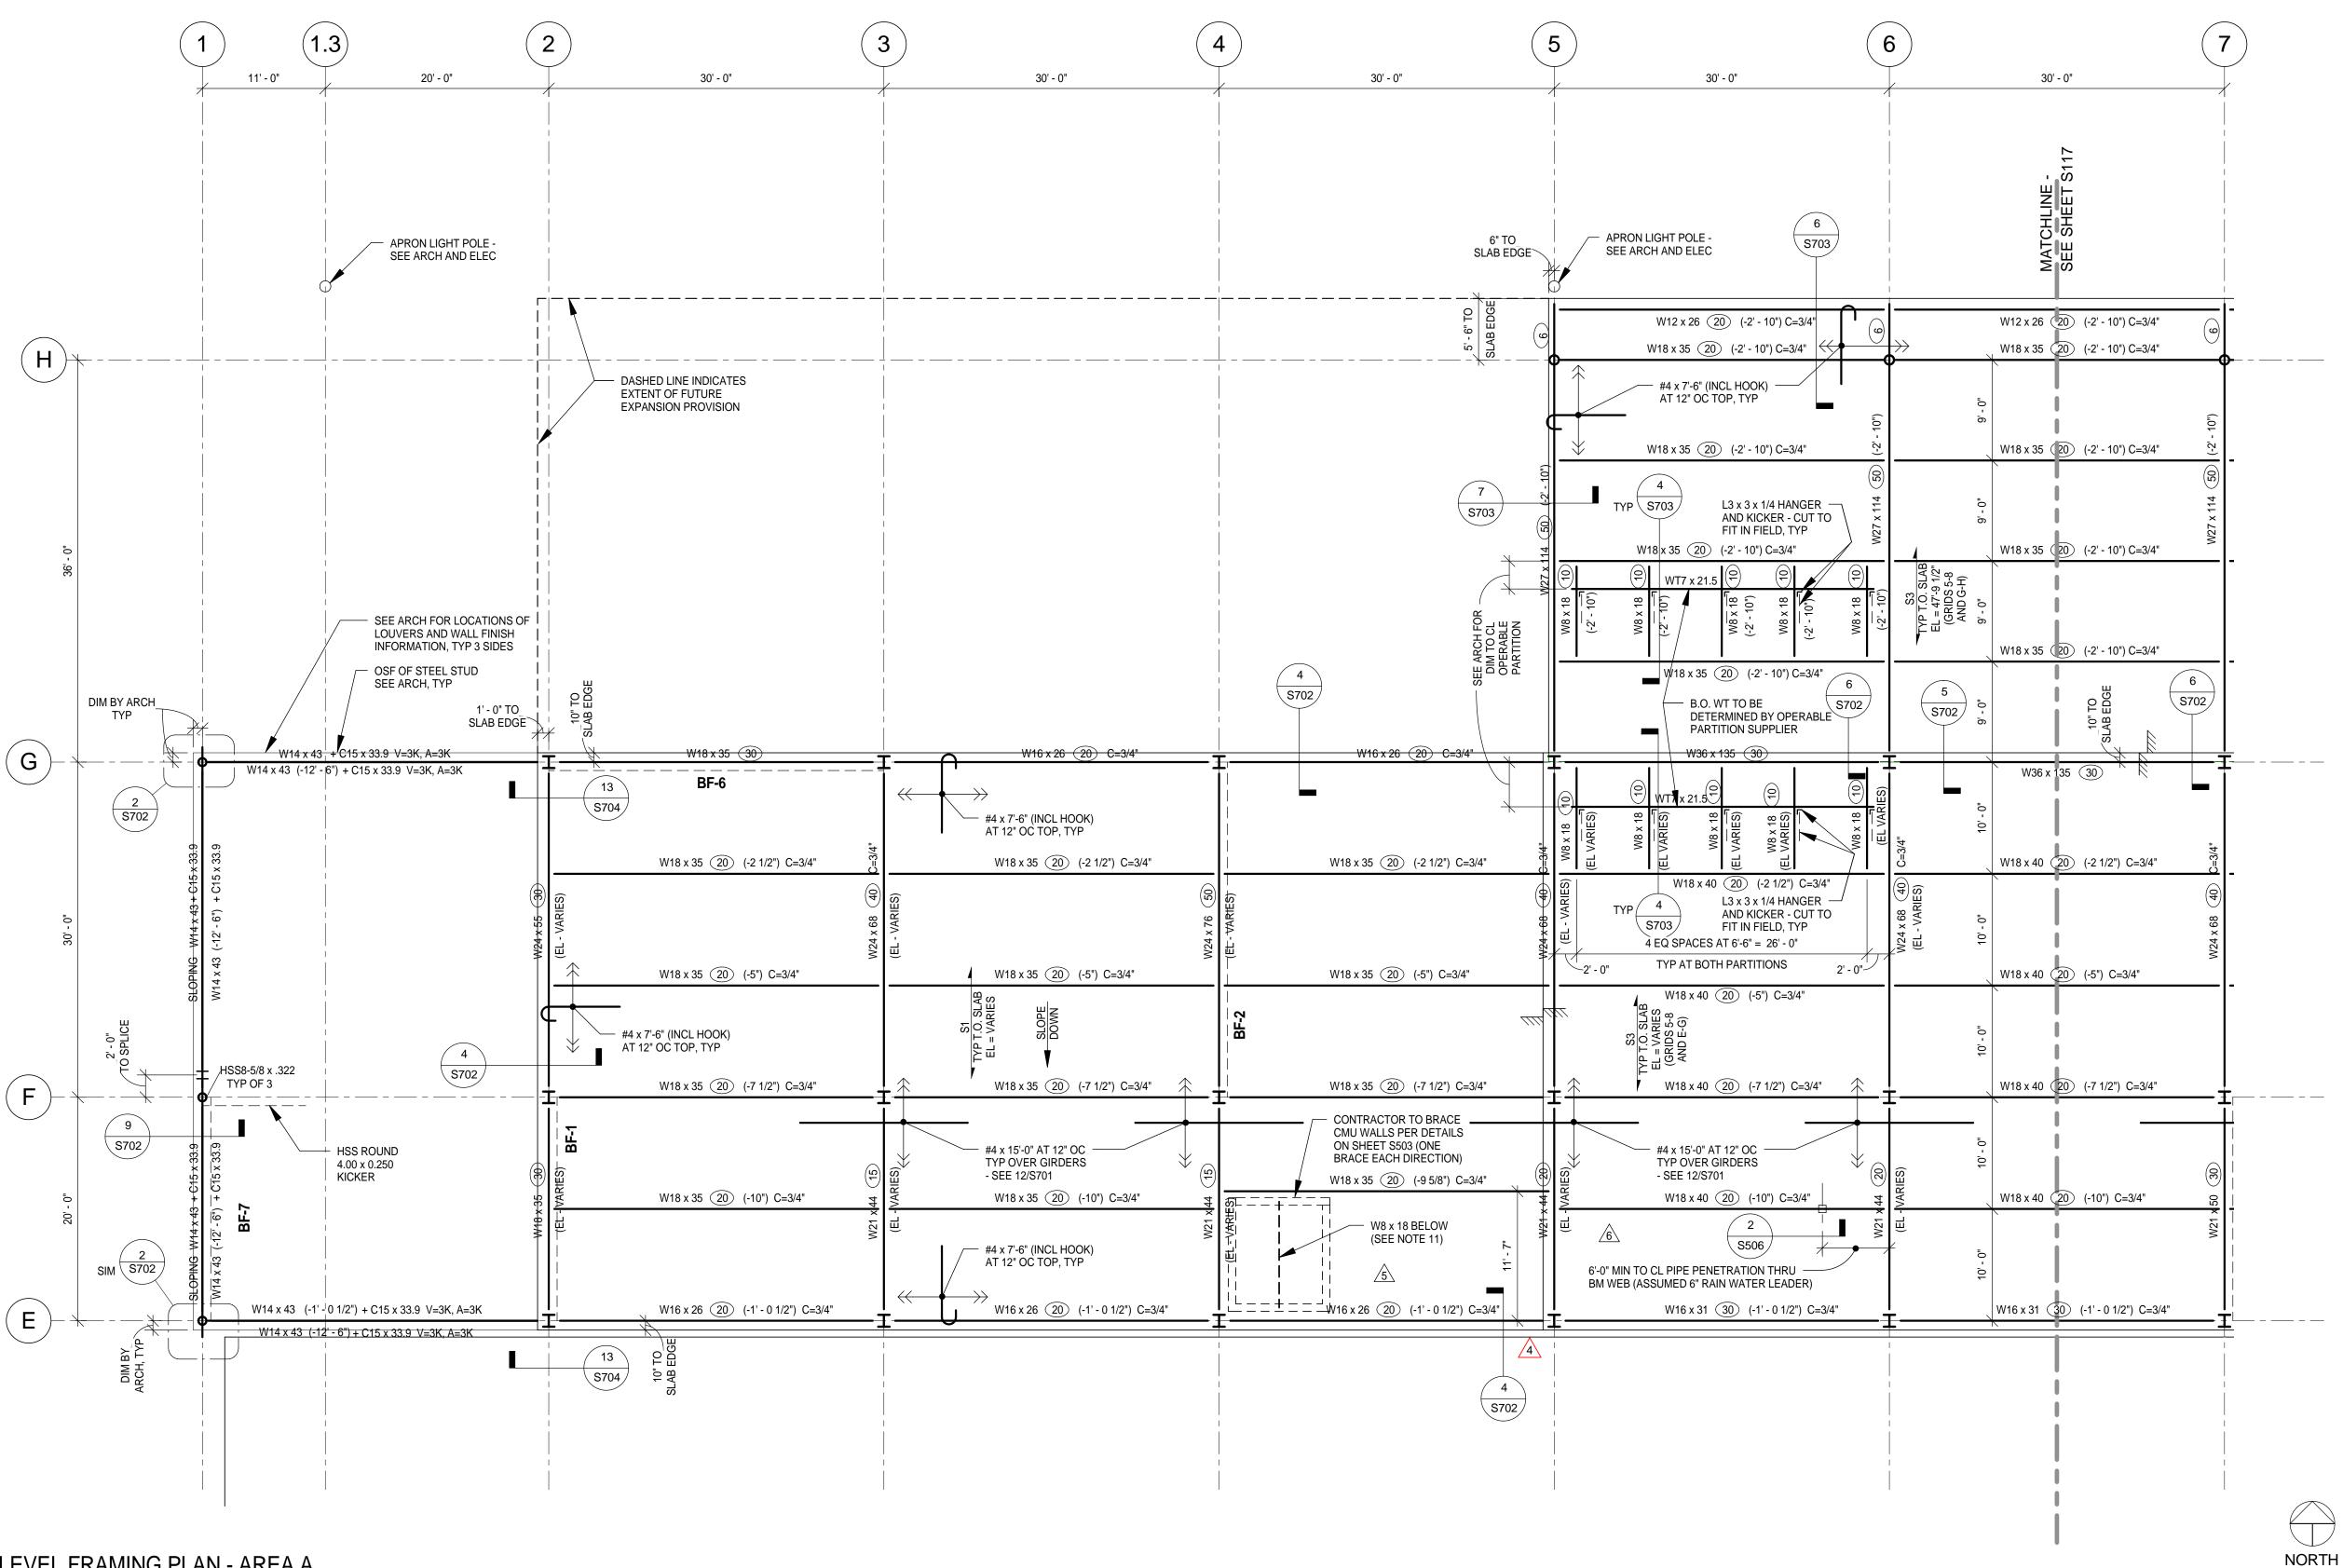
## SHEET TITLE THIRD LEVEL

# FRAMING PLAN AREA B

SHEET NUMBER

BID PACKAGE 2B ISSUED FOR BID

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ROOF LEVEL FRAMING PLAN - AREA A

TYPICAL PLAN NOTES:

1. TOP OF STEEL BEAM ELEVATION IS REFERENCED (+ OR -) FROM ELEVATION 49' - 6".

TOP OF STEEL BEAM = 49' - 6", UNLESS NOTED OTHERWISE.

TOP OF SLAB ELEVATION VARIES. SEE PLAN REFER TO ARCHITECTURAL DRAWINGS FOR ADDITIONAL DIMENSIONS, ELEVATIONS, ANGLES AND LOCATION OF WORK POINTS. SEE SHEET S001 FOR TYPICAL

ABBREVIATIONS AND S002 AND S003 FOR GENERAL STRUCTURAL NOTES. 4. BF1 ON PLAN INDICATES BRACED FRAME MARK. REFER TO \$301 FOR BRACED FRAME

ELEVATIONS, NOTES AND ADDITIONAL DETAIL. 5. S1 ON PLAN INDICATES SLAB ON METAL DECK MARK. D1 ON PLAN INDICATES ROOF

DECK MARK. SEE SCHEDULE ON SHEET S701.

DO NOT CUT CONTROL JOINTS IN SLABS ON METAL DECK. VERIFY EXACT SIZE, LOCATION AND QUANTITY OF REQUIRED OPENINGS THROUGH THE FLOOR AND/OR ROOF WITH ARCHITECTURAL AND OTHER CONSULTANT DRAWINGS AS NECESSARY. COORDINATE REQUIRED OPENINGS WITH ALL TRADES THAT REQUIRE

THEM. MINOR OPENINGS ARE NOT SHOWN ON STRUCTURAL DRAWINGS. 8. SEE PLAN AND SCHEDULES FOR COLUMN, WALL AND PIER INFORMATION. 9. HEADED STUDS ON PLAN ARE THUS: 3/4" DIAMETER x 0'-5" LONG. SEE GENERAL

STRUCTURAL NOTES AND DETAILS ON SHEETS S701 AND S702 FOR PLACEMENT REQUIREMENTS ON BEAMS AND GIRDERS. 10. \* ON PLAN INDICATES DIMENSION TO BE VERIFIED BY THE CONTRACTOR WITH SUPPLIERS, MANUFACTURERS, AND ALL ARCHITECTURAL, MECHANICAL AND

ELECTRICAL REQUIREMENTS AS NECESSARY PRIOR TO CONSTRUCTION. 11. W8 "STEEL SAFETY BEAM" DESIGNED USING RECOMMENDED 5,000 POUND NET LIVE LOAD PER OTIS DRAWING NO. AAA 28020BD (NO DATE). TOP OF BEAM ELEVATION TO BE COORDINATED WITH REQUIRED ELEVATOR CLEAR HEIGHT. BEAR ON BEARING PLATE 1/2" x 8" x 0'-8" WITH 3/4" DIAMETER x 4" LONG HSA EACH END OVER FULLY GROUTED CELL. VERIFY SAFETY BEAM REQUIREMENTS WITH ELEVATOR SUPPLIER PRIOR TO FABRICATION.



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**NEW TERMINAL** DESIGN

## **CONSULTANTS**

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Landscape Consultants: **APPOLD DESIGN** 2432 East First Street, Duluth MN 55812 TEL: (218) 591-5079

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Print Name: Paul A. Johnson

Signature:

Date: June 3, 2010 Reg. No.: 20379

RE\	/ISIONS	
NO.	DESCRIPTION	DATE
	BID PACKAGE 1	5.12.10
	FOUNDATION PERMIT	6.4.10
1,2,3	NOT CHANGED	
	CONFORMANCE SET	7.12.10
	BUILDING PERMIT	8.6.10
4	BUILDING PERMIT REVISIONS	10.15.10
5	100% REVIEW	12.15.10

01.24.11

05.02.11

05.25.11 **DATE ISSUED:** 08-23-11 **REVIEWED BY:** PAJ / CWB

BP 2A CONFORMANCE

BID PACKAGE 2A

DRAWN BY: SJL **DESIGNED BY:** CWB AEP PROJECT NUMBER


213-1882-091

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SHEET TITLE

**ROOF LEVEL** FRAMING PLAN -**AREA A** 

> SHEET NUMBER **S116**

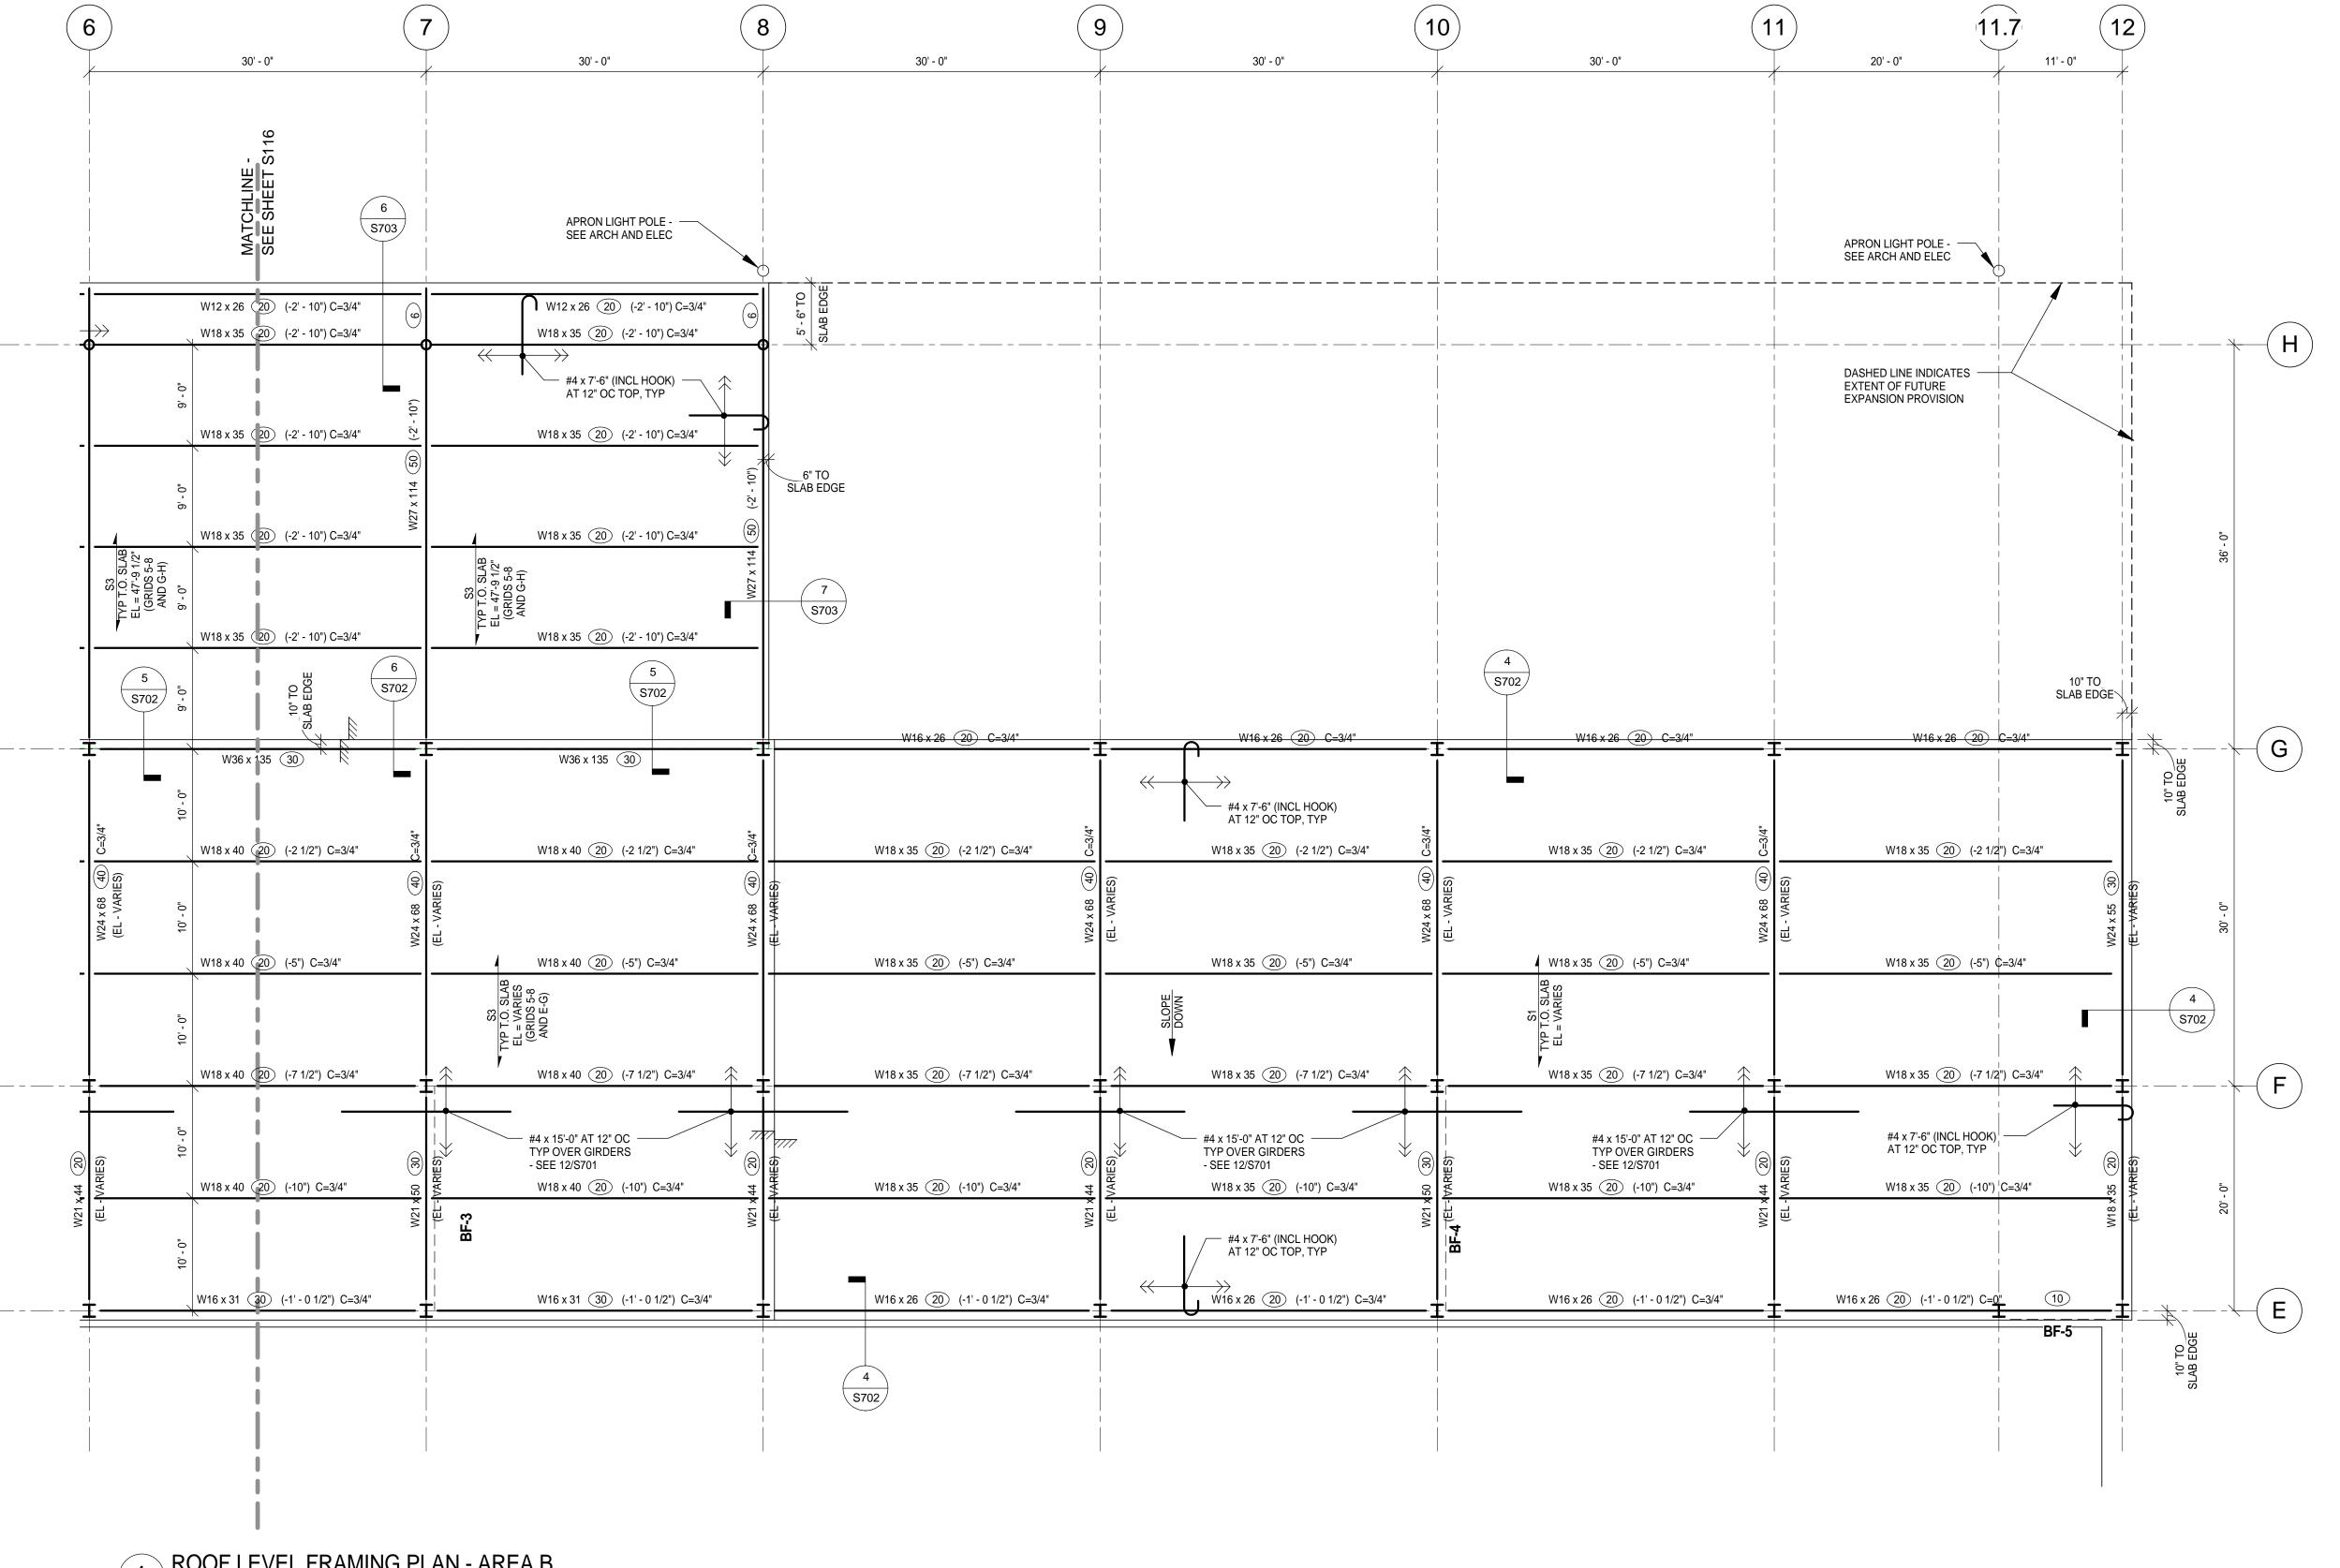

NORTH

ROOF LEVEL FRAMING PLAN - AREA B

TYPICAL PLAN NOTES: 1. TOP OF STEEL BEAM ELEVATION IS REFERENCED (+ OR -) FROM ELEVATION 49' - 6". TOP OF STEEL BEAM = 49' - 6", UNLESS NOTED OTHERWISE.

2. TOP OF SLAB ELEVATION VARIES. SEE PLAN REFER TO ARCHITECTURAL DRAWINGS FOR ADDITIONAL DIMENSIONS, ELEVATIONS, ANGLES AND LOCATION OF WORK POINTS. SEE SHEET S001 FOR TYPICAL

ABBREVIATIONS AND S002 AND S003 FOR GENERAL STRUCTURAL NOTES. 4. BF1 ON PLAN INDICATES BRACED FRAME MARK. REFER TO \$301 FOR BRACED FRAME ELEVATIONS, NOTES AND ADDITIONAL DETAIL.

5. S1 ON PLAN INDICATES SLAB ON METAL DECK MARK. D1 ON PLAN INDICATES ROOF DECK MARK. SEE SCHEDULE ON SHEET S701. 6. DO NOT CUT CONTROL JOINTS IN SLABS ON METAL DECK.7. VERIFY EXACT SIZE, LOCATION AND QUANTITY OF REQUIRED OPENINGS THROUGH THE

FLOOR AND/OR ROOF WITH ARCHITECTURAL AND OTHER CONSULTANT DRAWINGS AS NECESSARY. COORDINATE REQUIRED OPENINGS WITH ALL TRADES THAT REQUIRE THEM. MINOR OPENINGS ARE NOT SHOWN ON STRUCTURAL DRAWINGS. 8. SEE PLAN AND SCHEDULES FOR COLUMN, WALL AND PIER INFORMATION. 9. HEADED STUDS ON PLAN ARE THUS: 3/4" DIAMETER x 0'-5" LONG. SEE GENERAL

STRUCTURAL NOTES AND DETAILS ON SHEETS S701 AND S702 FOR PLACEMENT REQUIREMENTS ON BEAMS AND GIRDERS. 10. \* ON PLAN INDICATES DIMENSION TO BE VERIFIED BY THE CONTRACTOR WITH

SUPPLIERS, MANUFACTURERS, AND ALL ARCHITECTURAL, MECHANICAL AND ELECTRICAL REQUIREMENTS AS NECESSARY PRIOR TO CONSTRUCTION. 11. W8 "STEEL SAFETY BEAM" DESIGNED USING RECOMMENDED 5,000 POUND NET LIVE LOAD PER OTIS DRAWING NO. AAA 28020BD (NO DATE), TOP OF BEAM ELEVATION TO BE COORDINATED WITH REQUIRED ELEVATOR CLEAR HEIGHT. BEAR ON BEARING PLATE 1/2" x 8" x 0'-8" WITH 3/4" DIAMETER x 4" LONG HSA EACH END OVER FULLY GROUTED CELL. VERIFY SAFETY BEAM REQUIREMENTS WITH ELEVATOR SUPPLIER PRIOR TO FABRICATION.



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5	100% REVIEW	12.15.10
	BID PACKAGE 2A	01.24.11
	BP 2A CONFORMANCE	05.02.11

**DATE ISSUED:** 08-23-11 **REVIEWED BY:** PAJ / CWB DRAWN BY: SJL


> **DESIGNED BY:** CWB AEP PROJECT NUMBER

> > 213-1882-091

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**ROOF LEVEL** FRAMING PLAN -**AREA B** 

> SHEET NUMBER **S117**

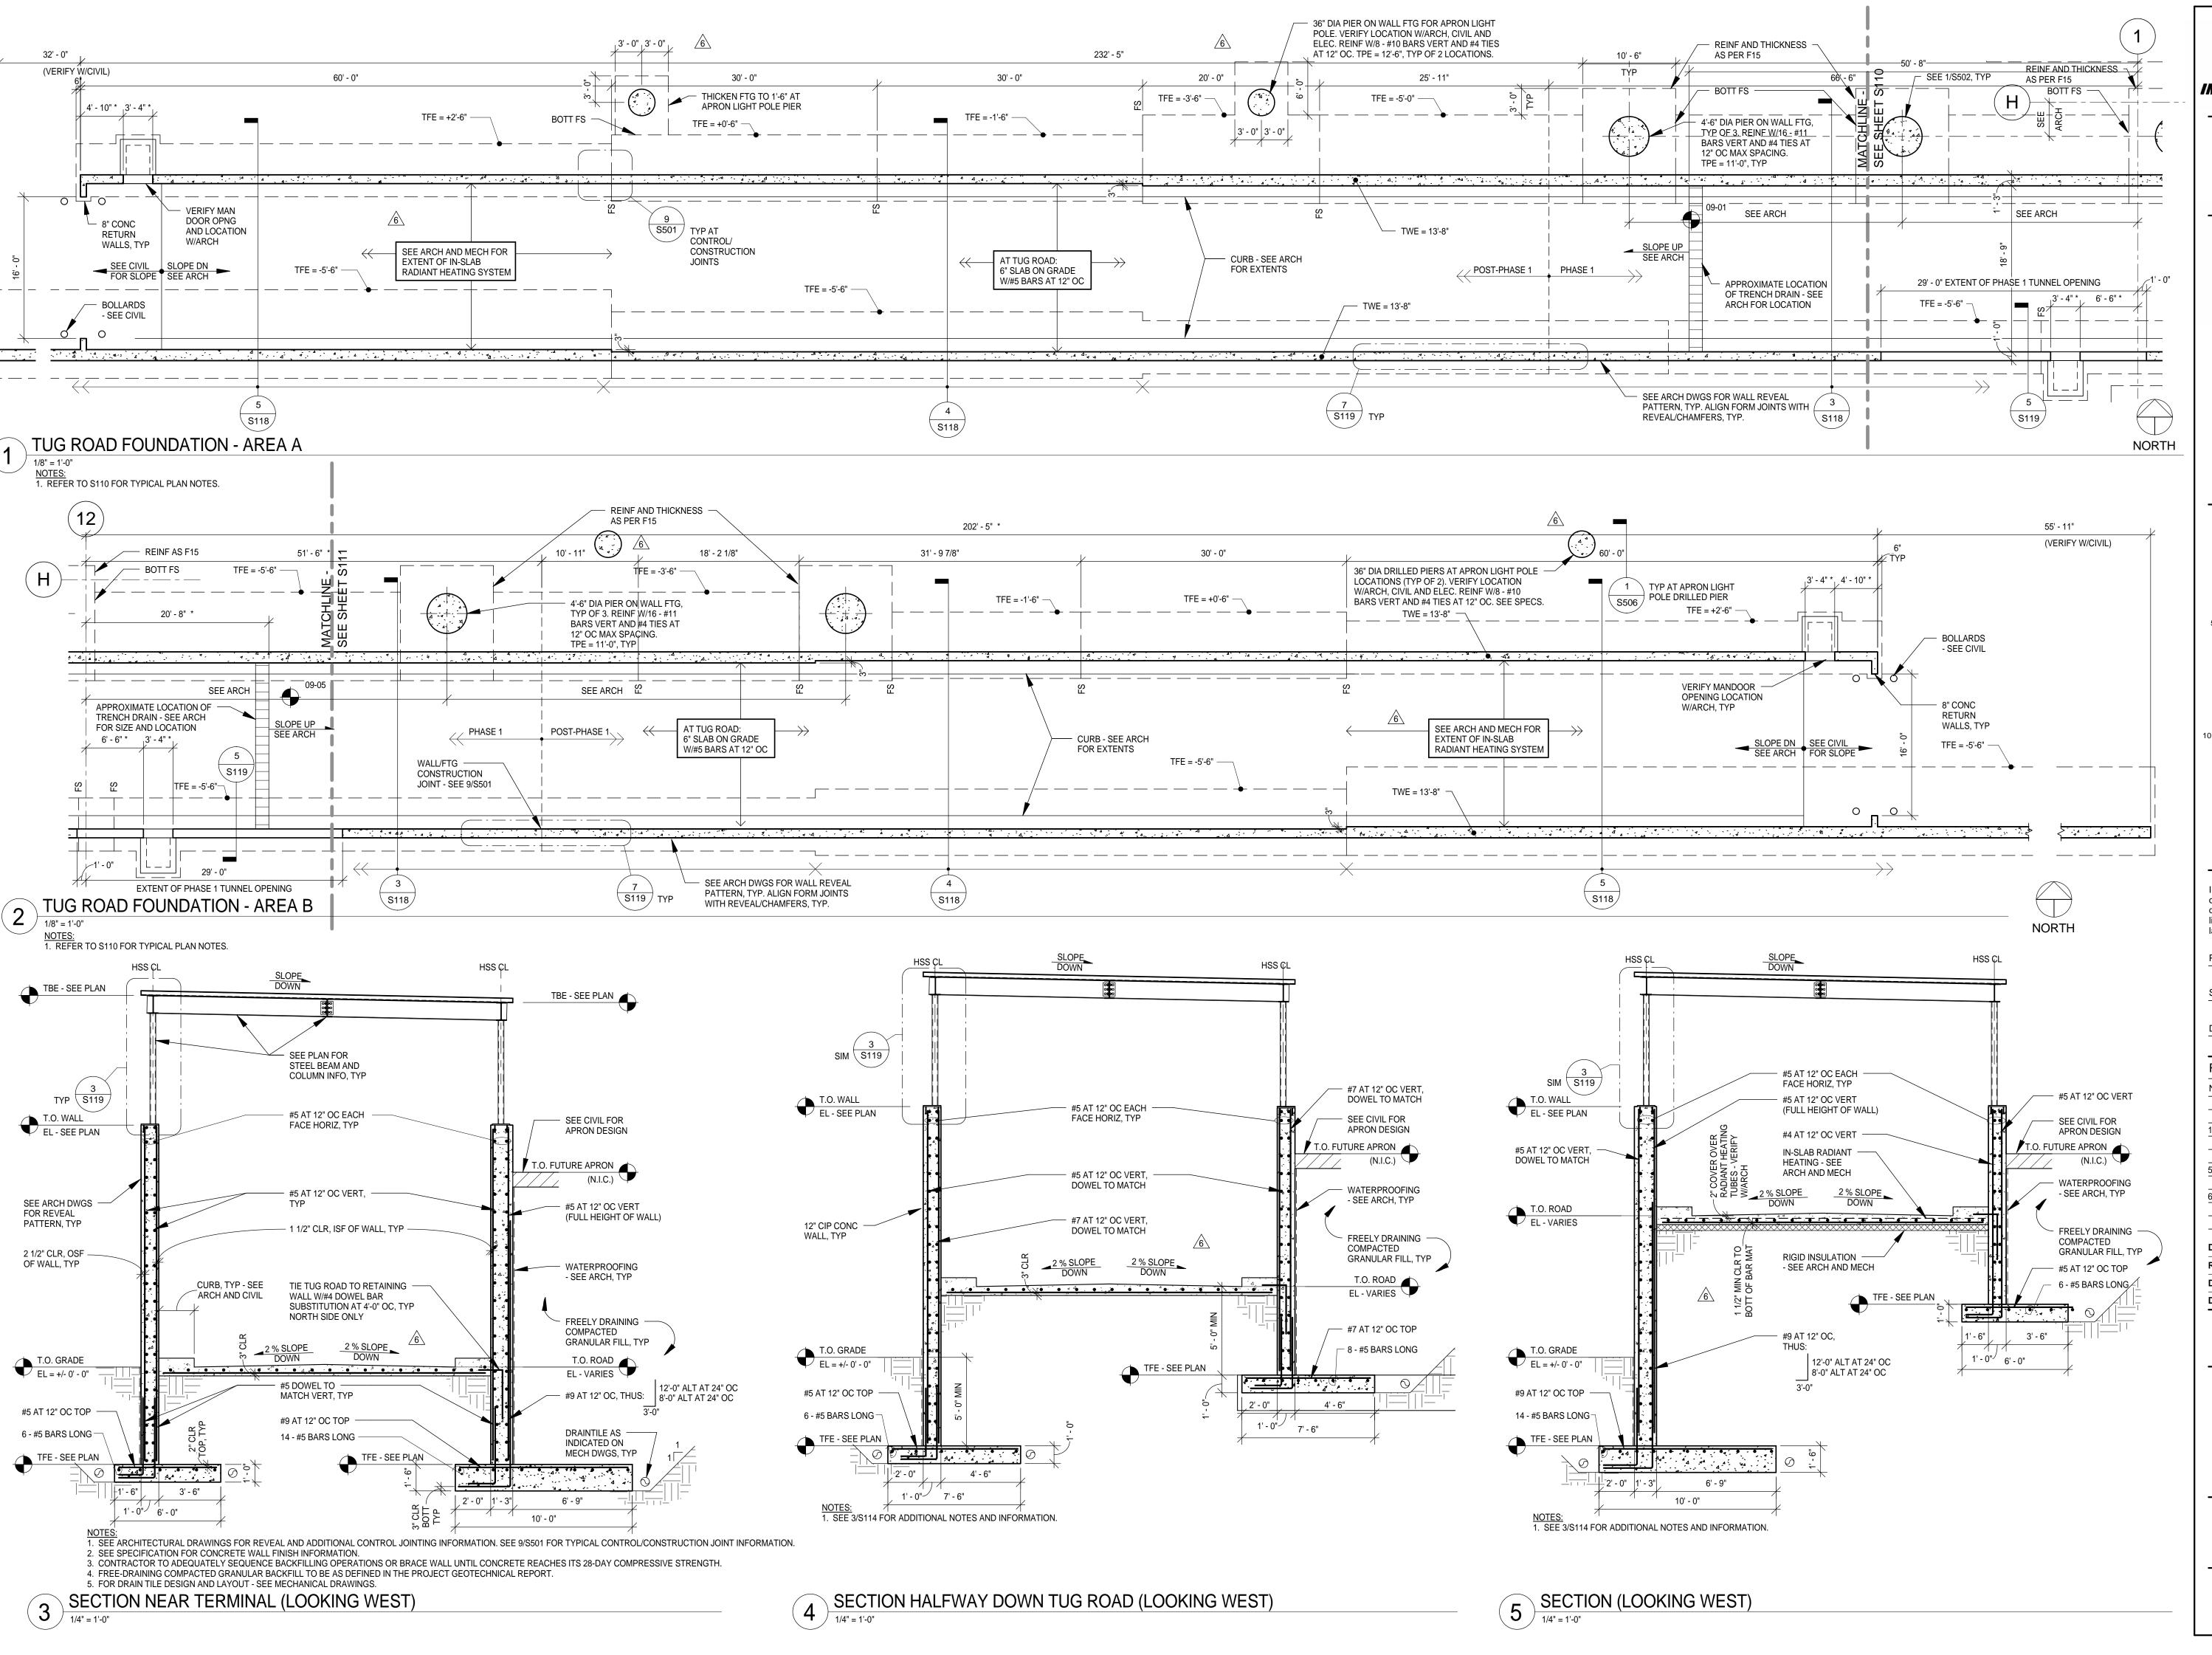

RS&FF.

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REVISIONS

RFP 120

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	BID PACKAGE 2A	01.24.11
6	BP2A ADDENDUM 2	02.25.11
	BP 2A CONFORMANCE	05.02.11

DATE ISSUED: 08-23-11

REVIEWED BY: PAJ / CWB

DRAWN BY: SJL

DESIGNED BY: CWB

AEP PROJECT NUMBER


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07.22.11

TUG ROAD FOUNDATION PLAN

SHEET NUMBER **S118** 



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	BP 2A CONFORMANCE	05.02.11
	RFP 120	07.22.11
		1

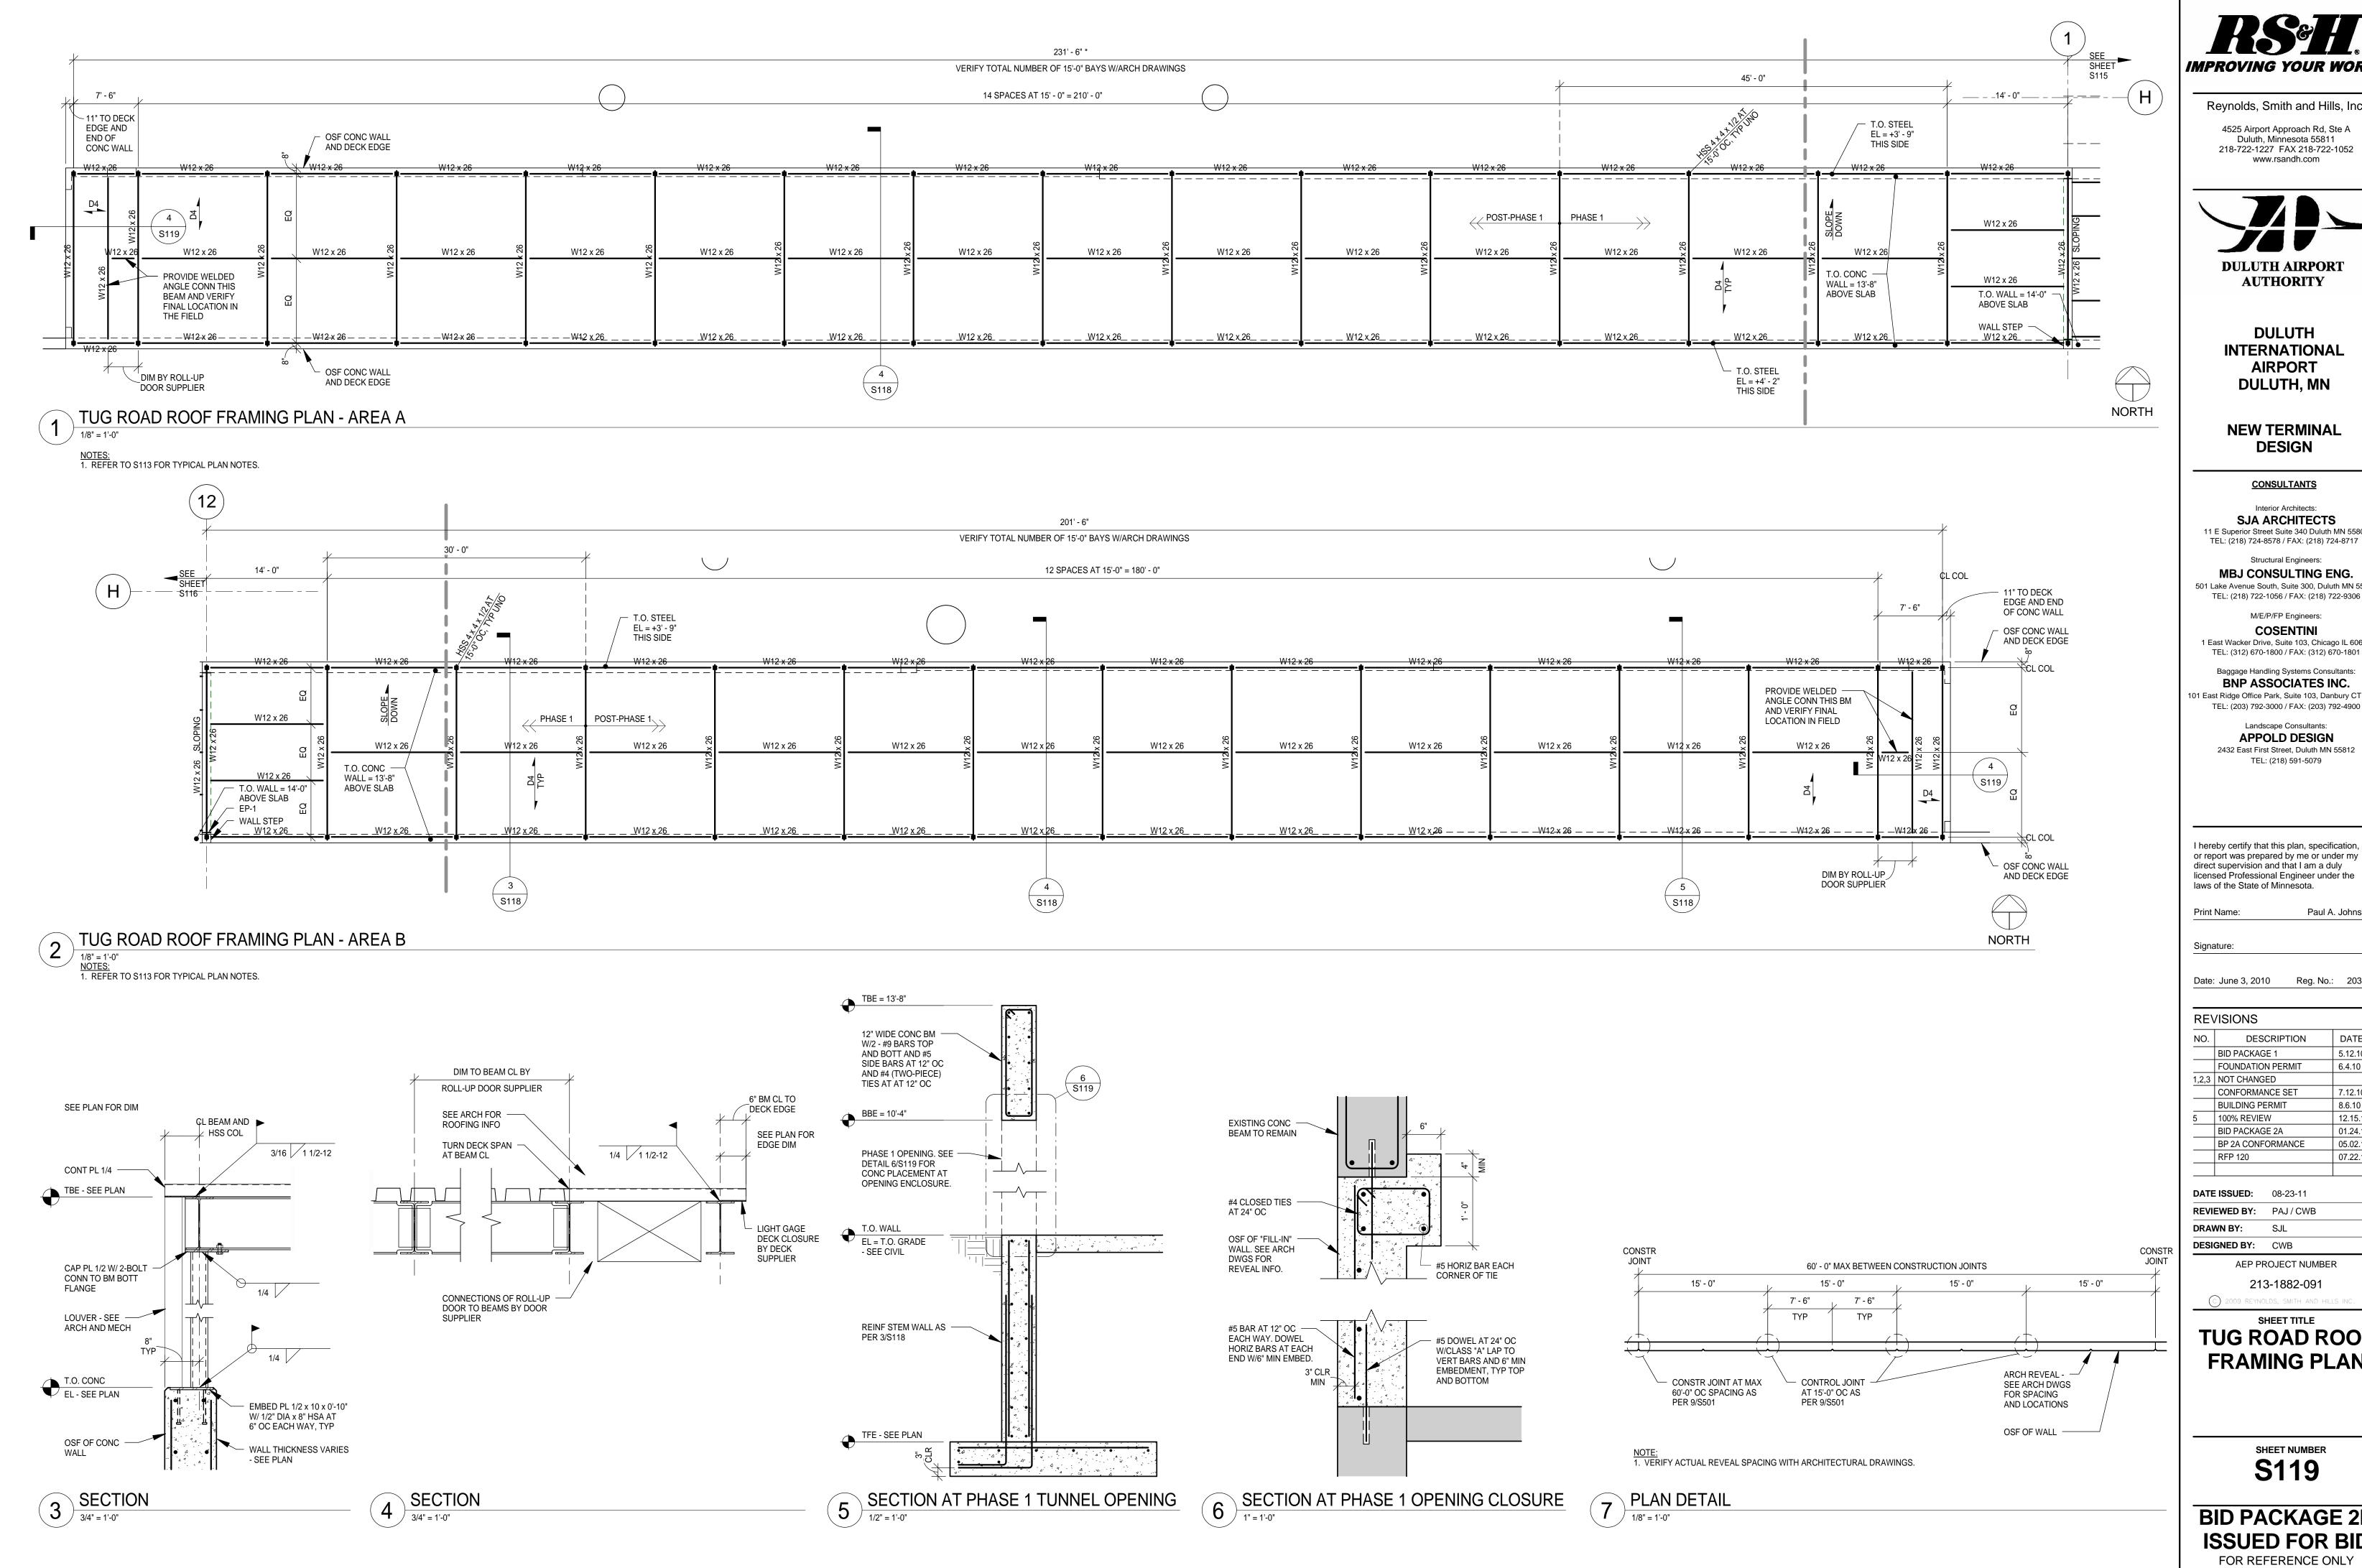
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REVIEWED BY:	PAJ / CWB	
DRAWN BY:	SJL	
DESIGNED BY:	CWB	
AEP PROJECT NUMBER		
213-1882-091		


SHEET TITLE

**TUG ROAD ROOF** FRAMING PLAN

> SHEET NUMBER **S119**

**BID PACKAGE 2B ISSUED FOR BID** 

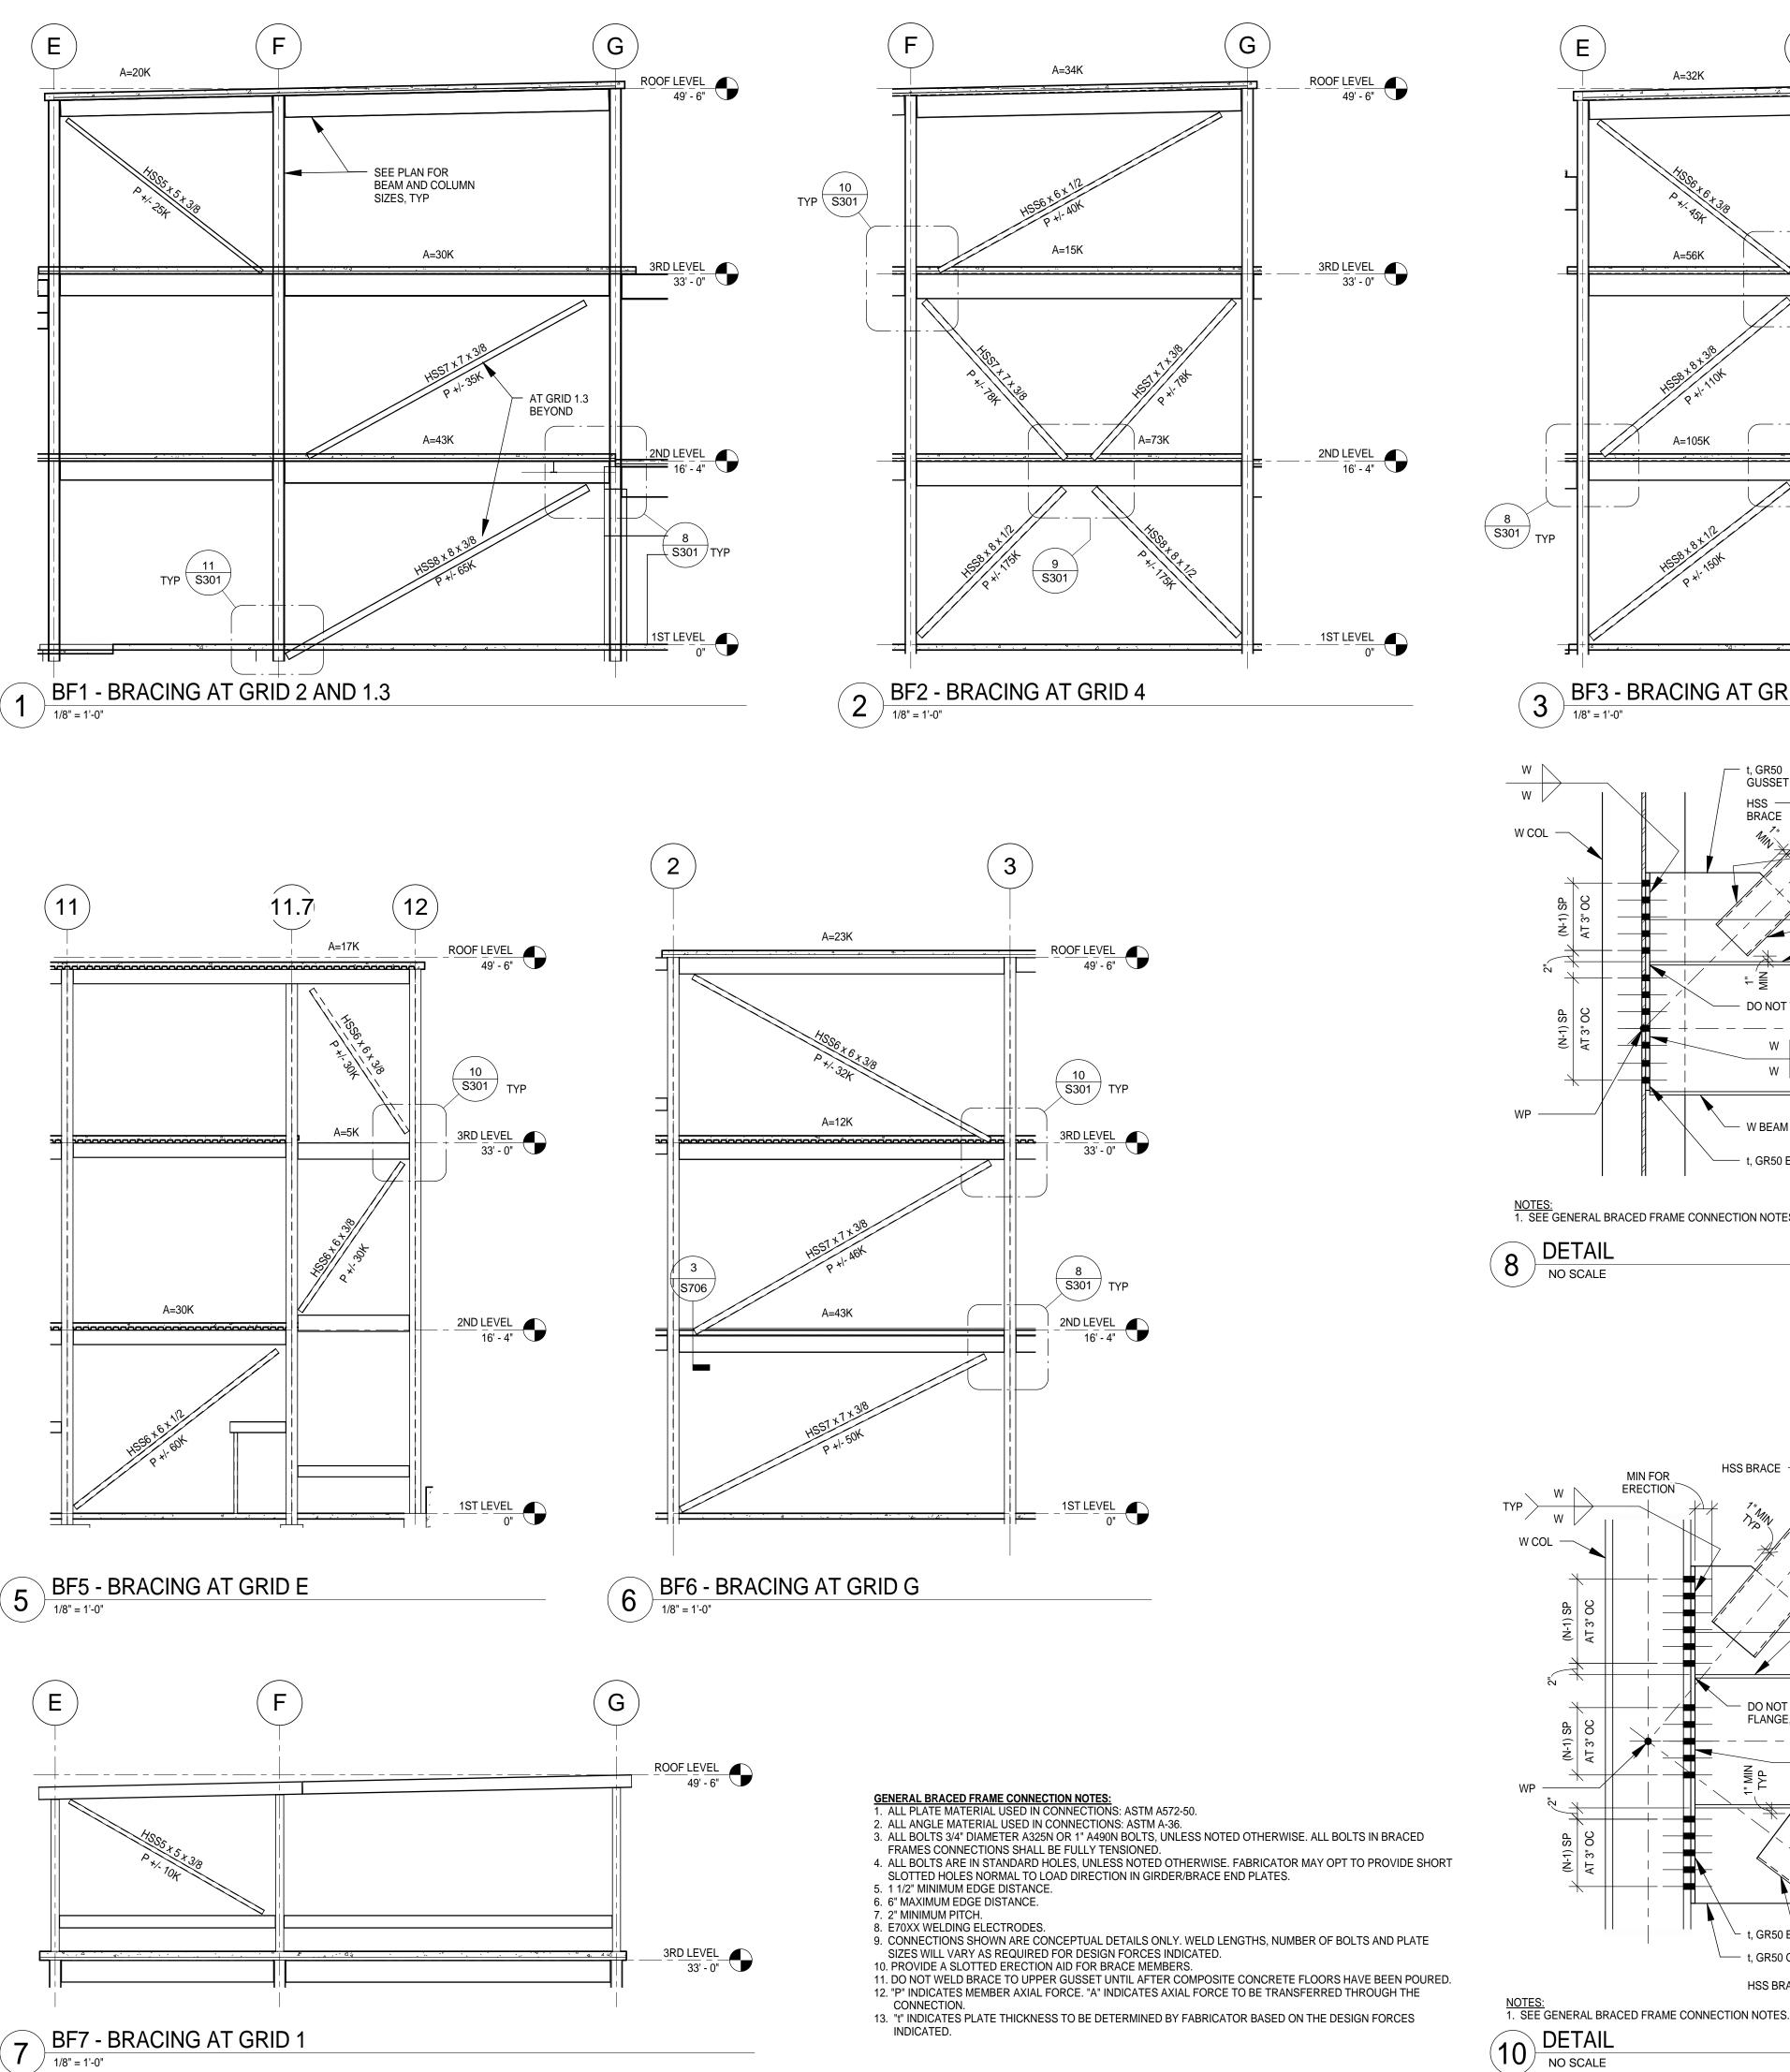

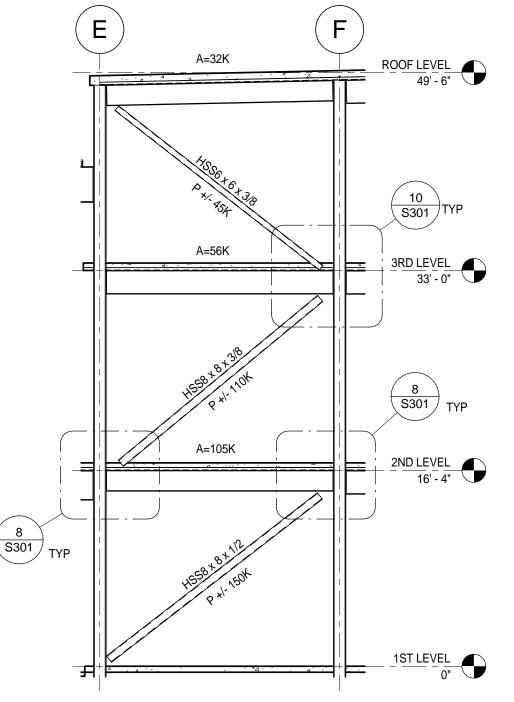


Ε

A=103K

BF4 - BRACING AT GRID 10




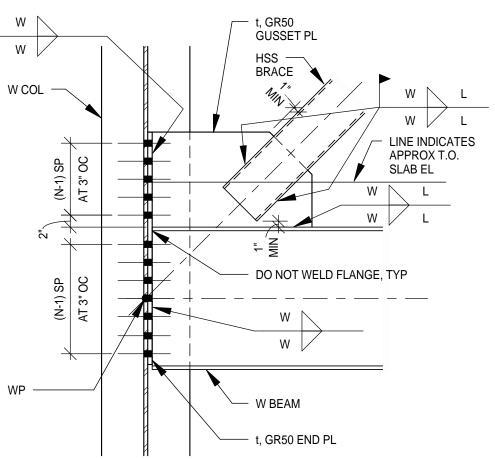

NOTES:

1. SEE GENERAL BRACED FRAME CONNECTION NOTES.

8 DETAIL

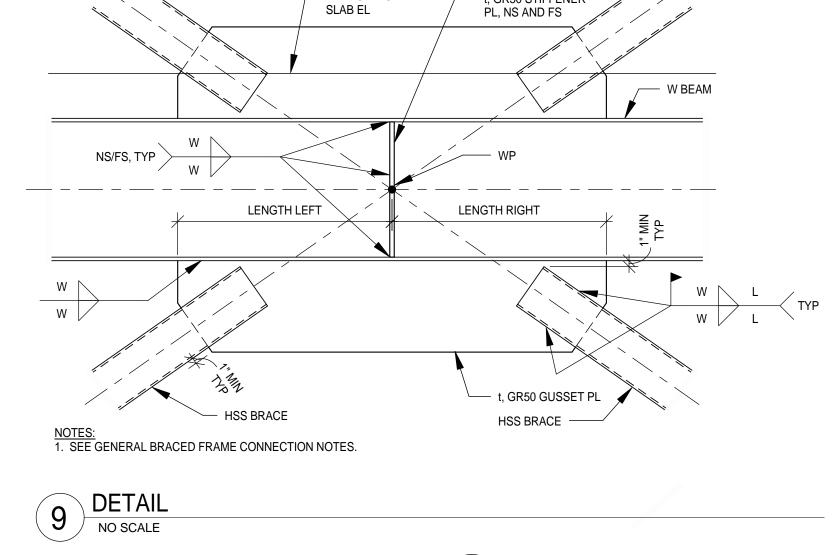

LINE INDICATES

A=156K

HSS BRACE

t, GR50 STIFFENER

SEE SHEET S401 — FOR BASE PL INFO

TYPICAL FOUNDATION DETAIL AT BRACED FRAMES L7 x 4 x 3/4 x 1'-8" (LLV)
 EACH SIDE OF COLUMN T.O. SLAB

EL - SEE PLAN TYP EACH END TPE OR TFE - SEE PLAN EMBED PL 3/4 x 10 x 2'-0" (CENTER ON LONG SIDE OF BASE PL) W/ 8 - 3/4" DIA x 7" HSA AT 7" OC EACH WAY SEE PLAN AND SCHEDULES FOR FTG, BASE PL AND ANCHOR BOLT INFO

LINE INDICATES

GUSSET PL

DO NOT WELD

t, GR50 END PL

- t, GR50 GUSSET PL

HSS BRACE

APPROX T.O. SLAB EL

SECTION NO SCALE

# IMPROVING YOUR WORLD

G

ROOF LEVEL 49' - 6"

3RD LEVEL

 $\binom{8}{\text{S301}}$  TYP

2ND LEVEL 16' - 4"

\_ 1ST LEVEL \_\_\_\_\_

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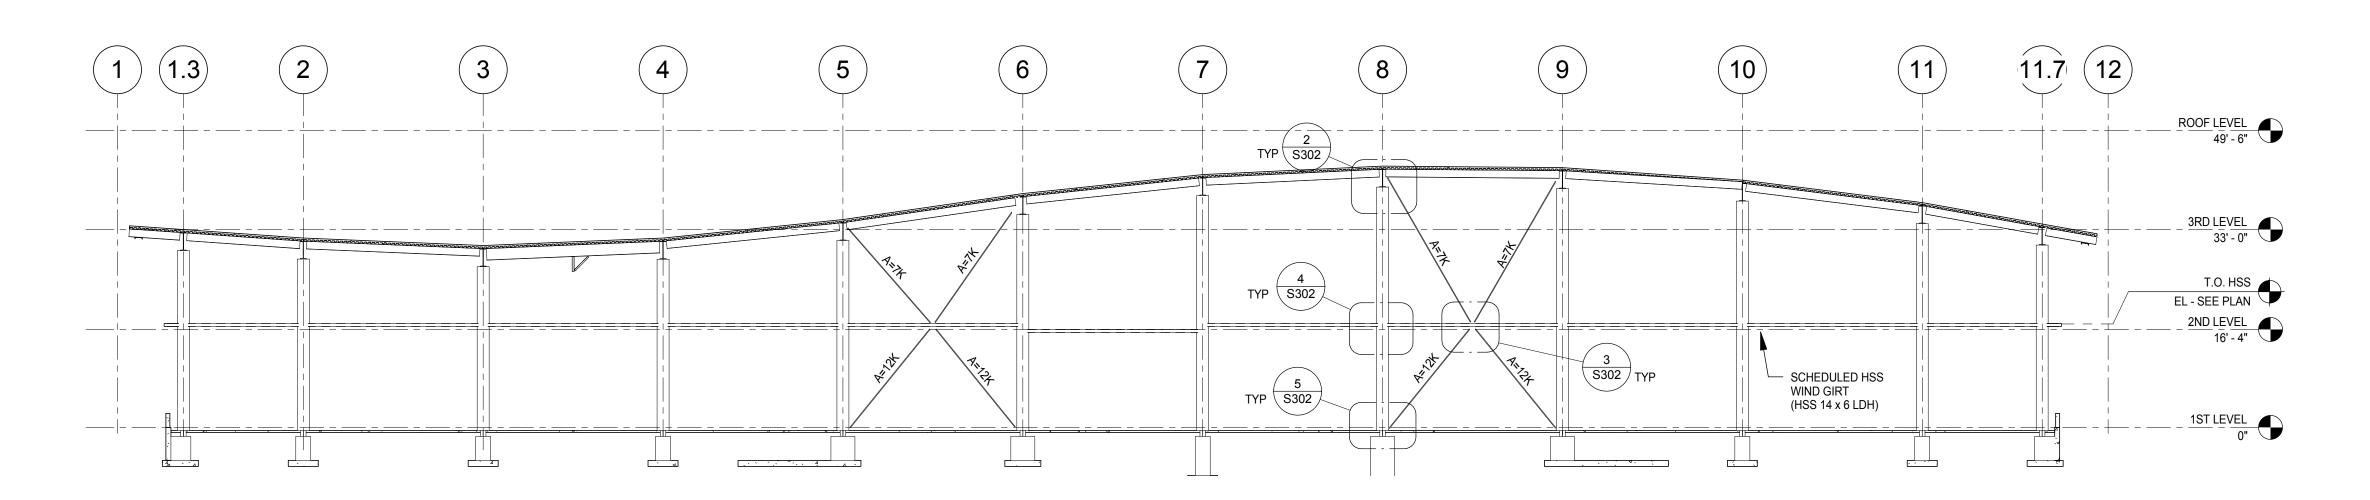
**DESIGNED BY:** CWB AEP PROJECT NUMBER

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> SHEET TITLE **BRACING**


**ELEVATIONS AND DETAILS** 


> SHEET NUMBER **S301**




## 1 ELEVATION AT GRID "C"

NOTES:
1. SEE GENERAL BRACED FRAME CONNECTION NOTES ON SHEET S301, TYPICAL THIS SHEET.

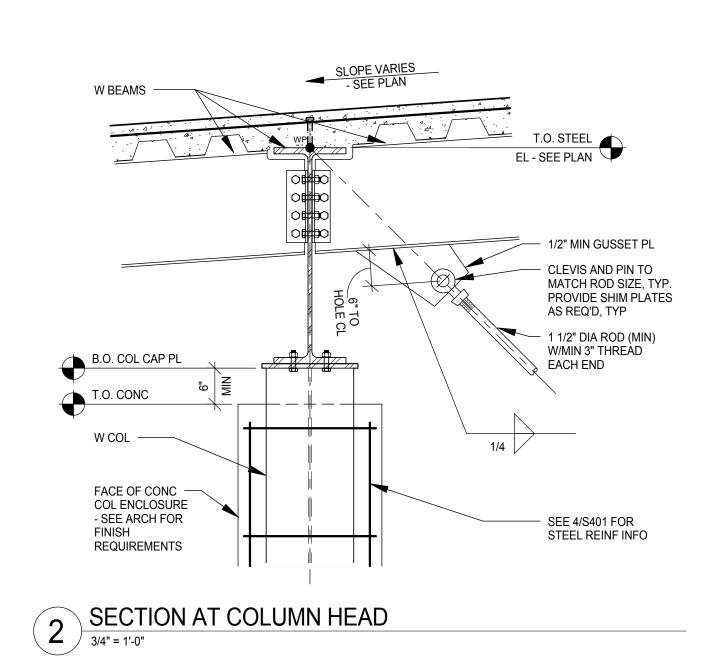

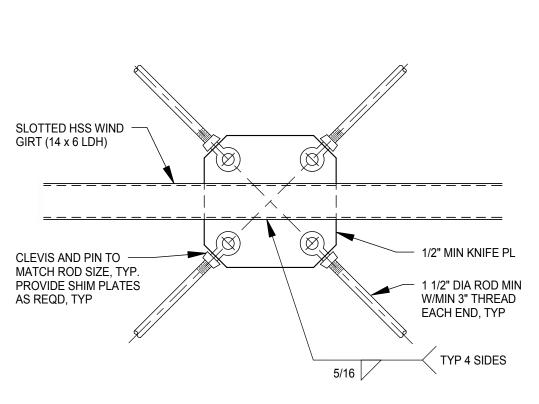




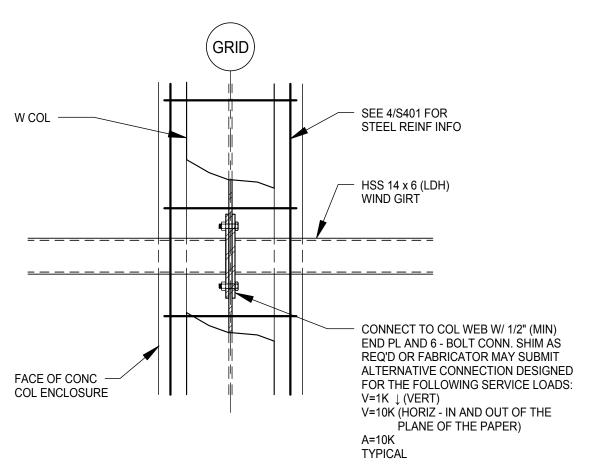

4 SECTION AT COLUMN TO GIRT CONNECTION

3/4" = 1'-0"

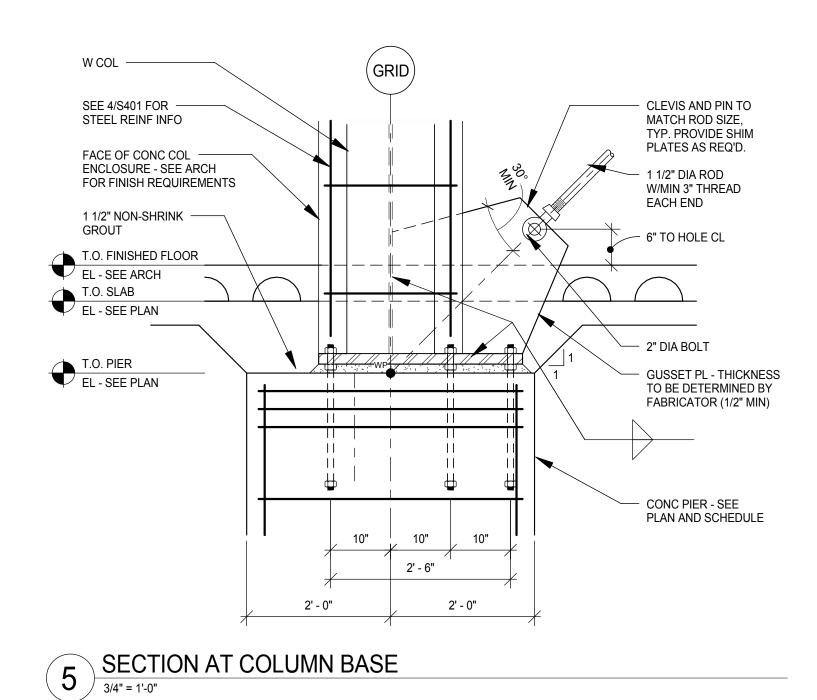

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DRAWN BY: SJL

DESIGNED BY: CWB


AEP PROJECT NUMBER


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BRACING ELEVATIONS AND DETAILS

SHEET NUMBER S302




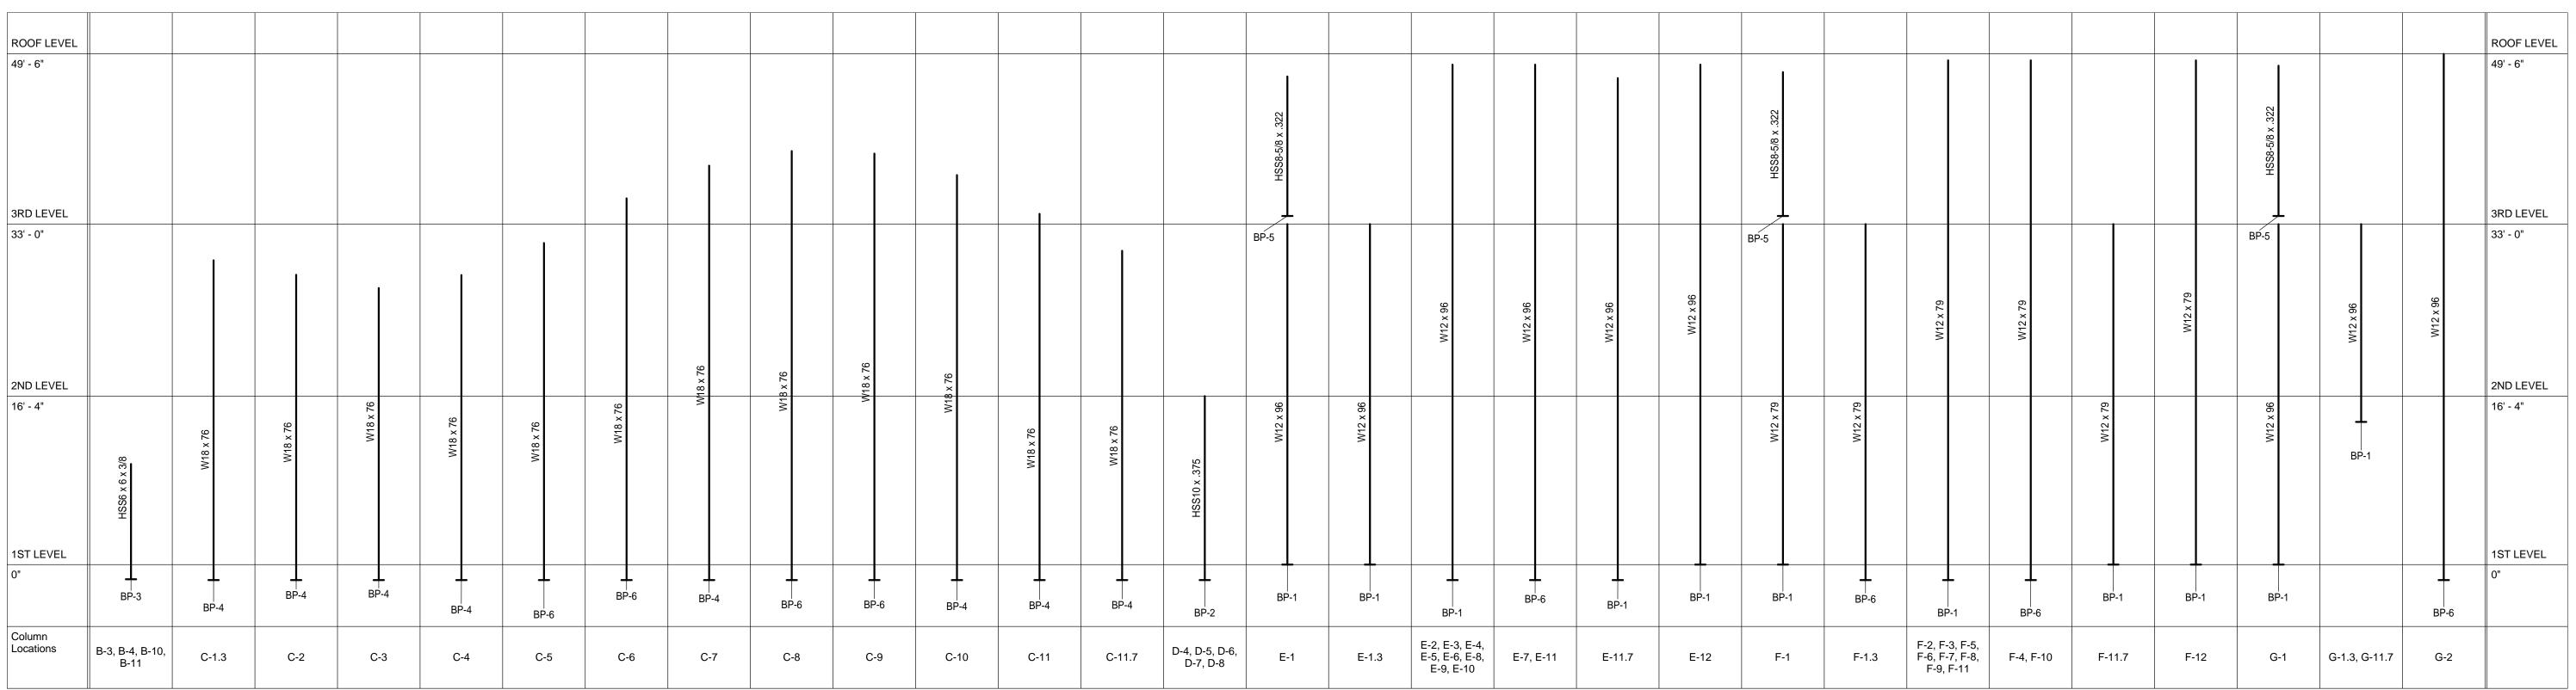

NOTES:

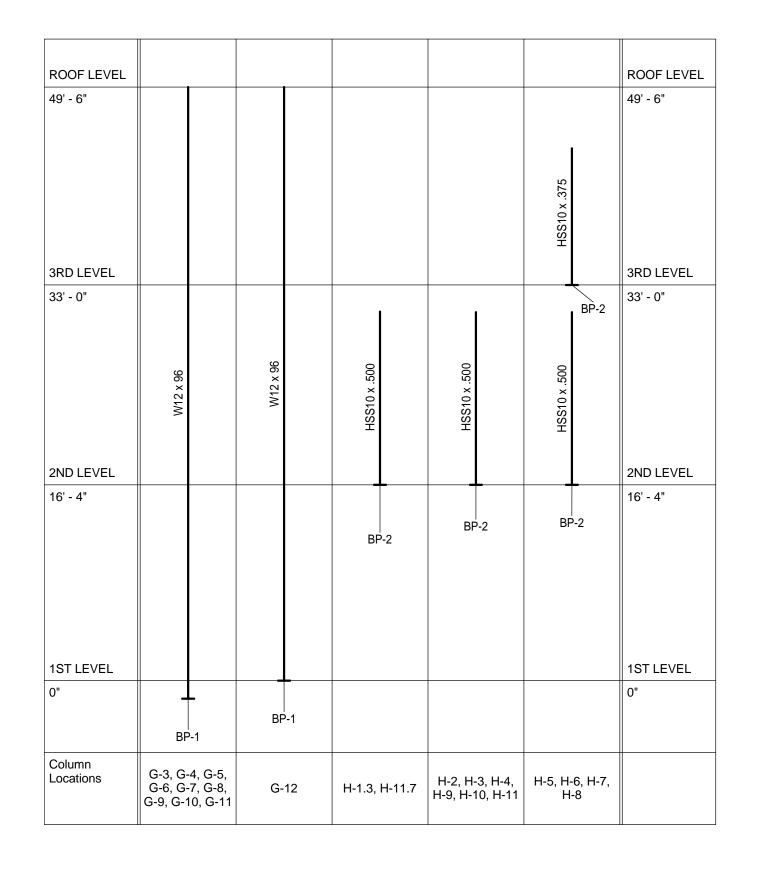1. FOR BASE PLATE AND ANCHOR BOLT INFORMATION, SEE COLUMN BASE PLATE SCHEDULE THIS SHEET. 2. AT HSS ROUND COLUMNS, FABRICATOR MAY OPT TO SUBMIT EQUIVALENT PIPE SECTION TO A/E FOR REVIEW IN LIEU OF HSS ROUND COLUMN SHOWN.

STEEL COLUMN SCHEDULE 1 NO SCALE

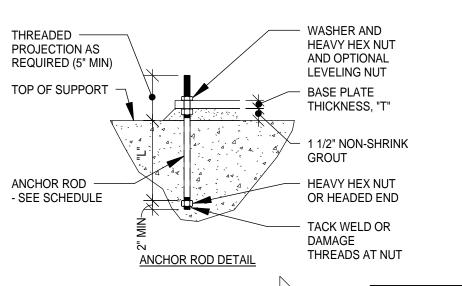

5/16
<u>a</u>
0 0
PROVIDE GROUT HOLE IF "B" OR "N" IS GREATER UNO
THAN 18" PLAN AT WF COLUMN (UNO)
NOTES (UNO):

	COLUMN BASE PLATE AND ANCHOR ROD SCHEDULE						
	BASE F	PLATE S	IZE (IN)	Д	NCHOR	RODS	
MARK	"N"	"B"	"T"	NO.	DIA (IN)	EMBED "L"	COMMENTS:
BP-1	20	20	1 3/4"	4	3/4"	0'-11"	AT GRID E-10, ANCHOR ROD EMBED LENGTH "L" = 2'-0"
BP-2	16	16	1"	4	3/4"	0'-11"	
BP-3	12	12	3/4"	4	3/4"	0'-11"	
BP-4	20	14	1 1/2"	4	3/4"	0'-11"	SEE 3/S401
BP-5	12	12	3/4"	4	1/2"	0'-3 1/2"	EXP ANCHORS
BP-6	24	34	1 3/4"	6	1"	1'-6"	SEE 3/S401
BP-7	12	18	1 1/2"	4	3/4"	0'-11"	

"N"

PLAN AT HSS/PIPE COLUMN (UNO)

PROVIDE 1/2" DIA DRAIN

HOLE AT BASE OF

UNO

 SEE SCHEDULE FOR BASE PLATE AND ANCHOR ROD DIMENSIONS. 2. DIMENSION "N" IS PARALLEL TO WF WEB OR LONGER HSS DIMENSION.


3. ANCHOR RODS SHALL BE ASTM F1554, GRADE 36.

4. BASE PLATES SHALL BE ASTM A36, MINIMUM.


MILL COLUMN BASE AND/OR BASE PLATE AS NECESSARY FOR FULL CONTACT.
 ANCHOR RODS SHALL SET BY TEMPLATE AND NOT BE SET INTO CONCRETE AFTER CONCRETE IS CAST.

7. SEE SHEETS S301 AND S302 FOR ADDITIONAL INFORMATION AT BRACED FRAME BASE PLATES. 8. FOR ALL UNDESIGNATED BASE PLATES, MINIMUM "N" = MEMBER SIZE + 4". MINIMUM "B" = MEMBER WIDTH + 1".

MINIMUM "T" = 1/2". MINIMUM 4 - 3/4" DIAMETER ANCHOR RODS. COLUMN BASE PLATE AND ANCHOR ROD SCHEDULE NO SCALE

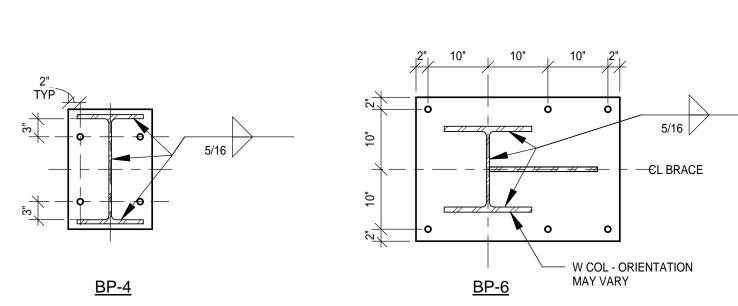

BASE PLATE DETAILS
NO SCALE

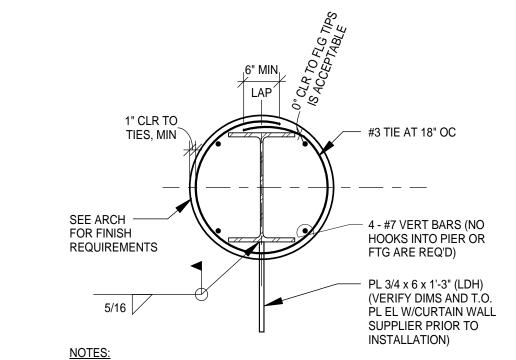

NOTES:

1. SEE PLAN FOR LOCATIONS.

CONCRETE ENCASED WIDE FLANGE COLUMN NO SCALE



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**REVISIONS** 


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COLUMN SCHEDULE AND **DETAILS** 

> SHEET NUMBER **S401**




## TYPICAL INTERIOR WF COLUMN FOOTING DETAIL NO SCALE

TENSION LAP S	TENSION LAP SPLICE / CONCRETE / GR 60 UNCOATED REINFORCING				
STRUCTURAL ELEMENTS	FOOTINGS / SLAB-ON-GRADE / CONCRETE FILL ON METAL DECK				
CONCRETE	F'c = 4,000 PSI (NORMAL WEIGHT)				
BAR SIZE	CLASS	"A" LAP	CLASS	"B" LAP	
	BASIC	TOP BAR	BASIC	TOP BAR	
#3	12"	14"	14"	18"	
#4	15"	19"	19"	25"	
#5	18"	23"	23"	30"	
#6	22"	28"	28"	36"	
#7	32"	42"	42"	55"	
#8	42"	55"	55"	71"	
#9	53"	69"	69"	90"	
#10	68"	88"	88"	114"	
#11	83"	108"	108"	140"	

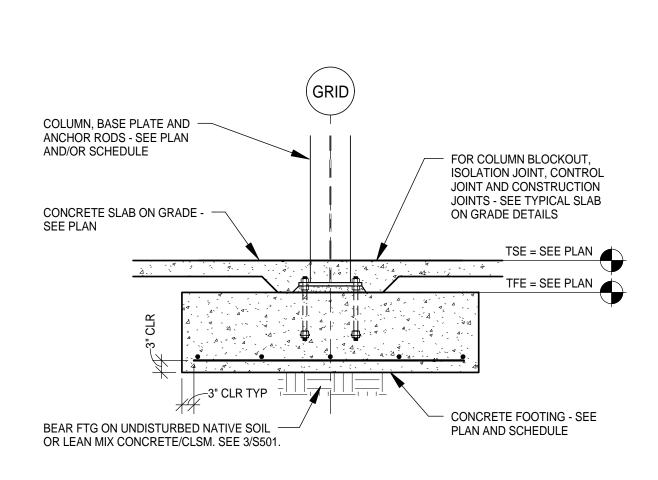1. TOP BARS ARE HORIZONTAL BARS WITH MORE THAN 12" OF CONCRETE PLACED BELOW THEM.



**JOINTS** 

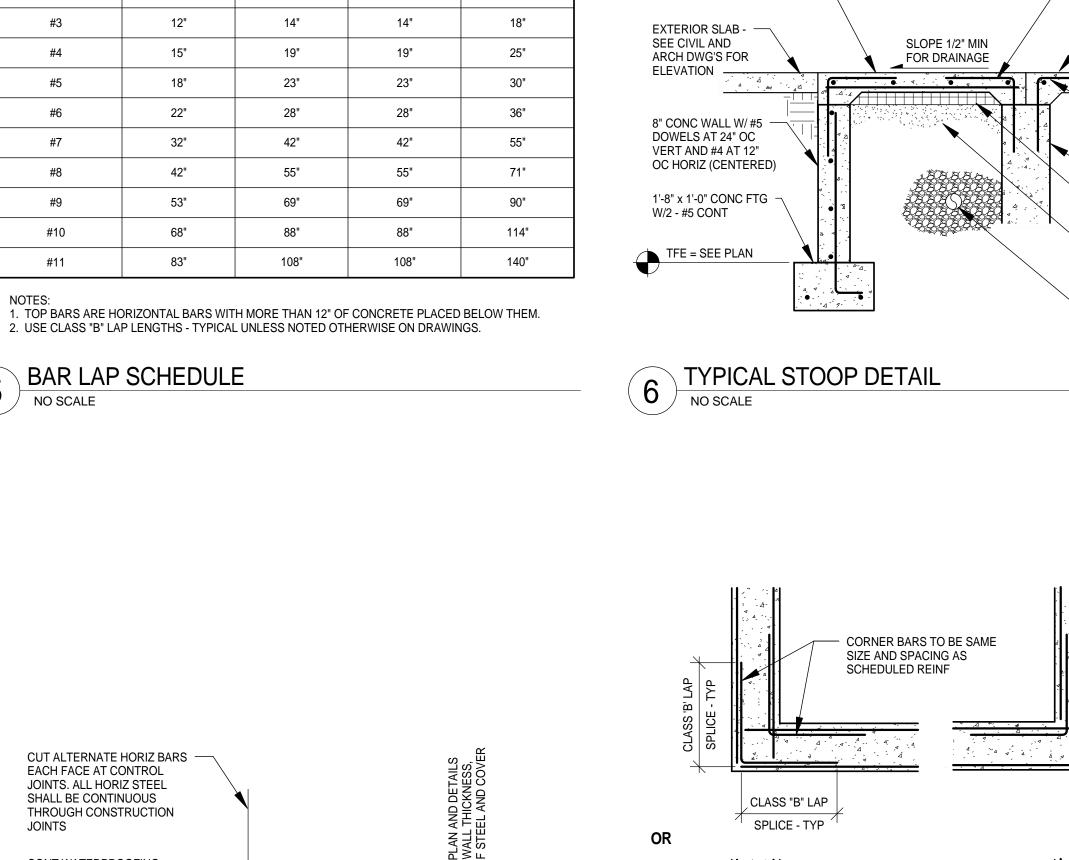


6" STOOP SLAB W/ #4 ----

**EPOXY COATED DOWELS** 

BOTTOM COVER

AT 16" OC EACH WAY W/ 2"

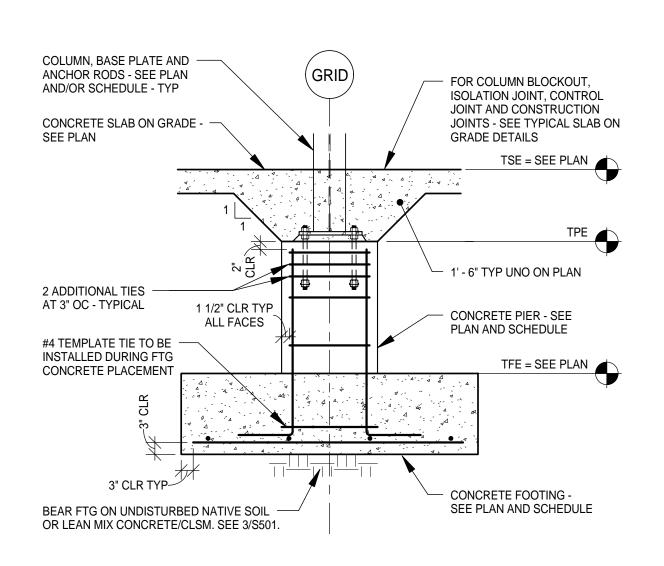

TYPICAL WF COLUMN, CONCRETE PIER AND FOOTING DETAIL

#4 EPOXY COATED

DOWELS AT 16" OC

ALL SIDED THUS:

SLAB ON GRADE

TSE = SEE PLAN

#4 DOWELS AT

16" OC THUS:

FDN WALL

- SEE ARCH

COMPACTED

FROST

RIGID INSULATION


GRANULAR NON-

SUSCEPTIBLE FILL

CONT DRAIN PIPE

- SEE CIVIL


- SEE PLAN

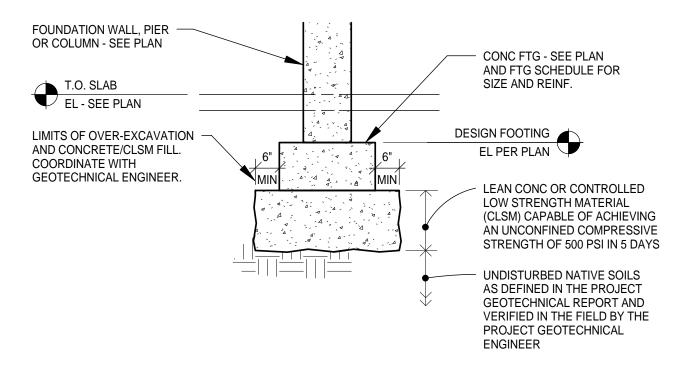

1. THIS DETAIL APPLIES ONLY AT LOCATIONS WHERE THE GEOTECHNICAL ENGINEER HAS DETERMINED THAT SOILS AT THE DESIGN FOOTING ELEVATIONS ARE NOT ADEQUATE FOR FOOTING SUPPORT ACCORDING TO THE ALLOWABLE SOIL BEARING CAPACITY LISTED UNDER "DESIGN UNIT STRESS" ON SHEET S002. 2. IN LIEU OF OVER-EXCAVATING AND PLACING LEAN CONCRETE OR CLSM AS OUTLINED IN THIS DETAIL CONTRACTOR MAY LOWER THE DESIGN FOOTING ELEVATION SUCH THAT THE FOOTING RESTS DIRECTLY ON UNDISTURBED NATIVE SOILS AS APPROVED BY THE GEOTECHNICAL ENGINEER IN THE FIELD. 3. SEE GEOTECHNICAL REPORT FOR WATER TABLE ELEVATIONS. CONTRACTOR TO MAKE ADEQUATE


OVER-EXCAVATION WITH LEAN CONCRETE/CLSM FILL DETAIL NO SCALE

PROVISIONS FOR DEWATERING AS REQUIRED.

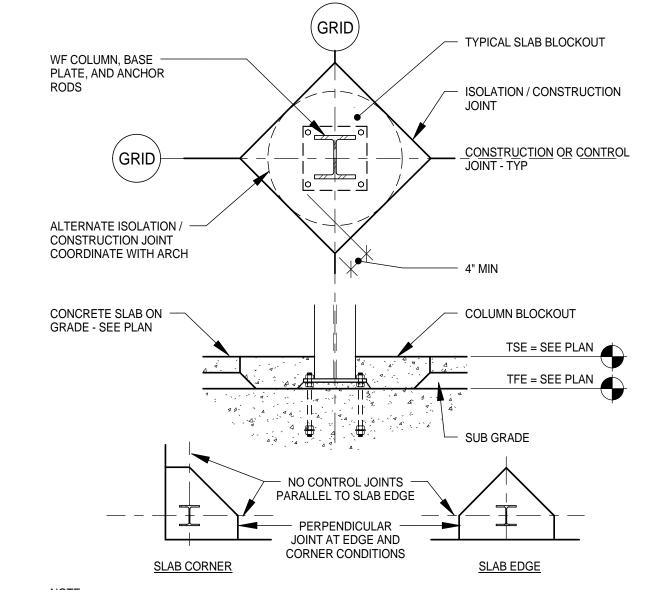


1. CONTRACTOR MAY PROPOSE ALTERNATE ISOLATION JOINT DETAIL TO A/E PRIOR TO CONSTRUCTION.


TYPICAL COLUMN ISOLATION JOINT NO SCALE

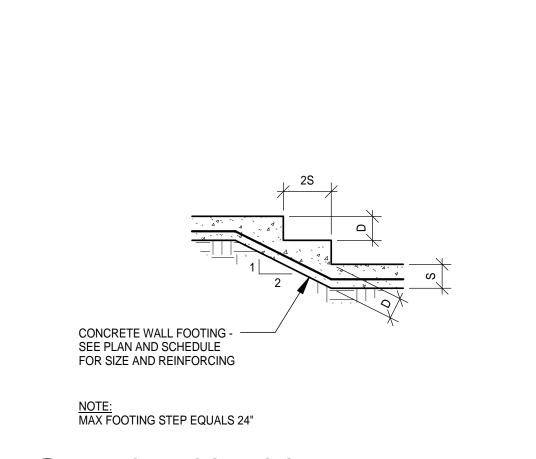


TYPICAL FOOTING STEP NO SCALE

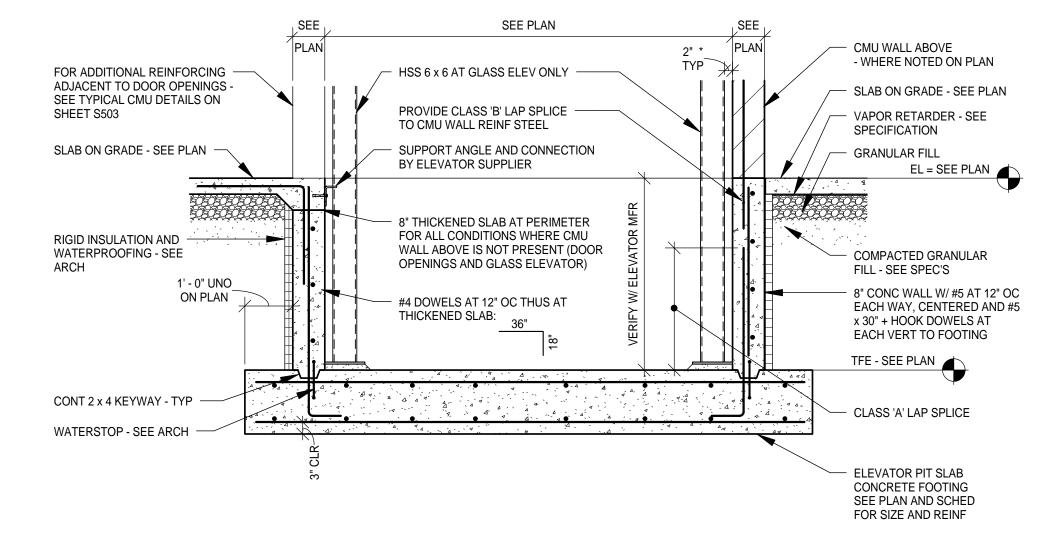


SECTION THRU ELEVATOR PIT NO SCALE

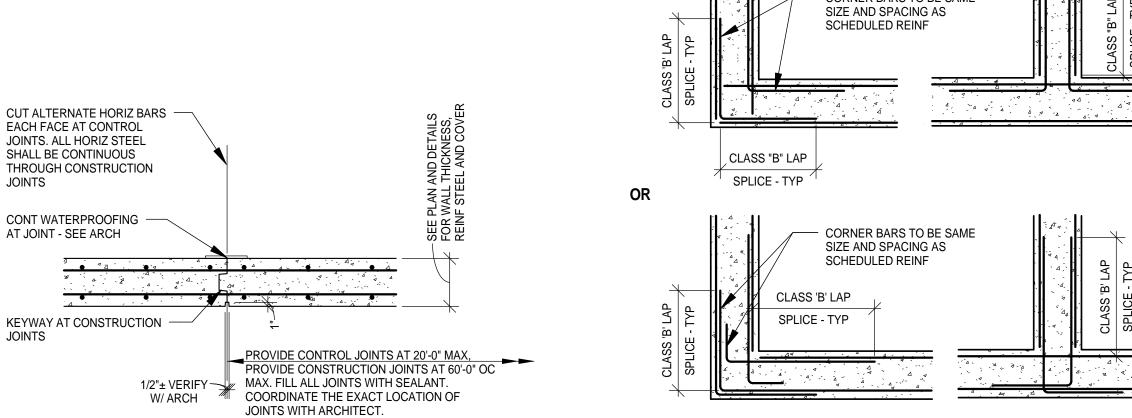

TYPICAL CONSTRUCTION/CONTROL JOINTS FOR CONCRETE WALLS

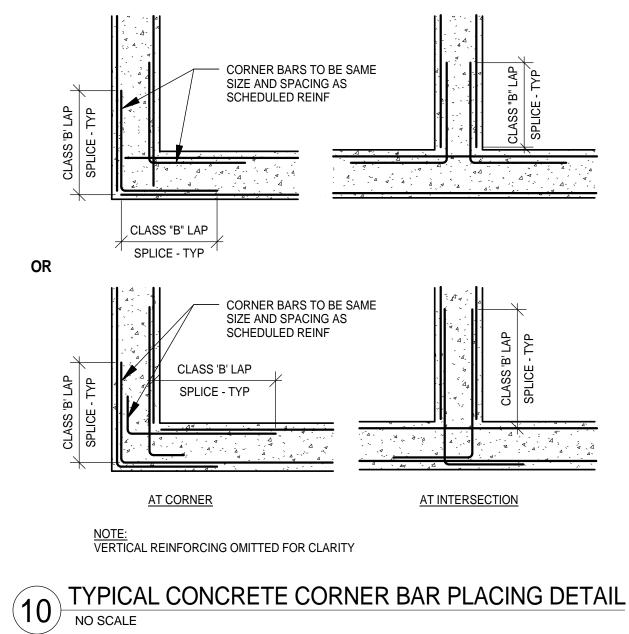


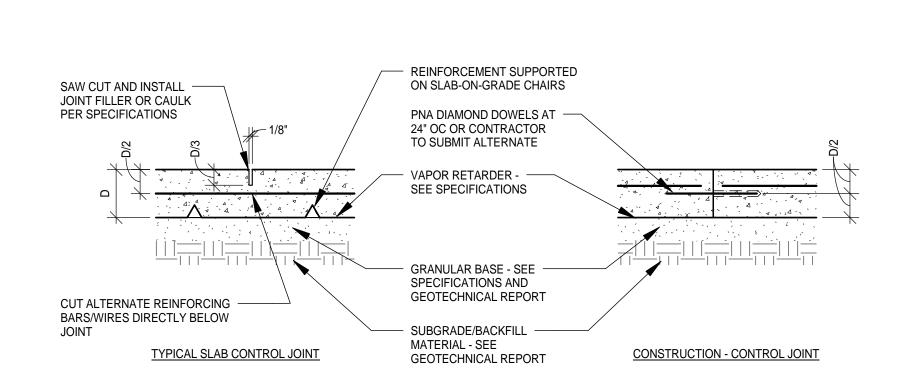

NOTES: 1. A CONSTRUCTION JOINT WHICH IS NOT INTENDED TO ALSO SERVE AS A CONTROL JOINT IS TO HAVE ALL REINFORCING EXTEND THROUGH IT AND TO HAVE NO GROOVE/SAW-CUT, UNLESS NOTED OTHERWISE. 2. IGNORE REINFORCING NOTES AT UNREINFORCED OR FIBER REINFORCED SLABS-ON-GRADE. 3. FOR EXTERIOR SLAB ON GRADE EXPOSED TO FREEZE-THAW CYCLES, CONSTRUCT A SLAB EXPANSION-CONTRACTION JOINT THE SAME EXCEPT ADD 3/8" COMPRESSIBLE MATERIAL THROUGH JOINT.

TYPICAL SLAB ON GRADE CONSTRUCTION DETAIL

1/2" = 1'-0"

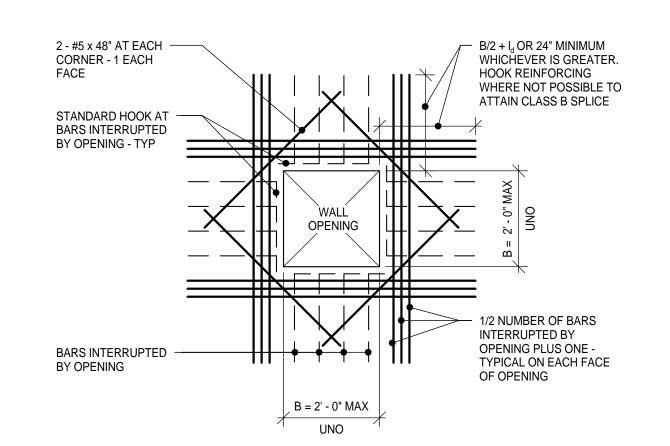

NOTES:

1. FOR WALL OPENINGS LARGER THAN 2'-0" (FOR WALLS NOT SUBJECT TO LATERAL EARTHPRESSURE) ADD

1. FOR WALL OPENINGS LARGER THAN 2'-0" (FOR WALLS NOT SUBJECT TO LATERAL EARTHPRESSURE) ADD 2 - #5 EACH FACE ALL 4 SIDES OF OPENING. EXTEND BAR 24" PAST OPENING UNLESS NOTED

TYPICAL ADDITIONAL BAR PLACING DETAIL FOR WALL OPENING

1/2" = 1'-0"

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**NEW TERMINAL** DESIGN

**CONSULTANTS** 

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> Landscape Consultants: **APPOLD DESIGN** 2432 East First Street, Duluth MN 55812

> > TEL: (218) 591-5079

I hereby certify that this plan, specification, or report was prepared by me or under my direct supervision and that I am a duly

laws of the State of Minnesota.

licensed Professional Engineer under the

Print Name: Paul A. Johnson

Signature:

Date: June 3, 2010 Reg. No.: 20379


/ISIONS	
DESCRIPTION	DATE
BID PACKAGE 1	5.12.10
FOUNDATION PERMIT	6.4.10
NOT CHANGED	
CONFORMANCE SET	7.12.10
BUILDING PERMIT	8.6.10
100% REVIEW	12.15.10
BID PACKAGE 2A	01.24.11
BP 2A CONFORMANCE	05.02.11
	DESCRIPTION BID PACKAGE 1 FOUNDATION PERMIT NOT CHANGED CONFORMANCE SET BUILDING PERMIT 100% REVIEW BID PACKAGE 2A

**DATE ISSUED:** 08-23-11 **REVIEWED BY:** PAJ / CWB DRAWN BY: SJL **DESIGNED BY:** CWB AEP PROJECT NUMBER 213-1882-091

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**STRUCTURAL DETAILS** 

> **SHEET NUMBER S501**

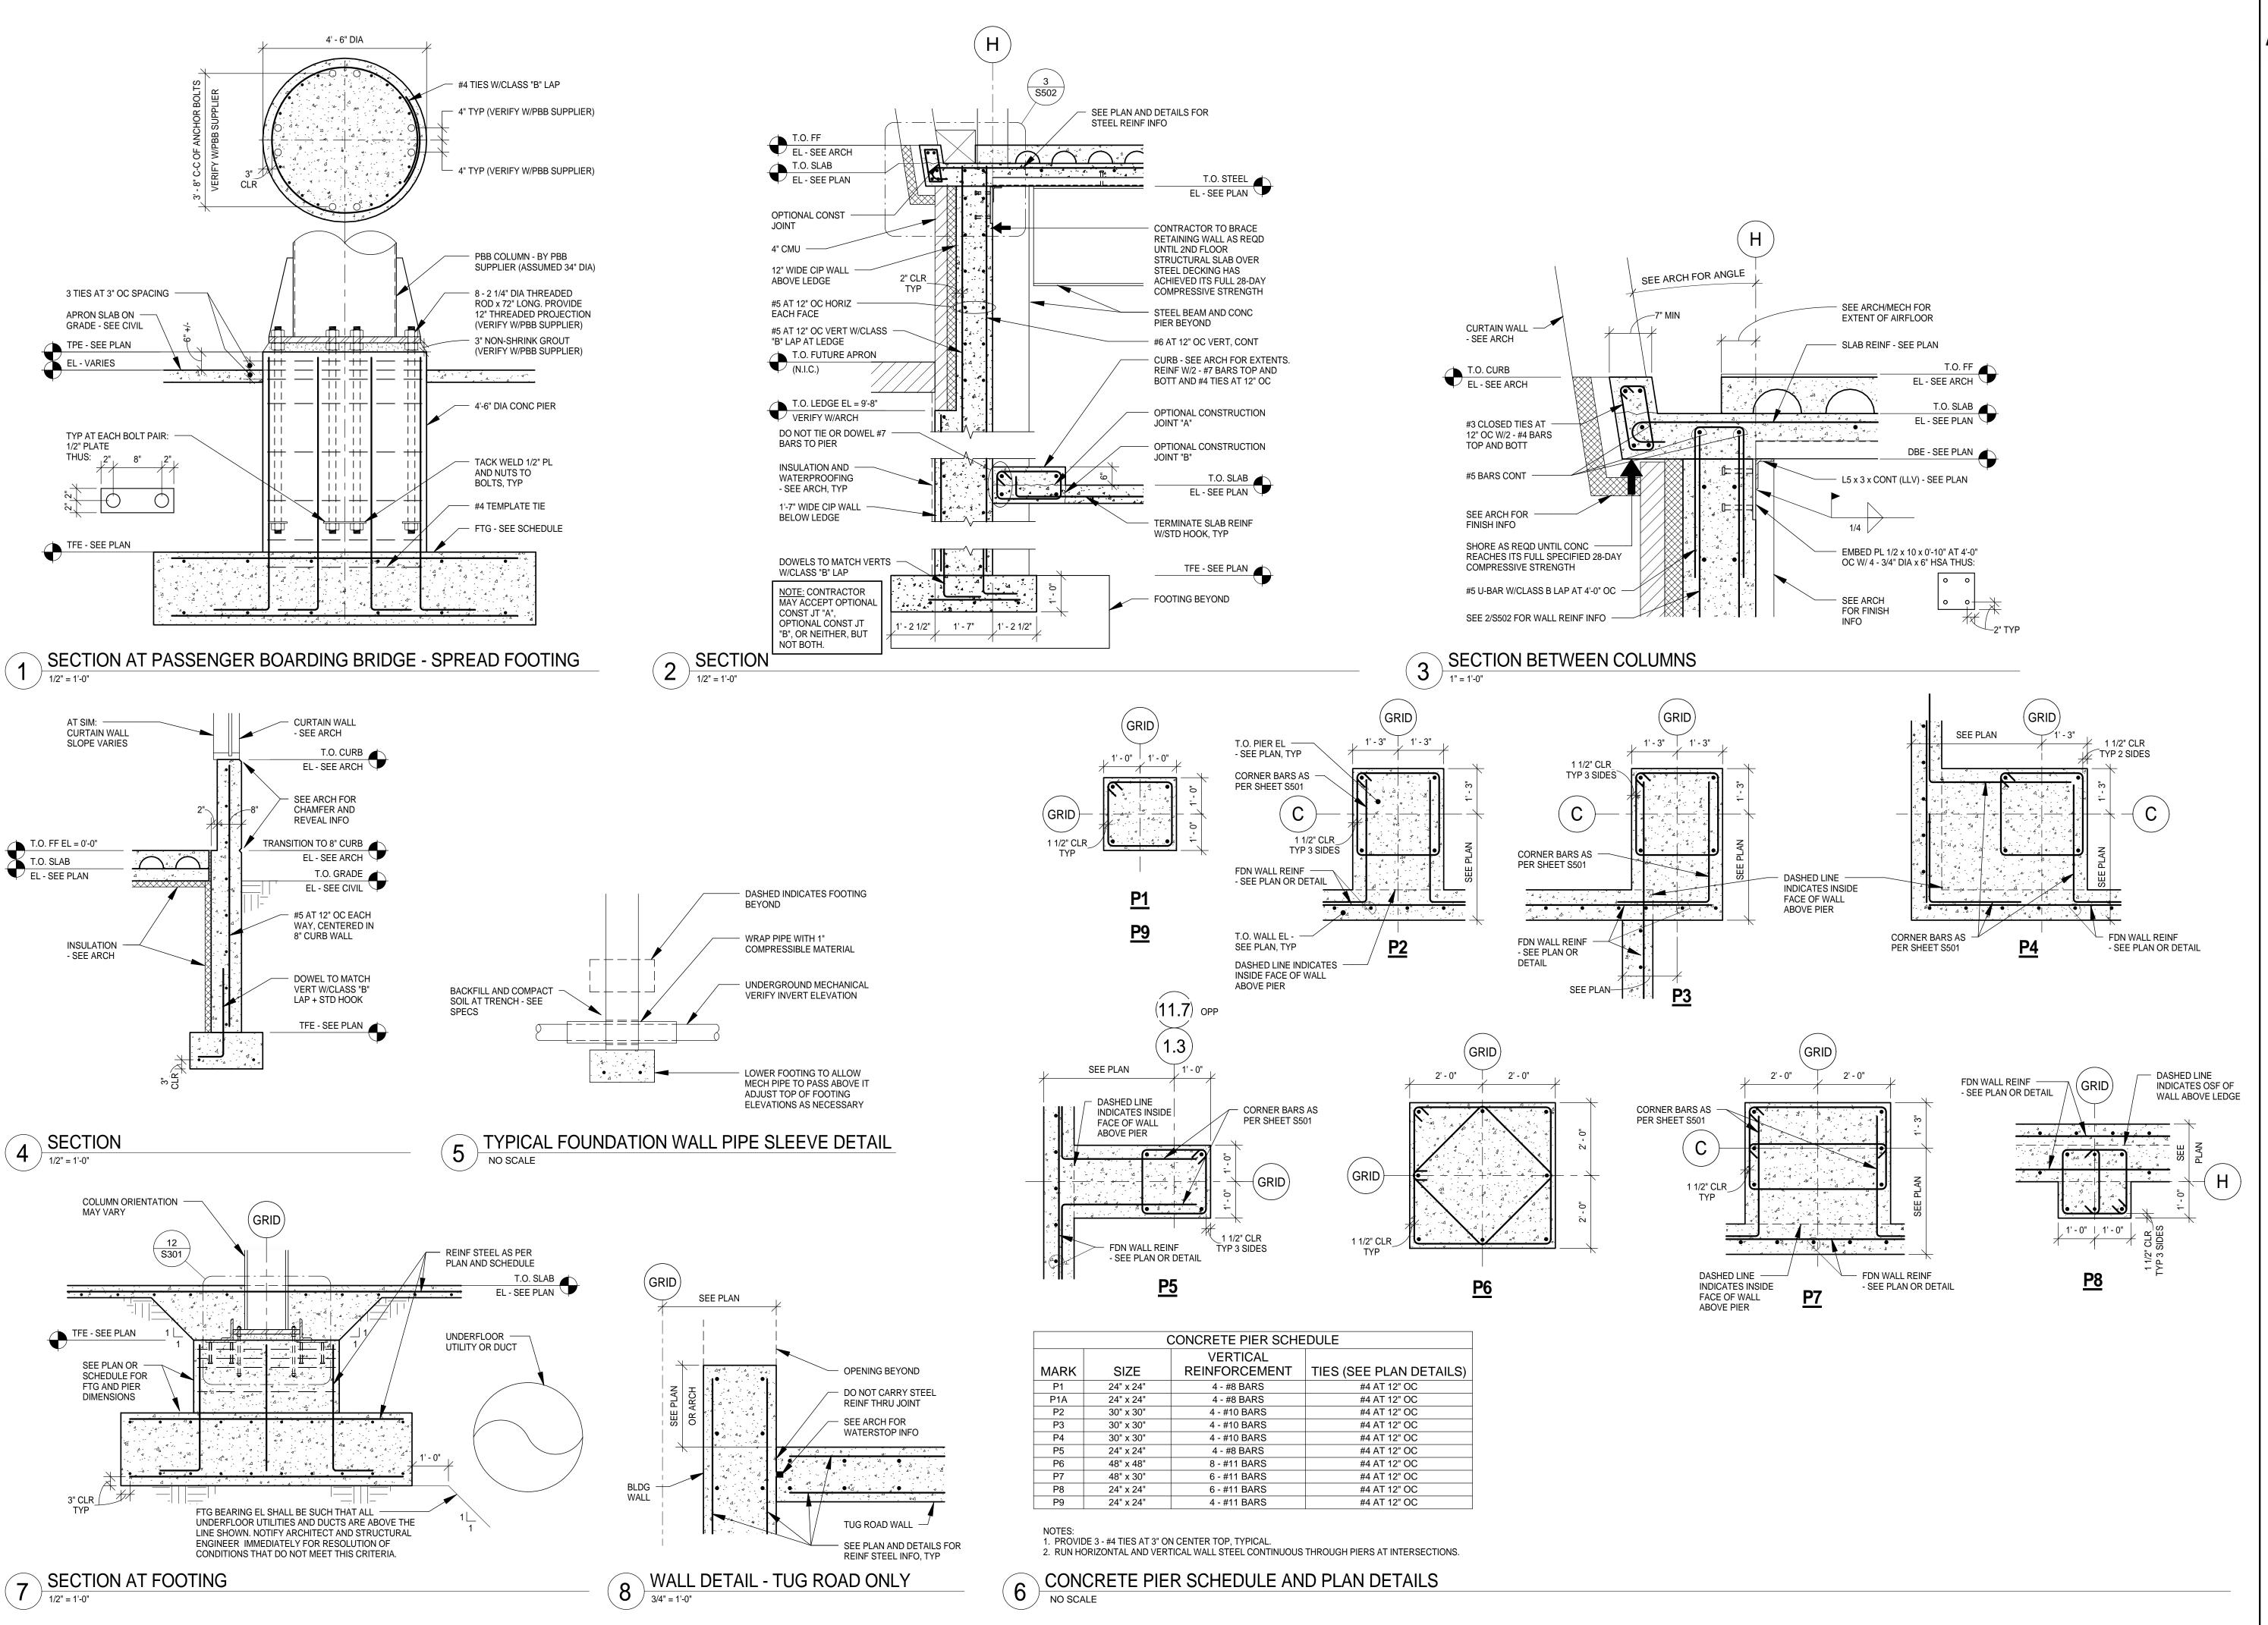

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Print Name: Paul A. Johnson

laws of the State of Minnesota.

Date: June 3, 2010 Reg. No.: 20379

REVISIONS

Signature:

	1010110	
NO.	DESCRIPTION	DATE
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	FOUNDATION PERMIT	6.4.10
1,2,3	NOT CHANGED	
	CONFORMANCE SET	7.12.10
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**DATE ISSUED:** 08-23-11 **REVIEWED BY:** PAJ / CWB DRAWN BY: SJL **DESIGNED BY:** CWB

AEP PROJECT NUMBER 213-1882-091

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SHEET TITLE

**STRUCTURAL DETAILS** 

> **SHEET NUMBER S502**

		CMU	J WALL REINFOR		
		CENTERED IN WALL		_L	
MARK	WALL TYPE	FOOTING DOWELS	HORIZONTAL	VERTICAL	COMMENTS
W1	8" CMU	#5 AT 24" OC	AS NOTED ON DETAILS	#5 AT 24" OC	CMU BOND BEAM LINTELS OVER ELEVATOR DOOR OPENINGS TO EXTEND AROUND ALL 4 SIDES OF ELEVATOR CORES TO PROVIDE ATTACHMENT POINT FOR ELEVATOR GUIDE RAIL SUPPORTS

<u>UNLESS NOTED OTHERWISE:</u>
1. PROVIDE CLASS "A" SPLICE TO DOWELS TYPICAL.

2. FOR ALL CMU WALLS NOT INDICATED ON STRUCTURAL PLANS, SEE "NON-LOAD BEARING MASONRY PARTITION WALL REINFORCING SCHEDULE". 3. SEE LINTEL SCHEDULE THIS SHEET FOR LINTELS OVER MASONRY WALL OPENINGS.

## WALL REINFORCING SCHEDULE / NO SCALE


	CMU LINTEL SCHEDULE					
WALL TYPE	ROUGH OPENING	REQUIRED LINTEL	BEARING LENGTH EACH END			
6" CMU	UP TO 3'-4"	8" DEEP BOND BM W/1 - #5 CONT BOTT	8"			
6" CMU	3'-4" TO 8'-0"	16" DEEP BOND BM W/1 - #5 CONT TOP AND BOTT	16"			
8" CMU	UP TO 5'-4"	8" DEEP BOND BM W/2 - #5 CONT BOTT	8"			
8" CMU	5'-4" TO 10'-0"	16" DEEP BOND BM W/2 - #5 CONT TOP AND BOTT AND #4 SINGLE LEG HOOKED STIRRUP AT 8" OC	16"			

NOTES:

1. REFER TO ARCHITECTURAL DRAWINGS FOR ALL ROUGH OPENING SIZES AND ELEVATIONS. 2. USE LINTEL BLOCKS FOR ALL CMU LINTELS. 3. PROVIDE 8" DEEP BOND BM W/2 - #5 CONT BOTTOM AT ALL SILLS.


4. ALL LINTEL REINFORCING TO EXTEND 1'-4" MINIMUM BEYOND EDGES OF ROUGH OPENING.

## LINTEL SCHEDULE $^{/}$ NO SCALE

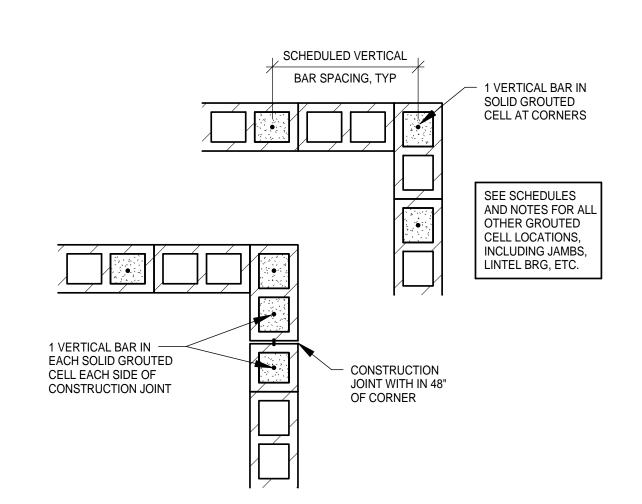

## TYPICAL VERTICAL REINFORCING AT MASONRY CORNER DETAIL

NO SCALE

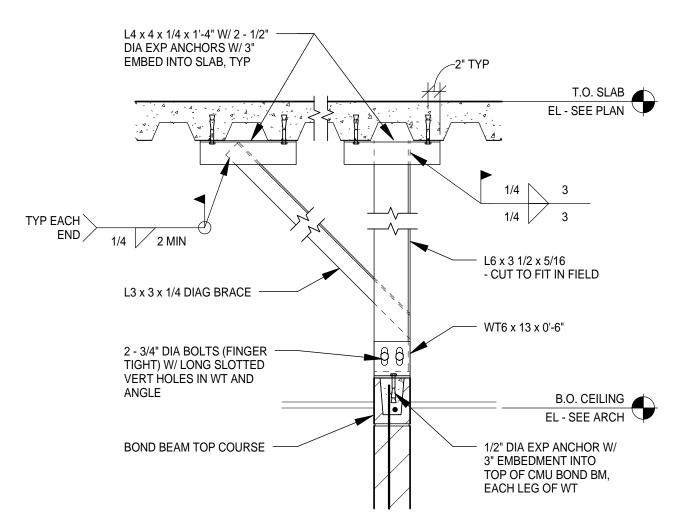

FLOOR DECK PARALLEL TO WALL

MASONRY	LAP SPLICE SCHEDULE
BAR SIZE	8" CMU (1 BAR IN CENTER)
DAR SIZE	f'c = 2,000 PSI
#4	24"
#5	30"
#6	36"


NOTES:


1. ALL BARS TO BE IN FULLY GROUTED CELLS OR BOND BEAMS

2. Fy = 60 KSI (Fs = 24 KSI MAX) 3. BAR LAP LENGTHS PER IBC 2006 SECTION 2107.5 AND ACI 530 EQ 2-9

4. SEE SHEET S501 FOR CONCRETE REINFORCING LAP SCHEDULE.



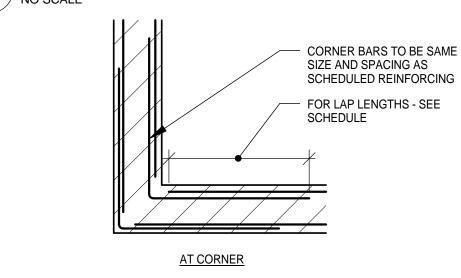


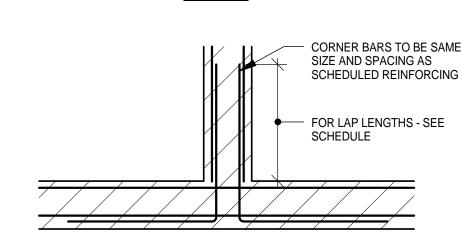

**AT INTERSECTION** NOTE: VERTICAL REINFORCING OMITTED FOR CLARITY

## TYPICAL HORIZONTAL REINFORCING AT MASONRY CORNER

NO SCALE

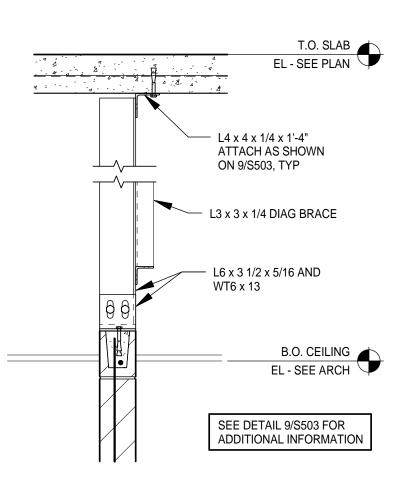

FLOOR DECK PERPENDICULAR TO WALL

NON-LOAD BEARING MASONRY PARTITION WALL REINFORCING SCHEDULE				
WALL TYPE				
6" CMU UP TO 13'-0"	#4 AT 4'-0" OC, CENTERED	BOND BM AT 5'-4" OC W/1 - #5 CONT, CENTERED		
8" CMU UP TO 13'-0"	#5 AT 5'-4" OC, CENTERED	BOND BM AT TOP OF WALL AND ABOVE ALL OPNGS, EACH W/2 - #5 CONT		
8" CMU CANTL TO 5'-4" MAX	#5 AT 2'-8" OC, CENTERED	BOND BM AT TOP OF WALL W/2 - #5 CONT		

NOTES:


1. REFER TO TYPICAL DETAILS FOR DOWELS AT BOTTOM OF CMU WALLS AND BRACING AT TO THE REPORT OF THE PROPERTY OF THE PROP TOP OF CMU WALLS. TOP OF WALL BRACING TO BE PLACED AT 10'-0" OC MAX SPACING WHERE DISTANCE BETWEEN WALL CORNERS EXCEEDS 12'-0". CONTRACTOR MAY USE ONE OF THE BRACING OPTIONS PROVIDED OR COORDINATE ALTERNATE BRACING WITH A/E. 2. GROUT CMU SOLID AT HANDRAIL, GUARDRAIL AND OTHER SUPPORTS. REFER TO


ARCHITECTURAL DRAWINGS FOR LOCATION AND ADDITIONAL GROUTING REQUIREMENTS. 3. PROVIDE (1) ADDITIONAL VERTICAL BAR MATCHING SCHEDULED REINFORCING IN FULLY GROUTED CELL AT CORNERS AND WITHIN 8" OF ALL OPENINGS.


ROOF DECK PERPENDICULAR TO WALL

4. REFER TO 3/S503 FOR MASONRY LINTEL SCHEDULE.

**ROOF DECK** 

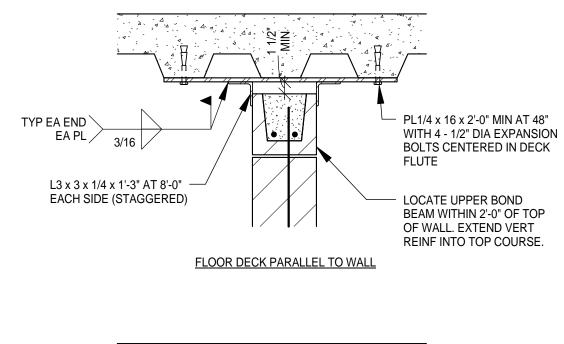

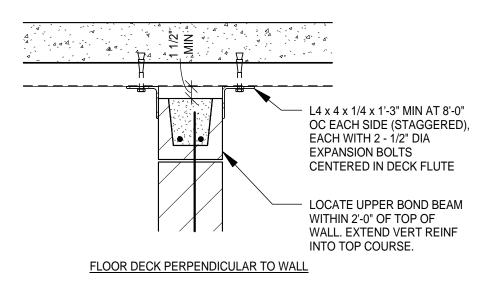

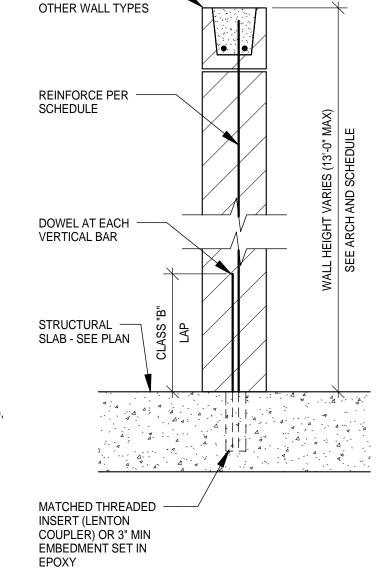

SEE ARCH DETAILS — FOR TRANSITION TO

## NON-LOAD BEARING WALL REINFORCING SCHEDULE AND TYPICAL DETAILS NO SCALE

- L6 x 4 x 1/4 x 2'-0" LLV AT

LOCATE UPPER BOND BM


WALL. EXTEND VERT REINF

WITHIN 2'-0" OF TOP OF


INTO TOP COURSE.

8'-0" OC EACH SIDE


(STAGGERED)

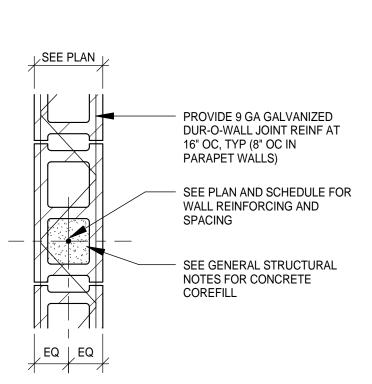



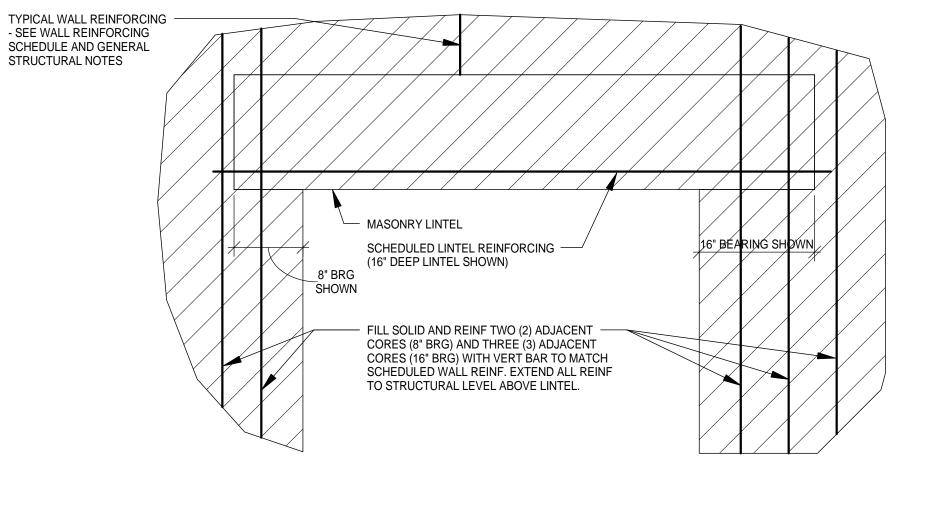


TYPICAL CMU LINTEL BEARING DETAIL

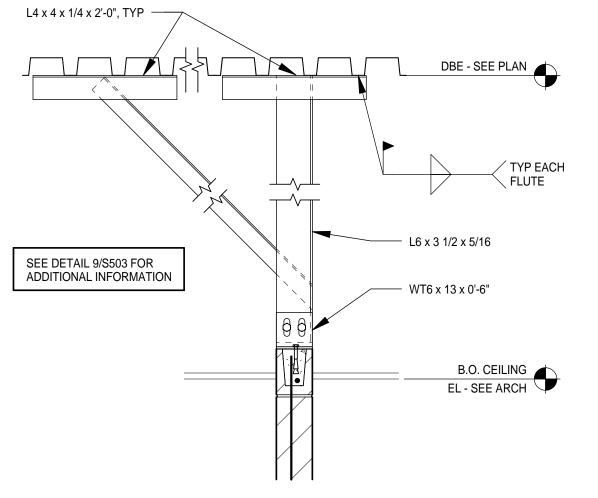

ROOF DECK PARALLEL TO WALL

3/4" = 1'-0"

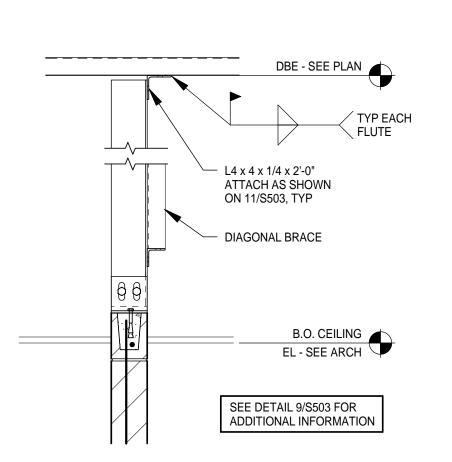

ROOF DECK PERPENDICULAR TO WALL

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Print Name: Paul A. Johnson

Signature:

Date: June 3, 2010 Reg. No.: 20379

REVISIONS DATE DESCRIPTION BID PACKAGE 1 5.12.10 FOUNDATION PERMIT 6.4.10 1,2,3 NOT CHANGED CONFORMANCE SET 7.12.10 **BUILDING PERMIT** 8.6.10 100% REVIEW 12.15.10 01.24.11 BID PACKAGE 2A BP 2A CONFORMANCE 05.02.11


**DATE ISSUED:** 08-23-11 **REVIEWED BY:** PAJ / CWB DRAWN BY: SJL **DESIGNED BY:** CWB AEP PROJECT NUMBER

213-1882-091 (C) 2009 REYNOLDS, SMITH AND HILLS INC

SHEET TITLE **STRUCTURAL DETAILS** 


**S503** 


**SHEET NUMBER** 

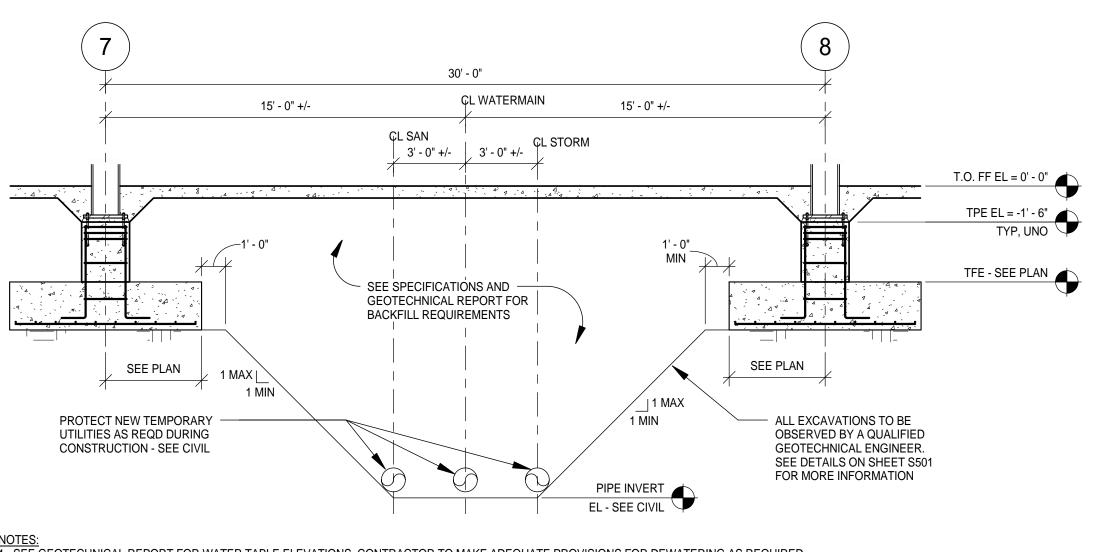

1. SEE GEOTECHNICAL REPORT FOR WATER TABLE ELEVATIONS. CONTRACTOR TO MAKE ADEQUATE PROVISIONS FOR DEWATERING AS REQUIRED.


2. PIPE INVERT LOCATION SHOWN SCHEMATICALLY REPRESENT LOCATIONS AT GRID E. 3. CONTRACTOR TO NOTIFY A/E IMMEDIATELY IF ACTUAL FIELD CONDITIONS VARY FROM LOCATIONS/SLOPES INDICATED.

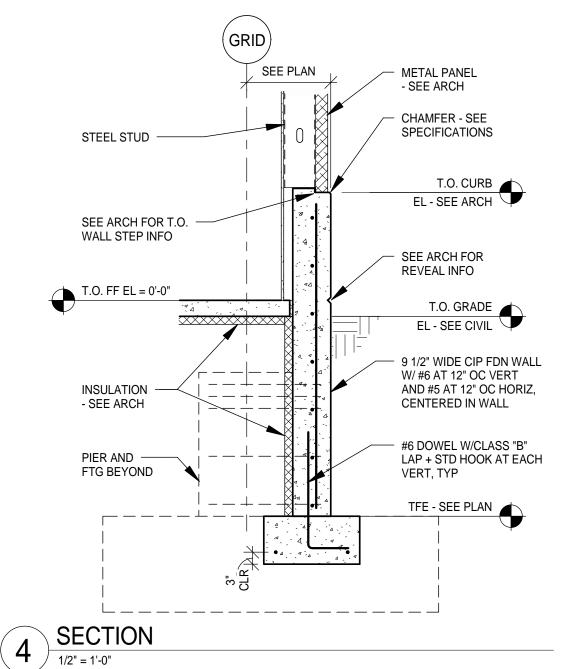

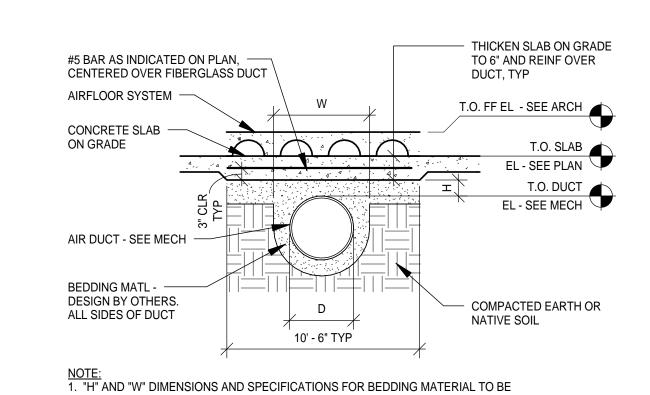



UNDERGROUND DUCTWORK DETAIL 1/2" = 1'-0"

VERIFIED WITH UNDERGROUND DUCT SUPPLIER PRIOR TO CONSTRUCTION.

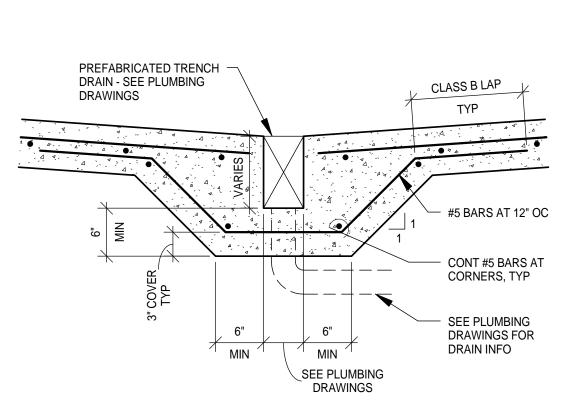


8 SECTION AT TRENCH DRAIN

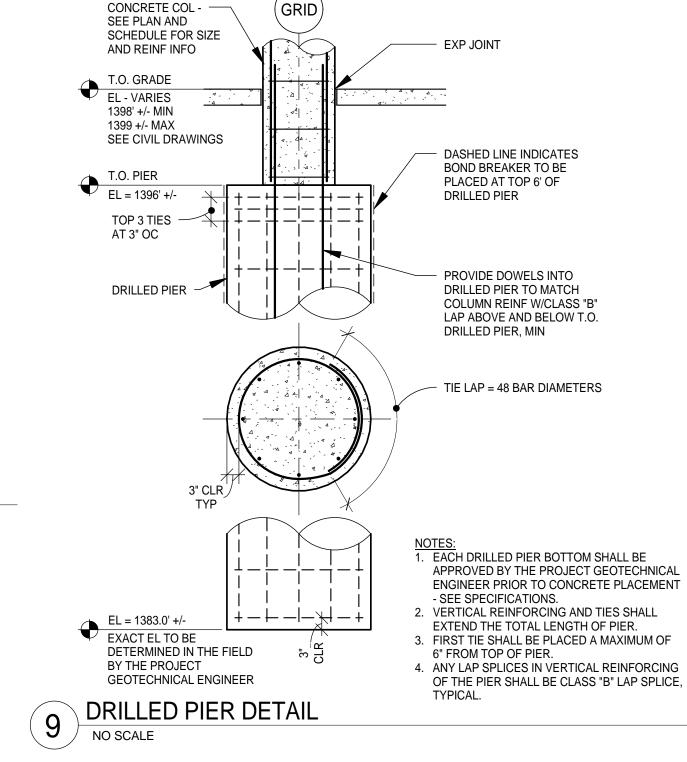

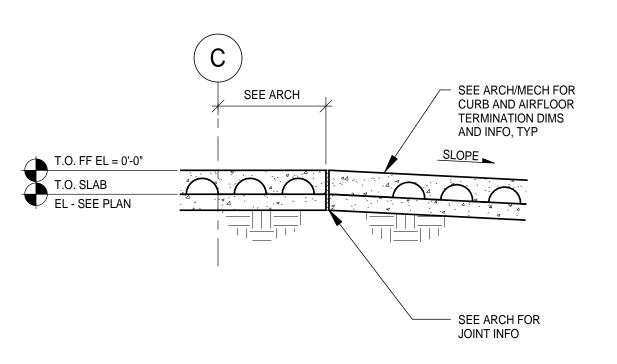



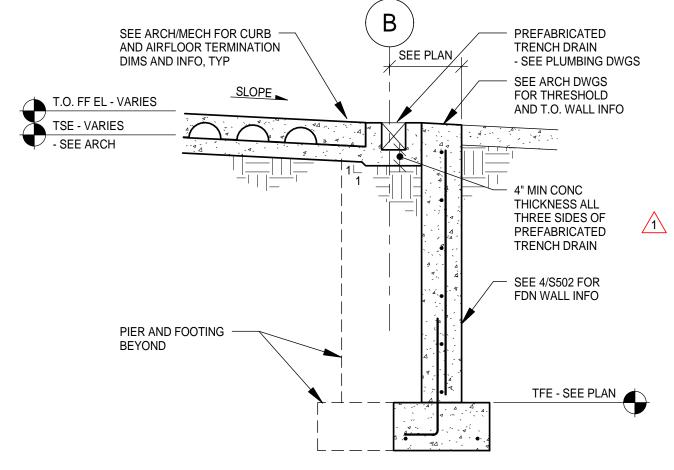

SEE PLAN

SEE 3/S502 FOR

SEE 2/S502 FOR

WALL REINF INFO

TYP TOP AND

BOTTOM

**CURB REINF INFO** 

SEE PLAN AND 4/S702

FOR STEEL REINF INFO

SECTION AT VESTIBULE DOOR

THICKEN SLAB AT ----

GATE DOOR TO MATCH

T.O. AIRFLOOR EL

(VERIFY W/ARCH)

EL - SEE ARCH

T.O. WALL
EL - SEE PLAN


 $7)\frac{3EC1}{1/2" = 1'-0"}$ 


SEE ARCH FOR FINISH INFO


CONTRACTOR TO SHORE SLAB OVERHANG UNTIL CONC REACHES ITS FULL 28-DAY

SECTION AT GATE DOOR SLAB

SPECIFIED COMPRESSIVE STRENGTH

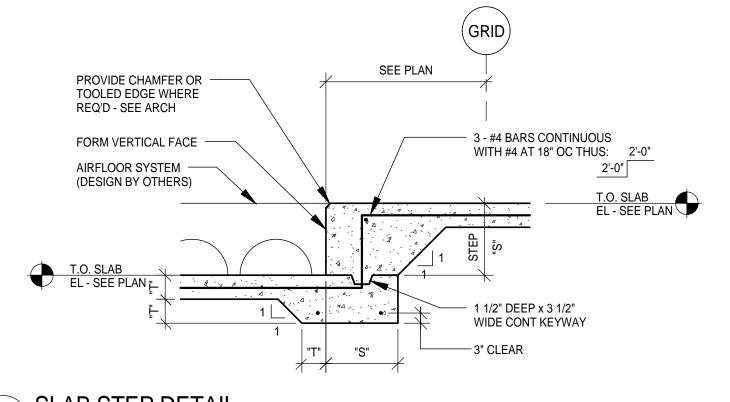

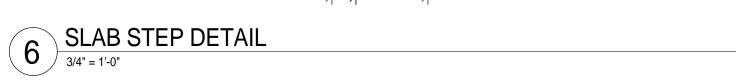

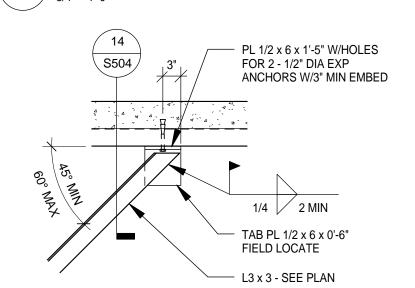



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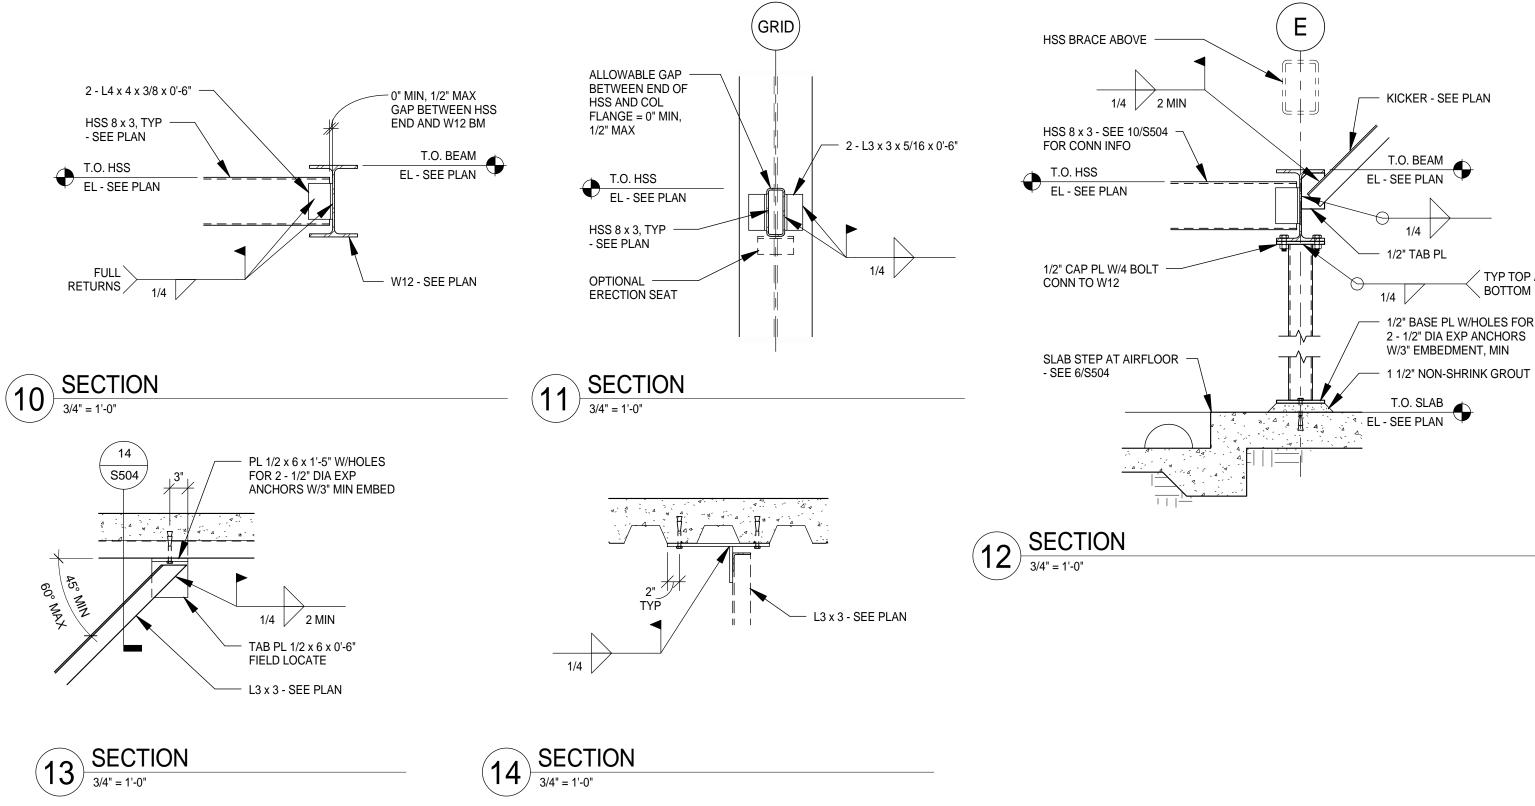
RE\		
NO.	DESCRIPTION	DATE
	BID PACKAGE 1	5.12.10
	FOUNDATION PERMIT	6.4.10
1	ADDENDUM 1	6.11.10
2,3	NOT CHANGED	
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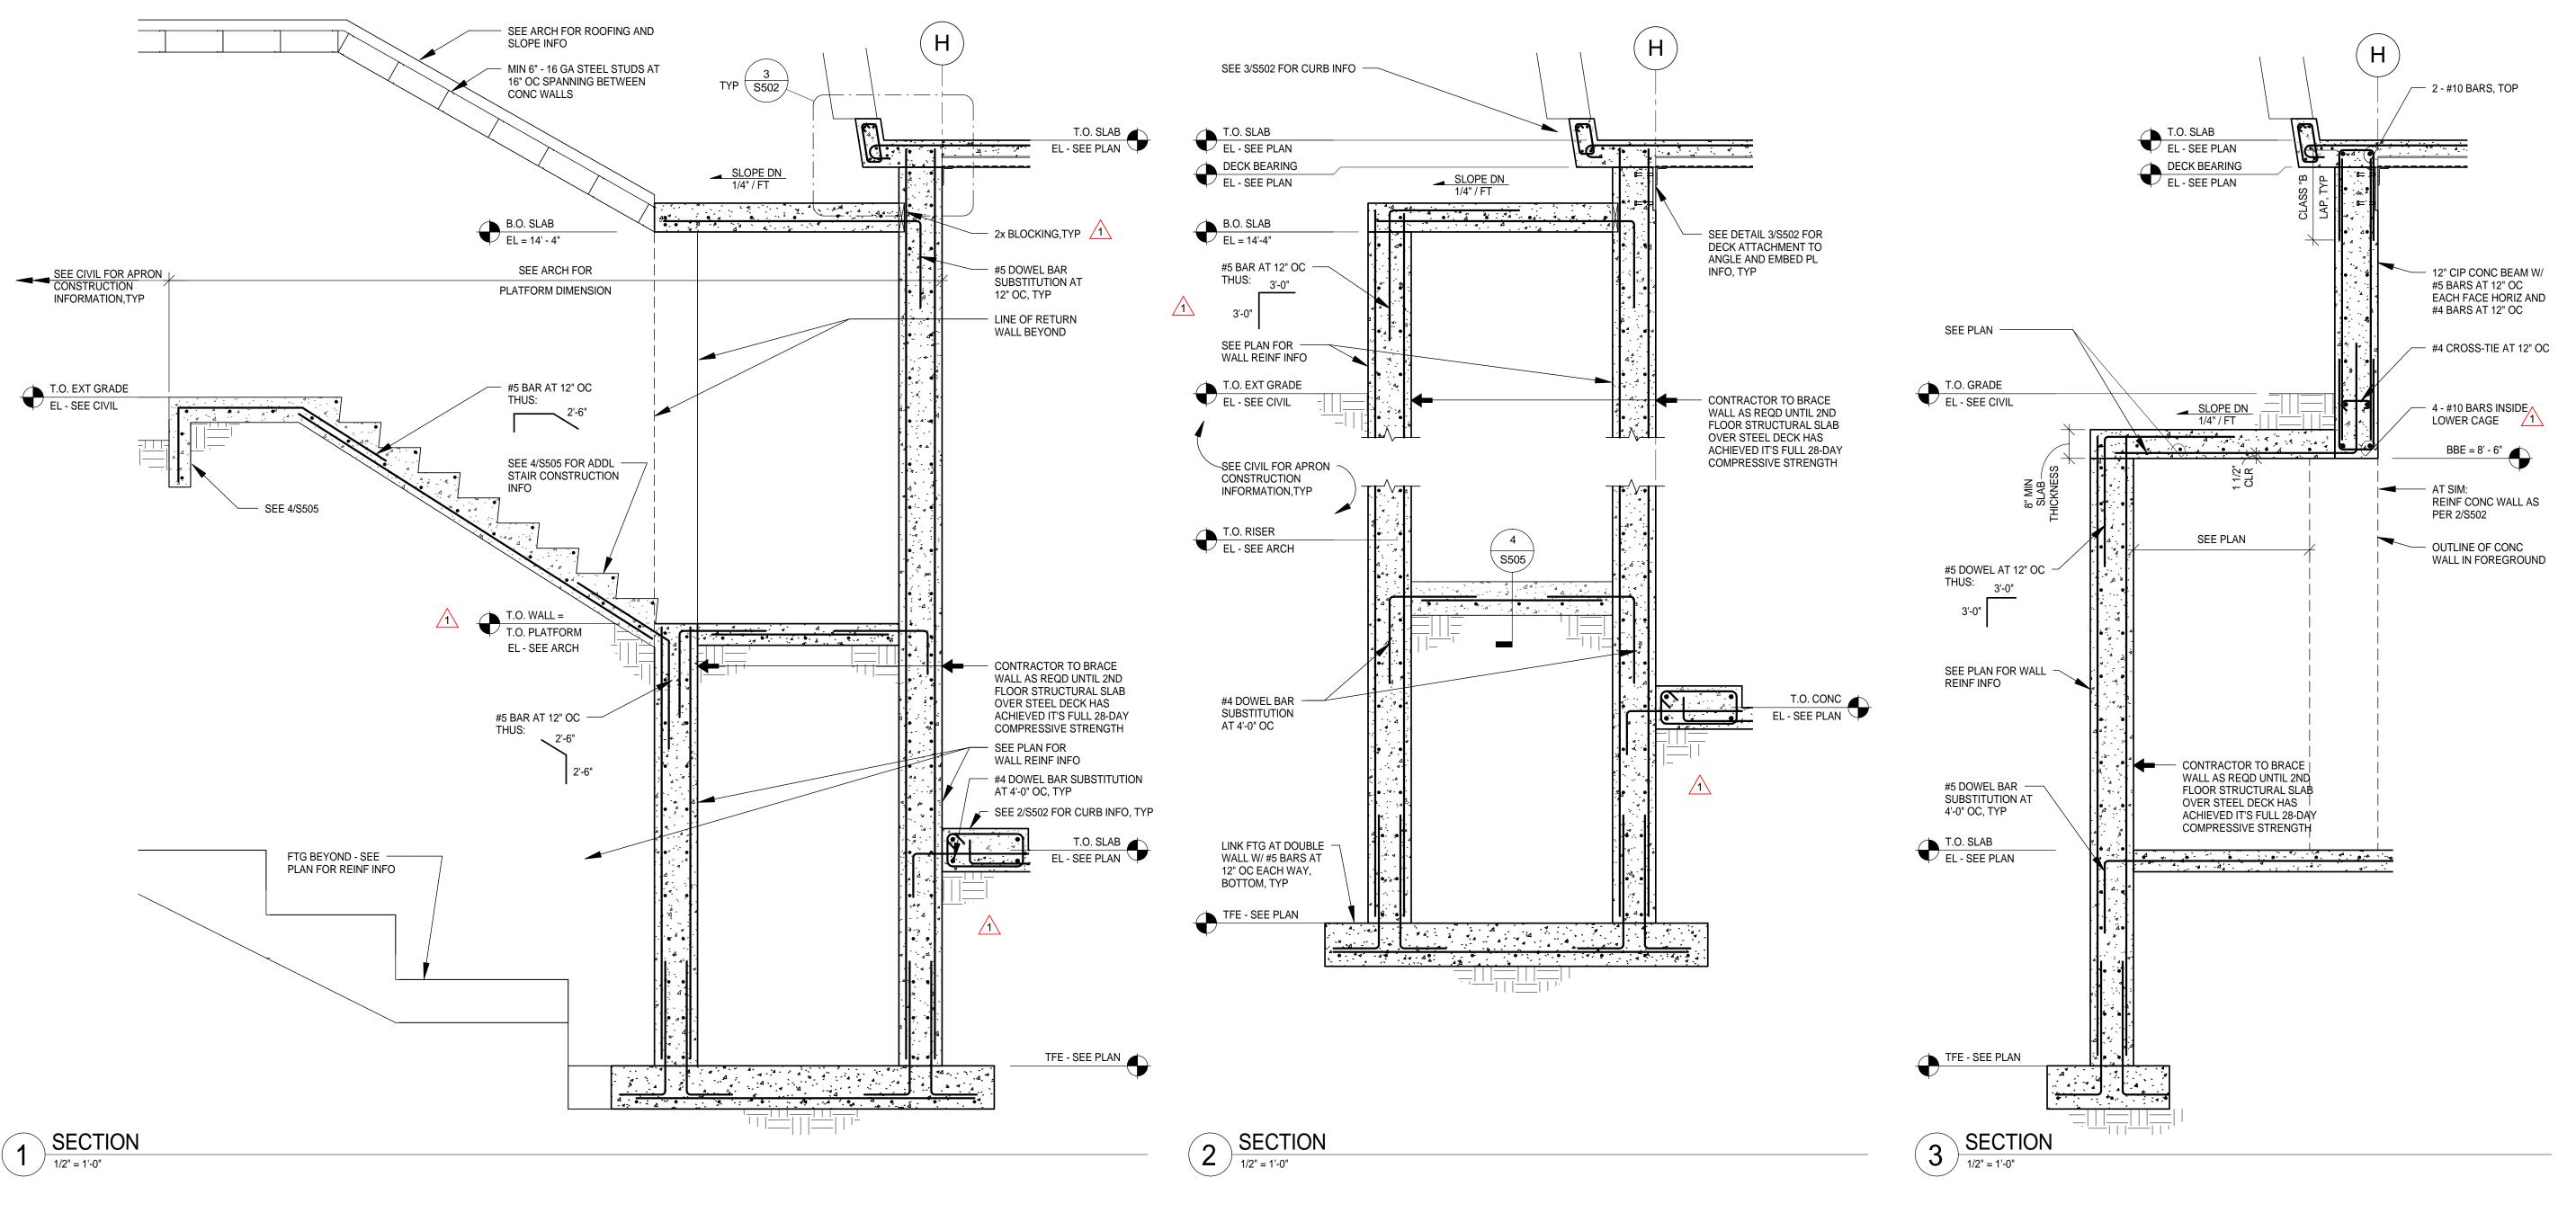
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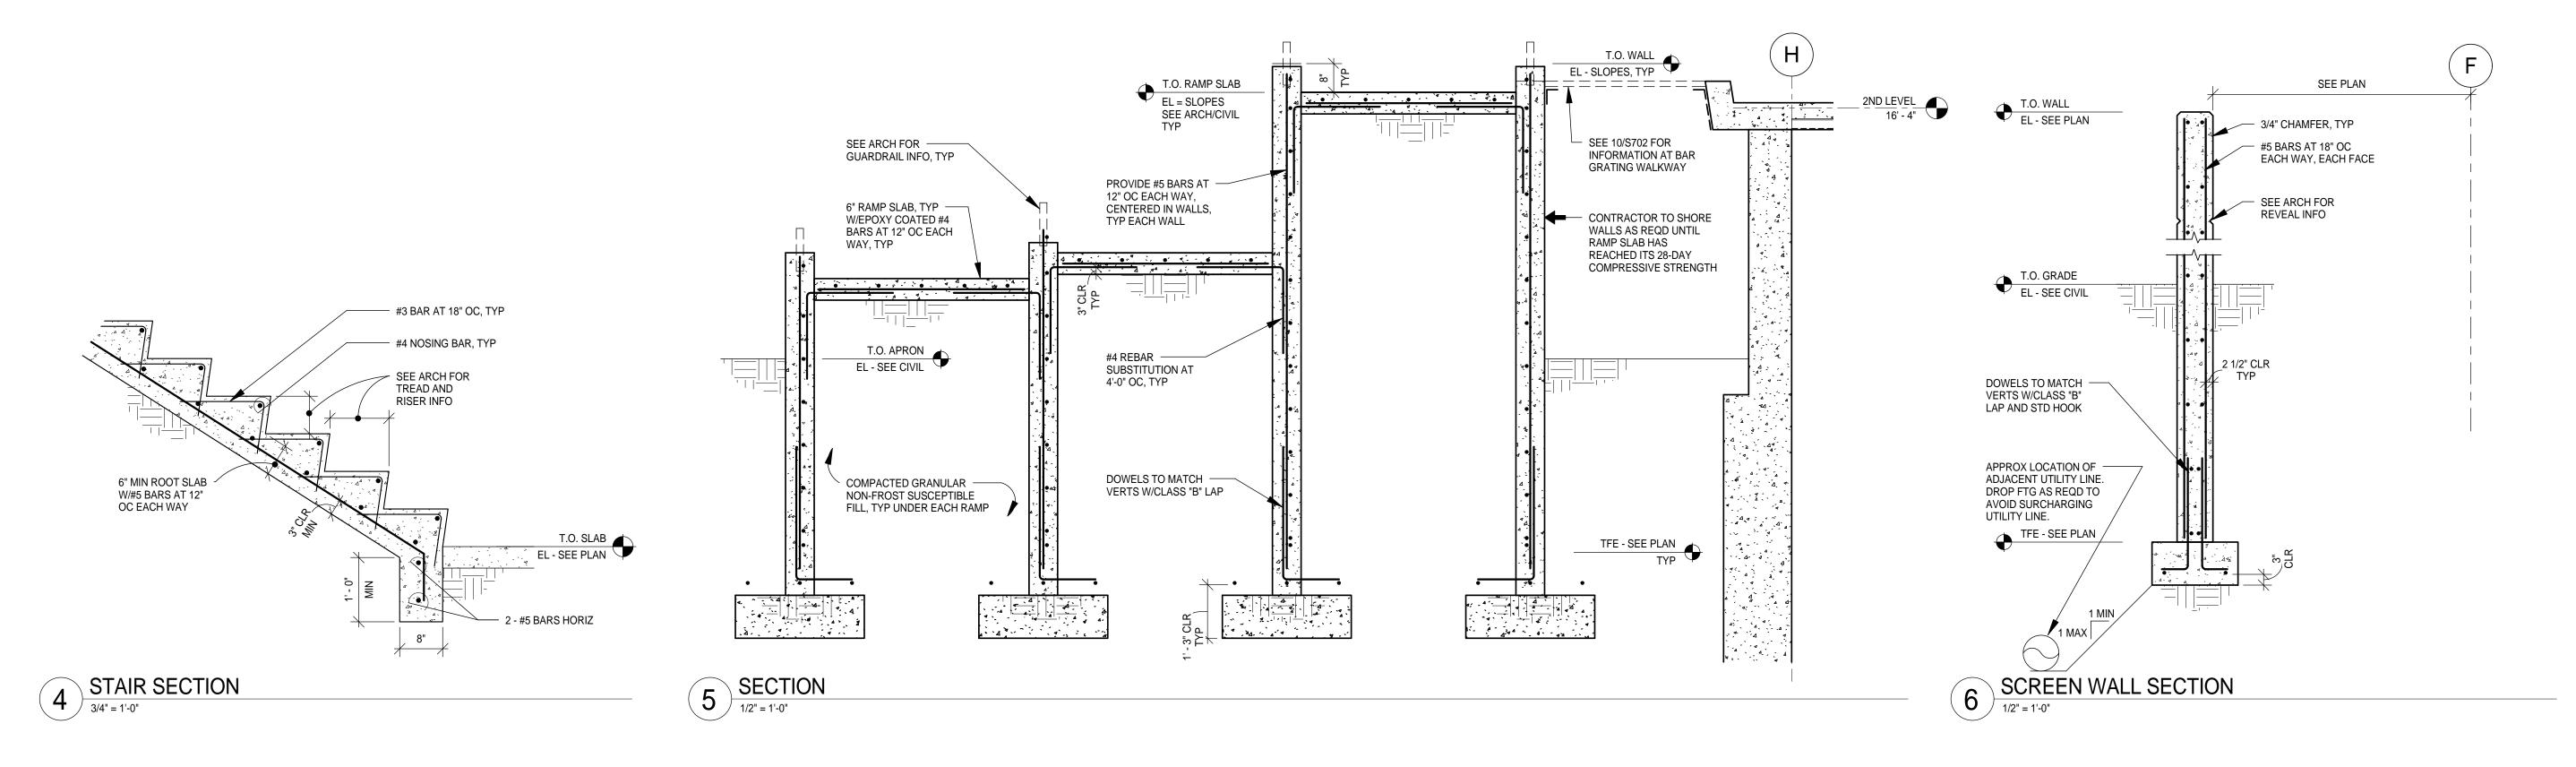
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**STRUCTURAL DETAILS** 

> **SHEET NUMBER S504**







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Baggage Handling Systems Consultants: **BNP ASSOCIATES INC.**101 East Ridge Office Park, Suite 103, Danbury CT 06810

Landscape Consultants:

APPOLD DESIGN

TEL: (203) 792-3000 / FAX: (203) 792-4900

2432 East First Street, Duluth MN 55812 TEL: (218) 591-5079

I hereby certify that this plan, specification, or report was prepared by me or under my direct supervision and that I am a duly licensed Professional Engineer under the

Print Name: Paul A. Johnson

laws of the State of Minnesota.

Signature:

Date: June 3, 2010 Reg. No.: 20379

**REVISIONS** DESCRIPTION DATE 5.12.10 **BID PACKAGE 1** FOUNDATION PERMIT 6.4.10 ADDENDUM 1 6.11.10 NOT CHANGED 7.12.10 CONFORMANCE SET BUILDING PERMIT 8.6.10 12.15.10 100% REVIEW

01.24.11

05.02.11

BID PACKAGE 2A

BP 2A CONFORMANCE

DATE ISSUED: 08-23-11

REVIEWED BY: PAJ / CWB

DRAWN BY: SJL

DESIGNED BY: CWB

AEP PROJECT NUMBER


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STRUCTURAL

DETAILS

SHEET NUMBER



/ 1/2" = 1'-0"

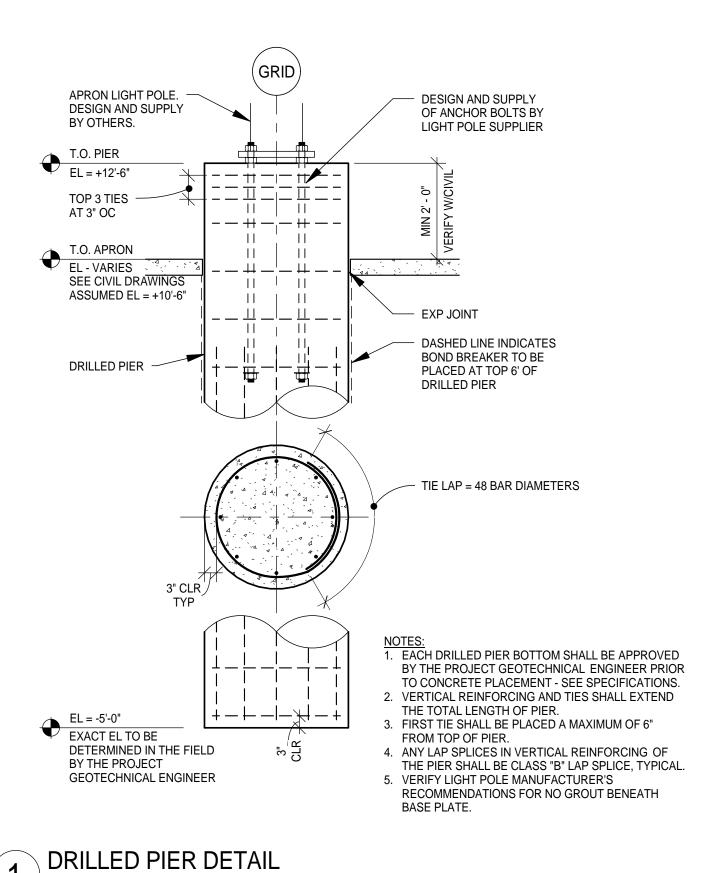CL OPNG.

4" MIN, 6" MAX
T.O. BM TO
T.O. PIPE

STIFFENER
RING x 0'-4"

SECTION

NOTES:

1. SEE PLAN FOR BEAM WEB OPENING LOCATION.

2. WELDING TO BE AS PER AWS D1.1. CARE IS TO BE TAKEN NOT TO DAMAGE PORTIONS OF BEAM TO REMAIN DURING CUTTING OF BEAM WEB.

2 STEEL BEAM WEB OPENING REINFORCING DETAIL NO SCALE





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DULUTH INTERNATIONAL AIRPORT DULUTH, MN

NEW TERMINAL DESIGN

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REVISIONS				
DESCRIPTION	DATE			
BP2A ADDENDUM 2	02.25.11			
BP 2A CONFORMANCE	05.02.11			
RFP	05.25.11			
	DESCRIPTION BP2A ADDENDUM 2 BP 2A CONFORMANCE			

DATE ISSUED: 08-23-11

REVIEWED BY: PAJ / CWB

DRAWN BY: SJL

DESIGNED BY: CWB

AEP PROJECT NUMBER


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SHEET NUMBER

S506



## 1 TYPICAL EMBED PLATE - DOUBLE ANGLE CONNECTION 3/4" = 1'-0"

	TYP	PICAL EMBED P	LATE SCHEDULE	
MARK	STEEL	STUD ROWS	PLATE LENGTH	MIN ANGLE LENGTH
	BEAM SIZE	"N"	"H"	"L"
EP-1	W12, W14	3	13"	8 1/2"
EP-2	W16	4	18"	11 1/2"
EP-3	W33	8	38"	24"
EP-4	HSS 5 x 5	3	13"	NA
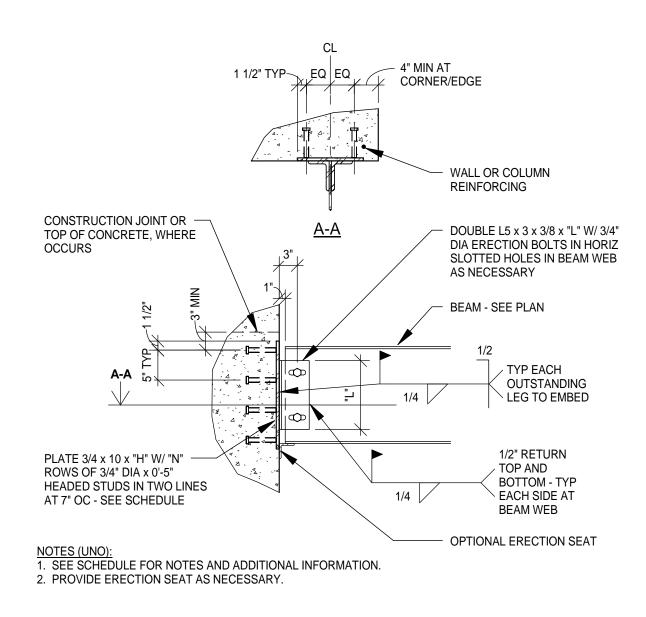
<u>NOTES (UNO):</u>
1. PROVIDE EMBED PLATES CORRESPONDING TO BEAM SIZES IN SCHEDULE, UNLESS NOTED

- OTHERWISE ON PLANS OR DETAILS. 2. PROVIDE HOLES AS NECESSARY FOR PLATE ATTACHMENT TO FORMWORK (5/16" DIA MAX). 3. COORDINATE CONCRETE REINFORCING BAR PLACEMENT WITH HEADED STUDS.
- 4. FIELD VERIFY EMBED PLATE PLACEMENT PRIOR TO BEAM ERECTION. 5. AT EP-4, PROVIDE 3" DIAMETER HOLE CENTERED ON HSS FOR CONDUIT ACCESS.


# TYPICAL EMBED PLATE SCHEDULE 1:1

			* *	24" MOE DECK	
				NOE DECK	
	MM.	MWIN			*
	2. 3PAN M				) _
			////	/ OREL	DSUPPORT ERIMETER POINT
*	2" MINLAP	////	// N	TERMEDIATE	JOINTER
*			// \	MORT DIATE	
UPPORT <		////	NIER	EOX	
EDGE SUMETE		\\ \frac{1}{2}	NOTERMEDIATE SUPPORT DIATE S	2 TYP	
EDGE SUPPORT AT PERIMETER OR EXP JT		END JOINT AT	X	•	
	T AP	SUPERMENTA			

DECK SUPPORT CONDITION	DECK ATTACHMENT
END SUPPORT	PUDDLE WELDS AT EACH LOW FLUTE
EDGE SUPPORT	PUDDLE WELDS AT 12" OC
INTERMEDIATE SUPPORT	PUDDLE WELDS AT EACH LOW FLUTE
END JOINT AT INT SUPPORT	PUDDLE WELDS AT EACH LOW FLUTE, EACH SIDE
SIDE LAP JOINT	#10 TEK SCREWS OR 1 1/2" SEAM WELD AT 36" OC MAX


- 1. ALL PUDDLE (ARC-SPOT) WELDS SHALL BE 5/8" DIAMETER. 2. PROVIDE DECK ATTACHMENTS AT SPACING SHOWN UNLESS NOTED OTHERWISE ON DRAWINGS
- 3. DECK SHEETS SHALL BE BUTTED AT END JOINTS. PROVIDE 2 1/2" MINIMUM BEARING. GAPS UP TO 1" ARE ACCEPTABLE AT BUTT JOINTS.
- 4. HEADED STUD INSTALLED THROUGH THE DECK MAY BE SUBSTITUTED FOR PUDDLE WELD.

## TYPICAL 3" COMPOSITE STEEL DECK ATTACHMENT DETAIL NO SCALE

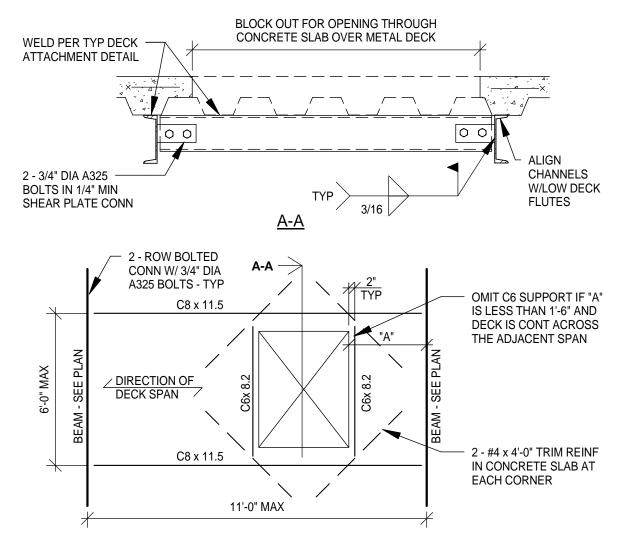

1. DO NOT CUT DECK AT OPENINGS UNTIL CONCRETE HAS ATTAINED ITS SPECIFIED COMPRESSIVE 2. VERIFY OPENING DIMENSIONS WITH ARCHITECTURAL DRAWINGS AND MECHANICAL TRADES.

TYPICAL FLOOR OPENING FRAME (OVER 32")

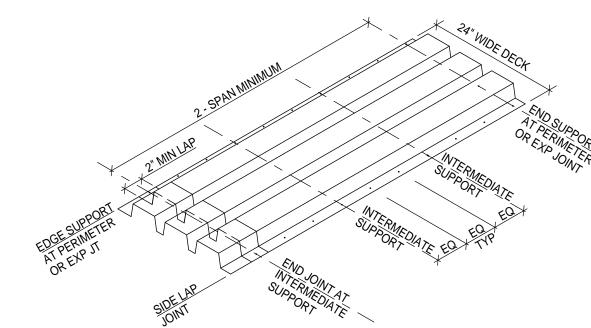


DECK SUPPORT CONDITION	DECK ATTACHMENT
END SUPPORT	PUDDLE WELDS AT EACH LOW FLUTE
EDGE SUPPORT	PUDDLE WELDS AT 12" OC
INTERMEDIATE SUPPORT	PUDDLE WELDS AT EACH LOW FLUTE
END LAP JOINT	PUDDLE WELDS AT EACH LOW FLUTE
SIDE LAP JOINT	#10 TEK SCREWS PER SPAN

NOTES (UNO):

1. ALL PUDDLE (ARC-SPOT) WELDS SHALL BE 5/8" DIAMETER. 2. PROVIDE DECK ATTACHMENTS AT SPACING SHOWN UNLESS NOTED OTHERWISE ON DRAWINGS. 3. AT END LAP CONDITIONS, PUDDLE WELDS SHALL PROVIDE FUSION THROUGH ALL DECK LAYERS.

## TYPICAL 3" STEEL ROOF DECK ATTACHMENT DETAIL NO SCALE

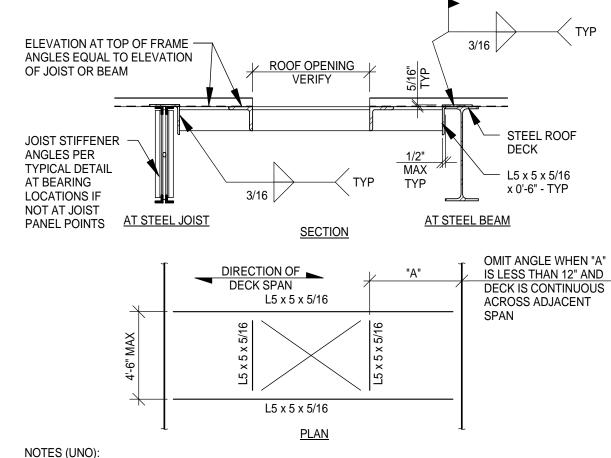

NOTES (UNO):


1. VERIFY OPENING SIZES AND LOCATIONS WITH MECHANICAL CONTRACTOR PRIOR TO FABRICATION. 2. WELD DECK AT OPENING AT EACH FLUTE WITH PUDDLE WELDS, PER THE TYP DECK ATTACHMENT DETAIL 3. DO NOT CUT OPENING IN DECK UNTIL NECESSARY, CONTRACTOR TO COORDINATE 4. THIS ROOF OPENING FRAME IS NOT DESIGNED TO SUPPORT THE WEIGHT OF ROOF TOP MECHANICAL EQUIPMENT WEIGHING OVER 400 LBS. EQUIPMENT SHALL BE SUPPORTED ON A STRUCTURAL CURB DESIGNED BY THE SUPPLIER TO SPAN TO THE PRIMARY STRUCTURAL FRAMING.

TYPICAL ROOF OPENING FRAME FOR 3" DECK (10) NO SCALE

	BEAM SHEAR CONNECTION SCHEDULE				
STEEL BEAM		SHEAR CONNECTION SUPPORTING DECK ONLY	DOUBLE SHEAR CONNECTION FOR BEAMS SUPPORTING OTHER BEAMS		
SIZE	MIN ROWS OF BOLTS	MIN DESIGN SERVICE CAPACITY (KIPS)	MIN ROWS OF BOLTS	MIN DESIGN SERVICE CAPACITY (KIPS)	
W8, W10	2	12	2	24	
W12	3	23	3	46	
W14	3	23	3	46	
W16	4	35	4	70	
W18	5	45	4	70	
W21	6	55	5	90	
W24	7	65	6	110	
W27	7	65	6	110	
W30	8	75	7	130	
W33	8	75	7	130	
W36	9	85	8	150	


NOTES:
1. CONTRACTOR/FABRICATOR SHALL DESIGN TYPICAL SHEAR CONNECTIONS FOR THIS PROJECT. CONNECTION TYPES SHALL CONFORM TO AISC STANDARD SHEAR CONNECTIONS. SUBMIT PROPOSED CONNECTION TYPES FOR APPROVAL BEFORE STARTING SHOP

- DRAWINGS. 2. PROVIDE BEAM CONNECTIONS FOR END REACTIONS INDICATED ABOVE OR AS SHOWN ON PLAN OR DETAIL, WHICHEVER IS GREATER. BEAM TO BEAM CONNECTIONS MAY BE SINGLE OR DOUBLE SHEAR, AS REQUIRED TO PROVIDE THE SPECIFIED CONNECTION CAPACITY WITHIN THE AVAILABLE CONNECTION GEOMETRY. ALL BEAM TO COLUMN CONNECTIONS SHALL BE DOUBLE SHEAR.
- 3. ALL BOLTS SHALL BE 3/4" DIAMETER A325-N OR 1" DIAMETER A490-N, UNLESS NOTED OTHERWISE. 4. SHOP CONNECTIONS MAY BE WELDED (WITH CAPACITY AS NOTED HEREIN) OR BOLTED.
- 5. VALUES SHOWN ASSUME 1/4" BEAM WEB THICKNESS, MINIMUM. 6. USE TWO ANGLE CONNECTION TO ALL BEAMS FRAMING INTO CONCRETE EMBED PLATES.
- BEAM SHEAR CONNECTION SCHEDULE

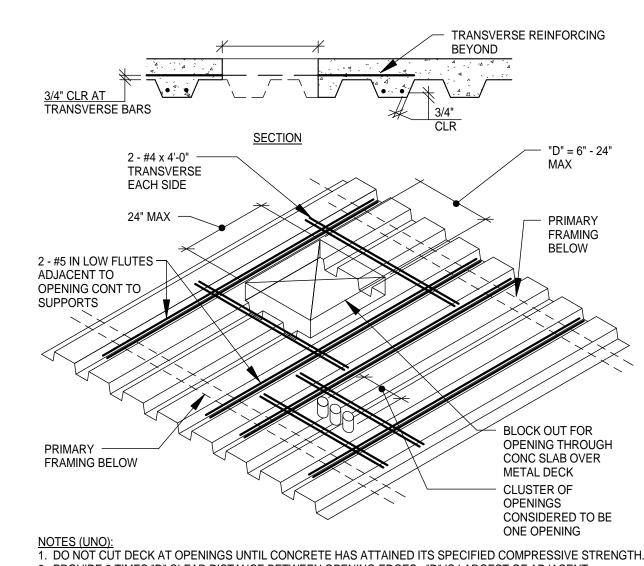

2. PROVIDE 2 TIMES "D" CLEAR DISTANCE BETWEEN OPENING EDGES. "D" IS LARGEST OF ADJACENT OPENING DIMENSIONS.

TYPICAL FRAMING AT FLOOR OPENINGS (6"-32" MAX) NO SCALE

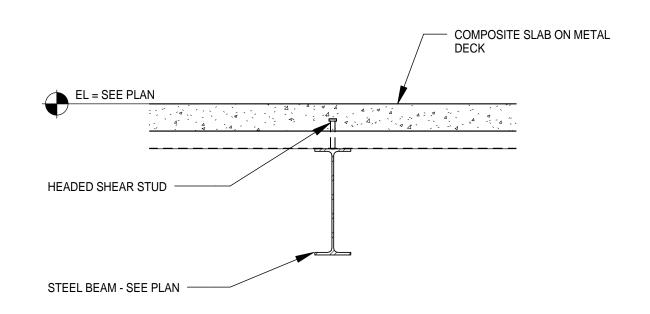

NOTES (UNO):

1. SEE TYPICAL DETAILS FOR DECK ATTACHMENT AND HEADED STUD INFORMATION.

TYPICAL SECTION AT COMPOSITE DECK PERPENDICULAR TO BEAM NO SCALE


	FLOOR AND ROOF DECK SCHEDULE					
		CONCRET	E TOPPING			
MARK	DECK TYPE	THICKNESS	REINFORCING	COMMENTS		
S1	3" - 19 GA COMPOSITE DECK	4 1/2" NORMAL WT	STRUX 90/40 SYNTHETIC FIBER	5.0 LBS/CU YD		
S2	3" - 19 GA COMPOSITE DECK	6 1/2" NORMAL WT	#5 AT 12" OC EACH WAY	1 1/2" TOP COVER		
S3	3" - 19 GA COMPOSITE DECK	6 1/2" NORMAL WT	STRUX 90/40 SYNTHETIC FIBER	5.0 LBS/CU YD		
S4	3" - 20 GA COMPOSITE DECK	3" NORMAL WT	STRUX 90/40 SYNTHETIC FIBER	5.0 LBS/CU YD		
D1	3" - 20 GA TYPE N ROOF DECK	NA	NA	NA		
D2	3 1/2" - 16 GA ROOF DECK OR 4 1/2" - 18 GA ROOF DECK	NA	NA	NA		
D3	1 1/2" - 20 GA TYPE N ROOF DECK	NA	NA	NA		
D4	3" - 20 GA TYPE N ROOF DECK	NA	NA	"GALVALUM" FINISH REFER TO ARCH		

NOTES (UNO):

1. SEE TYPICAL DETAILS FOR DECK ATTACHMENT DETAILS.

- 2. SEE GENERAL STRUCTURAL NOTES FOR CONCRETE STRENGTH. 3. CONCRETE TOPPING THICKNESS IS FROM TOP OF DECK TO TOP OF CONCRETE
- 4. SEE PLANS AND DETAILS FOR ADDITIONAL REINFORCING AND REINFORCING PLACEMENT AT CONCRETE
- SLABS ON METAL DECK. 5. SEE SPECIFICATIONS FOR SYNTHETIC FIBERS.
- 6. ALL COMPOSITE DECK IS GALVANIZED. REFER TO SPECIFICATIONS FOR ROOF DECK FINISH.



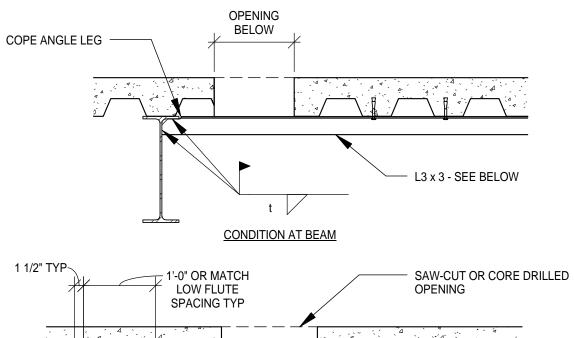

SAW-CUT OR CORE DRILLED "D" = 6"- 18" L3 x 3 x 3/16 EACH SIDE OF - 2 - 1/2" DIA WEDGE ANCHORS MAX OPENING ORIENTED EACH END OF ANGLE W/ 3 1/2" PERPENDICULAR TO DECK SPAN EMBED INTO CONCRETE - TYP

NOTES (UNO):


1. DO NOT OVER CUT CORNERS OF SQUARE OR RECTANGULAR OPENINGS.

2. CLUSTER OF OPENINGS CONSIDERED TO BE ONE OPENING. PROVIDE SUPPORT ANGLES IF OPENINGS

1. DO NOT OVER CUT CORNERS OF SQUARE OR RECTANGULAR OPENING. PROVIDE SUPPORT ANGLES IF OPENINGS. LOCATED WITH LESS THAN TWO TIMES "D" CLEAR BETWEEN OPENING EDGES. "D" IS LARGEST OF ADJACENT OPENING DIMENSIONS.

## TYPICAL OPENING (6"-24" MAX) THROUGH SLAB

OVER METAL DECK

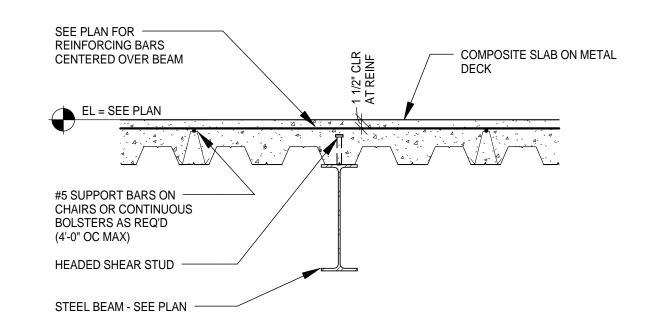

NOTES (UNO):

1. CUT HIGH DECK FLUTE WHEN IT OCCURS AT BEAM AND PROVIDE GIRDER FILLER DECK 2. SEE TYPICAL DETAILS FOR DECK ATTACHMENT AND HEADED STUD INFORMATION

TYPICAL SECTION AT COMPOSITE DECK PARALLEL TO BEAM NO SCALE



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> > TEL: (218) 591-5079

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Signature:

Date: June 3, 2010 Reg. No.: 20379

RE\	/ISIONS	
NO.	DESCRIPTION	DATE
	BID PACKAGE 1	5.12.10
	FOUNDATION PERMIT	6.4.10
1,2,3	NOT CHANGED	
	CONFORMANCE SET	7.12.10
	BUILDING PERMIT	8.6.10
5	100% REVIEW	12.15.10
	BID PACKAGE 2A	01.24.11
	BP 2A CONFORMANCE	05.02.11
	RFP 120	07 22 11

**DATE ISSUED:** 08-23-11 **REVIEWED BY:** PAJ / CWB DRAWN BY: SJL **DESIGNED BY:** CWB AEP PROJECT NUMBER 213-1882-091


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SHEET TITLE **STRUCTURAL DETAILS** 

> **SHEET NUMBER S701**

**BID PACKAGE 2B ISSUED FOR BID** 

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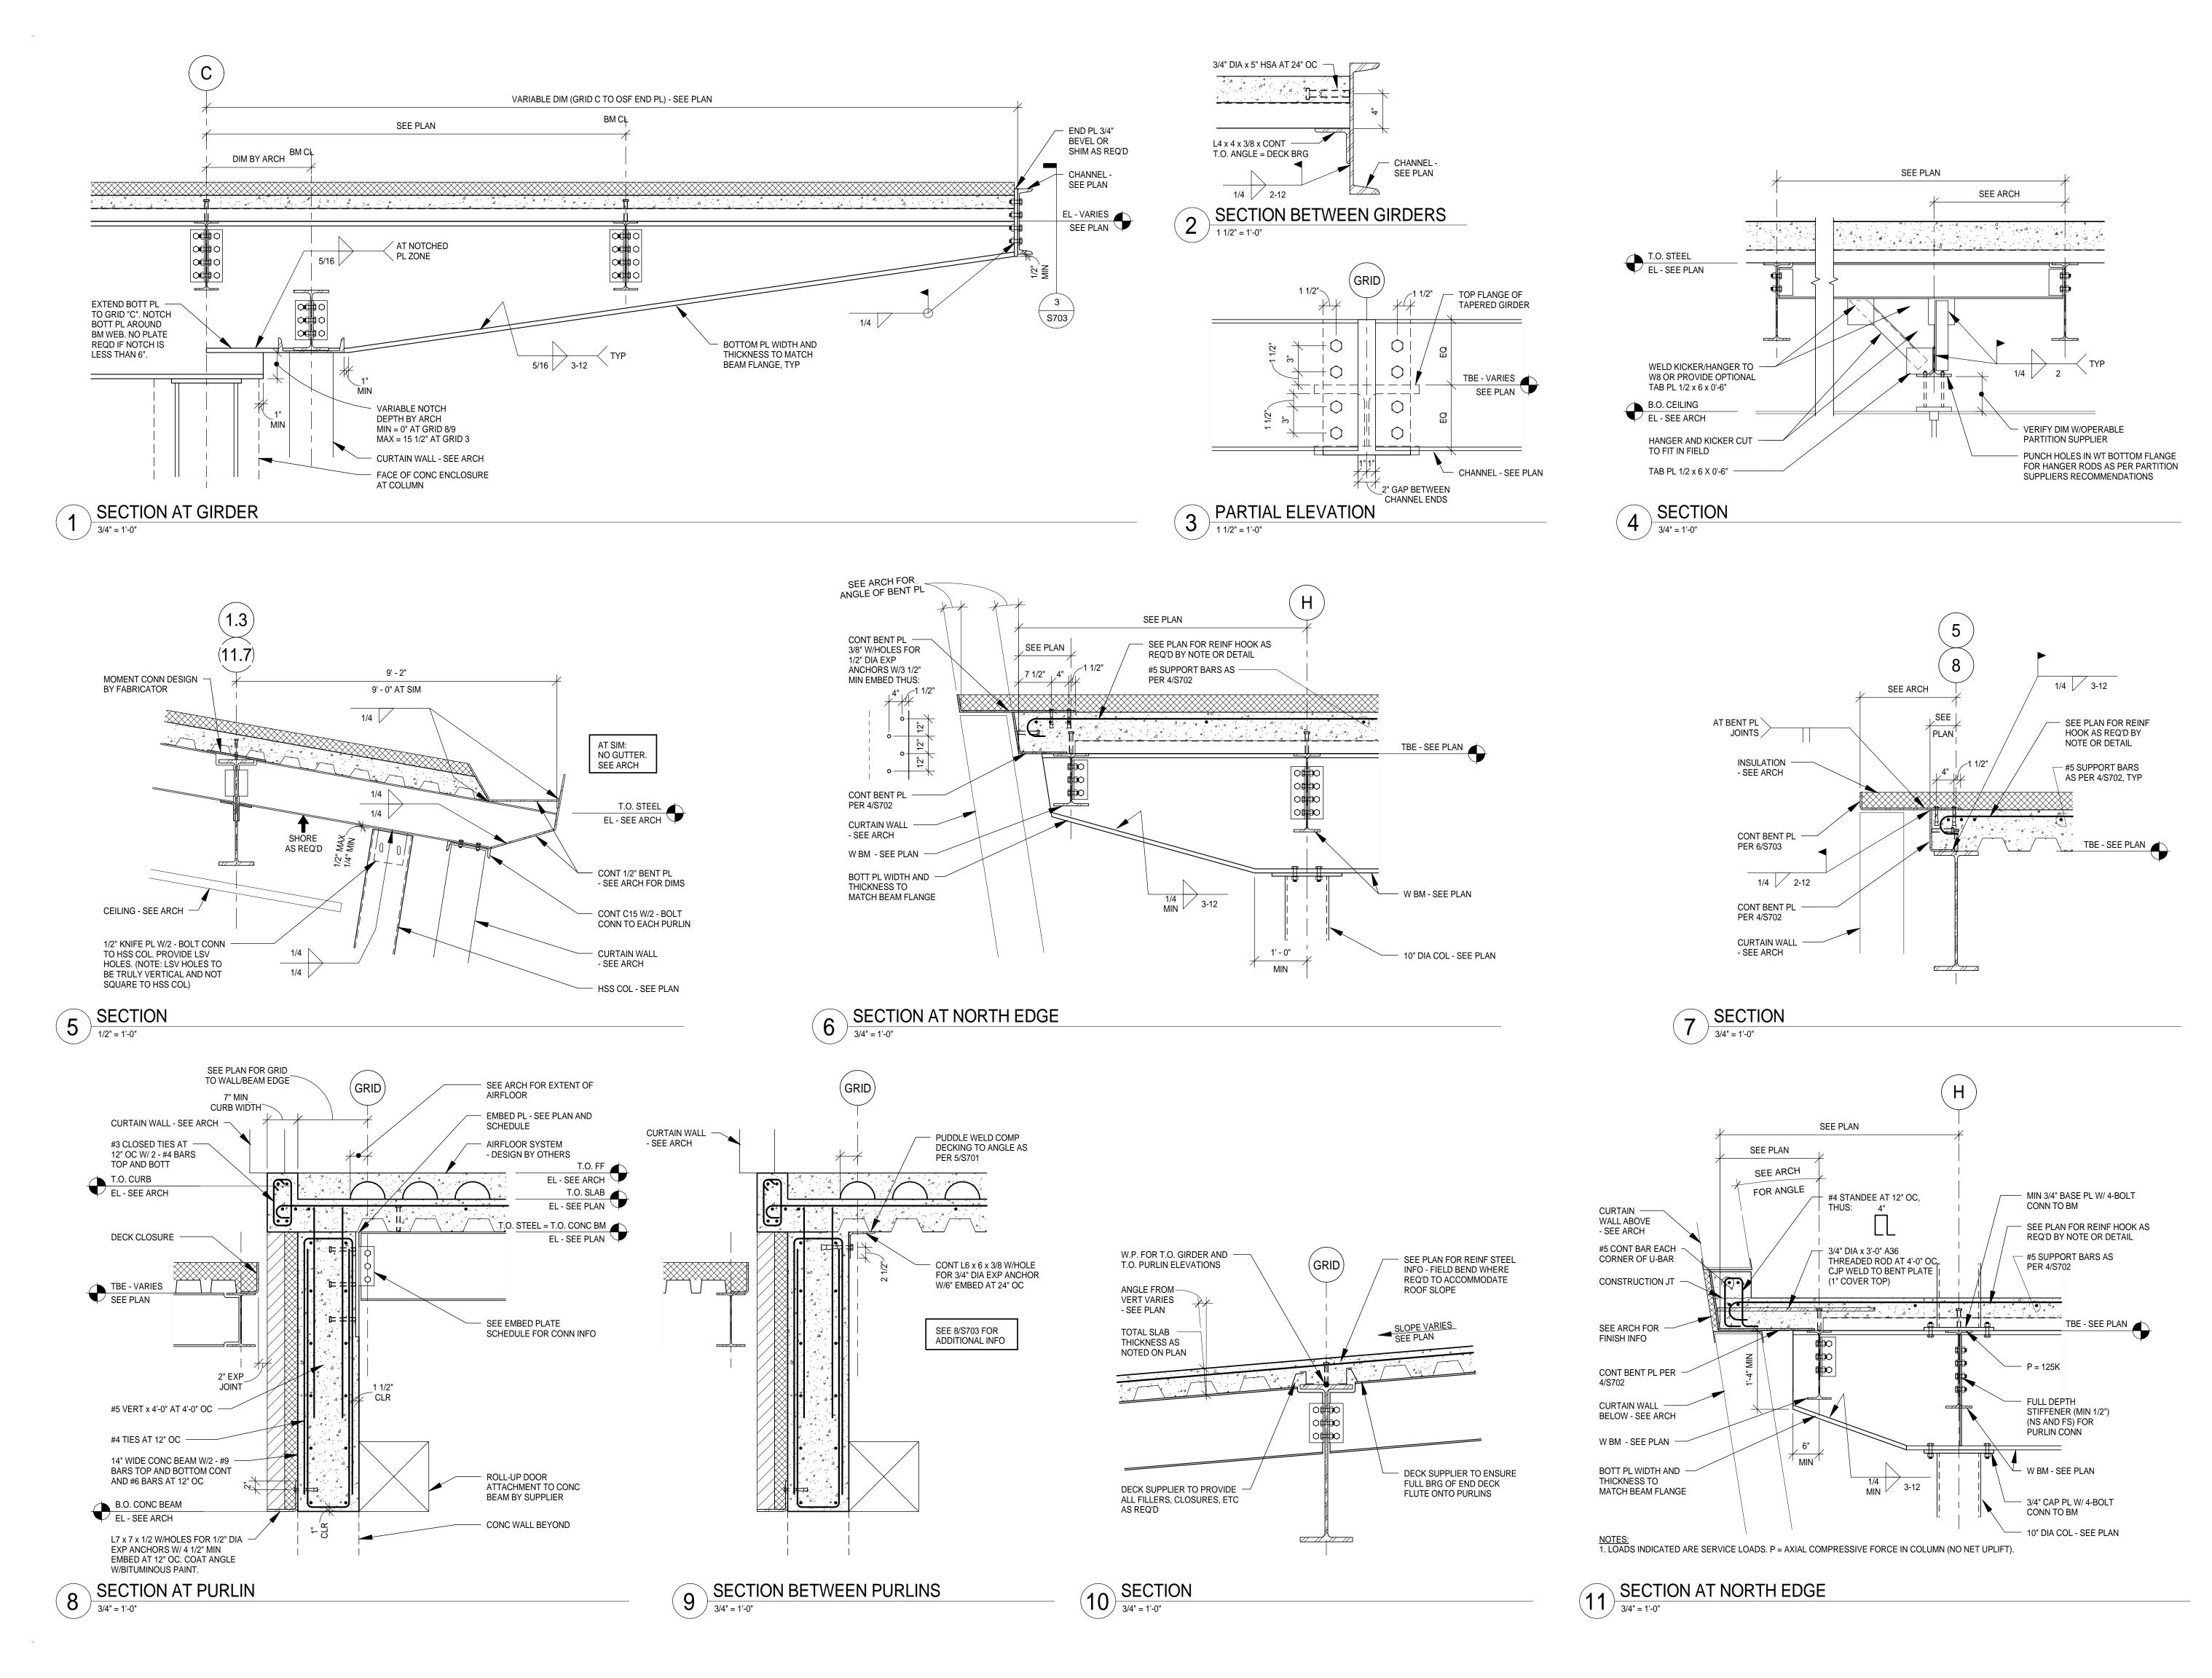
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SHEET TITLE

STRUCTURAL DETAILS

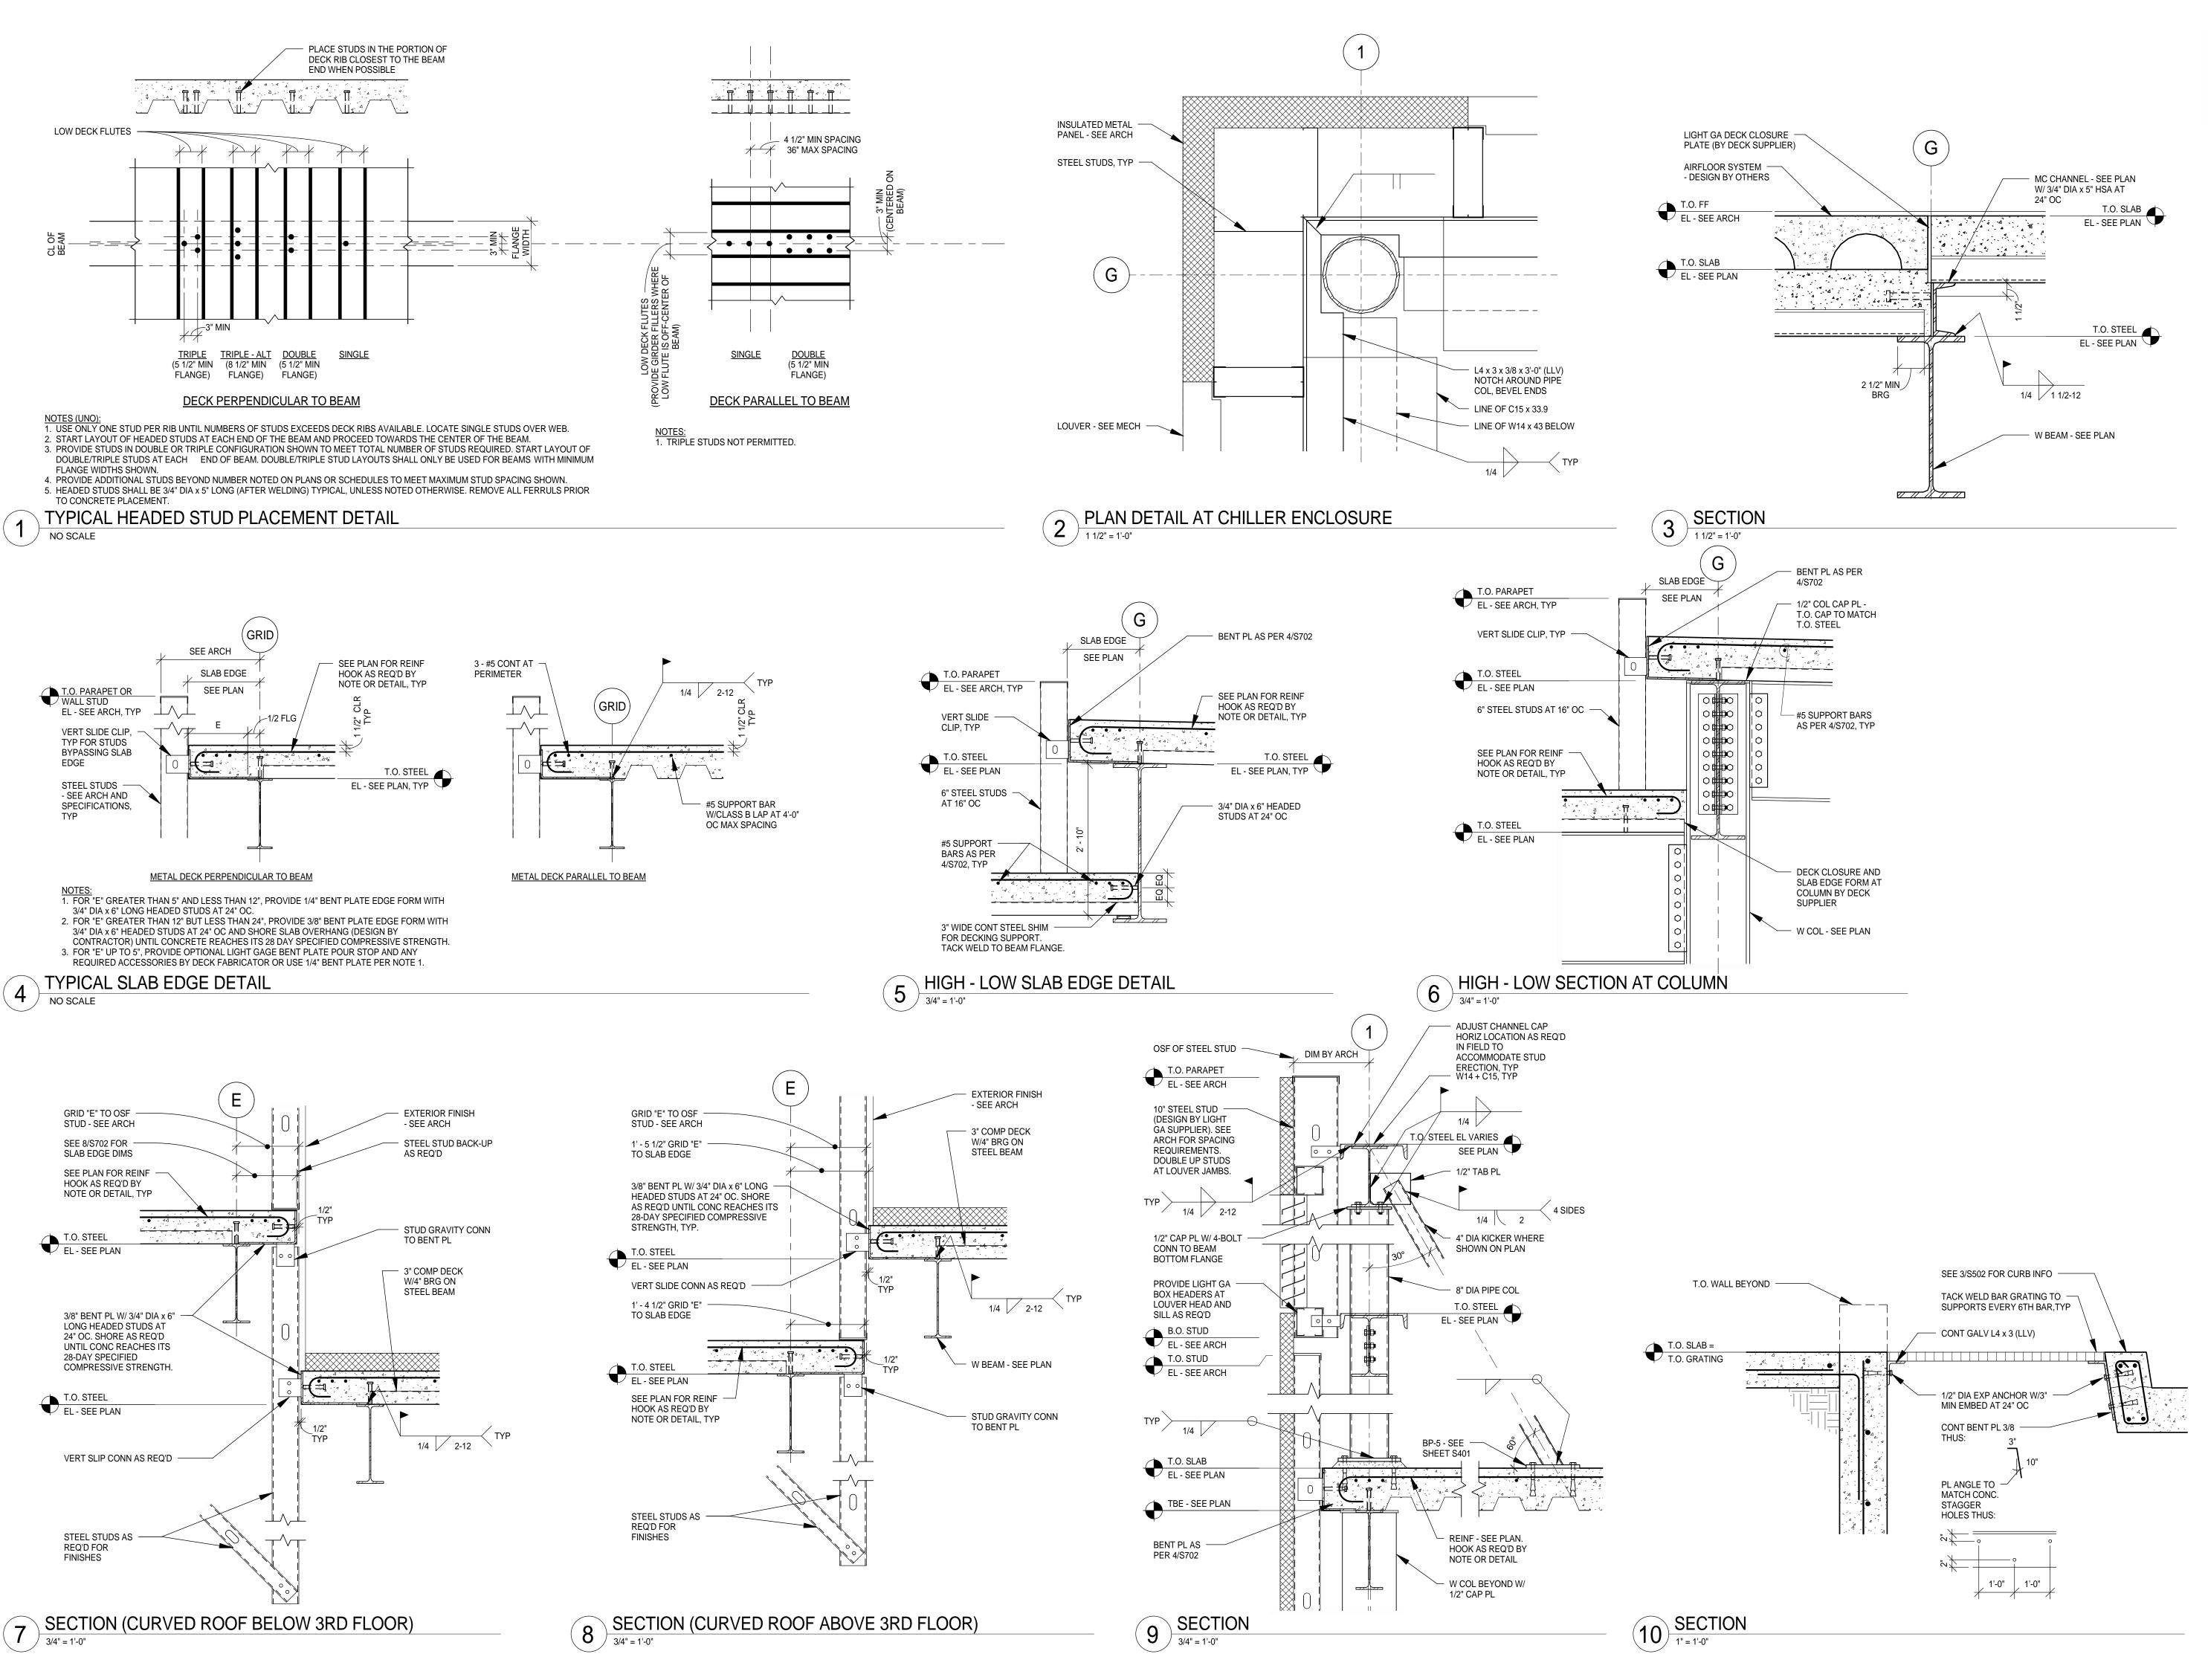SHEET NUMBER **S702** 





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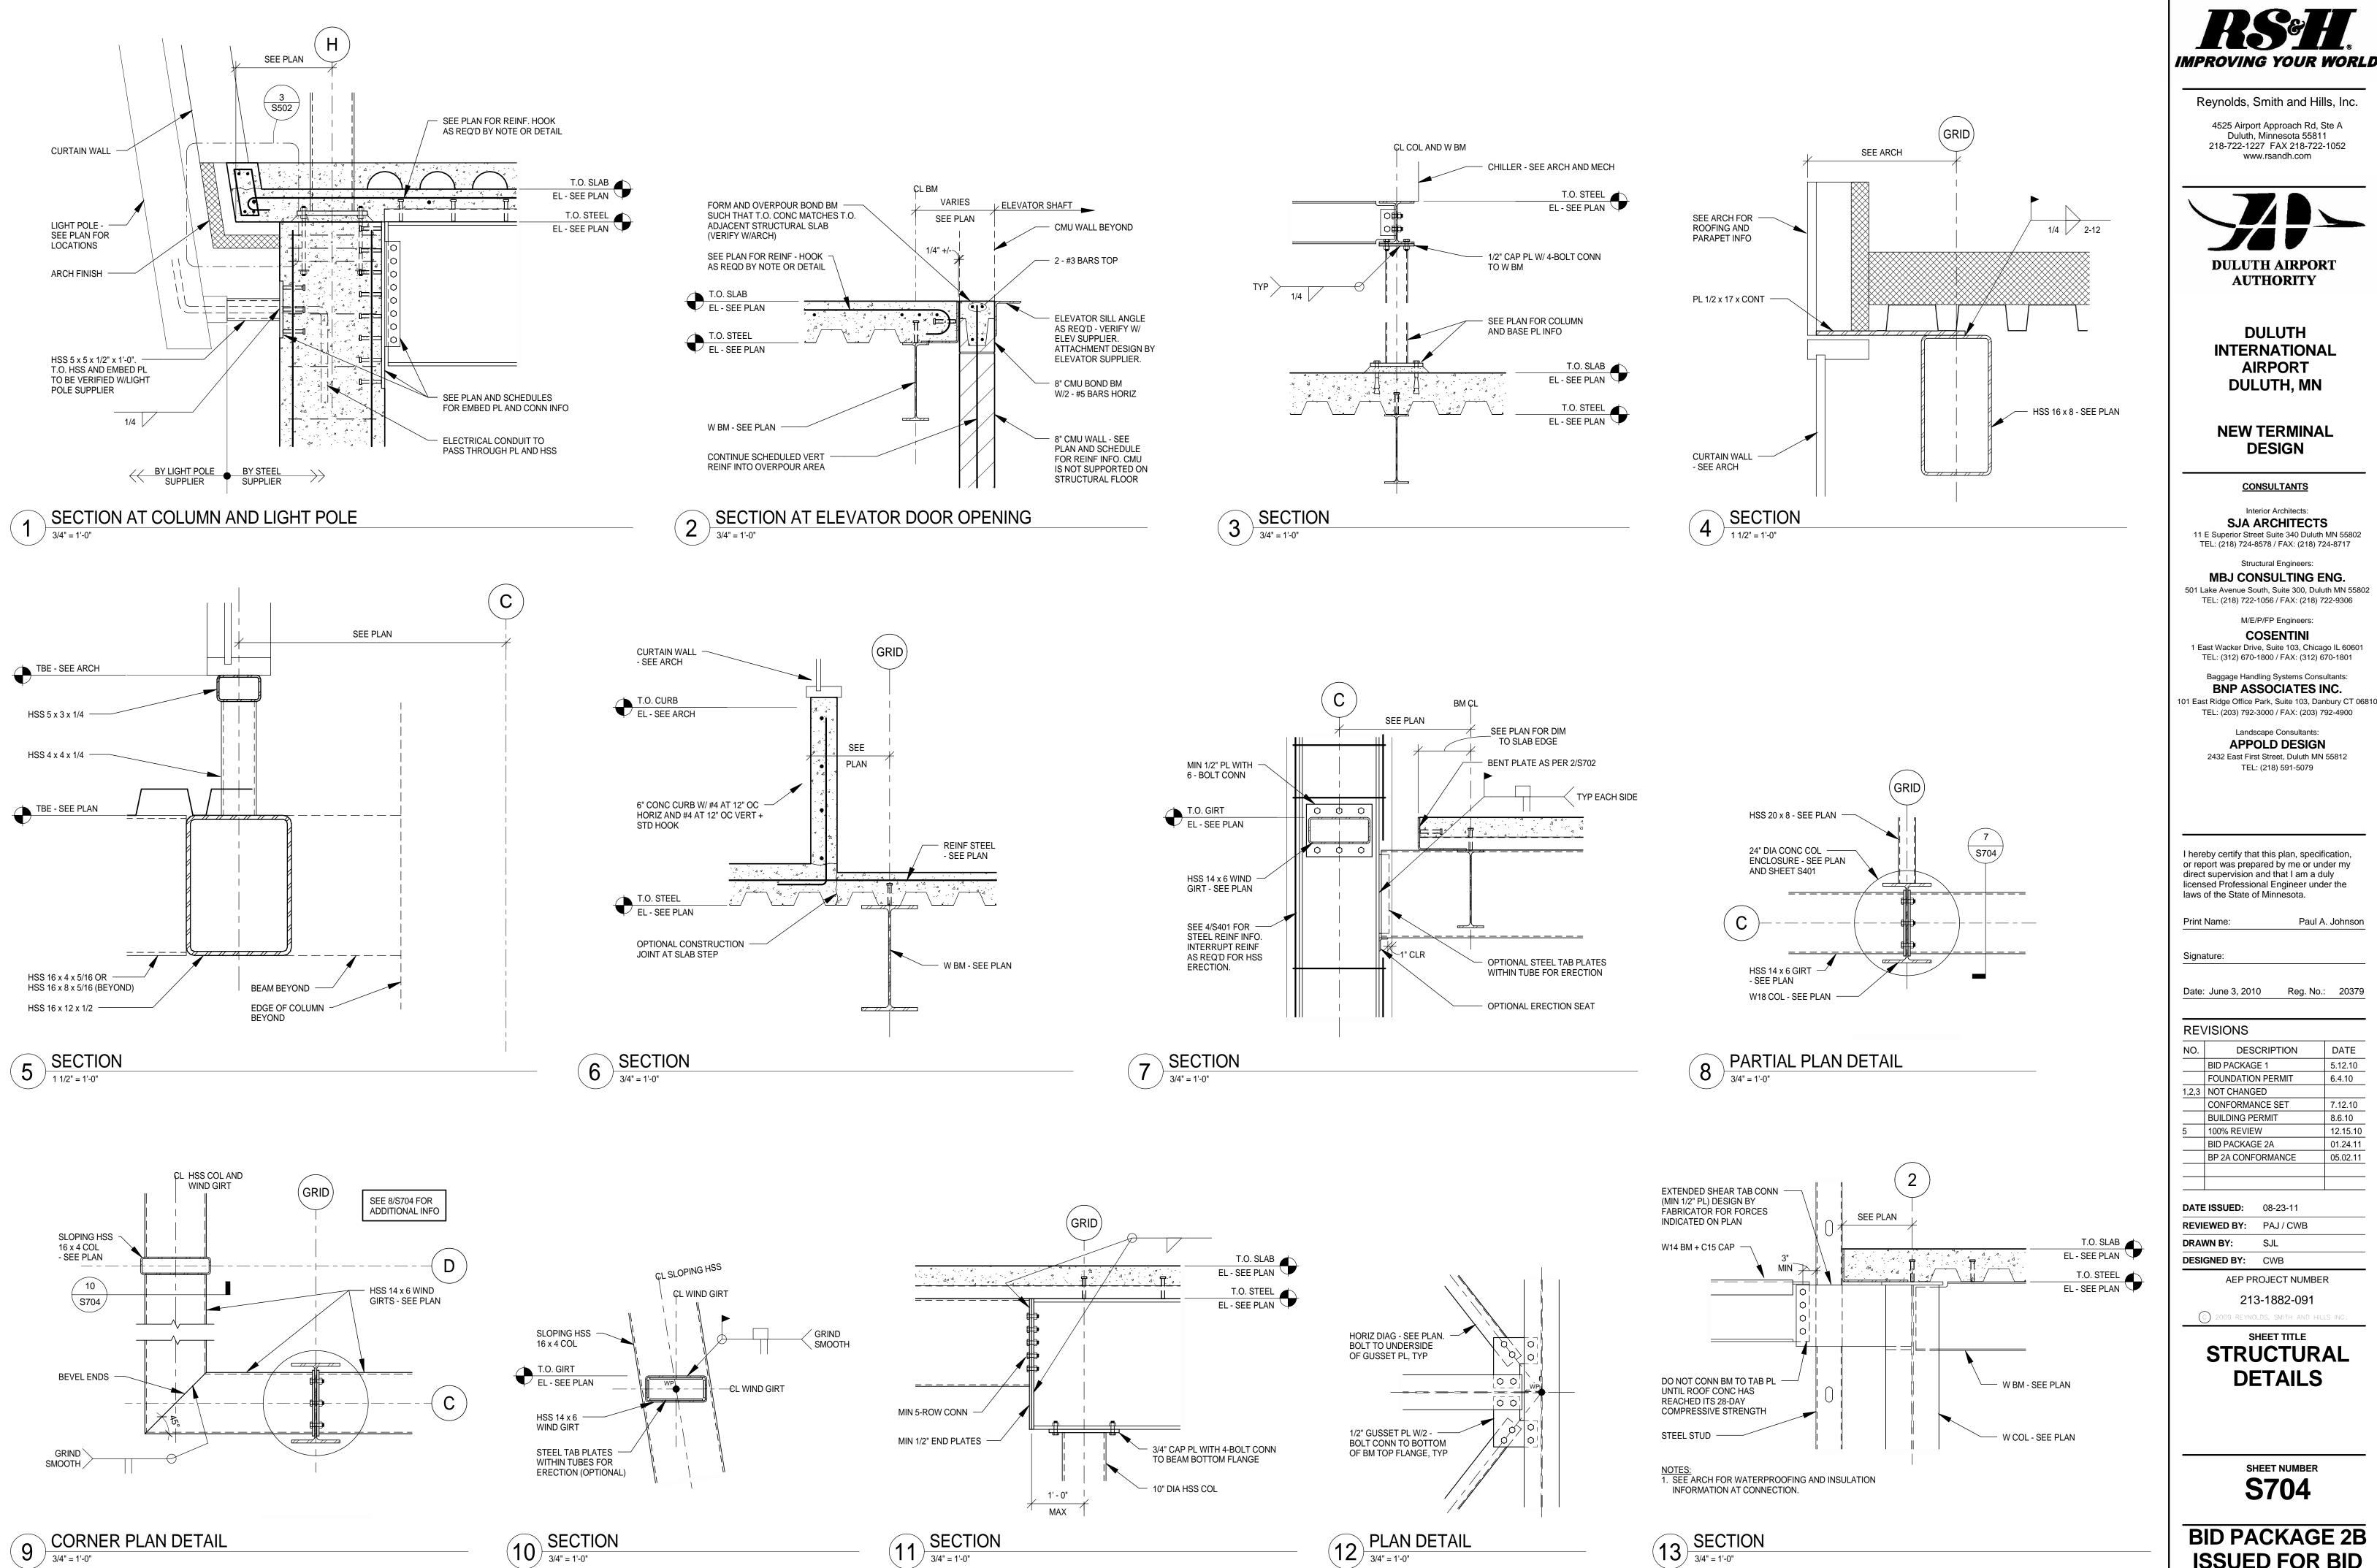
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DRAWN BY:	SJL			
DESIGNED BY:	CWB			
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# STRUCTURAL DETAILS

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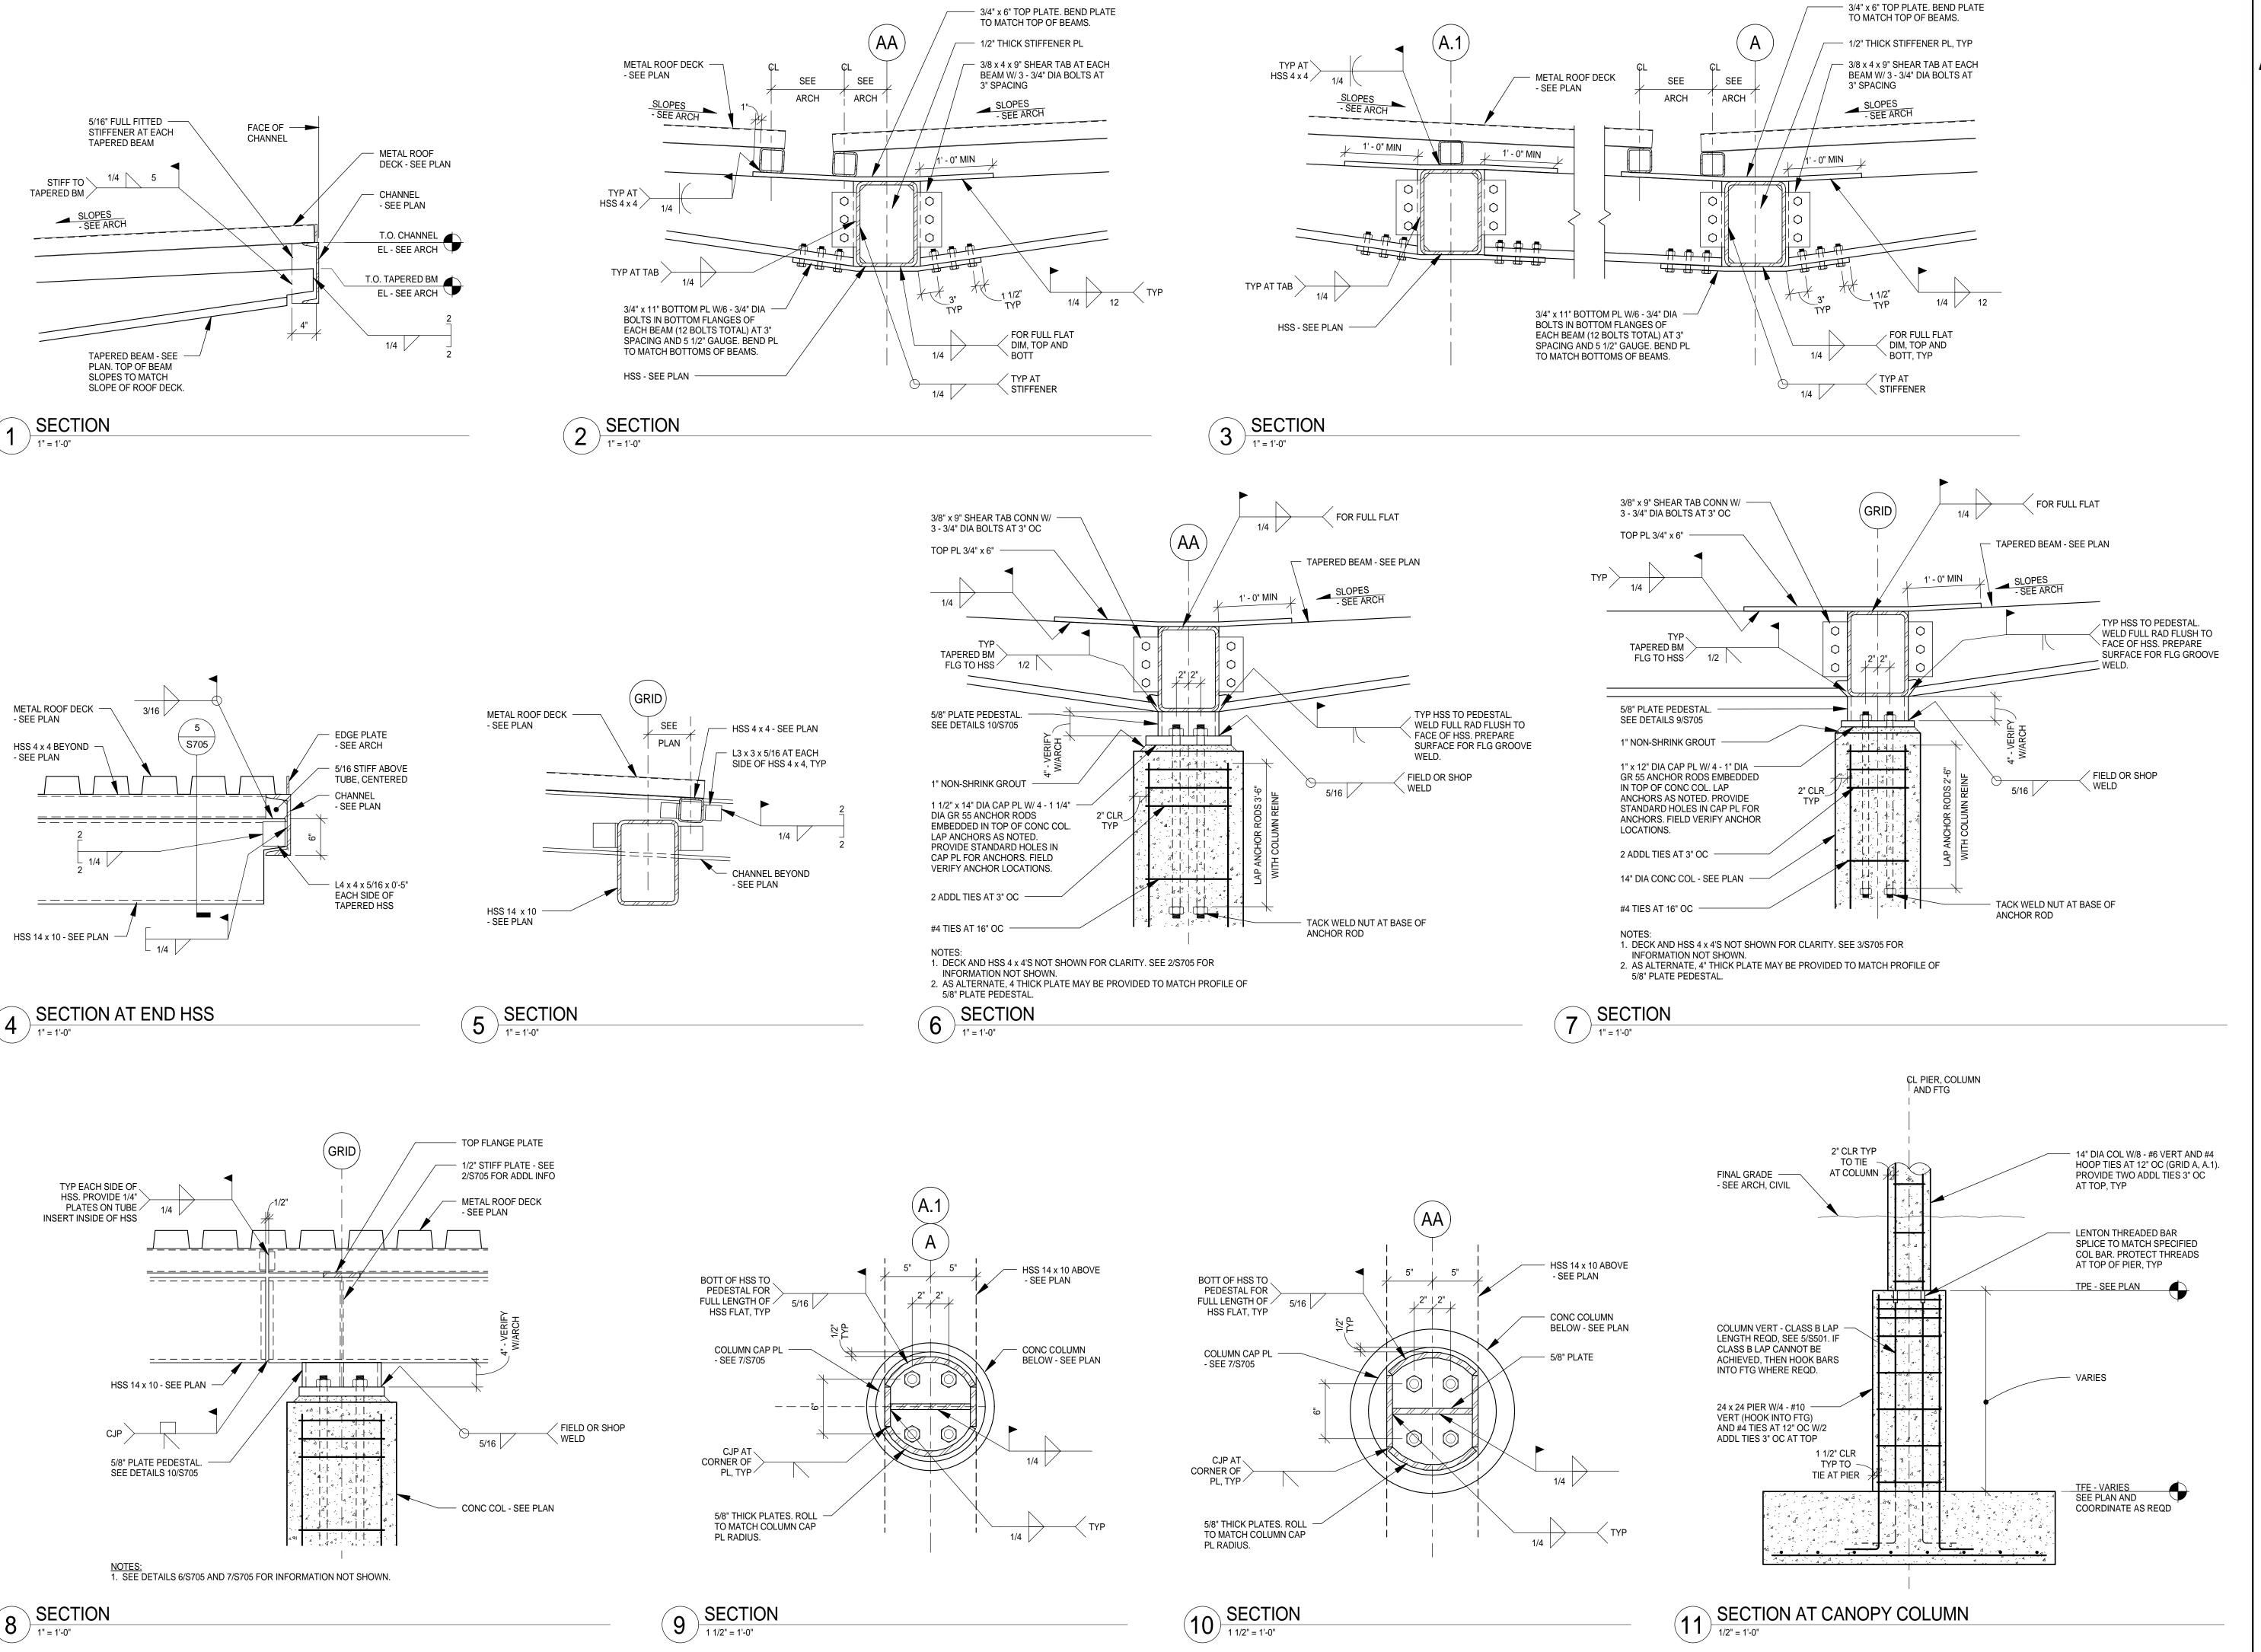
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DATE ISSUED:	08-23-11			
REVIEWED BY:	PAJ / CWB			
DRAWN BY:	SJL			
DESIGNED BY:	CWB			
AEP PROJECT NUMBER				
21	3-1882-091			

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**STRUCTURAL DETAILS** 

> SHEET NUMBER **S704**



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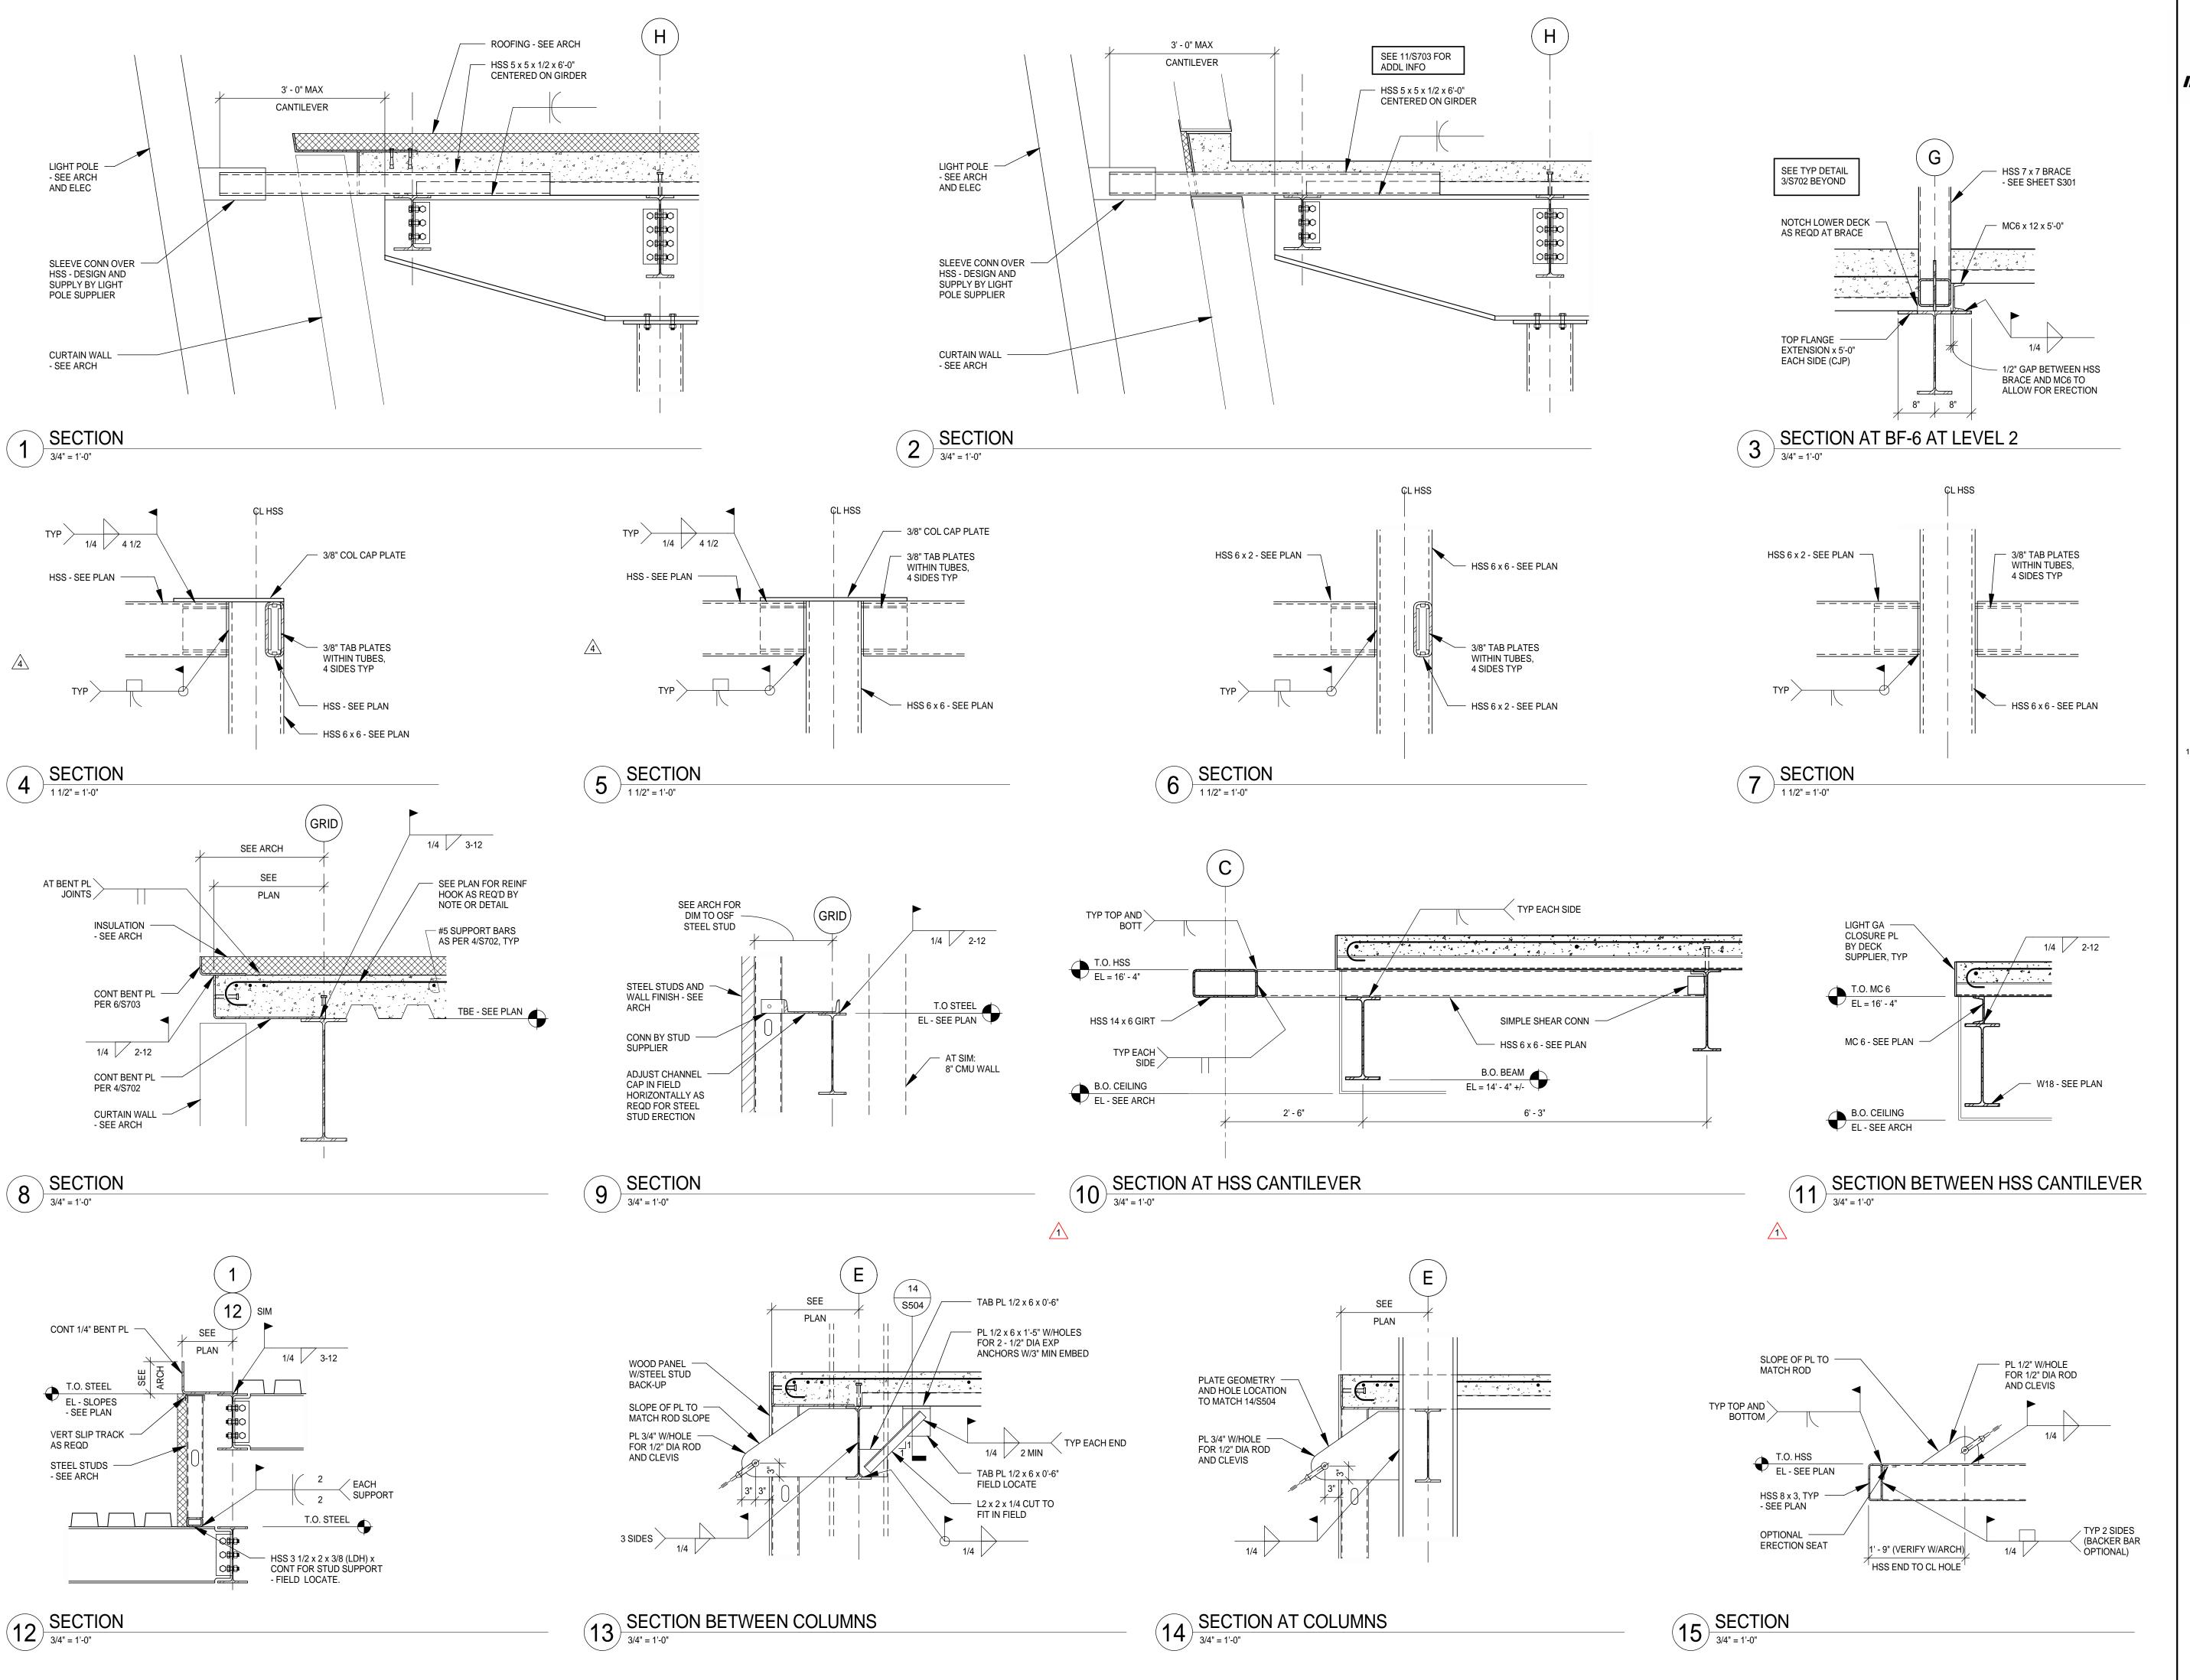
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4525 Airport Approach Rd, Ste A Duluth, Minnesota 55811 218-722-1227 FAX 218-722-1052 www.rsandh.com



DULUTH INTERNATIONAL AIRPORT DULUTH, MN

NEW TERMINAL DESIGN

## CONSULTANTS

Interior Architects:

SJA ARCHITECTS

11 E Superior Street Suite 340 Duluth MN 55802
TEL: (218) 724-8578 / FAX: (218) 724-8717

Structural Engineers:

MBJ CONSULTING ENG.

501 Lake Avenue South, Suite 300, Duluth MN 55802

## TEL: (218) 722-1056 / FAX: (218) 722-9306 M/E/P/FP Engineers:

COSENTINI
1 East Wacker Drive, Suite 103, Chicago IL 60601

## TEL: (312) 670-1800 / FAX: (312) 670-1801 Baggage Handling Systems Consultants: BNP ASSOCIATES INC.

101 East Ridge Office Park, Suite 103, Danbury CT 06810 TEL: (203) 792-3000 / FAX: (203) 792-4900

## Landscape Consultants: APPOLD DESIGN 2423 Foot First Street, Pulleth MN F5643

2432 East First Street, Duluth MN 55812 TEL: (218) 591-5079

I hereby certify that this plan, specification, or report was prepared by me or under my direct supervision and that I am a duly licensed Professional Engineer under the laws of the State of Minnesota.

Print Name: Paul A. Johnson

Signature:

Date: June 3, 2010 Reg. No.: 20379

**REVISIONS** 

NO.	DESCRIPTION	DATE
	BID PACKAGE 1	5.12.10
	FOUNDATION PERMIT	6.4.10
1	ADDENDUM 1	6.11.10
2,3	NOT CHANGED	
	CONFORMANCE SET	7.12.10
	BUILDING PERMIT	8.6.10
4	100% REVIEW	12.15.10
	BID PACKAGE 2A	01.24.11
	BP 2A CONFORMANCE	05.02.11

DATE ISSUED: 08-23-11

REVIEWED BY: PAJ / CWB

DRAWN BY: SJL

DESIGNED BY: CWB

AEP PROJECT NUMBER

213-1882-091
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SHEET TITLE

STRUCTURAL DETAILS

SHEET NUMBER **\$706**