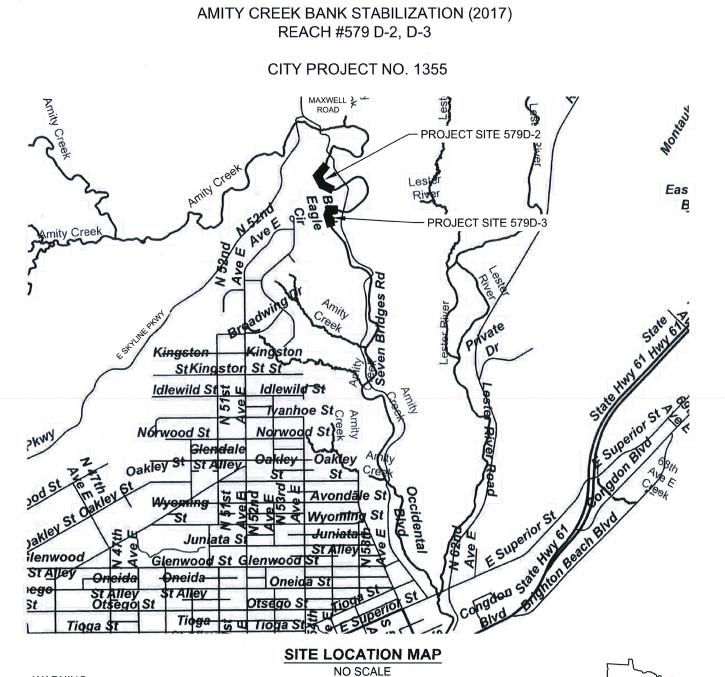
CITY OF DULUTH

CONSTRUCTION PLANS FOR:

DEPARTMENT OF PUBLIC WORKS AND UTILITIES - ENGINEERING DIVISION

LEGEND

| LEGEN | D | | | | | | | | | |
|----------------------------------|---------------------------------------|--|--|--|--|--|--|--|--|--|
| v | EXISTING WATER MAIN | | | | | | | | | |
| | EXISTING GATE VALVE & HYDRANT | | | | | | | | | |
| | WATER SERVICE & CURB STOP | | | | | | | | | |
| | PROPOSED WATERMAIN, VALVE, & HYDRANT | | | | | | | | | |
| | PROPOSED WATER SERVICE & CURB STOP | | | | | | | | | |
| sw(S | EXISTING SANITARY SEWER & MANHOLE | | | | | | | | | |
| FM | EXISTING FORCEMAIN | | | | | | | | | |
| s[] | EXISTING STORM SEWER & INLET | | | | | | | | | |
| | PROPOSED STORM SEWER & INLET | | | | | | | | | |
| | PROPOSED MANHOLE & SEWER MAIN | | | | | | | | | |
| E | BURIED ELECTRIC | | | | | | | | | |
| | BURIED GAS & VALVE | | | | | | | | | |
| | BURIED CABLE TELEVISION | | | | | | | | | |
| T | BURIED TELEPHONE | | | | | | | | | |
| F0 | BURIED FIBER OPTICS | | | | | | | | | |
| он | OVERHEAD UTILITY | | | | | | | | | |
| | RAILROAD TRACKS | | | | | | | | | |
| | EXISTING CURB & GUTTER | | | | | | | | | |
| | PROPOSED CURB & GUTTER | | | | | | | | | |
| | EXISTING SIDEWALK | | | | | | | | | |
| | PROPOSED SIDEWALK | | | | | | | | | |
| CP | EXISTING CULVERT PIPE | | | | | | | | | |
| | PROPOSED CULVERT PIPE | | | | | | | | | |
| —xxx | FENCE LINE | | | | | | | | | |
| | DRAINAGE ARROW | | | | | | | | | |
| | SILT FENCE | | | | | | | | | |
| | RIGHT-OF-WAY | | | | | | | | | |
| | BASELINE | | | | | | | | | |
| | PROPERTY LINE | | | | | | | | | |
| | TREE LINE | | | | | | | | | |
| • | BENCHMARK | | | | | | | | | |
| 0 | IRON PIPE | | | | | | | | | |
| • | IRON ROD | | | | | | | | | |
| A | CONTROL POINT | | | | | | | | | |
| -) | UTILITY POLE & GUY | | | | | | | | | |
| ⊕ ¹ _{000.00} | SOIL BORING | | | | | | | | | |
| × | LIGHT POLE | | | | | | | | | |
| 2 | PEDESTAL | | | | | | | | | |
| ŀ | STREET SIGN | | | | | | | | | |
| ۹ ۲ | MAILBOX | | | | | | | | | |
| 8 | FLAGPOLE | | | | | | | | | |
| (3 (4) | TREE - DECIDUOUS | | | | | | | | | |
| \$ 2 | TREE - CONIFEROUS | | | | | | | | | |
| 254 | TREE TO BE REMOVED | | | | | | | | | |
| | | | | | | | | | | |
| | | | | | | | | | | |
| | | | | | | | | | | |
| T NO.: 00616087 | SCALE: AS SHOWN NO. DATE | | | | | | | | | |
| T DATE: | DRAWN BY: JAS . CHECKED BY: JJJ . . | | | | | | | | | |



WARNING LOCATION OF UNDERGROUND UTILITIES TO BE VERIFIED BY CONTRACTOR GOPHER STATE ONE CALL CALL BEFORE DIGGING, 1-800-252-1166 REQUIRED BY LAW

THE SUBSURFACE UTILITY INFORMATION IN THIS PLAN IS UTILITY QUALITY LEVEL D. THIS QUALITY LEVEL WAS DETERMINED ACCORDING TO THE GUIDELINES OF CI/ASCE 38-.2, ENTILTED "STANDARD GUIDELINES FOR THE COLLECTION AND DEPICTION OF EXISTING SUBSURFACE UTILITY DATA."

MSA

PROFESSIONAL SERVICES

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DEVELOPMENT • ENVIRONA

332 W. Superior Street Duluth, MN 55802 218-722-3915 1-800-777-7380 Fax: 218-722-4548

Web Address: www.msa-ps.com

| MI | TΥ | CREEK BANK STA | |
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| PLOT DATE: | 3/28/17, | P:\610s\616\00616087\CADD\Construction Documents\00616087 | Amity Title Sheet d | w |

PROJEC

PROJEC

GOVERNING SPECIFICATIONS

THE 2016 EDITION OF THE MINNESOTA DEPARTMENT OF TRANSPORTATION *STANDARD SPECIFICATIONS FOR CONSTRUCTION" SHALL GOVERN. AVAILABLE AT: http://www.dot.state.mn.us/pre-letting/spec/index.html

THE 2017 EDITION OF THE CITY OF DULUTH PUBLIC WORKS AND UTILITIES DEPARTMENT STANDARD SPECIFIATIONS AND SUPPLEMENTS OR ADDENDUMS SHALL APPLY. AVAILABLE AT:

engineering/standard-construction-specificatio

THE SUBSURFACE UTILITY INFORMATION IN THIS PLAN IS UTILITY QUALITY LEVEL D. THIS QUALITY LEVEL WAS DETERMINED ACCORDING TO THE GUIDELINES OF CI/ASCE 38-.2, ENTILTED "STANDARD GUIDELINES FOR THE COLLECTION AND DEPICTION OF EXISTING SUBSURFACE UTILITY DATA."

WARNING: LOCATION OF UNDERGROUND UTILITIES TO BE VERIFIED BY CONTRACTOR. CALL BEFOR DIGGING. GOPHER STATE ONE CALL 1-800-252-1166 AS REQUIRED BY LAW. SHEET INDEX

QUANTITIES AND SCHEDULES

SHEET NO.

DESCRIPTION

TRAFFIC CONTROL PLAN ACCESS PLAN EROSION CONTROL DETAILS CHANNEL DETAILS

TOEWOOD DETAILS

PLANTING PLAN

COIR BENCH DETAILS TYPICAL SECTIONS

RIFFLE STRUCTURE DETAIL

PLAN & PROFILE - REACH 579D-2

PLAN & PROFILE - REACH 579D-3 CROSS SECTIONS - REACH 579D-2 CROSS SECTIONS - REACH 579D-3

TITLE SHEET

OVERVIEW

G-1 C-2 C-3 C-4 C-5 C-6 C-7 C-7 C-8 C-9 C-10 C-11 C-12-13 C-14-15 C-5-14-15

CS-12-19



PROJECT COORDINATE SYSTEM IS NAD 1983 HARN ADJ. MN ST. LOUIS CS96 (US FEET)

I HEREBY CERTIFY THAT THIS PLAN WAS PREPARED BY ME OR UNDER MY DIRECT SUPERVISION AND THAT I AM A DULY LICENSED PROFESSIONAL ENGINEER UNDER THE LAWS OF THE STATE OF MINNESOTA.

MAR. 13, 2017 50396 LIC, NO, PROJECT ENGINEER: JOSEPH LHUREWICZ **CITY APPROVAL**

TITLE SHEET

00616087

SHEET G-1

PROJECT LOCATION ST. LOUIS COUNTY

ST. LOUIS COUNTY CITY OF DULUTH

JLUTH

Y CREEK BANK STABILIZATION 2017 CITY OF DULUTH, MINNESOTA CITY OF DULUTH PROJECT NO. 1355

| | | l |
|--|--|---|

| | | | | 1 | 1 | 1 |
|-------------|----------|---|-------|--------------------------------|----------------------------|----------------------------|
| ESTIM | ATED QUA | NTITIES - TABLE 1 | | | | |
| ITEM NO. | SPEC. | ITEM DESCRIPTION | UNITS | TOTAL ESTIMATED QUANTITY | QUANTITY SITE 579D-2 | QUANTITY SITE 579D-3 |
| 1 | A | Project Mobilization/Demobilization | LS | 1 | 0.5 | 0.5 |
| 2 | В | Control of Water | LS | 1 | 0.5 | 0.5 |
| 3 | С | Construction Entrance | EA | 2 | 1 | 1 |
| 4 | D | Maintenance and Restoration of Access Paths | LS | 1 | 0.5 | 0.5 |
| 5 | E | Clearing and Grubbing | LS | 1 | 0.5 | 0.5 |
| 6 | F | Toewood | LF | 210 | 110 | 100 |
| 7 | G | Coir Bench | SY | 1320 | 920 | 400 |
| 8 | Н | Live Stake | EA | 185 | 105 | 80 |
| 9 | I | Filter Log | LF | 900 | 500 | 400 |
| 10 | J | Erosion Control Blanket, Category 3N-2S | SY | 2350 | 1750 | 600 |
| 11 | К | Seeding | SY | 2910 | 2050 | 860 |
| 12 | L | Shrubs | EA | 74 | 43 | 31 |
| 13 | М | Deadfall and Debris Removal and Off-Site Disposal | LS | 1 | 0.5 | 0.5 |
| 14 | N | Boulder Cross Vane | EA | 8 | 5 | 3 |
| 15 | 0 | Riffle | EA | 10 | 6 | 4 |
| 16 | Р | Vegetated Keyway | EA | 6 | 4 | 2 |
| 17 | Q | Site Grading | LS | 1 | 0.5 | 0.5 |
| 18 | R | Silt Fence | LF | 200 | 100 | 100 |
| 19 | S | Traffic Control | LS | 1 | 0.5 | 0.5 |

GENERAL CONSTRUCTION NOTES:

- 1. ALL EXCAVATION WITHIN OR ADJACENT TO THE STREAM BED SHALL BE UNDERTAKEN IN DRY CONDITIONS. THE CONTRACTOR SHALL INSTALL SANDBAGS, COFFERDAMS, AND BYPASS PIPING AS NECESSARY TO SAFELY ROUTE THE STREAM FLOW AROUND THE EXCAVATION AREA UNTIL CONSTRUCTION IS COMPLETE. THIS WORK ITEM SHALL BE PAID FOR AS A PART OF THE LUMP SUM BID ITEM FOR CONTROL OF WATER.
- 2. DEBRIS AND DEADFALL REMOVAL SHALL NOT BE INTERPRETED TO MEAN GRUBBING, BUT MAY INCLUDE REMOVAL OF LIVE TIMBER BY CUTTING AND LEAVING STUMP INTACT. LIVE TIMBER CAN BE CUT AT A BREAK OR NO CLOSER THAN 2-FEET TO THE GROUND. DEADFALL IS TO BE CONSIDERED ONLY FLOATABLE DEBRIS. DEADFALL OR CUT TIMBER IN GOOD CONDITION MAY BE UTILIZED ONSITE FOR TOEWOOD OR COIR BENCH STABILIZATION AS APPROVED BY THE ENGINEER.
- 3. SITE GRADING SHALL INCLUDE TOPSOIL STRIPPING AND STOCKPILING, AND SUBSOIL EXCAVATION AND STOCKPILING. IT IS ANTICIPATED THAT THE EXCAVATED SUBSOIL WILL BE SUITABLE TO REUSE AS BACKFILL FOR TOEWOOD, COIR BENCH AND IN OTHER AREAS AS NECESSARY.
- 4. OTHER ITEMS WHERE A METHOD OF PAYMENT IS NOT NOTED SHALL BE INCIDENTAL TO CONSTRUCTION.

INVASIVE SPECIES CONTROL MEASURES:

PRIOR TO ENTERING THE PROJECT SITE, THE CONTRACTOR SHALL INSPECT ALL EQUIPMENT AND GEAR AND REMOVE ALL AQUATIC PLANTS, ANIMALS, AND MUD FROM ALL ITEMS. EQUIPMENT AND GEAR SHALL BE DEFINED AS ALL BOATS, MOTORS, TRACKED VEHICLES, HEAVY EQUIPMENT, BARGES, HOSES, PUMPS, SHEET PILING, SILT CURTAINS, OR TURBIDITY BARRIERS, WADERS AND ALL OTHER EQUIPMENT WHICH MAY COME IN CONTACT WITH SURFACE WATERS DURING CONSTRUCTION. THE CONTRACTOR SHALL SCRUB ALL EQUIPMENT AND GEAR WITH A STIFF-BRISTLED BRUSH WHEN FEASIBLE. THE CONTRACTOR SHALL MAINTAIN A MANIFEST DOCUMENTING THE ITEM, DATE, LOCATION AND DISINFECTION METHOD USED TO PERFORM DISINFECTION.

| ESTIMATED EARTHWORK QUANTITIES - TABLE 2 | | | | | | | | | |
|--|-------|--------------------------------|-------------------------|-------------------------|--|--|--|--|--|
| ITEM DESCRIPTION | UNITS | TOTAL ESTIMATED QUANTITY | QUANTITY SITE 579D-2 | QUANTITY SITE 579D-3 | | | | | |
| Excavation | CY | 1972 | 1253 | 719 | | | | | |
| Fill | CY | 1856 | 1436 | 420 | | | | | |

EARTHWORK NOTES:

- DURING EXCAVATION OR FILLING.
- 2. INSTALLATION OF TOEWOOD.

| PROJECT NO .: | 00616087 | SCALE: AS SHOWN | NO. | DATE | REVISION | BY | LUEDERY CERTIES THAT THIS RUAN REPORT OR | MAR. 13, 2017 50396 | | TRANSPORTATION . MUNICIPAL | |
|---------------|----------|-----------------|-----|------|----------|----|--|---------------------|--|--|--------------------|
| PROJECT DATE: | | DRAWN BY: JAS | | | | | I HEREBY CERTIFY THAT THIS PLAN, REPORT, OR SPECIFICATION WAS PREPARED BY ME OR | Date License No. | | | AMITY CREEK BANK S |
| F.B. : | | CHECKED BY: JJJ | | | | | UNDER MY DIRECT SUPERVISION AND THAT I AM | Josef | MSA | 332 W. Superior Street Duluth, MN 55802 218-722-3915 1-800-777-7380 Fax: 218-722-4548 | CITY OF DULUTH, |
| | | | | | | | A DULY LICENSED PROFESSIONAL ENGINEER UNDER THE LAWS OF THE STATE OF MINNESOTA. | | | | CITY OF DULUTH PR |
| | | | | | | | SNDER THE EAVIS OF THE STATE OF MINNESOTA. | JOSEPH J JUREWICE | PROFESSIONAL CONTACT IN THE PROFESSION OF THE PR | © MSA Professional Services, Inc. | |

1. QUANTITIES ARE NOT ADJUSTED FOR EXPANSION OR SHRINKAGE OF MATERIAL QUANTITIES INCLUDE ESTIMATED AMOUNTS OF EXCAVATION NEEDED FOR

| STABILIZATION 2017 | |
|--------------------|--|
| H, MINNESOTA | |
| ROJECT NO. 1355 | |

QUANTITIES & SCHEDULES



| PROJECT NO .: | 00616087 | SCALE: AS SHOWN | NO. | DATE | REVISION | BY | I HEREBY CERTIFY THAT THIS PLAN, REPORT, OR | MAR. 13, 2017 50396 | | TRANSPORTATION . MUNICIPAL | AMITY CREEK BANK ST |
|---------------|----------|-----------------|-----|------|----------|----|--|---------------------|-----------------------|--|---------------------|
| PROJECT DATE: | | DRAWN BY: JAS | | | | | SPECIFICATION WAS PREPARED BY ME OR | Date License No. | | DEVELOPMENT · ENVIRONMENTAL | AMILY CREEK BANK ST |
| F.B. : | | CHECKED BY: JJJ | | | | | UNDER MY DIRECT SUPERVISION AND THAT I AM | AAK . | MSA | 332 W. Superior Street Duluth, MN 55802 218-722-3915 1-800-777-7380 Fax: 218-722-4548 | CITY OF DULUTH, |
| | | | | | | 1. | A DULY LICENSED PROFESSIONAL ENGINEER UNDER THE LAWS OF THE STATE OF MINNESOTA. | | | | CITY OF DULUTH PRO |
| | | | | | | | UNDER THE EAVIS OF THE STATE OF MININESOTA. | JOSEPH J JURISMICE | PROFISSIONAL SERVICES | © MSA Professional Services, Inc. | |

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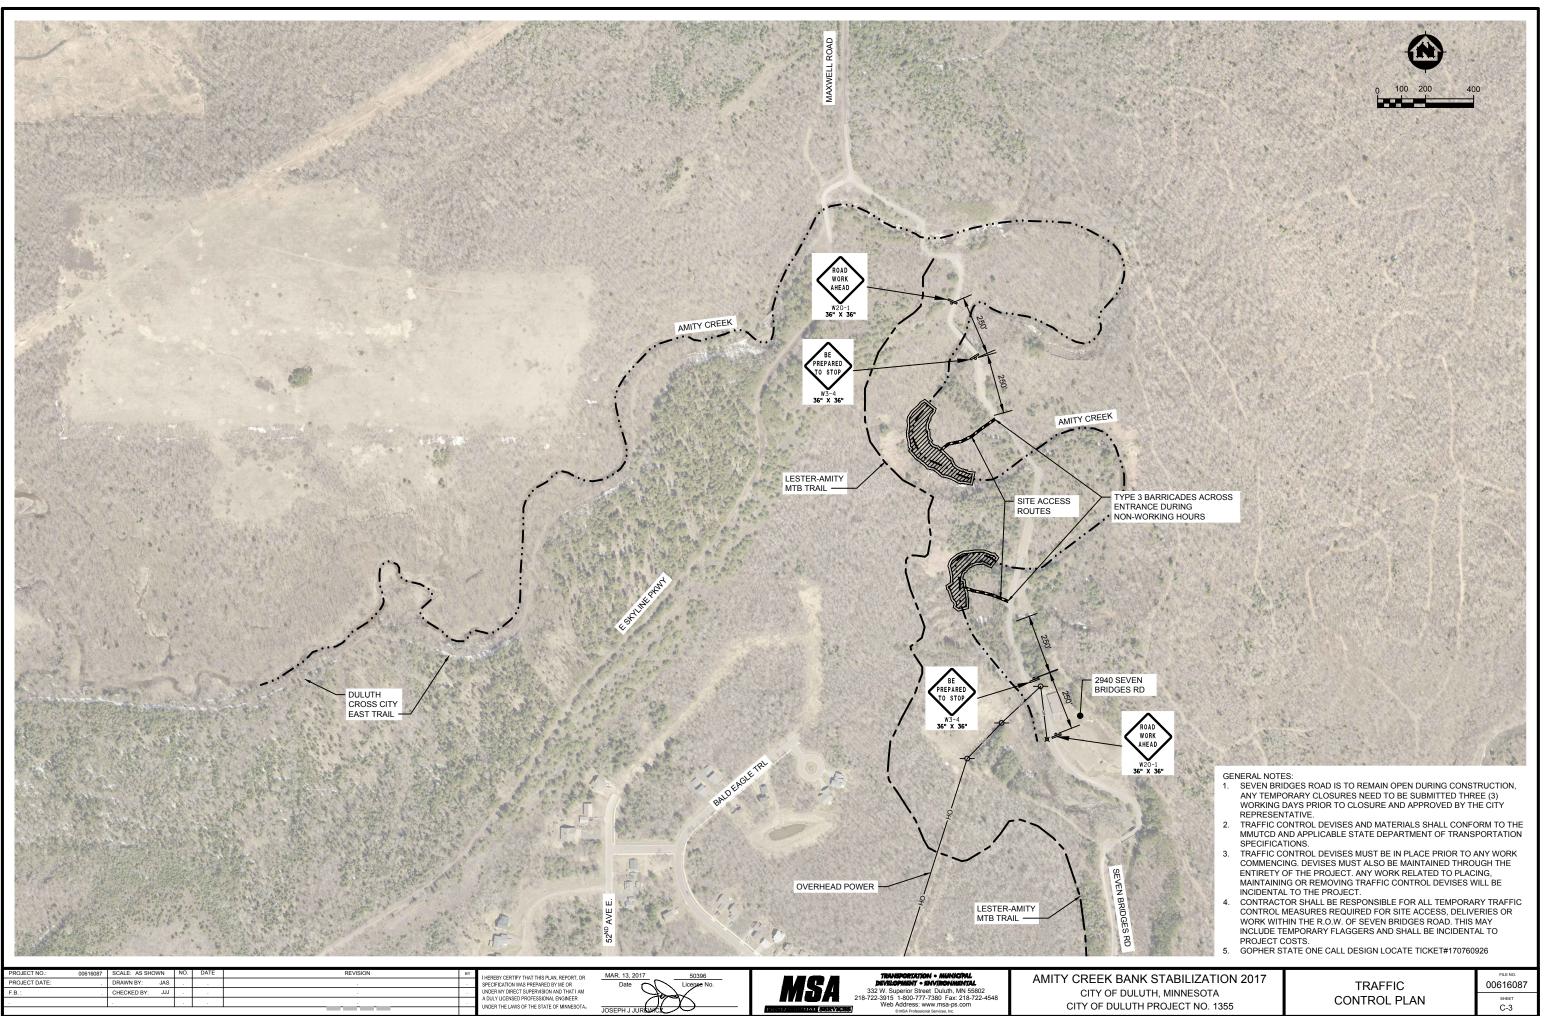
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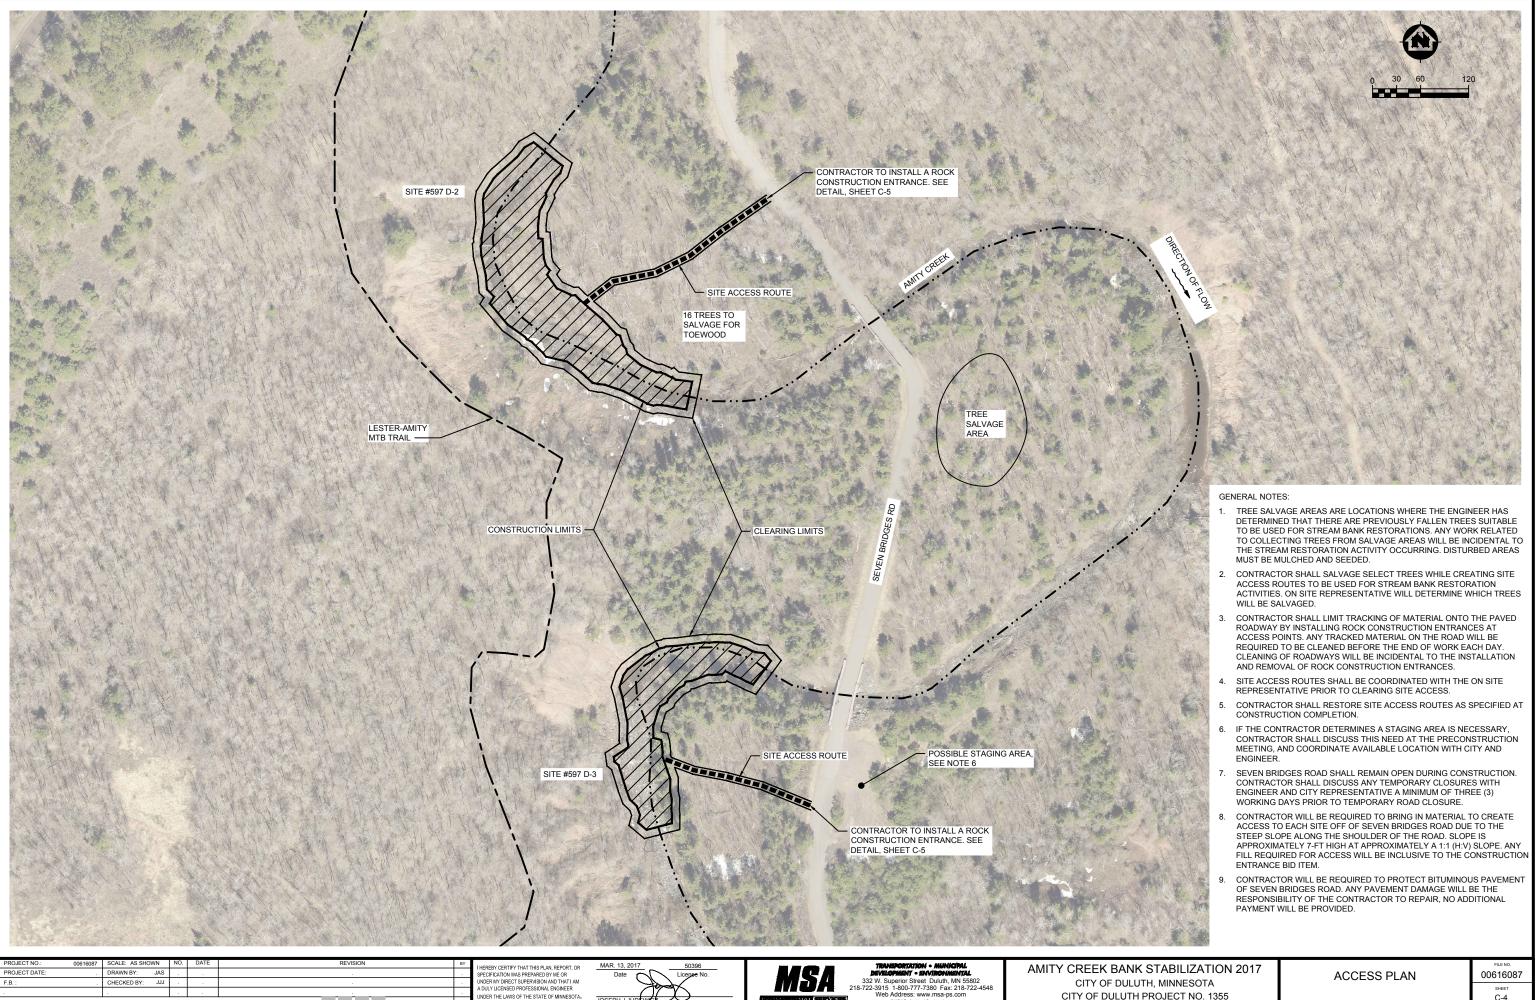
PROJECT COORDINATE SYSTEM IS NAD 1983 HARN ADJ. MN ST. LOUIS CS96 (US FEET)

| STABILIZATION 2017 |
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| H, MINNESOTA |
| PROJECT NO. 1355 |

OVERVIEW



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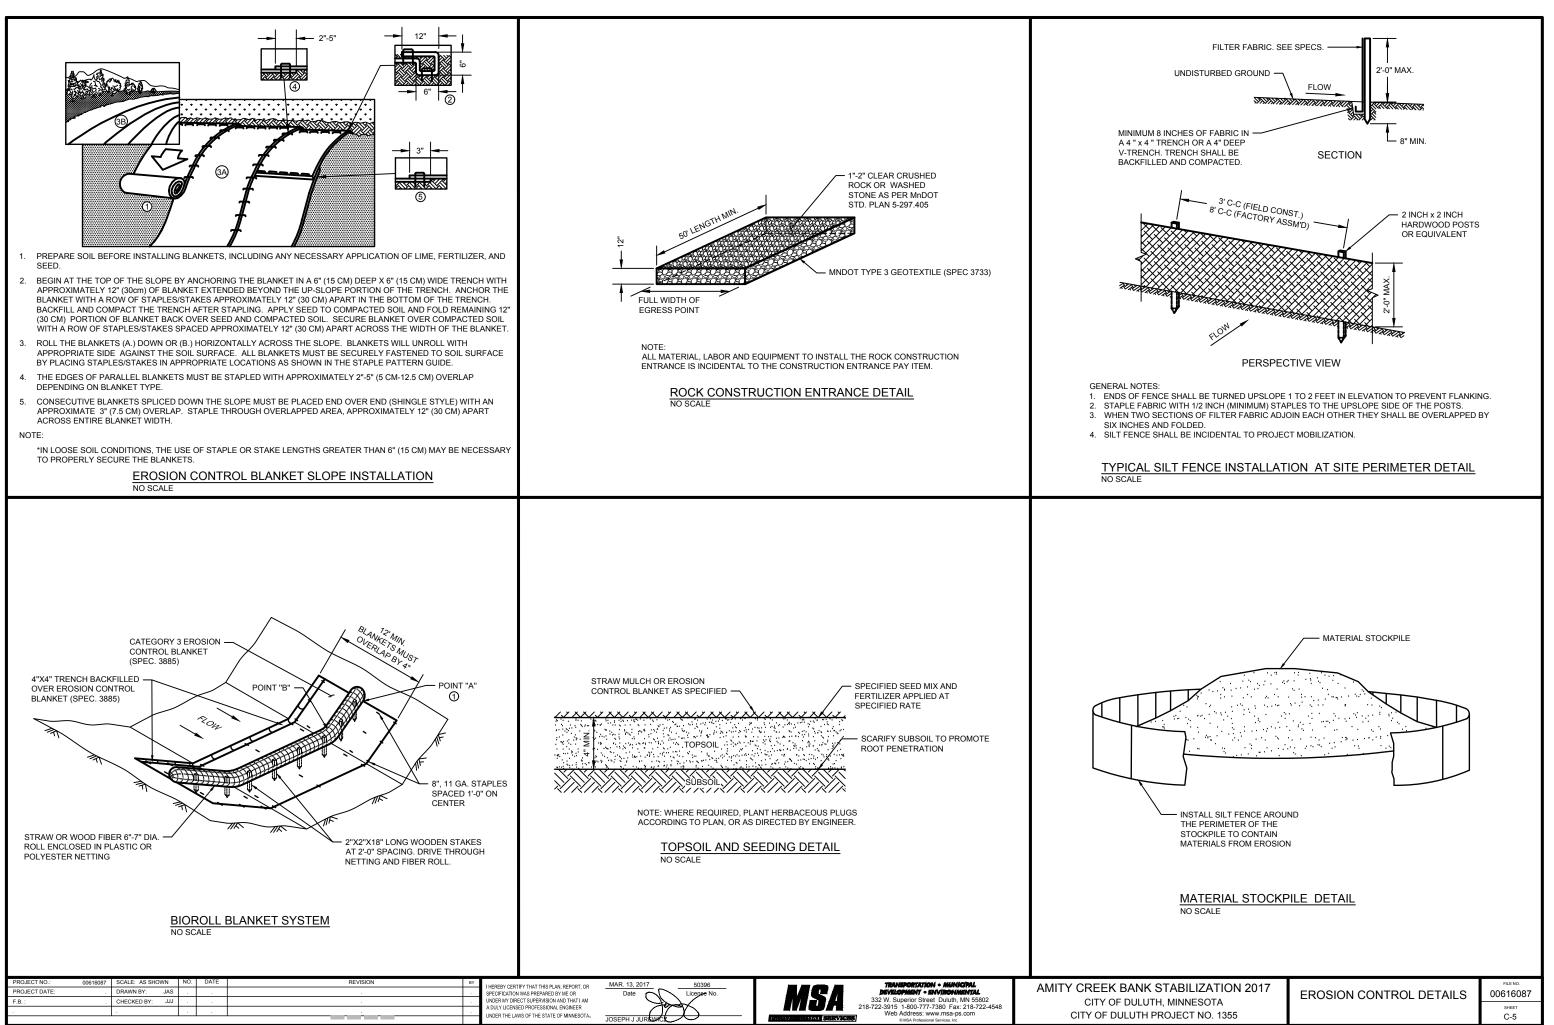
NAL CONTRACTOR

NDER THE LAWS OF THE STATE OF MINNESOTA.

JOSEPH J JURIEWICK

| PLOT DATE: 3/28/17 | P:\610s\616\00616087\CADD\Construction Documents\00616087 | Amity | Traffic Control Plan.dwg |
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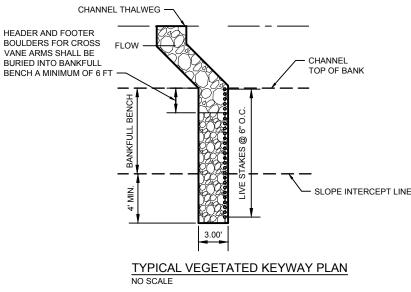
| Y CREEK BANK STABILIZATION 2017 | |
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| CITY OF DULUTH, MINNESOTA | |
| CITY OF DULUTH PROJECT NO. 1355 | |

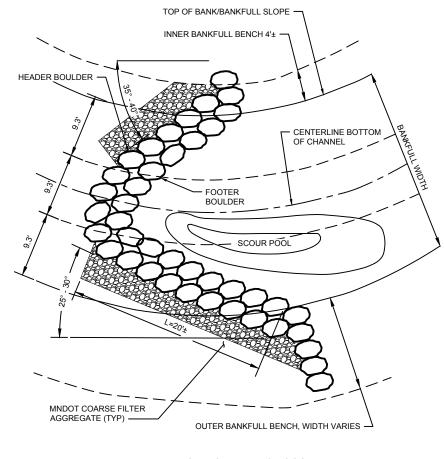


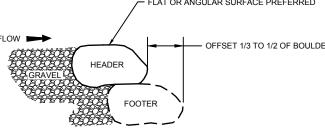
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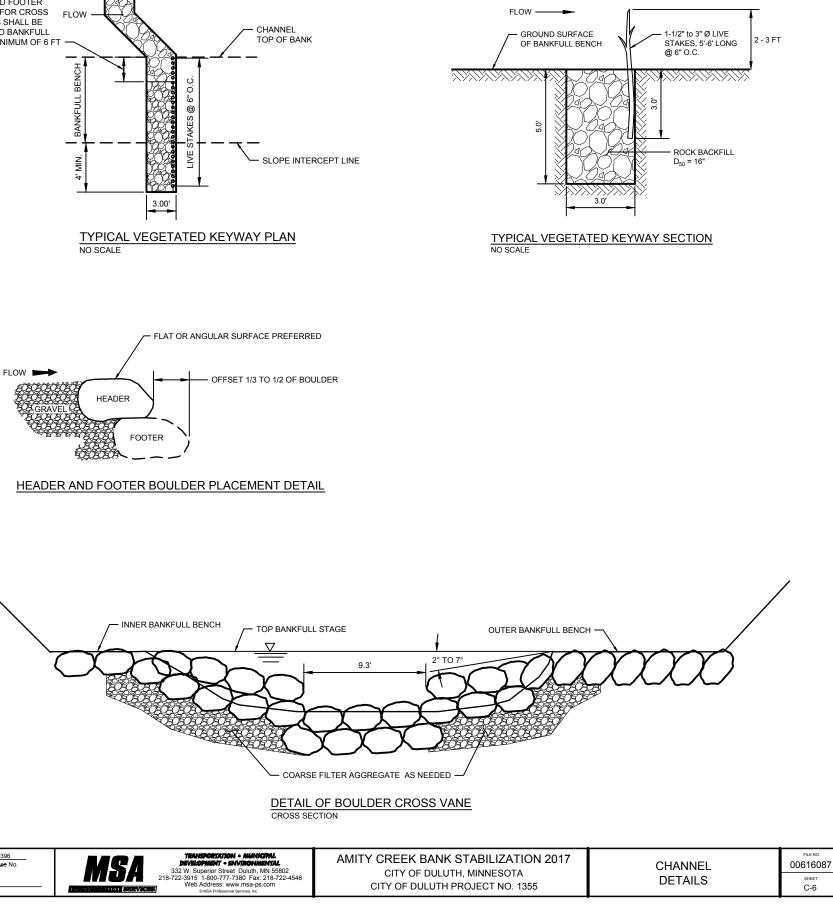
NOTES:

- 1. COARSE BACKFILL (MNDOT COARSE FILTER AGGREGATE) SHALL BE PLACED TO A THICKNESS EQUAL TO THE DEPTH OF THE HEADER AND FOOTER BOULDERS AND SHALL EXTEND OUT FROM THE VANE ARMS TO THE STREAM BANK.
- 2. THE VANE ARMS OF THE BOULDER CROSS VANE SHALL BE CONSTRUCTED FIRST, FOLLOWED BY THE CENTRAL VANE.
- 3. BOULDER CROSS VANES SHALL BE BUILT TYPICALLY AS FOLLOWS:
 - A. OVER EXCAVATE STREAM BED TO A DEPTH EQUAL TO THE TOTAL THICKNESS OF THE HEADER AND FOOTER BOULDERS.
 - B. PLACE FOOTER BOULDERS OF THE VANE ARM. THERE SHALL BE NO GAPS BETWEEN BOULDERS.
 - C. PLACE COARSE BACKFILL BEHIND THE FOOTER BOULDERS.
 - D. INSTALL HEADER BOULDERS ON THE VANE ARM ON TOP OF AND SET SLIGHTLY BACK FROM THE FOOTER BOULDERS (SUCH THAT PART OF THE HEADER BOULDER IS RESTING ON THE COARSE BACKFILL). HEADER BOULDERS SHALL SPAN THE SEAMS OF THE FOOTER BOULDERS. THERE SHALL BE NO GAPS BETWEEN BOULDERS.
 - E. PLACE COARSE BACKFILL BEHIND HEADER BOULDERS ENSURING THAT ANY VOIDS BETWEEN THE BOULDERS ARE FILLED.
 - F. PLACE EACH BOULDER TO FORM THE HOOK BY INSTALLING A FOOTER BOULDER, THEN A HEADER BOULDER. GAPS AS WIDE AS 1/4 TO 1/3 THE BOULDER DIAMETER SHALL BE LEFT BETWEEN THE CENTRAL VANE BOULDERS.



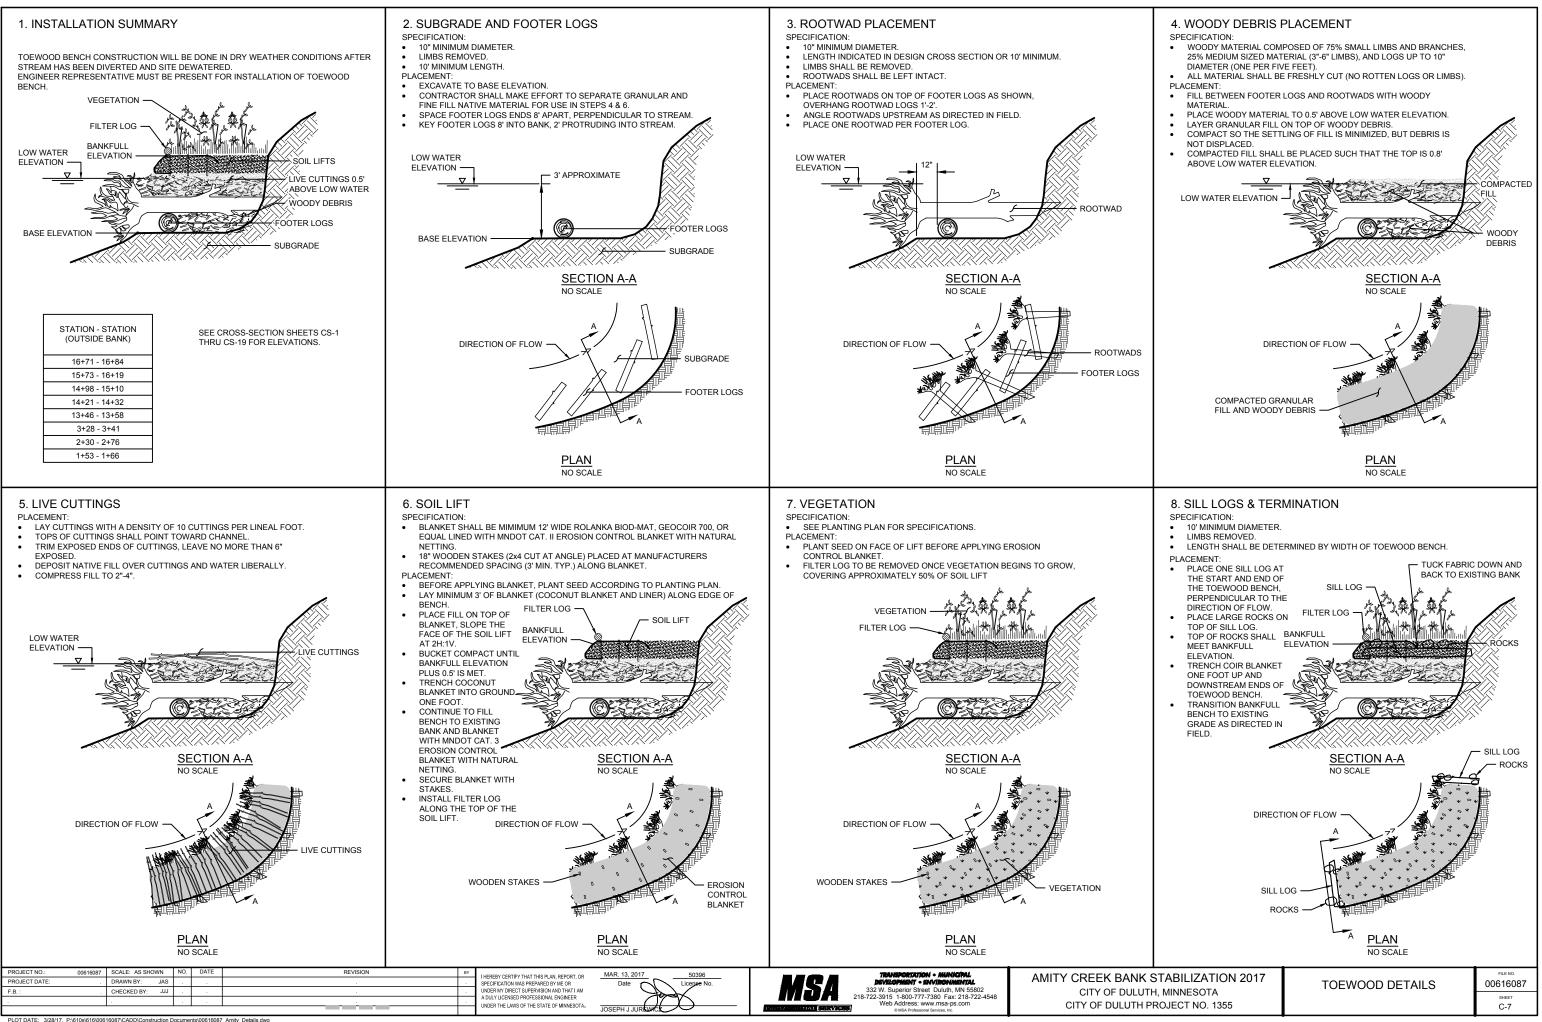


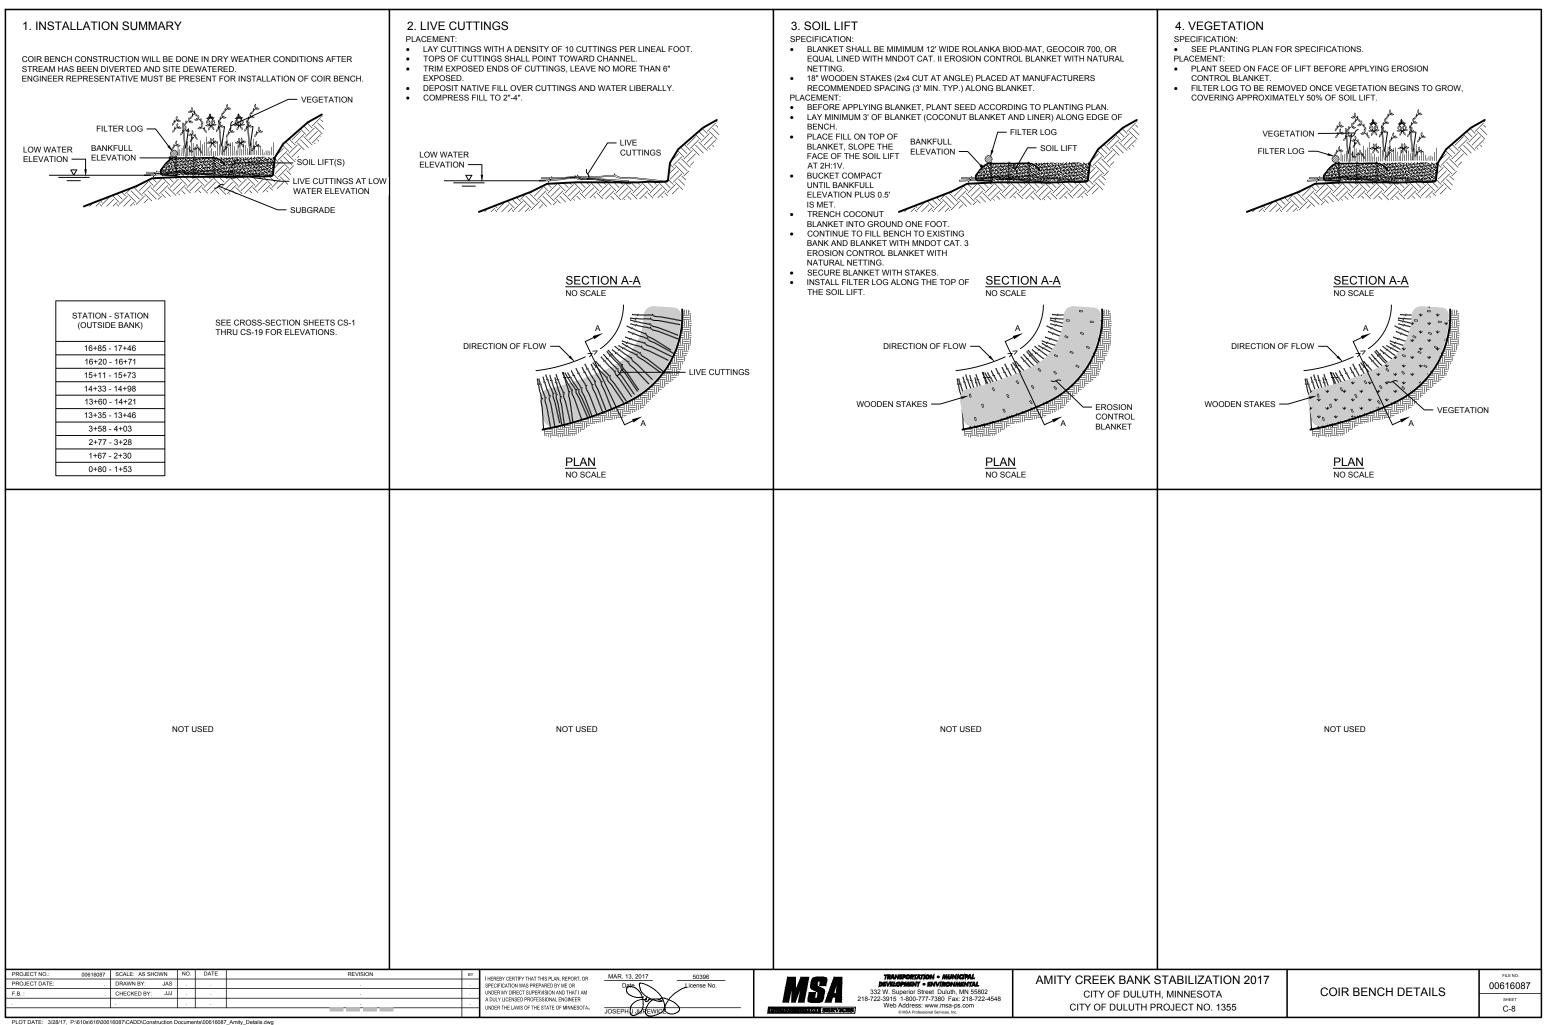


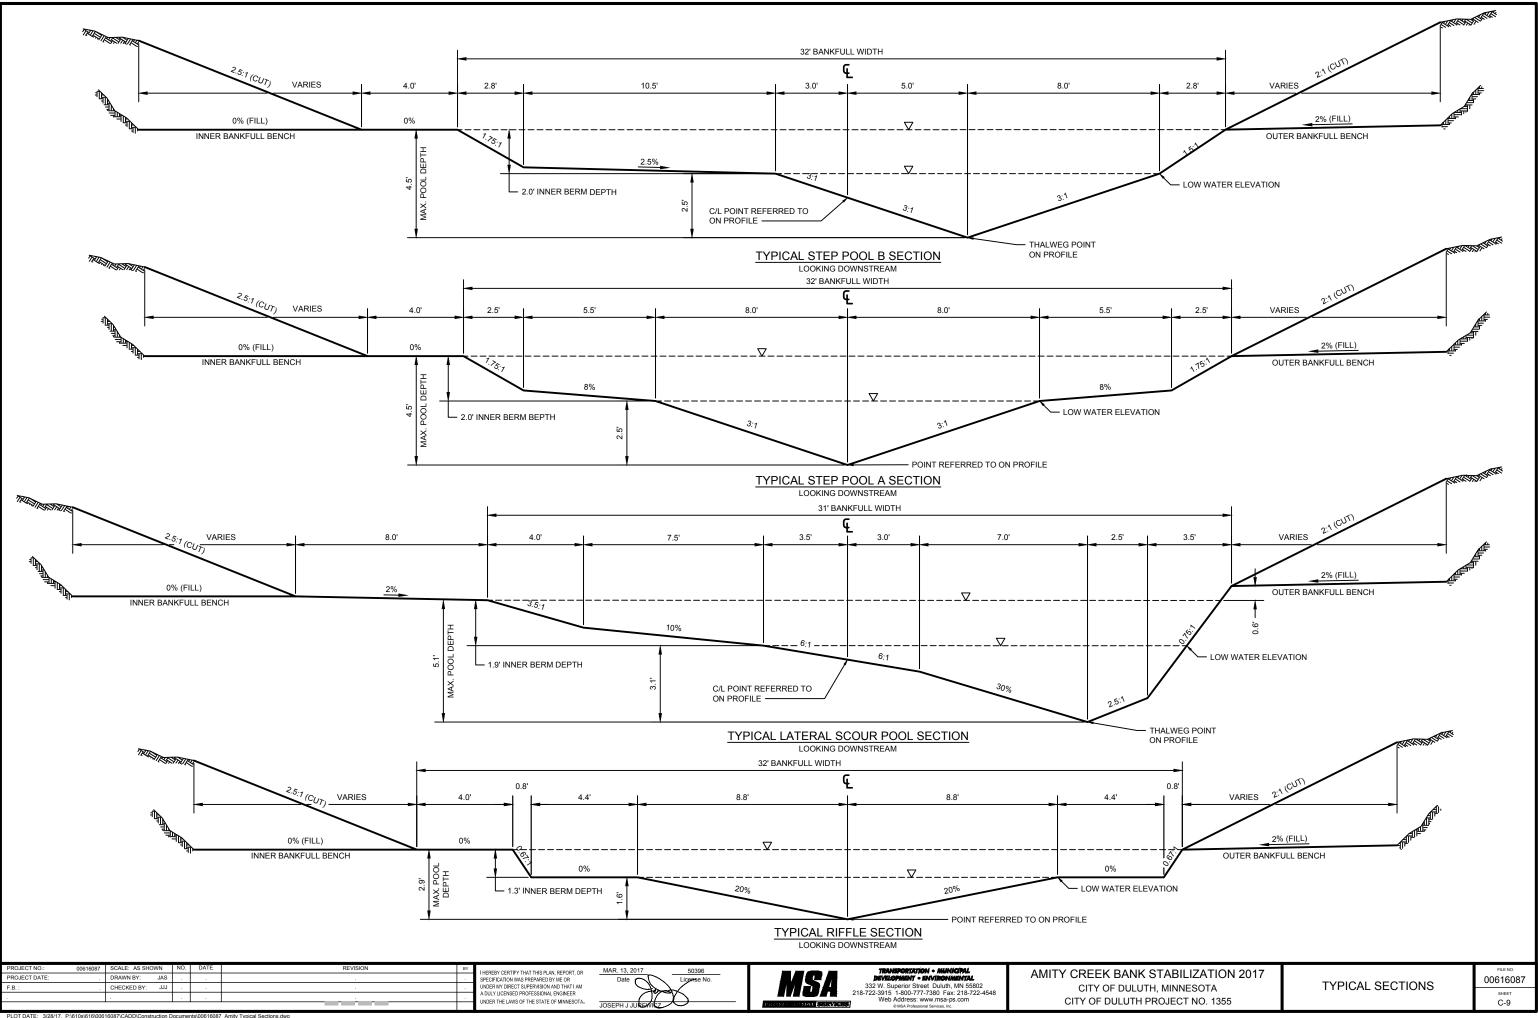


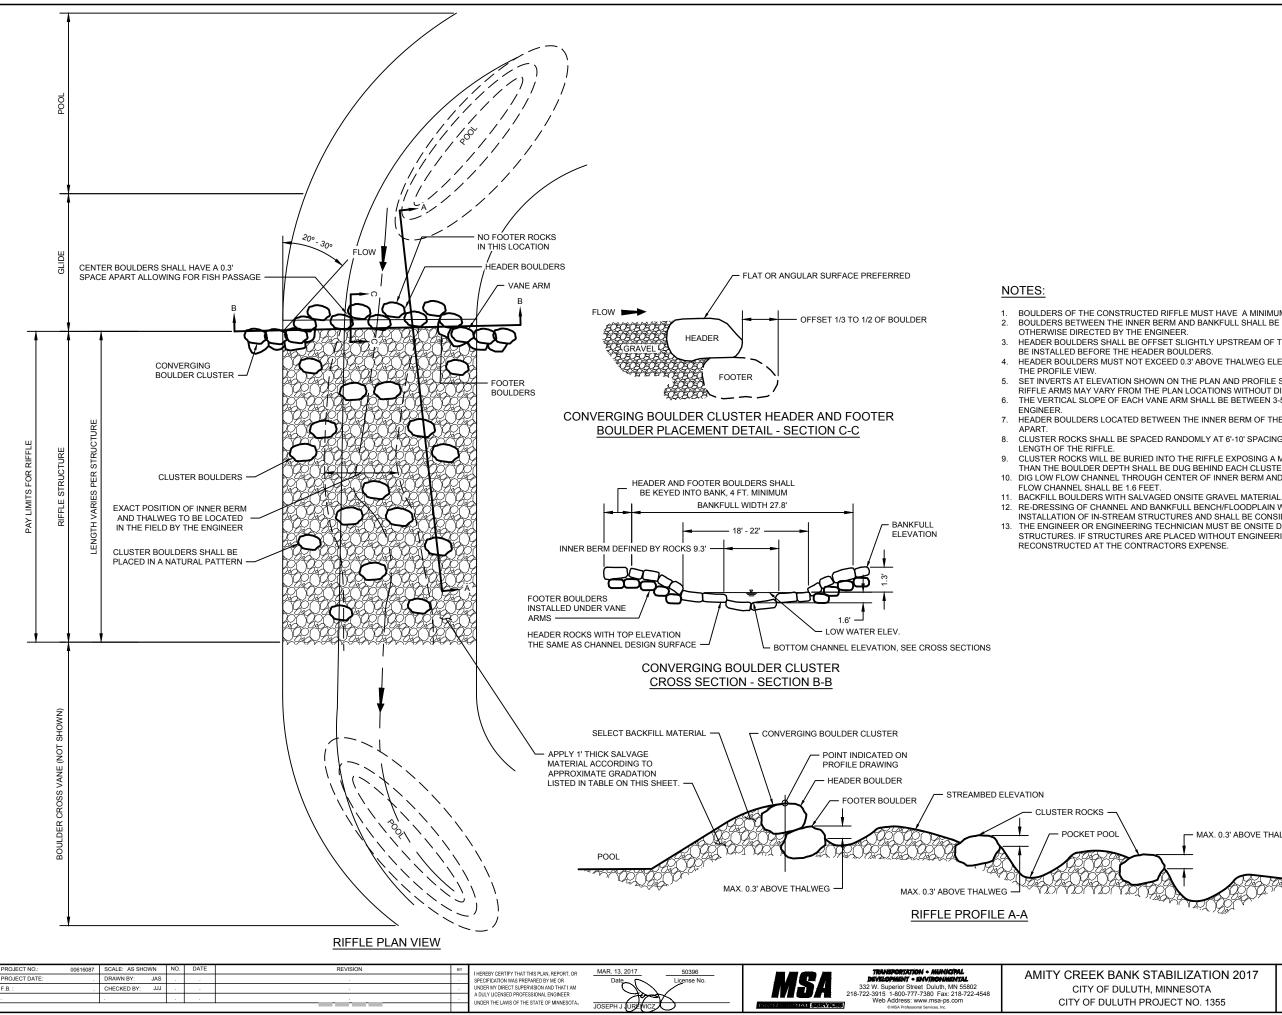
| DETAIL OF | BOULDER CROSS VANE |
|-----------|--------------------|
| PLAN VIEW | |

| PROJECT NO.: 00616087 | SCALE: AS SHOWN | NO. | DATE | REVISION | BY | LHEREBY CERTIEV THAT THIS PLAN REPORT OR | MAR. 13, 2017 50396 | | TRANSPORTATION . MUNICIPAL | |
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| F.B. : . | CHECKED BY: JJJ | | | | | UNDER MY DIRECT SUPERVISION AND THAT I AM | And A | | 332 W. Superior Street Duluth, MN 55802 | CITY OF DULUTH |
| | | | | | | A DULY LICENSED PROFESSIONAL ENGINEER UNDER THE LAWS OF THE STATE OF MINNESOTA. | | | 218-722-3915 1-800-777-7380 Fax: 218-722-4548 Web Address: www.msa-ps.com | CITY OF DULUTH PF |
| | | | | | | SNDER THE EAVIS OF THE STATE OF MINNESOTA. | JOSEPH J JUREWICE | PROFINSIONAL LERGY N | © MSA Professional Services, Inc. | |









PLOT DATE: 3/28/17. P:\610s\616\00616087\CADD\Construction Documents\00616087_Amity_Details.dwg

BOULDERS OF THE CONSTRUCTED RIFFLE MUST HAVE A MINIMUM DIAMETER OF 3 FEET. BOULDERS BETWEEN THE INNER BERM AND BANKFULL SHALL BE UNDERLAIN BY FOOTER BOULDERS UNLESS

HEADER BOULDERS SHALL BE OFFSET SLIGHTLY UPSTREAM OF THE FOOTER BOULDERS. FOOTER BOULDERS SHALL

HEADER BOULDERS MUST NOT EXCEED 0.3' ABOVE THALWEG ELEVATION. THE THALWEG ELEVATION IS SHOWN IN

SET INVERTS AT ELEVATION SHOWN ON THE PLAN AND PROFILE SHEETS. NO ELEVATIONS OF THE CONSTRUCTED RIFFLE ARMS MAY VARY FROM THE PLAN LOCATIONS WITHOUT DIRECTION FROM THE ENGINEER. THE VERTICAL SLOPE OF EACH VANE ARM SHALL BE BETWEEN 3-5% UNLESS OTHERWISE DIRECTED BY THE

HEADER BOULDERS LOCATED BETWEEN THE INNER BERM OF THE VANE WILL BE SPACED APPROXIMATELY 0.3'

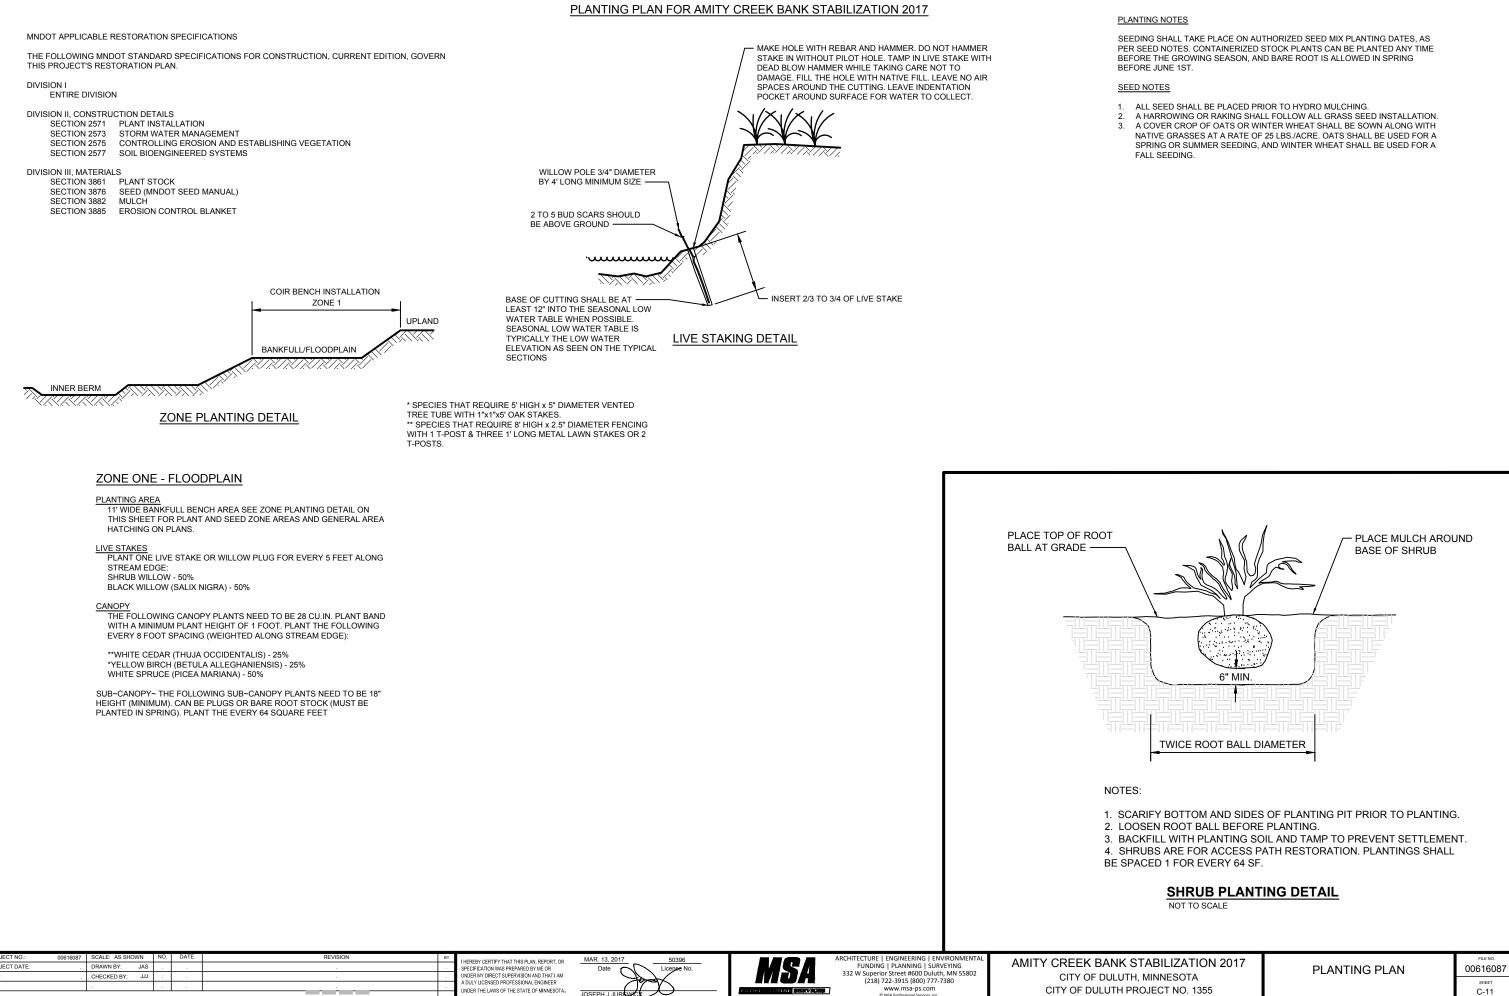
CLUSTER ROCKS SHALL BE SPACED RANDOMLY AT 6'-10' SPACING WITHIN THE INNER BERM AND THROUGHOUT THE LENGTH OF THE RIFFLE.

CLUSTER ROCKS WILL BE BURIED INTO THE RIFFLE EXPOSING A MAXIMUM OF 0.3'. A POCKET POOL NO DEEPER THAN THE BOULDER DEPTH SHALL BE DUG BEHIND EACH CLUSTER BOULDER. 10. DIG LOW FLOW CHANNEL THROUGH CENTER OF INNER BERM AND AVOIDING ALL CLUSTER ROCKS. DEPTH OF LOW

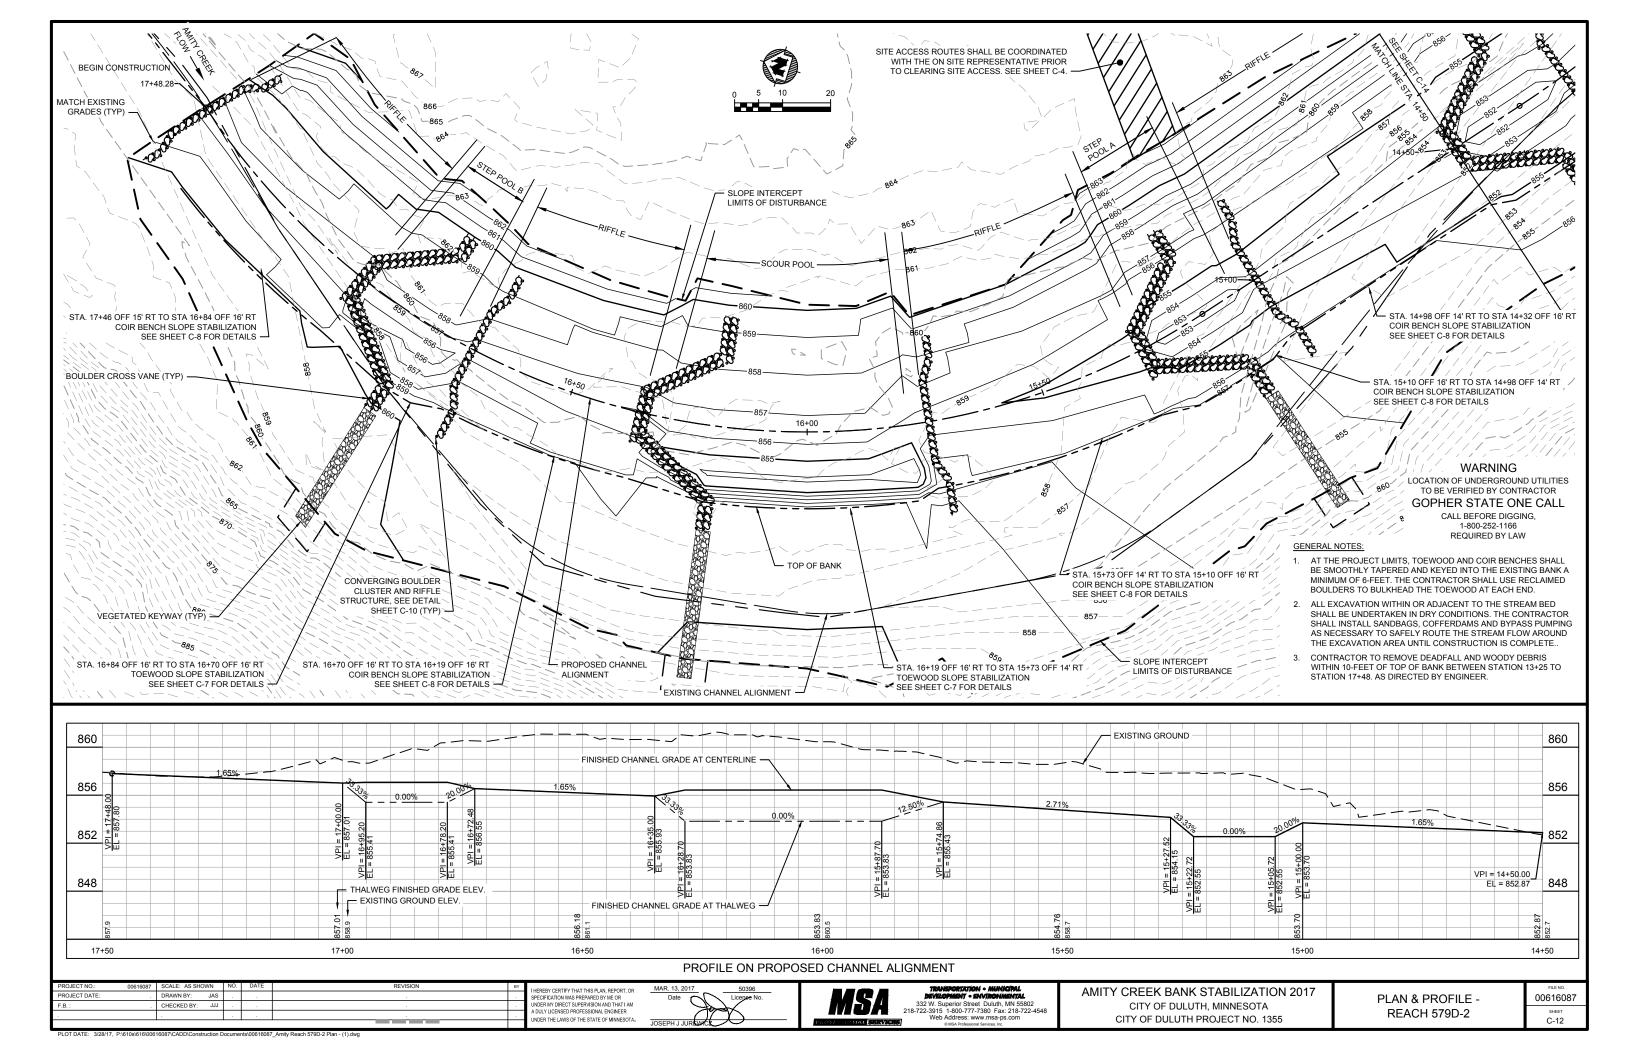
12. RE-DRESSING OF CHANNEL AND BANKFULL BENCH/FLOODPLAIN WILL LIKELY BE REQUIRED FOLLOWING

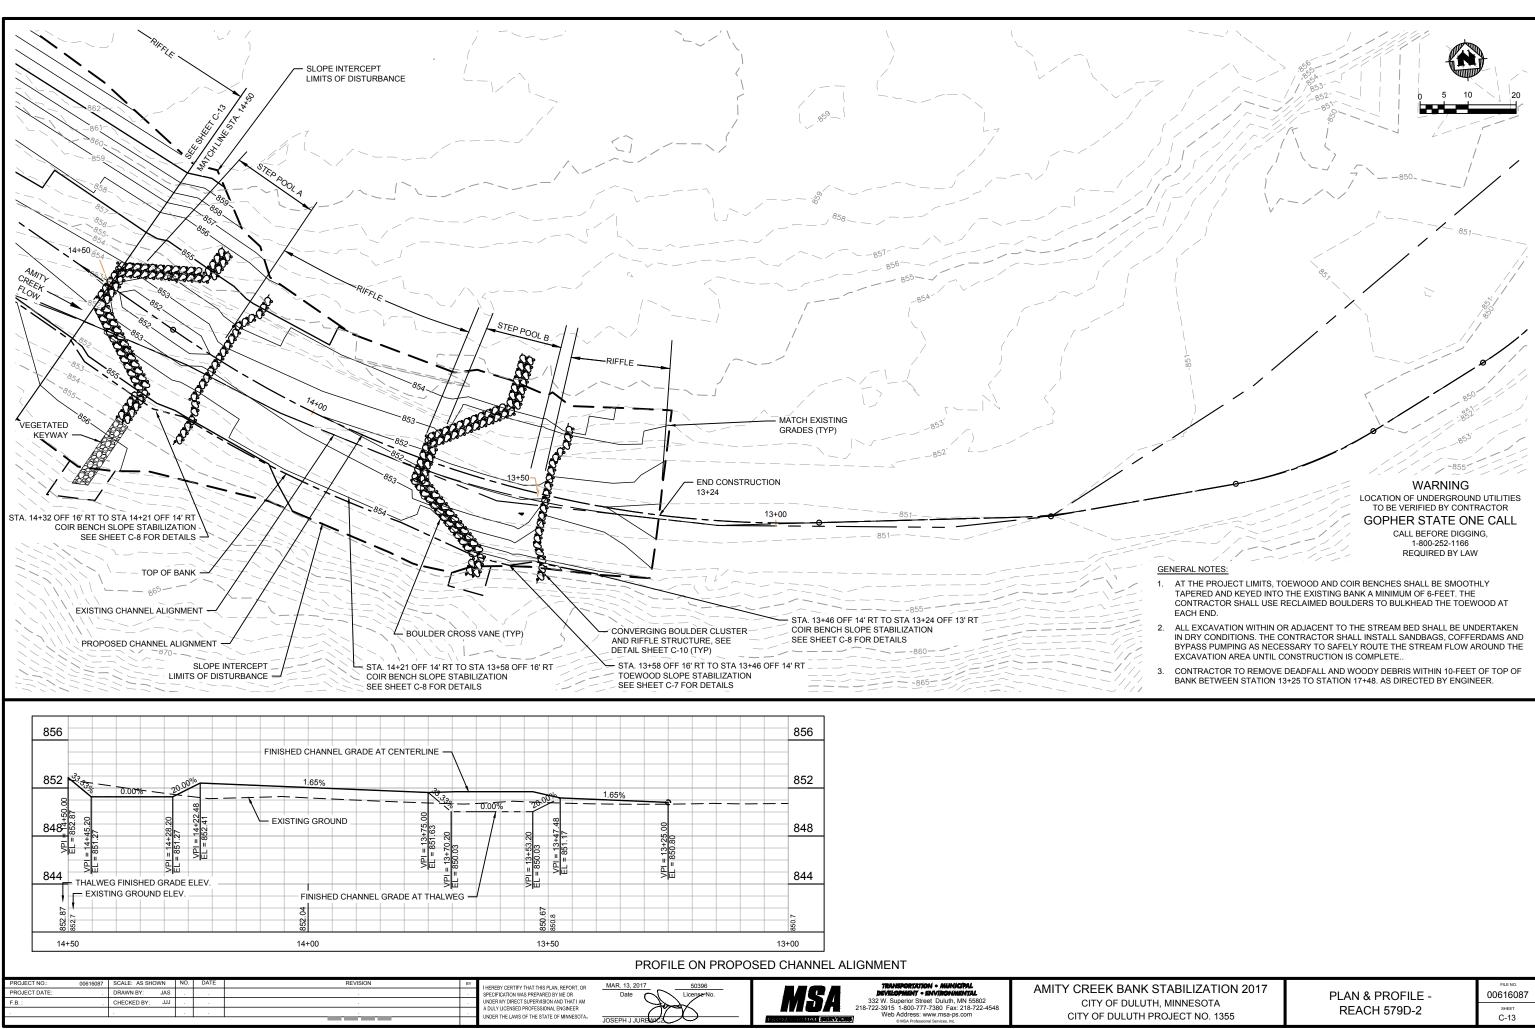
INSTALLATION OF IN-STREAM STRUCTURES AND SHALL BE CONSIDERED INCIDENTAL TO CONSTRUCTION. 13. THE ENGINEER OR ENGINEERING TECHNICIAN MUST BE ONSITE DURING THE PLACEMENT OF ALL IN STREAM STRUCTURES. IF STRUCTURES ARE PLACED WITHOUT ENGINEERING APPROVAL, THEY MAY BE REQUIRED TO BE

- MAX. 0.3' ABOVE THALWEG

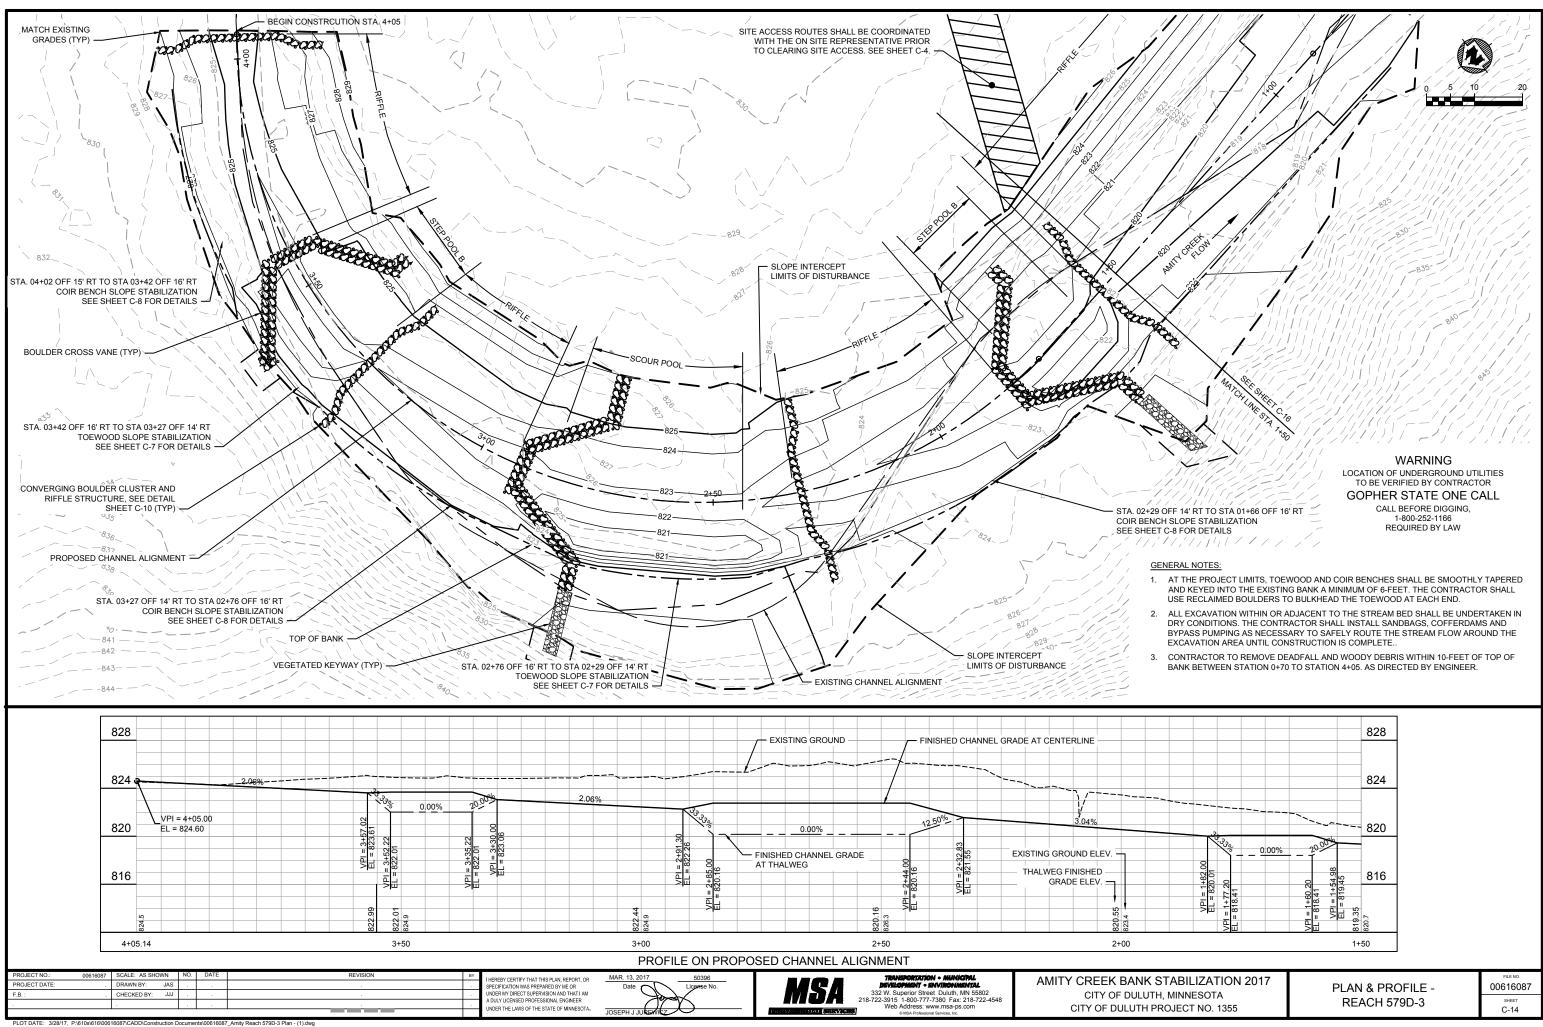


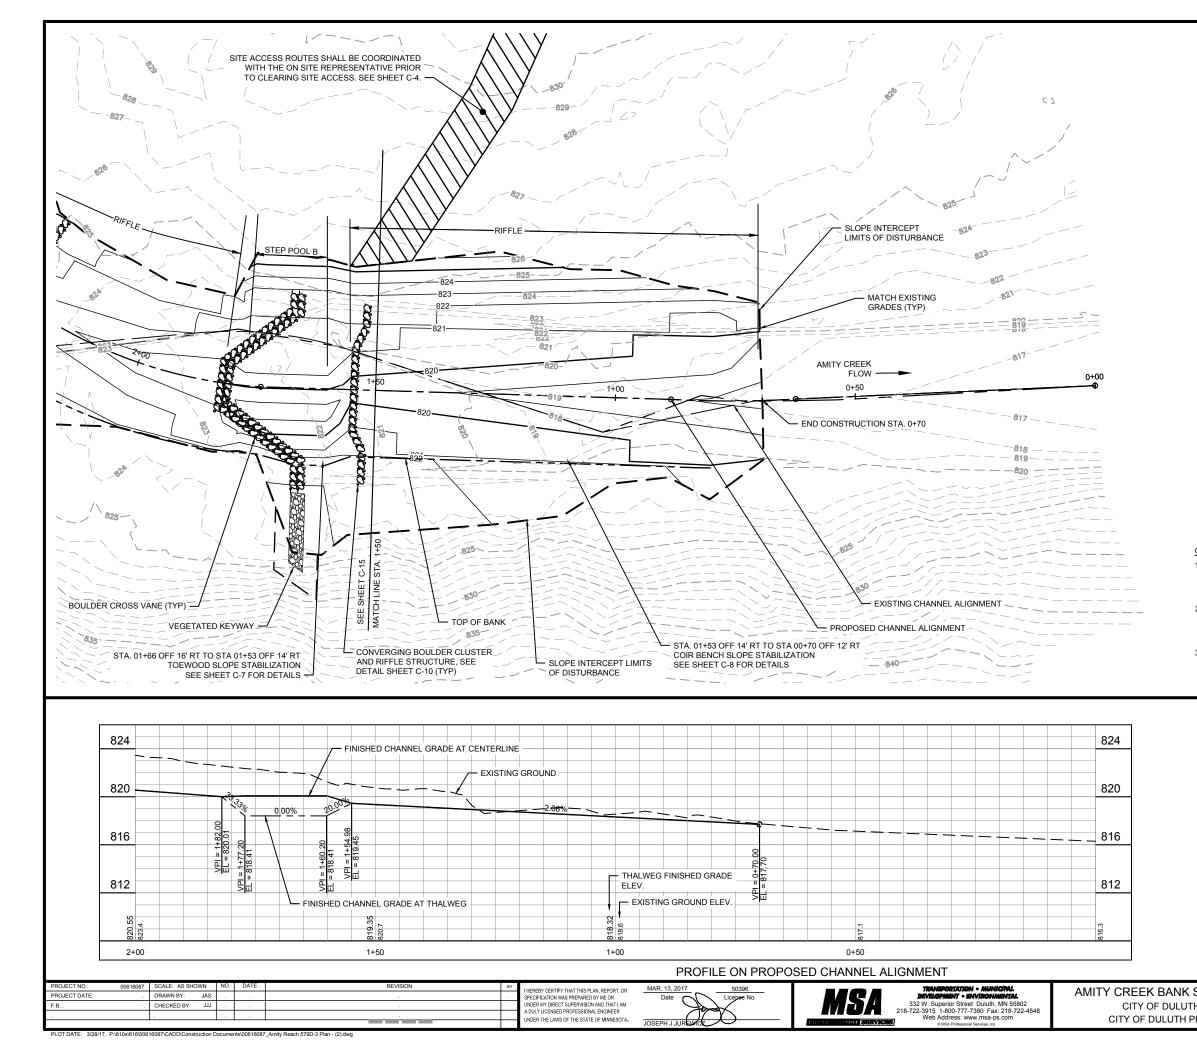
| STABILIZATION 2017 | PLANTING PLAN | FILE NO. | 1 | |
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| ⁻ H, MINNESOTA PROJECT NO. 1355 | | SHEET C-11 | | |

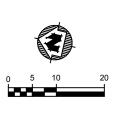




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| | REACH 579D-2 | SHEET |
| H PROJECT NO. 1355 | | C-13 |







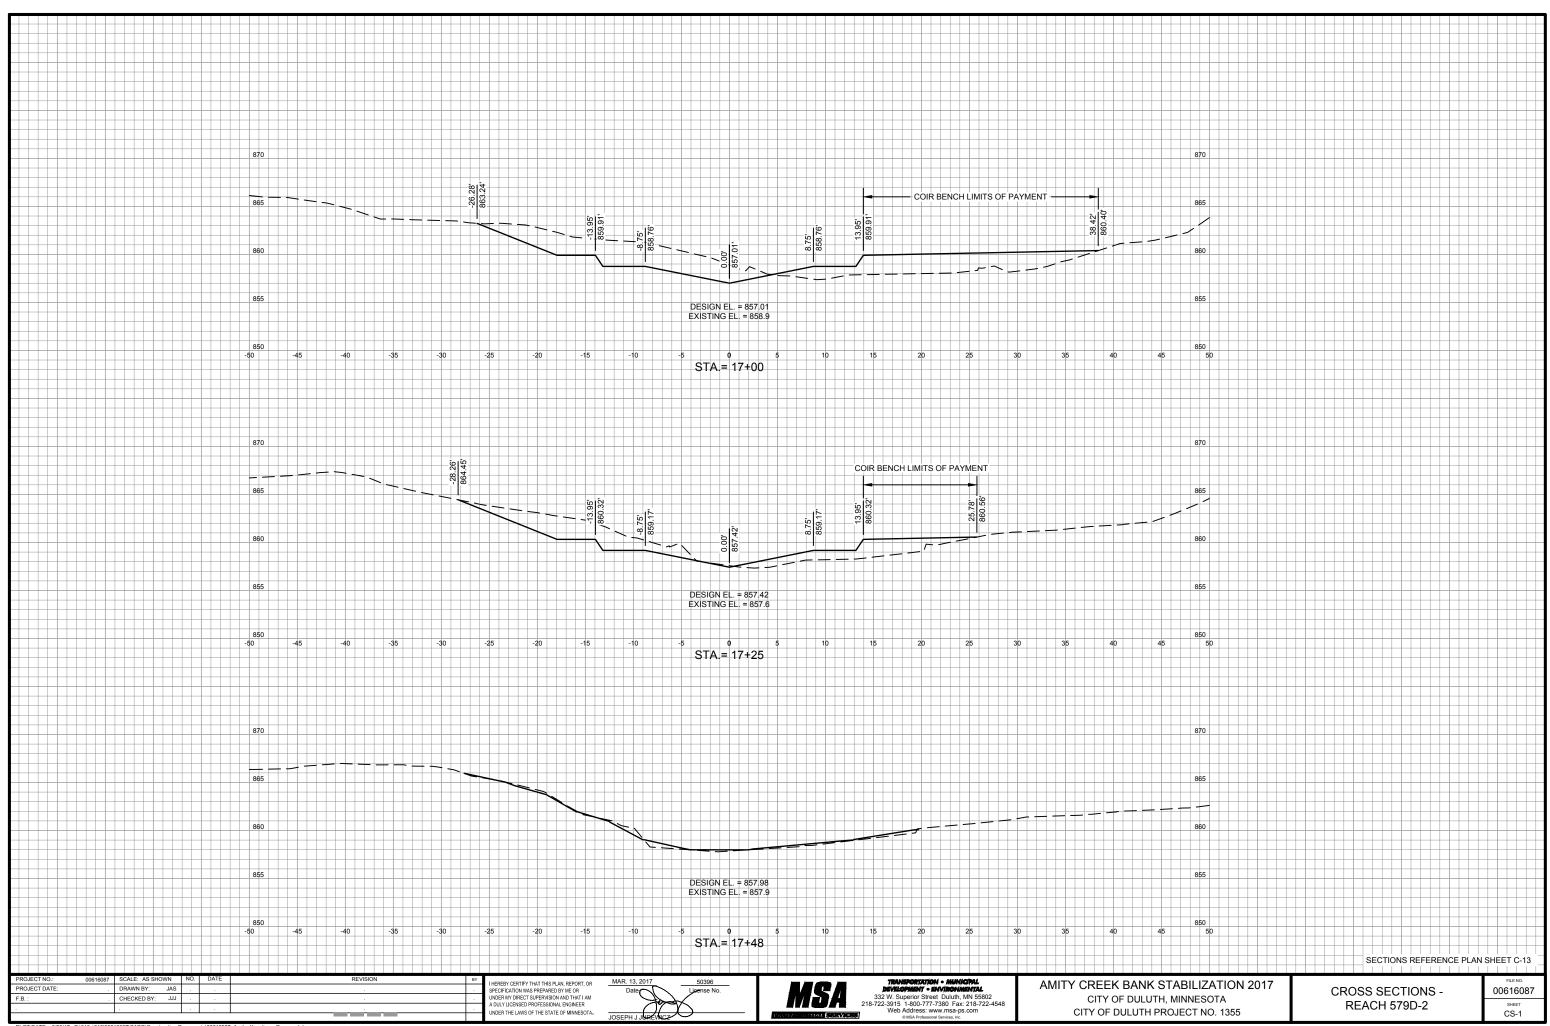
WARNING LOCATION OF UNDERGROUND UTILITIES TO BE VERIFIED BY CONTRACTOR GOPHER STATE ONE CALL CALL BEFORE DIGGING, 1-800-252-1166 REQUIRED BY LAW

GENERAL NOTES:

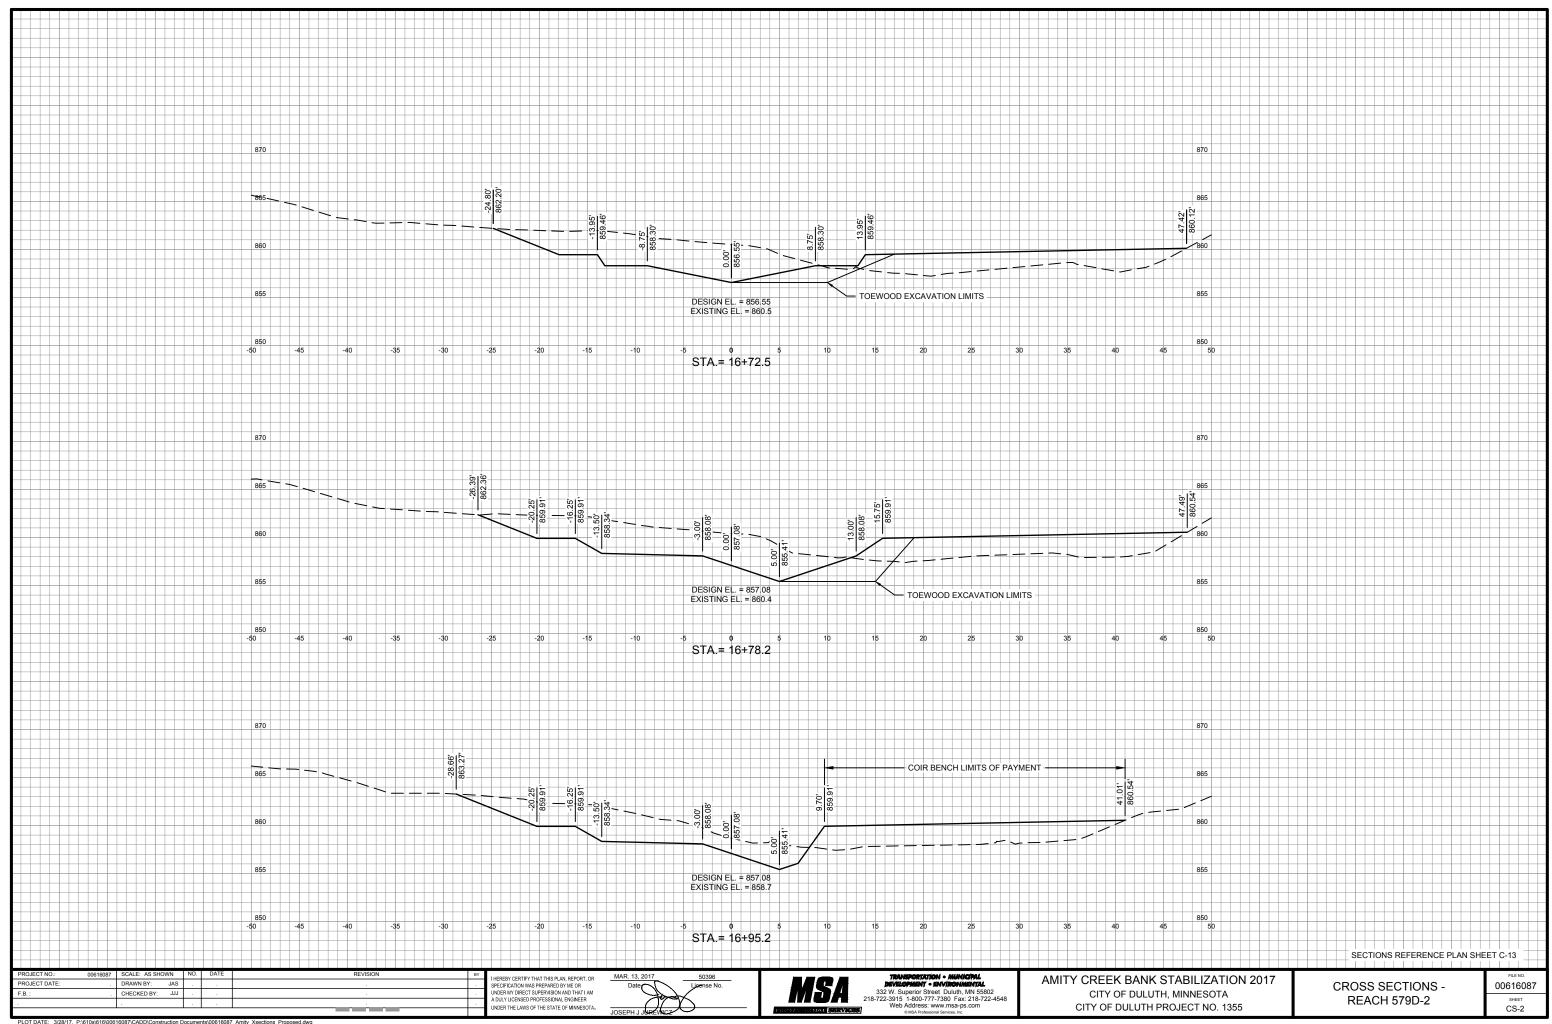
- 1. AT THE PROJECT LIMITS, TOEWOOD AND COIR BENCHES SHALL BE SMOOTHLY TAPERED AND KEYED INTO THE EXISTING BANK A MINIMUM OF 6-FEET. THE CONTRACTOR SHALL USE RECLAIMED BOULDERS TO BULKHEAD THE TOEWOOD AT EACH END.
- 2. ALL EXCAVATION WITHIN OR ADJACENT TO THE STREAM BED SHALL BE UNDERTAKEN IN DRY CONDITIONS. THE CONTRACTOR SHALL INSTALL SANDBAGS, COFFERDAMS AND BYPASS PUMPING AS NECESSARY TO SAFELY ROUTE THE STREAM FLOW AROUND THE EXCAVATION AREA UNTIL CONSTRUCTION IS COMPLETE...
- 3. CONTRACTOR TO REMOVE DEADFALL AND WOODY DEBRIS WITHIN 10-FEET OF TOP OF BANK BETWEEN STATION 0+70 TO STATION 4+05. AS DIRECTED BY ENGINEER.

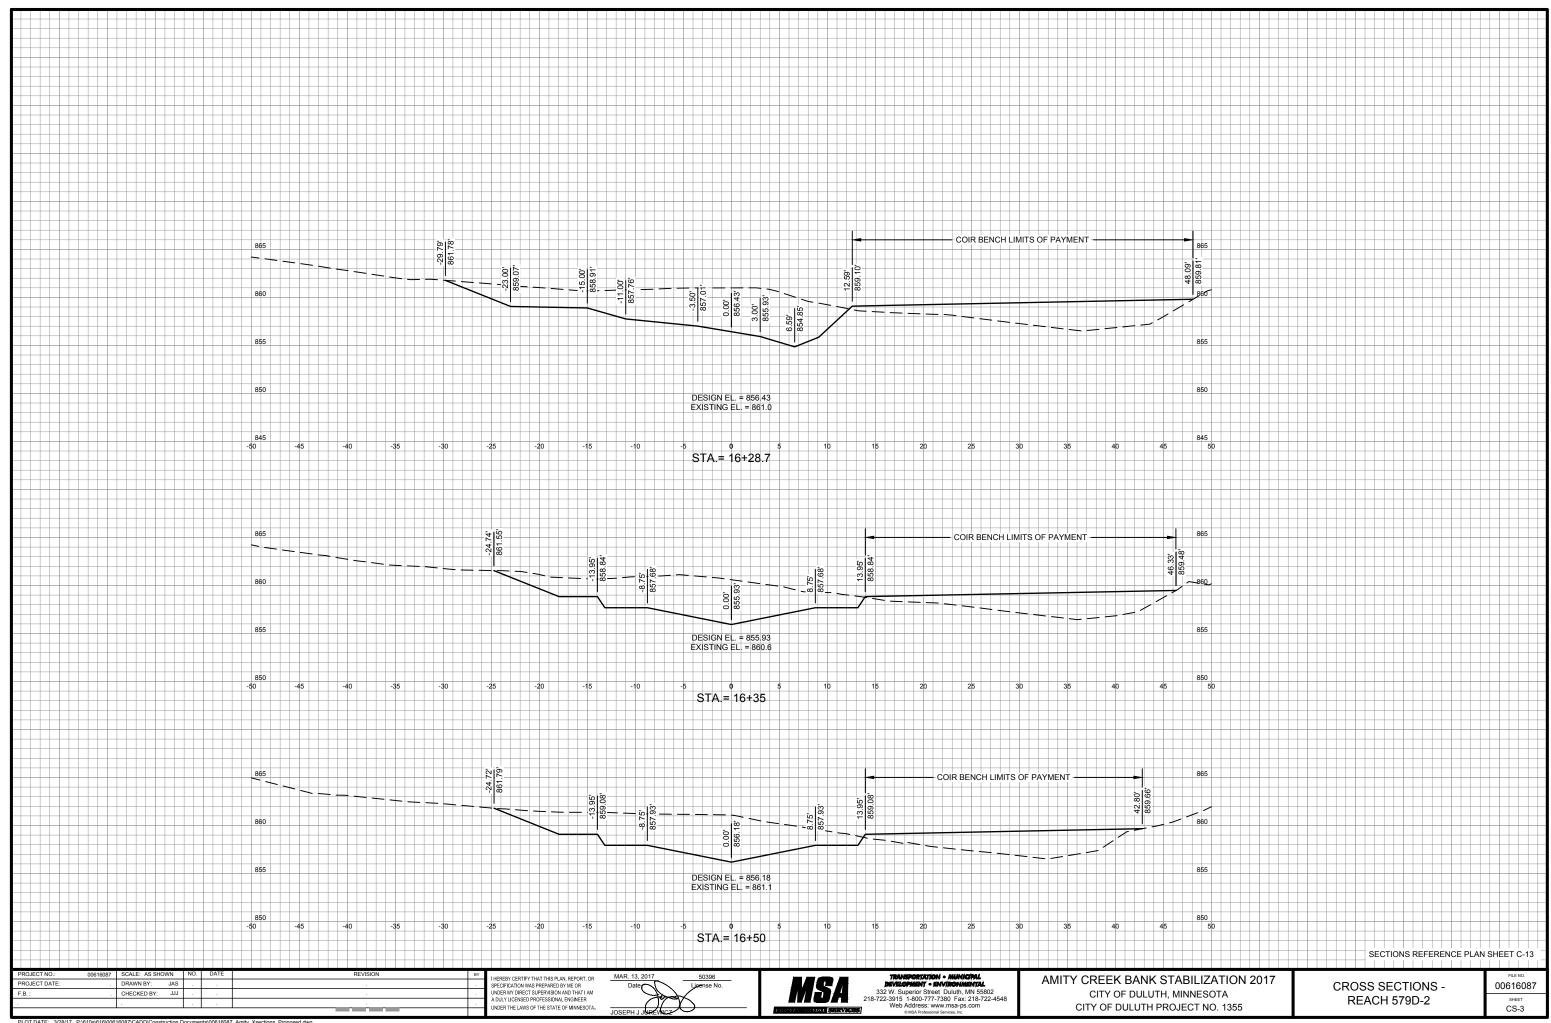
| STABILIZATION 2017 |
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| H, MINNESOTA |
| ROJECT NO. 1355 |

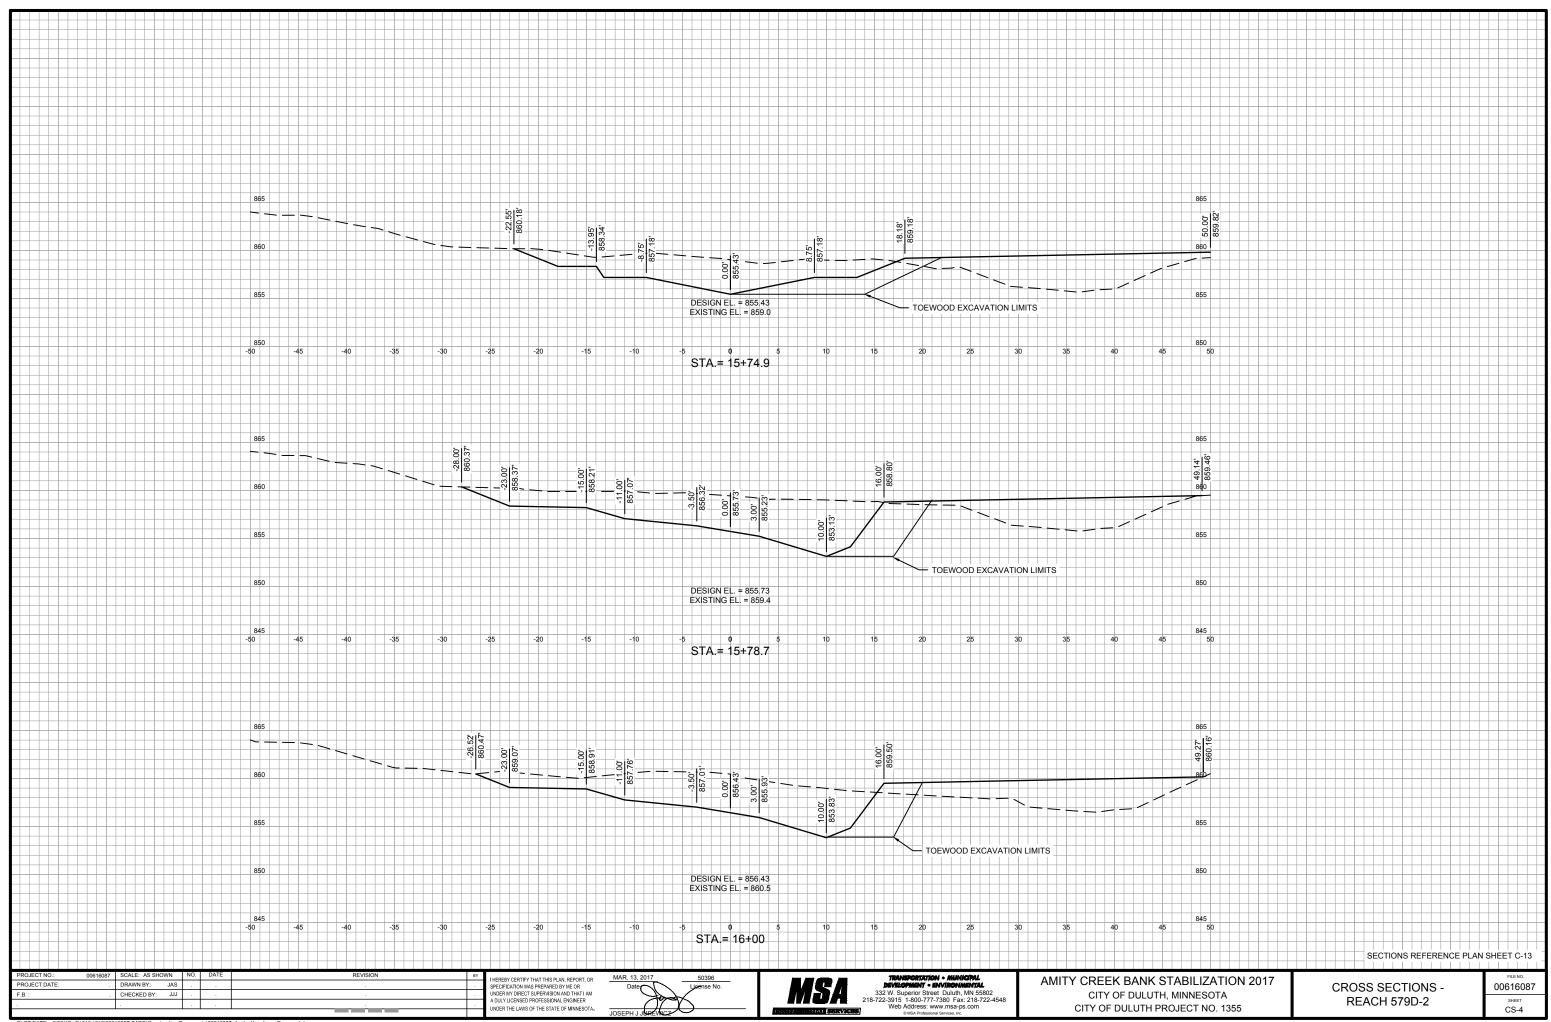
PLAN & PROFILE -REACH 579D-3



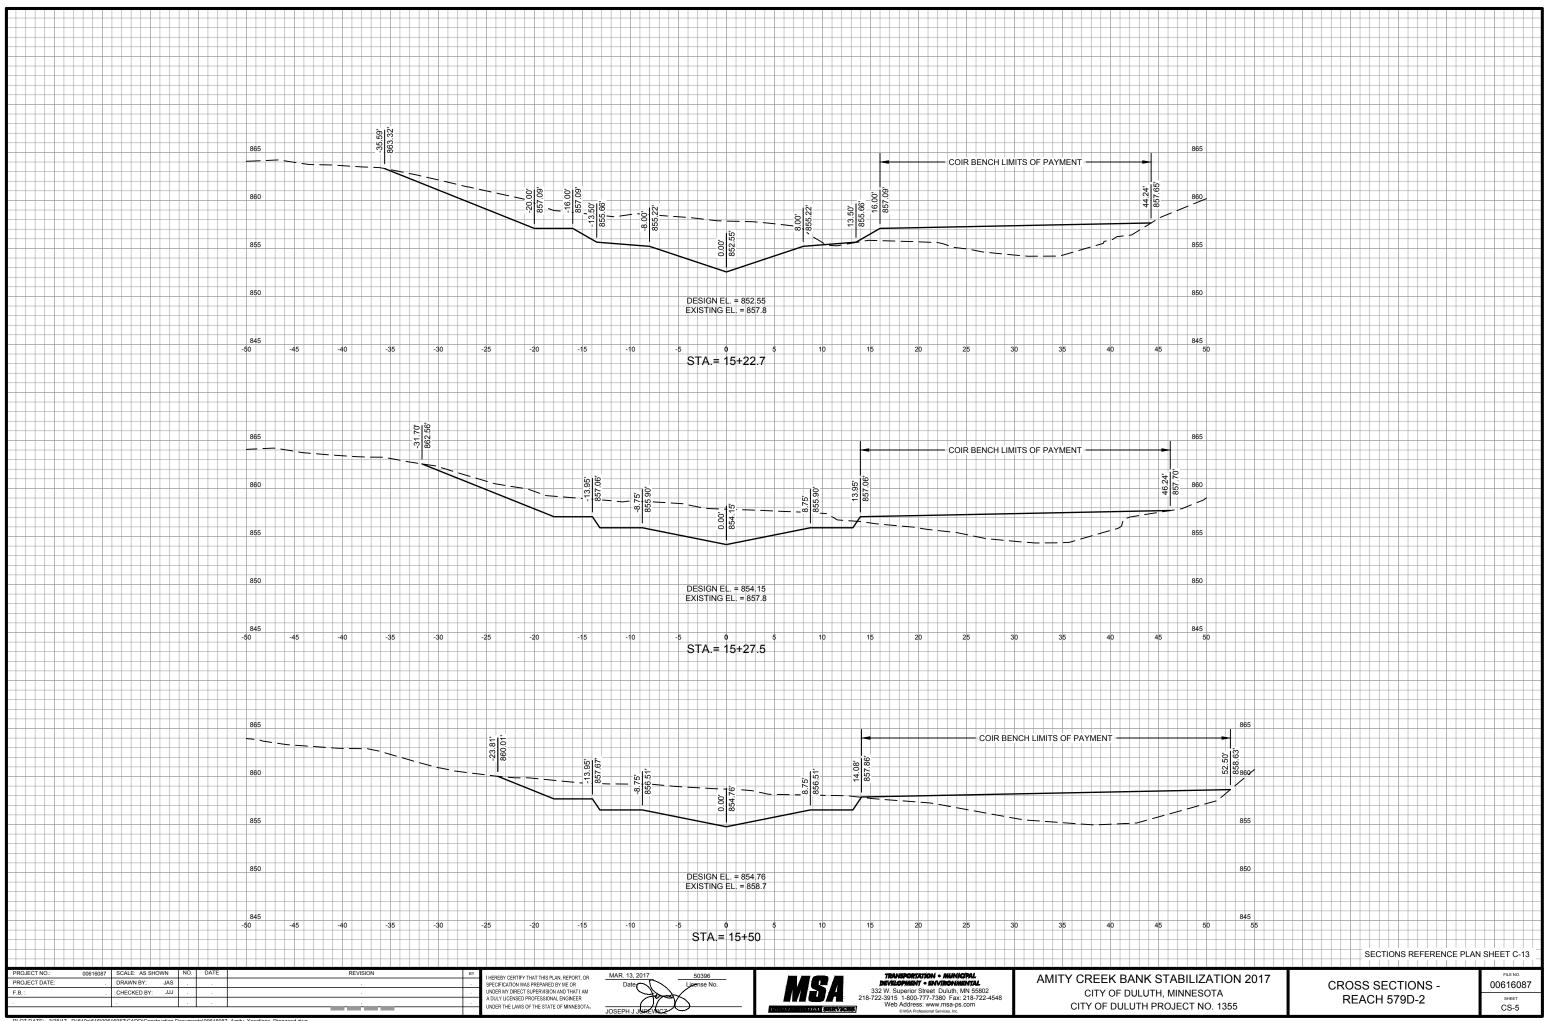
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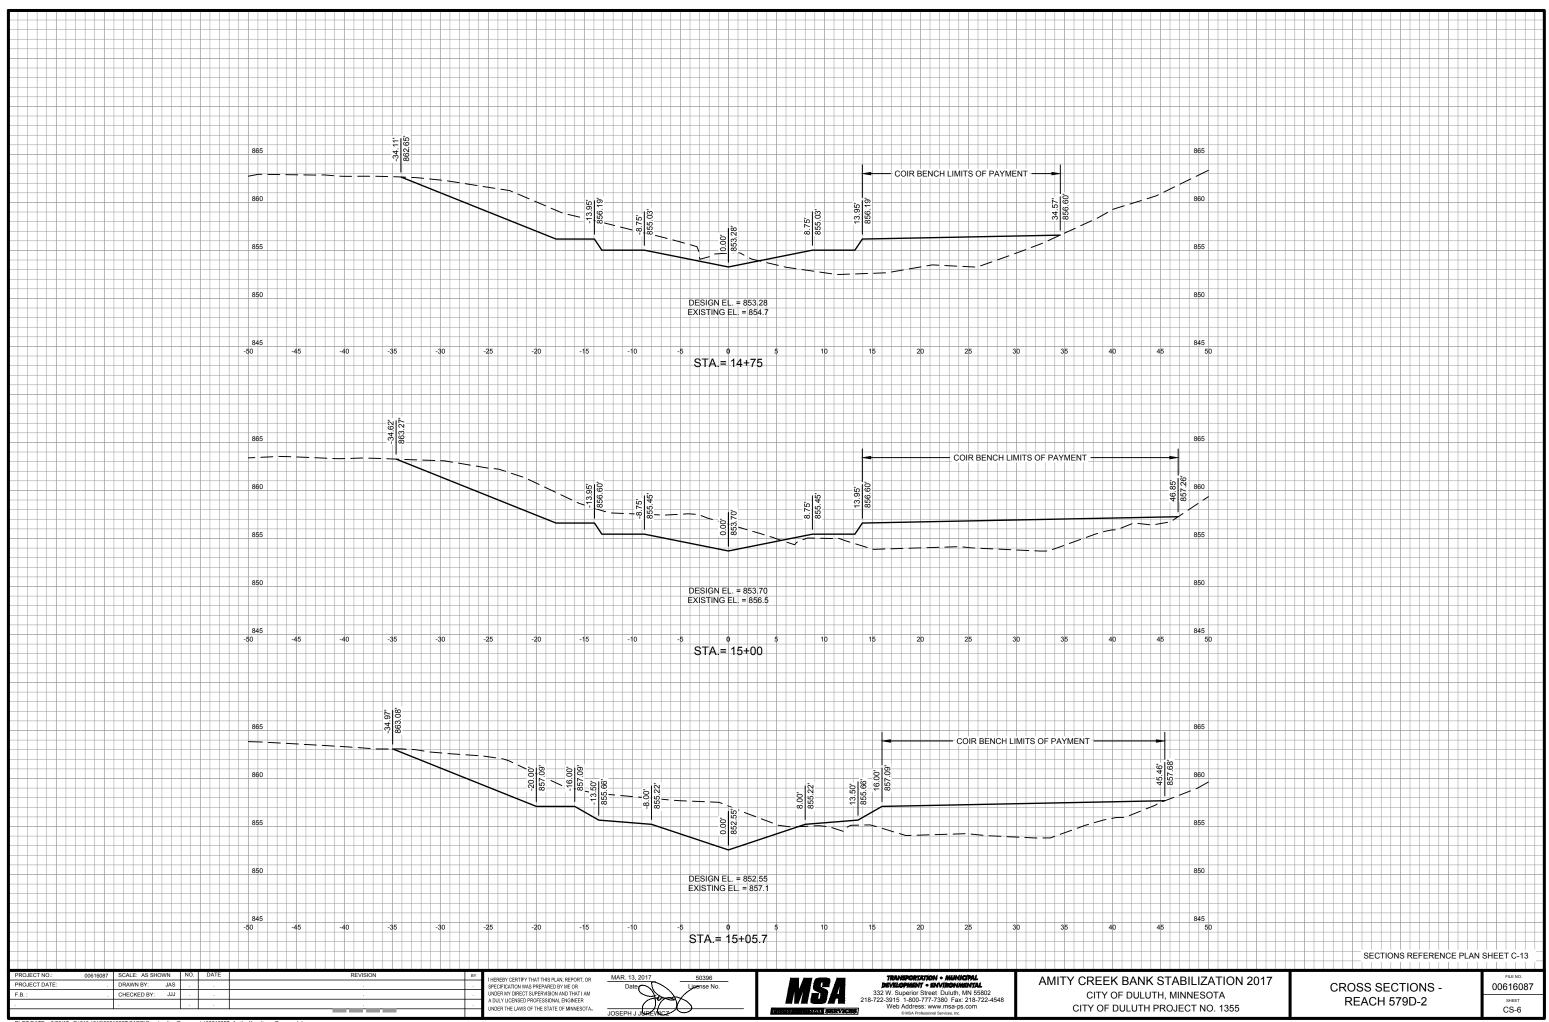


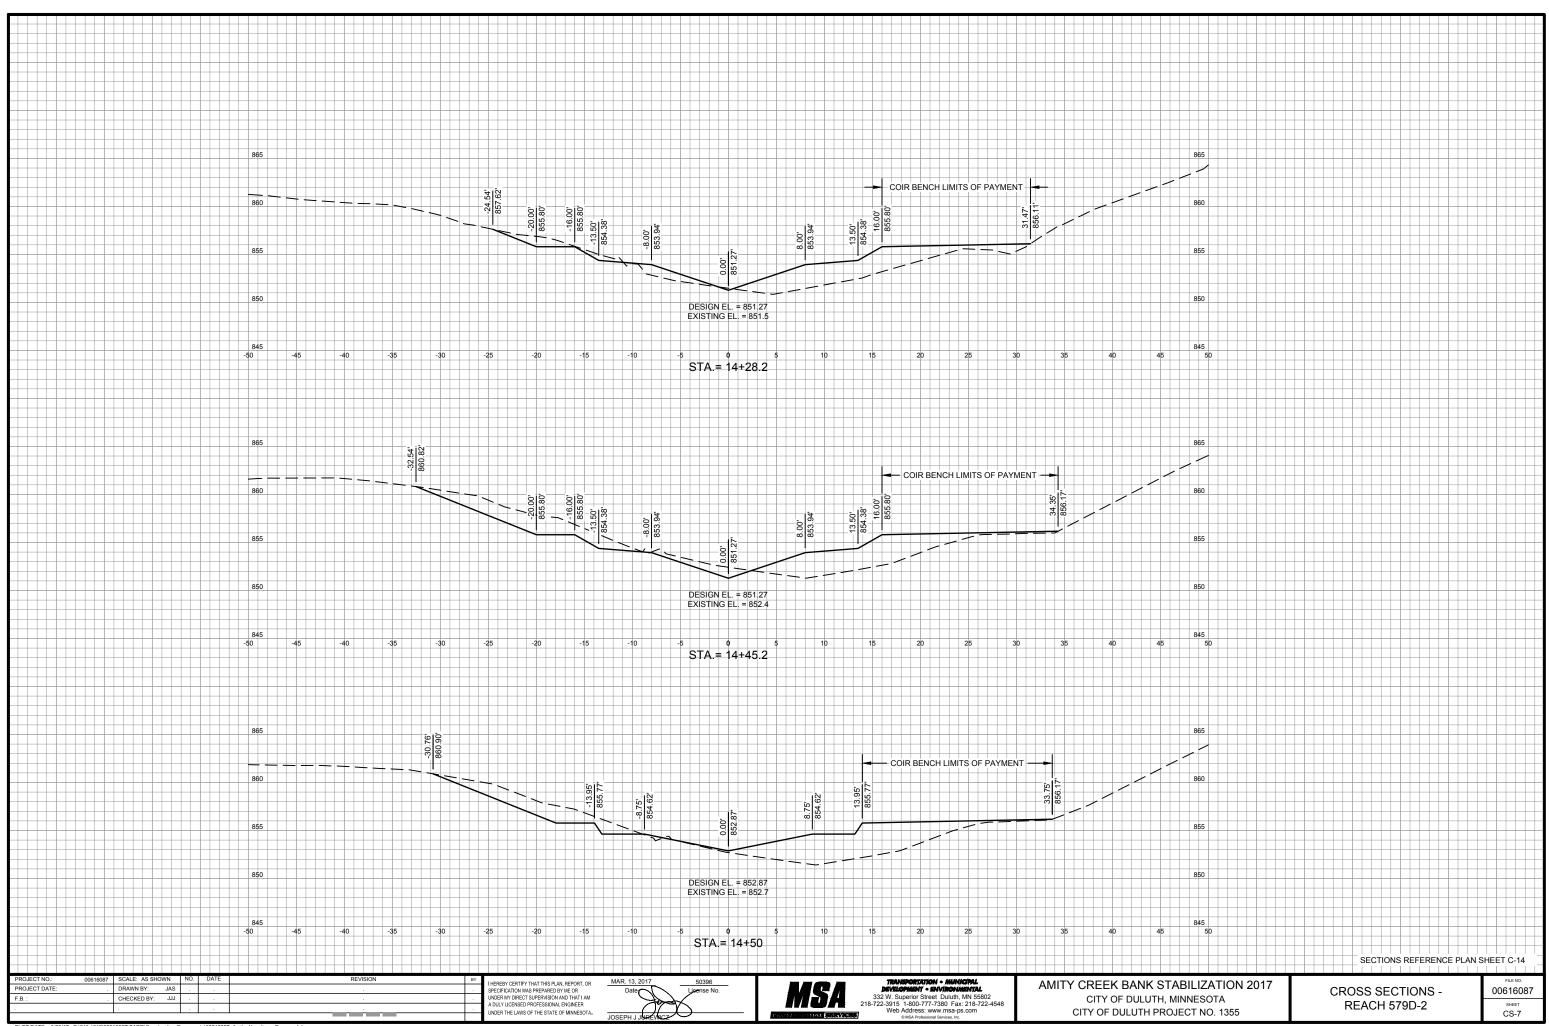




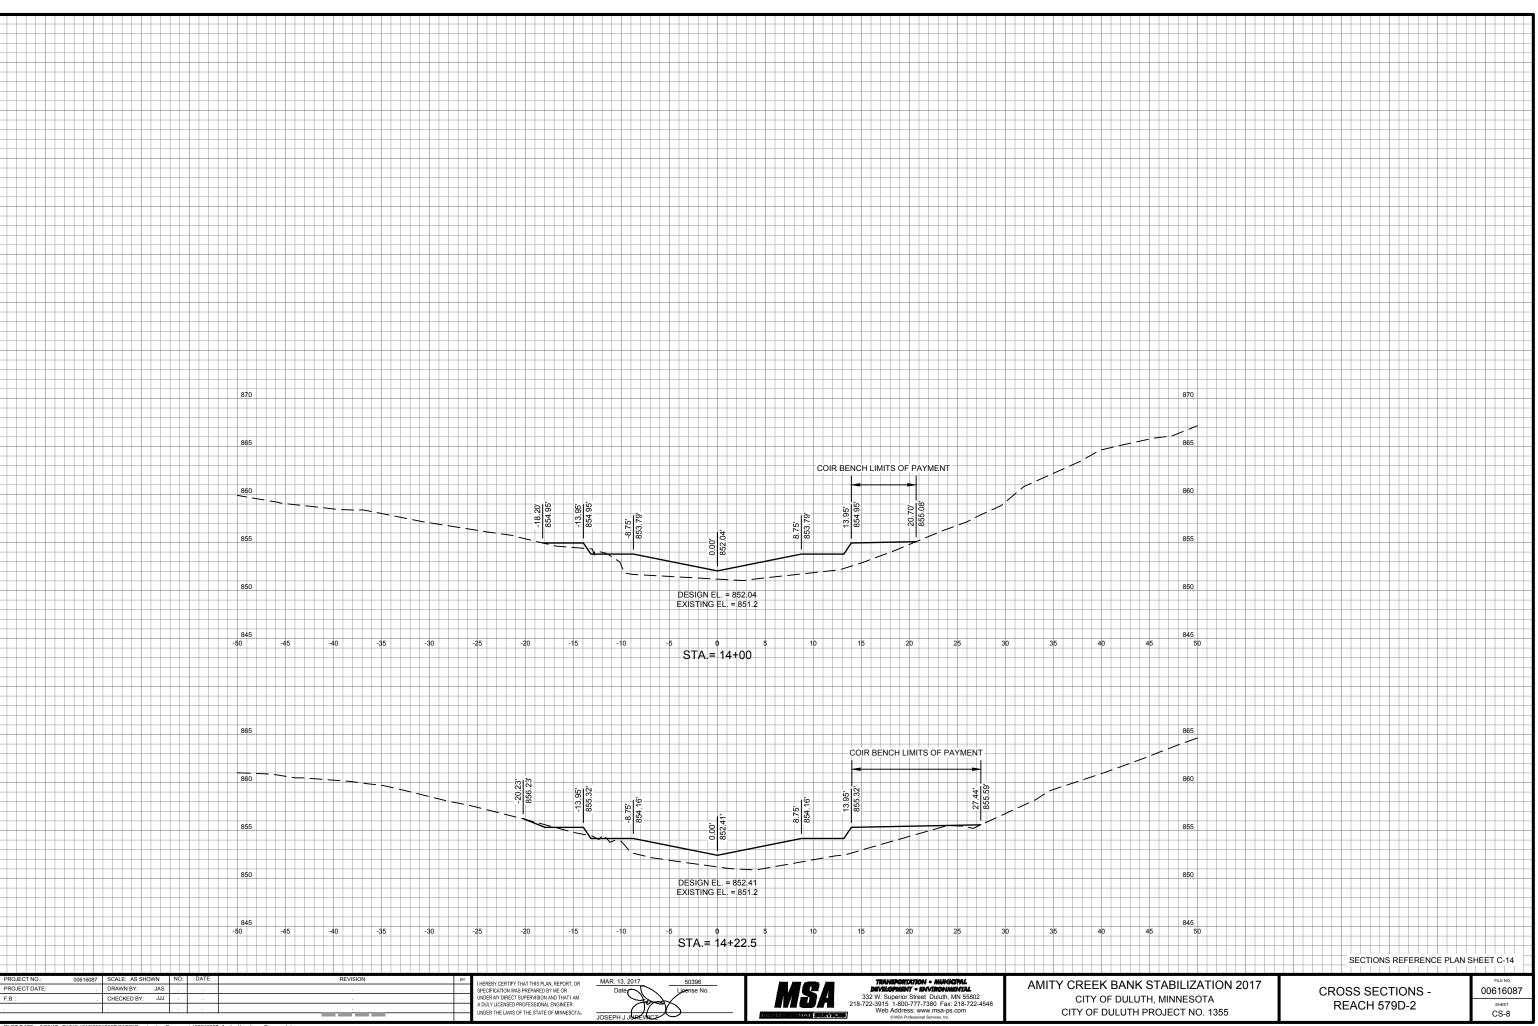
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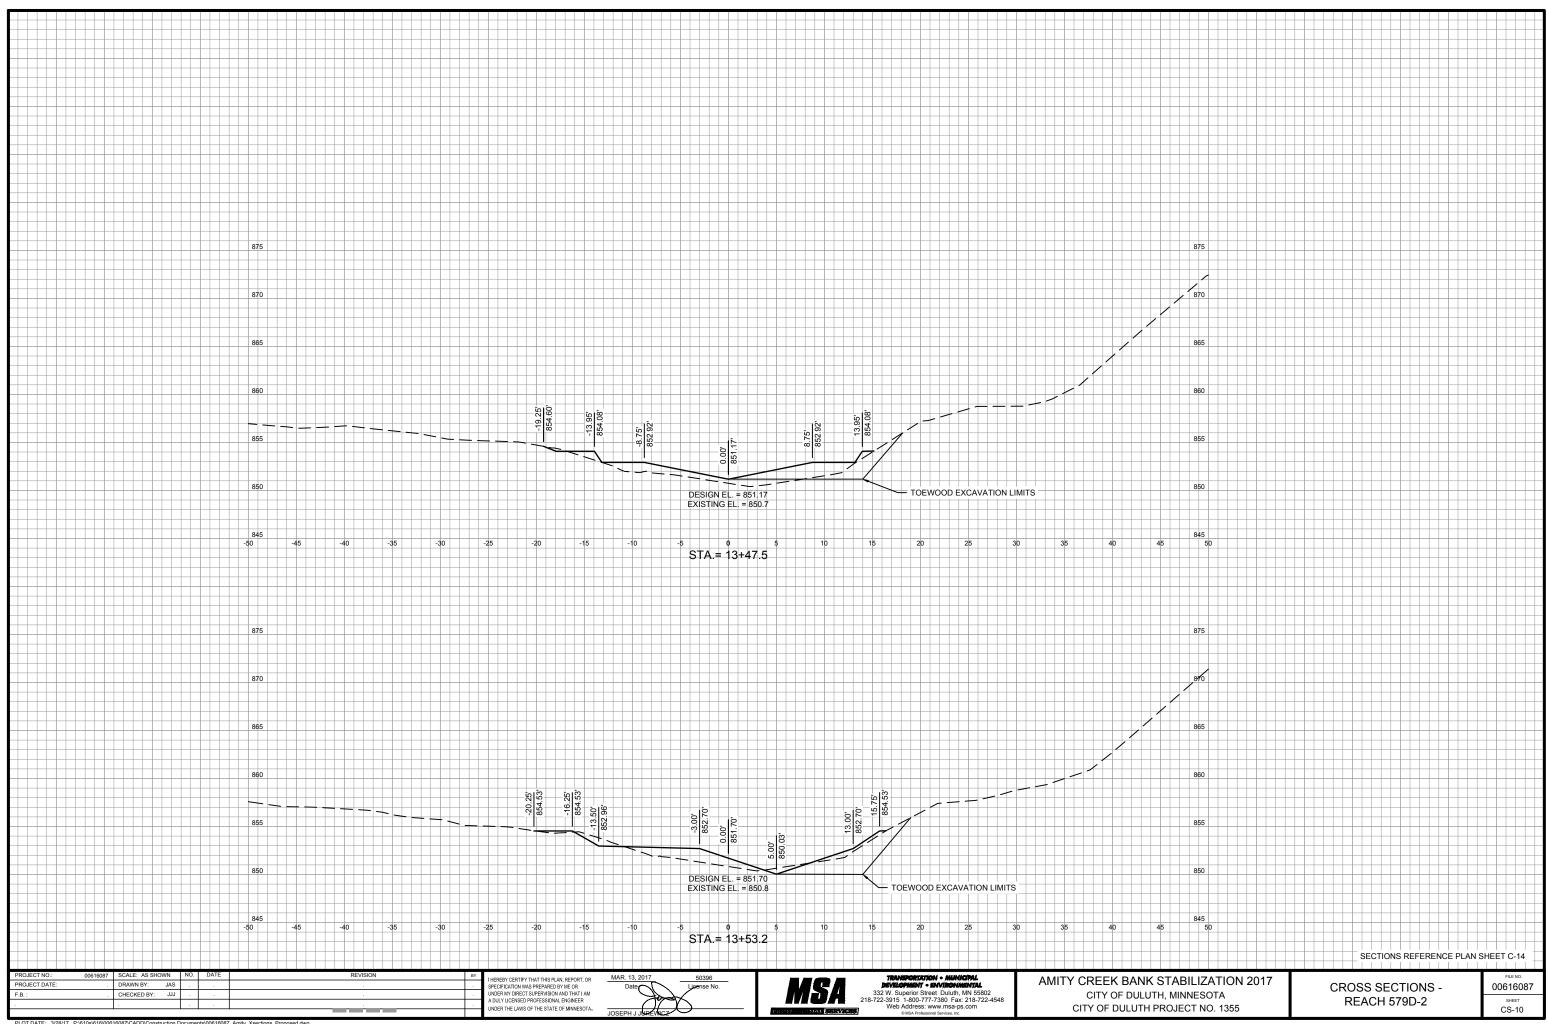


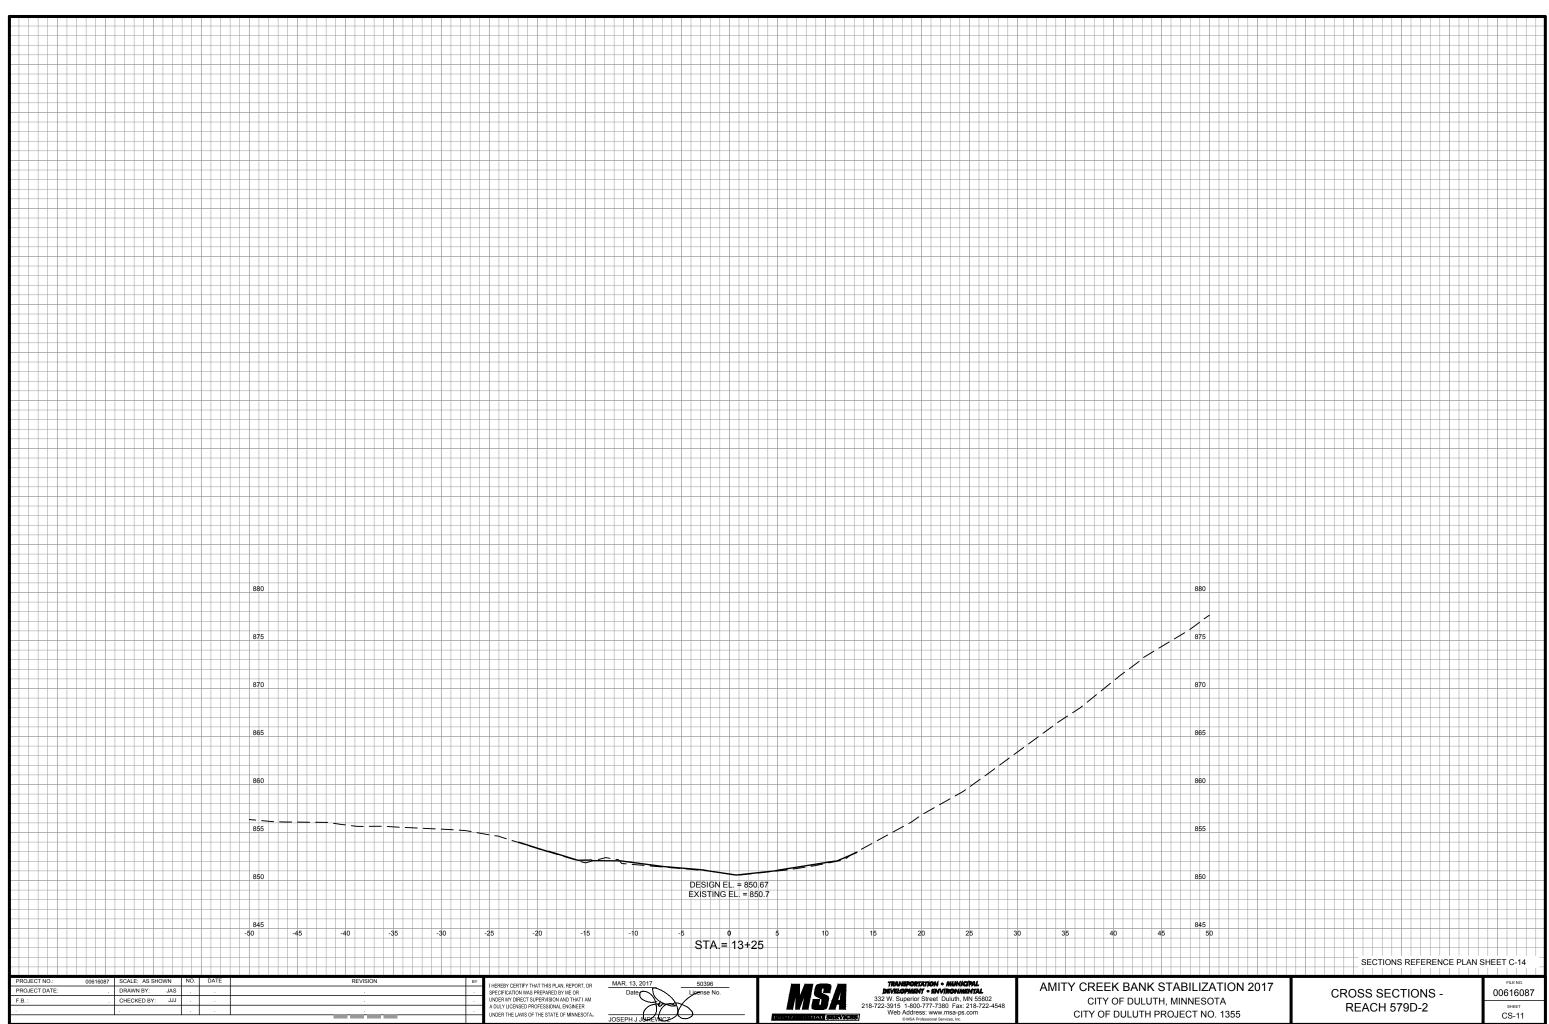


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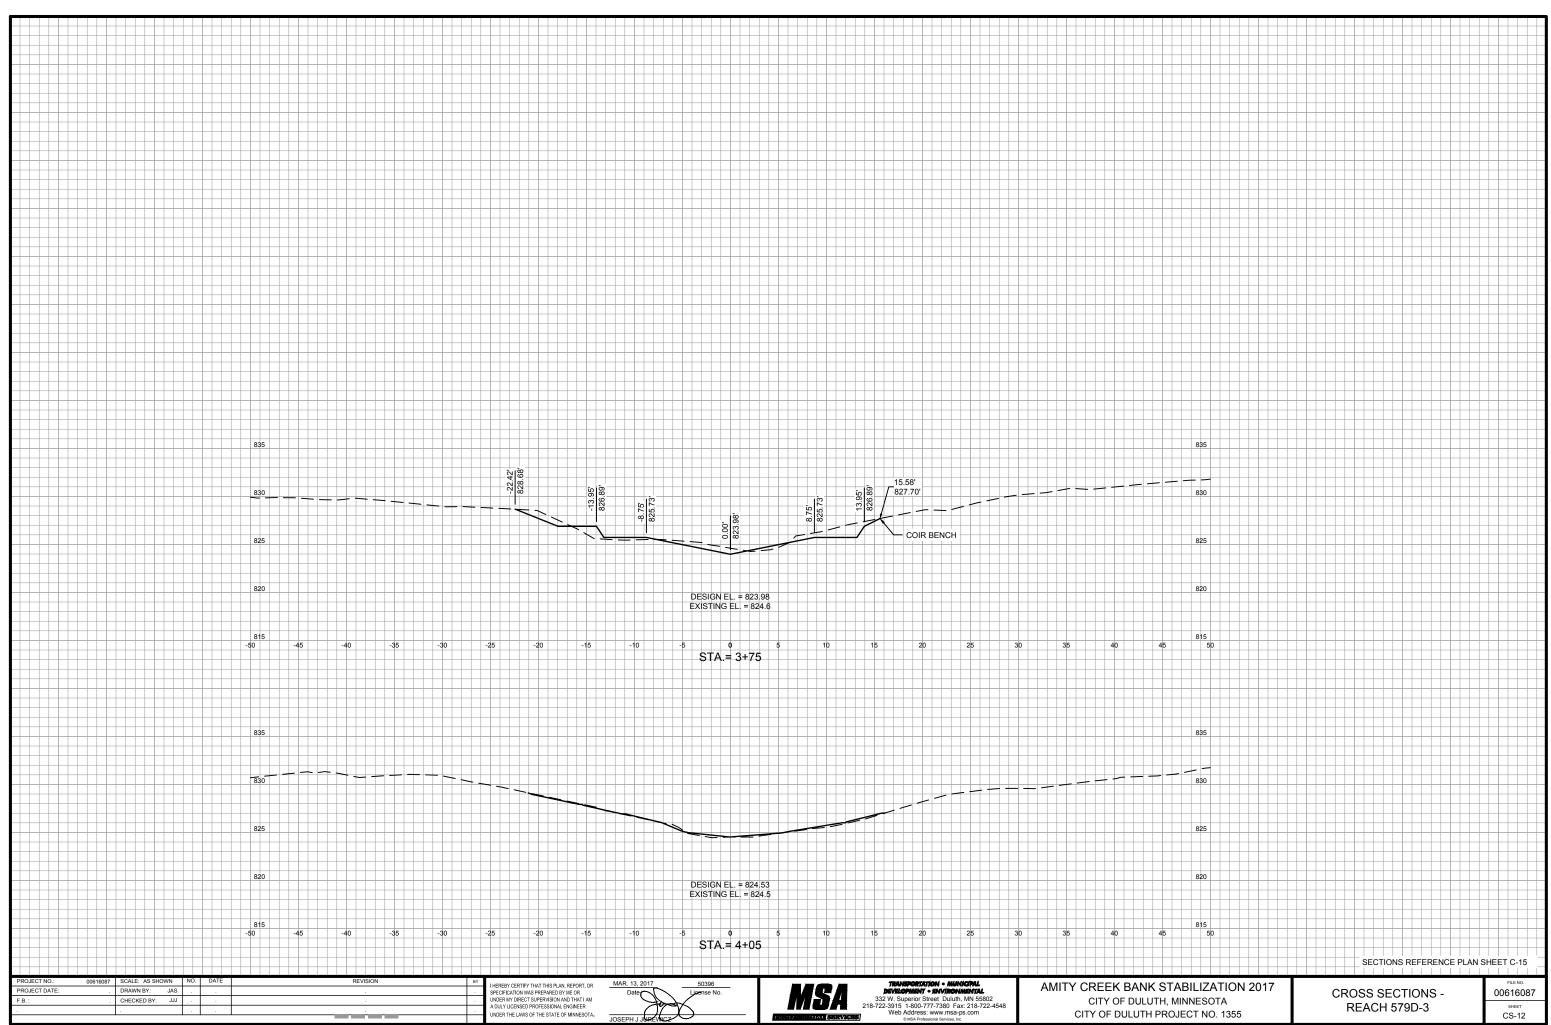




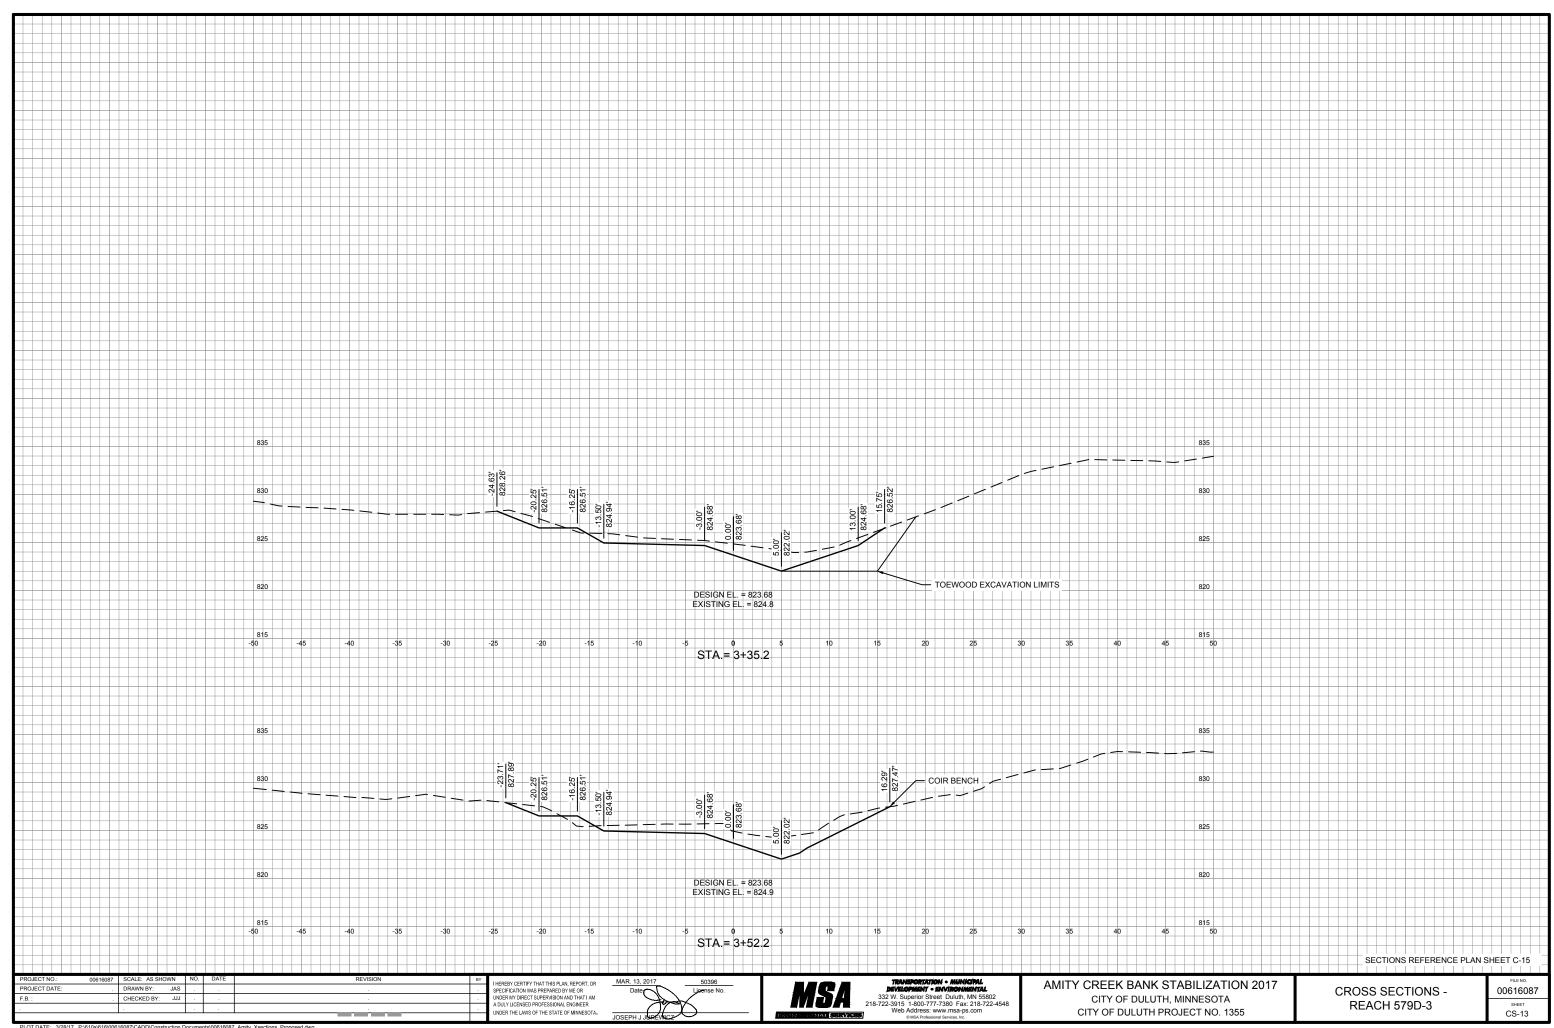


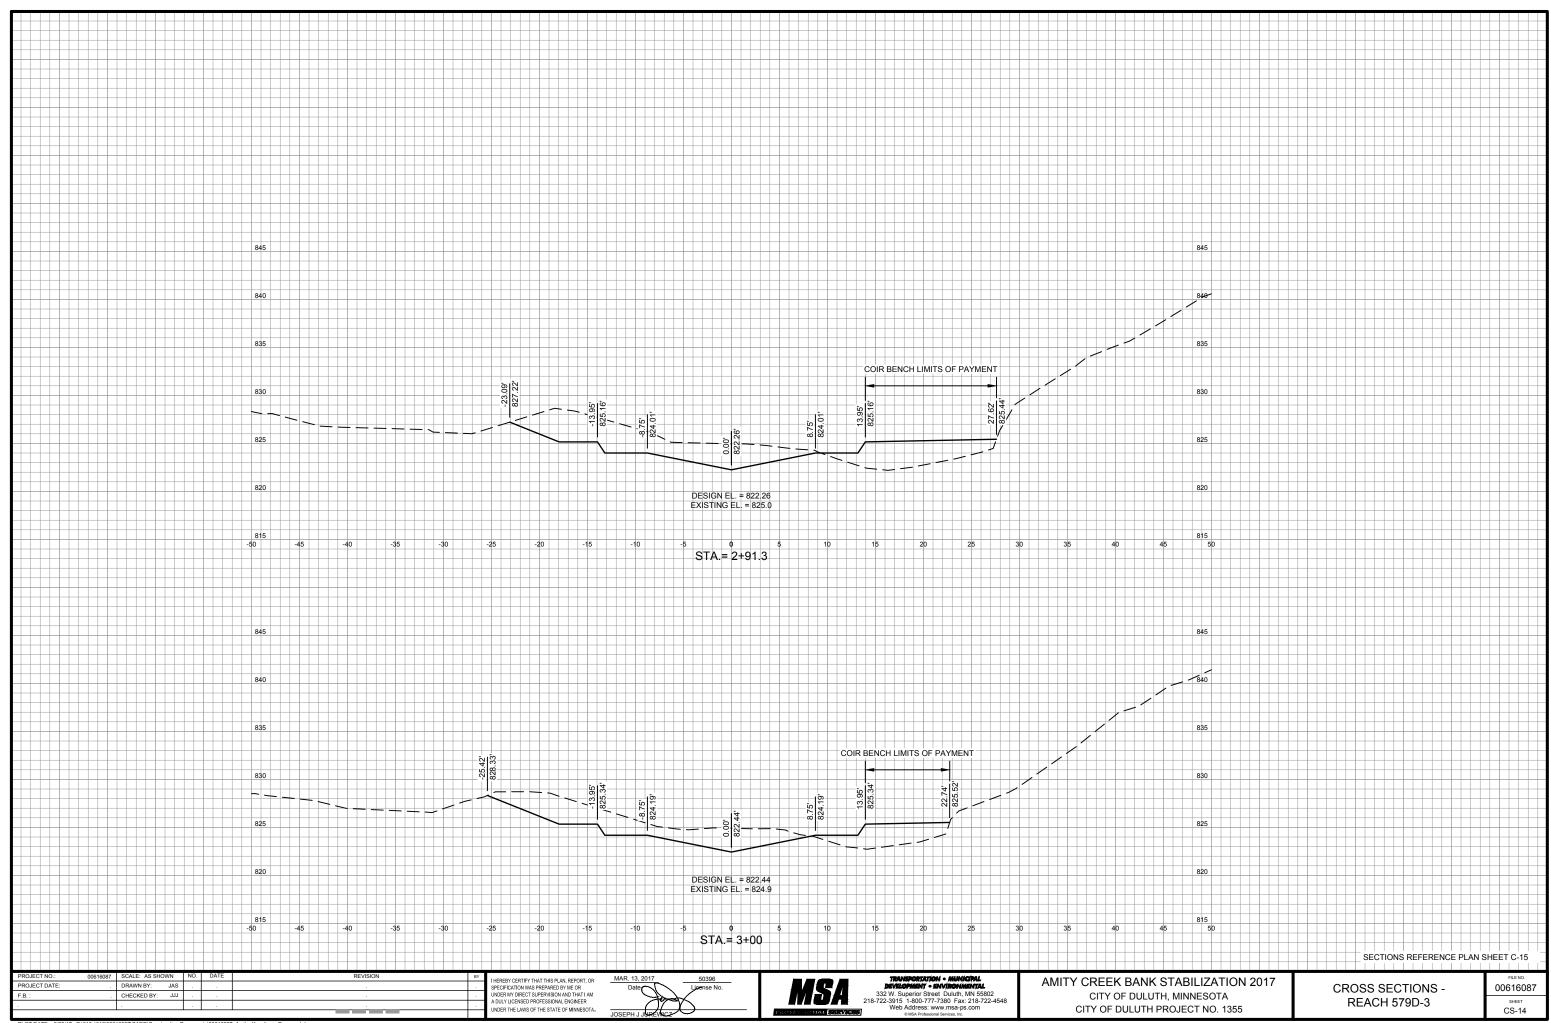


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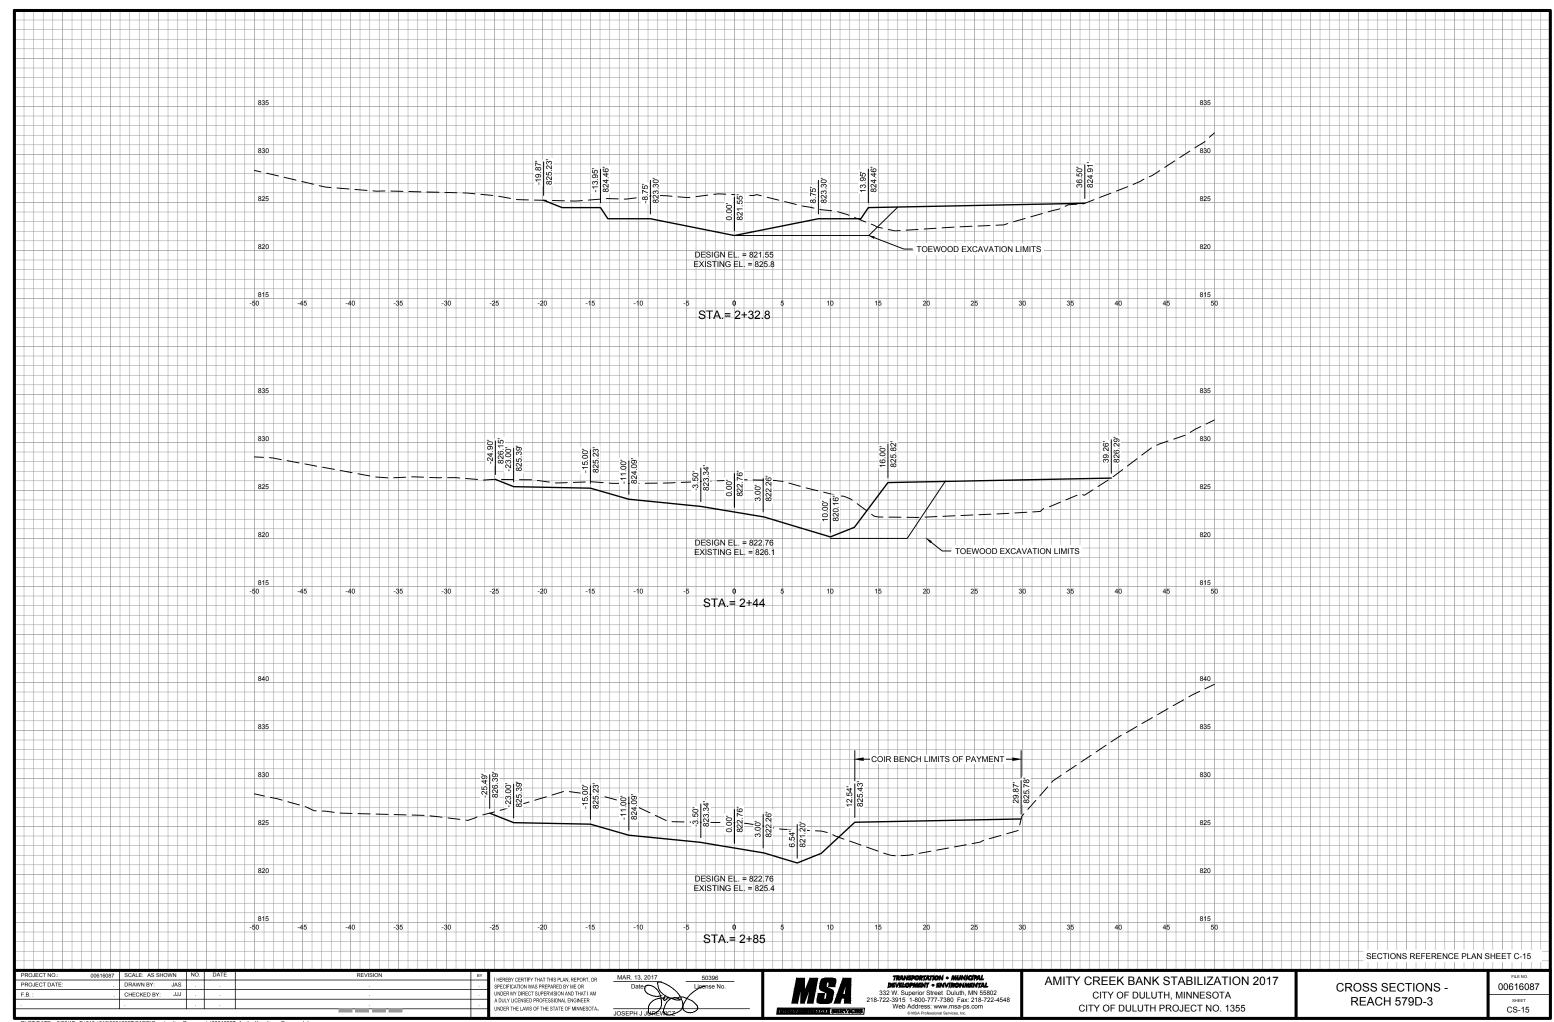


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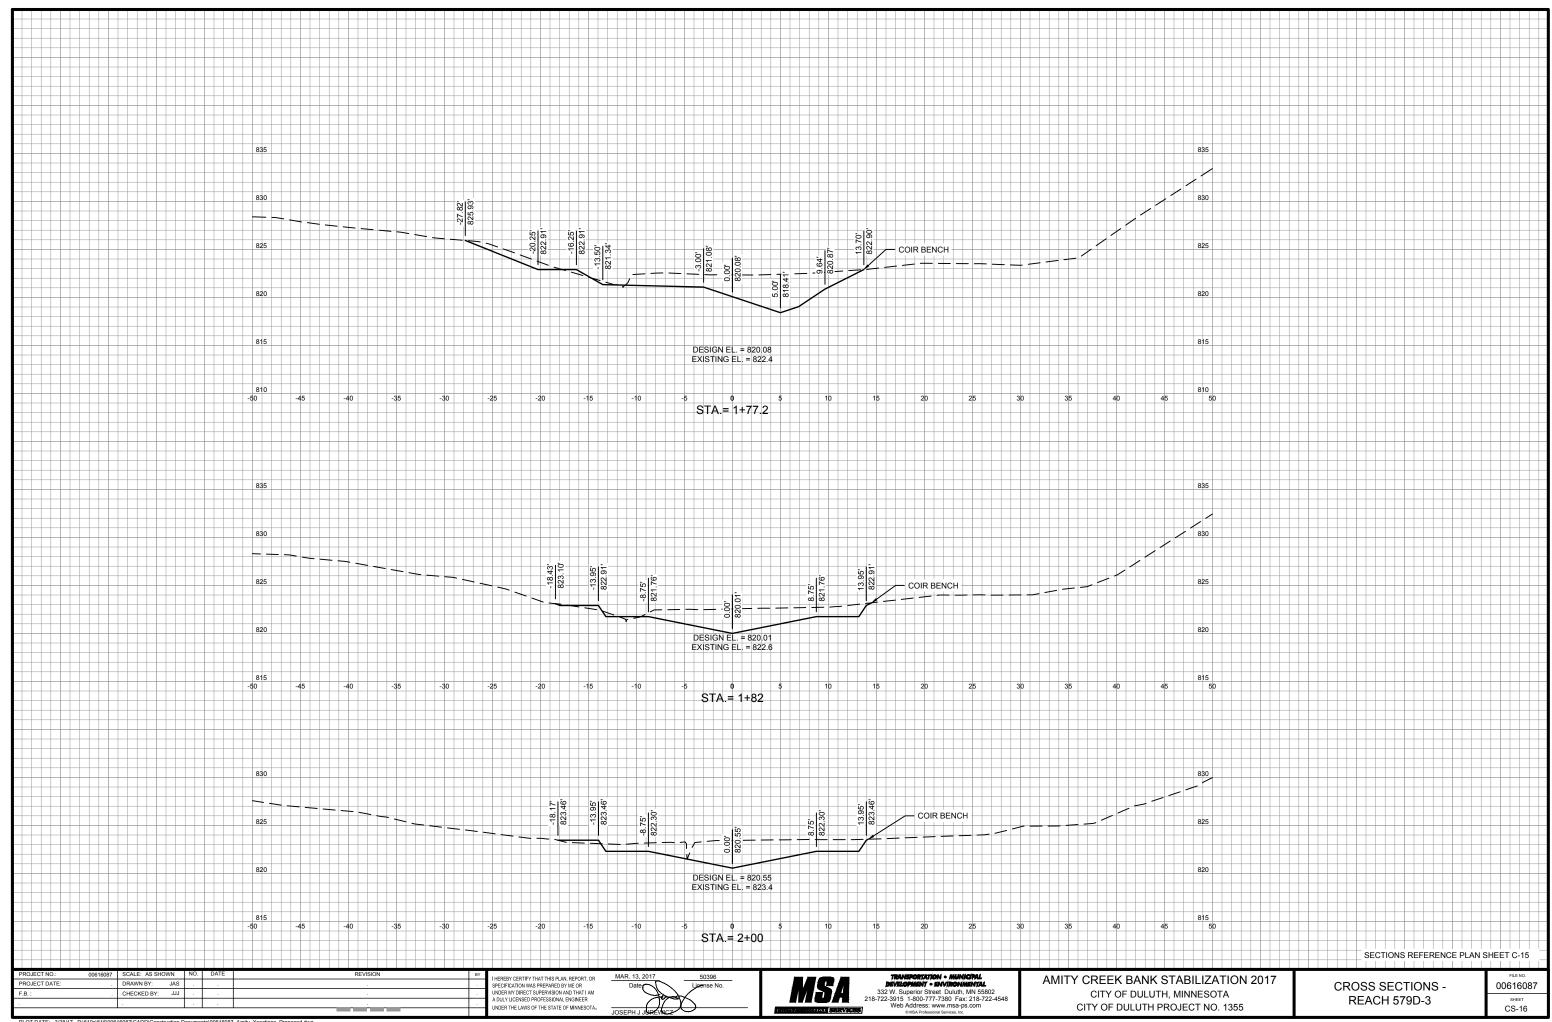


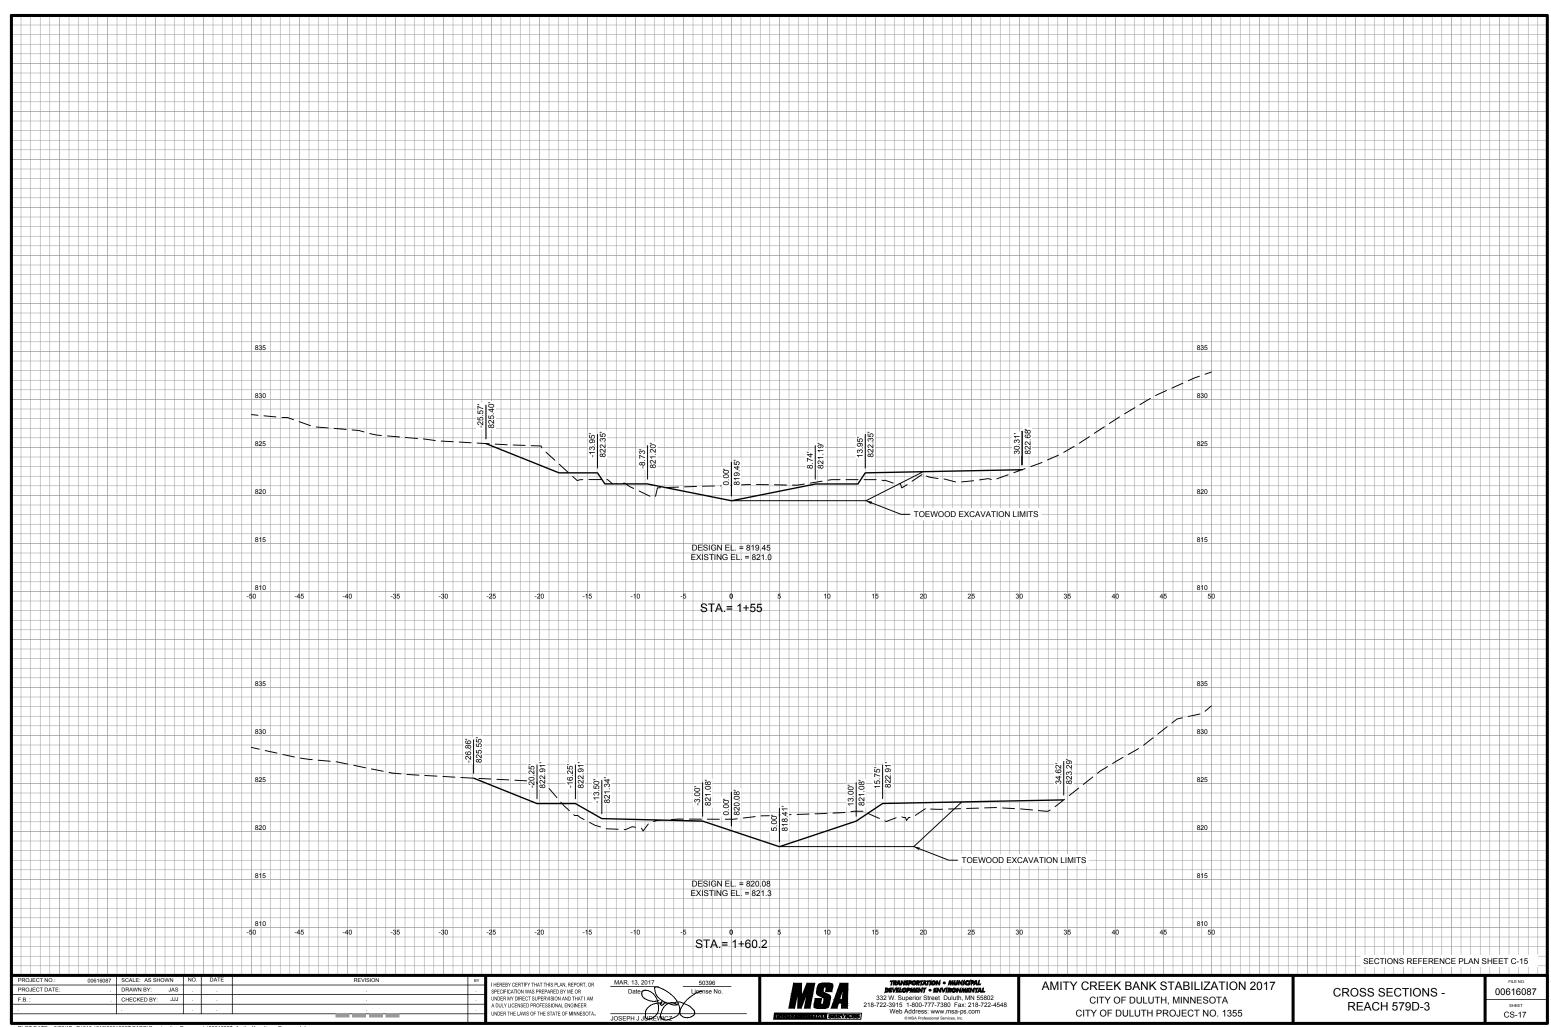


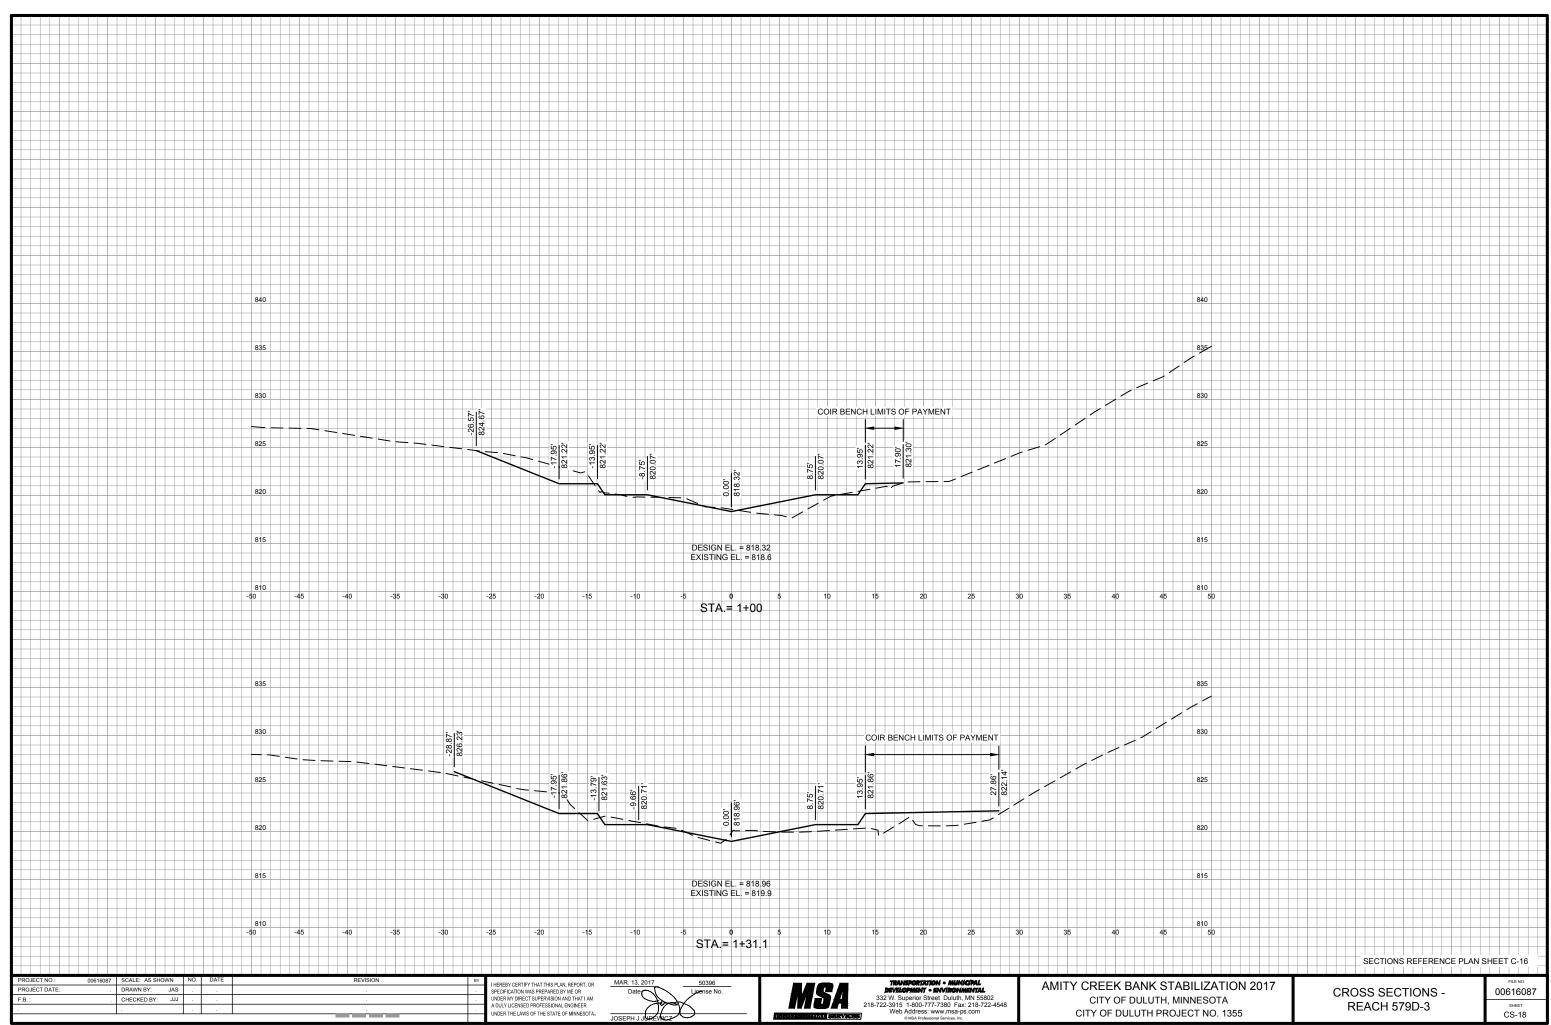
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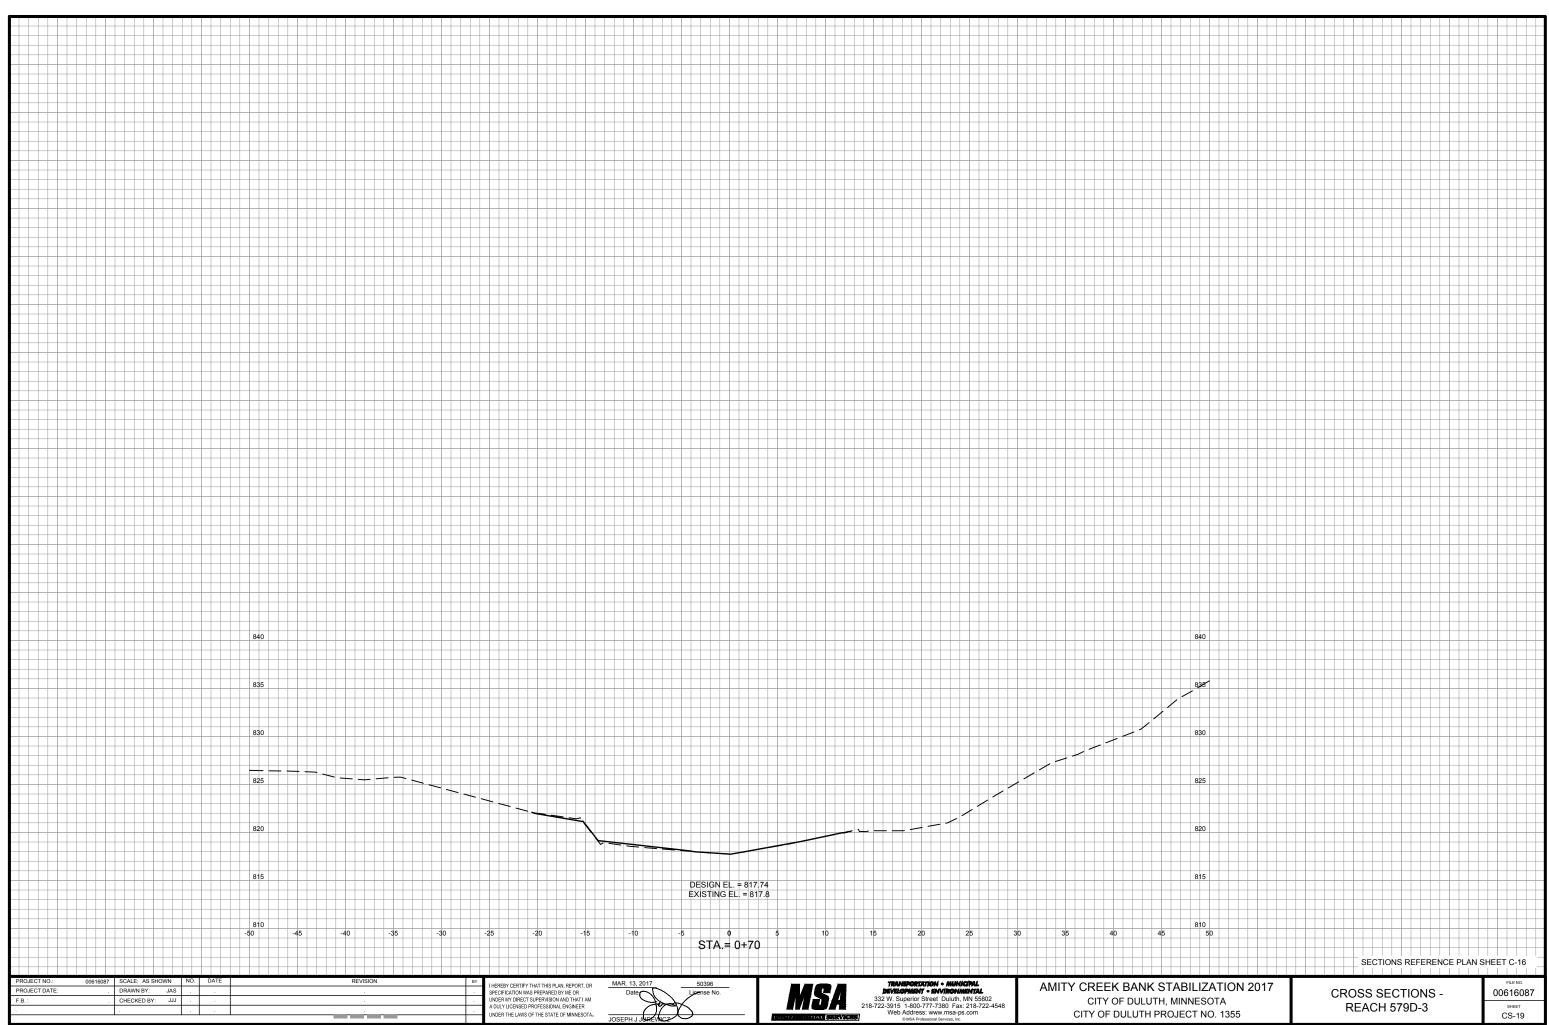
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