DULUTH INTERNATIONAL AIRPORT

Director of Airports: Brian Ryks 4701 GRINDEN DRIVE - DULUTH INTERNATIONAL AIRPORT **DULUTH, MINNESOTA 55811**

FAA AIP No. - 3-27-0024-48-10 RS&H PROJ. No. - 213,1882,091 CITY OF DULUTH BID No. - 10-4401

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NEW PASSENGER TERMINAL BID PACKAGE 1 - Sitework, Structure, Enclosure **ADDENDUM 1 JUNE 11, 2010**



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SJA ARCHITECTS 11 E Superior Street Suite 340,

Duluth MN 55802 TEL: (218) 724-8578 / FAX: (218) 724-8717

Structural Engineers:

MBJ CONSULTING ENG.

501 Lake Avenue South, Suite 300, Duluth MN 55802 TEL: (218) 722-1056 / FAX: (218) 722-9306

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Baggage Handling Systems Consultants: BNP ASSOCIATES INC.

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Landscaping Consultants: APPOLD DESIGN

> 2432 East First Street, Duluth MN 55812 TEL: (218) 591-5079

NOT FOR CONSTRUCTION

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DRAWING LIST
 G000 COVER SHEET
 G101 DRAWING LIST & PROJECT DATA
                                                                MECHANICAL
  <u>ARCHITECTURAL</u>
                                                                MOO1 MECHANICAL LEGEND
                                                                M002 MECHANICAL SYMBOLS
 A001 ARCHITECTUAL ABBREIVATIONS AND GENERAL NOTES
 A002 SYMBOLS AND ADA
                                                                M108 ENLARGED UNDERGROUND MECHANICAL PLAN - AREA A
 A003 PARTITION TYPES
                                                                M109 ENLARGED UNDERGROUND MECHANICAL PLAN - AREA B
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                                                                M501 MECHANICAL DETAILS I
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 A301 EXTERIOR ELEVATIONS
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 A310 BUILDING SECTIONS
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 LS102 SECOND FLOOR LIFE SAFETY
 LS103 THIRD FLOOR LIFE SAFETY
 <u>STRUCTURAL</u>
 S001 TITLE SHEET
 S002 GENERAL STRUCTURAL NOTES
  S003 GENERAL STRUCTURAL NOTES
  S101 OVERALL FIRST LEVEL FLOOR PLAN
 S102 OVERALL SECOND LEVEL FLOOR PLAN
 S103 OVERALL THIRD LEVEL FLOOR PLAN
 S104 OVERALL ROOF LEVEL FLOOR PLAN
  S106 CANOPY FOUNDATION PLAN - AREA A
  S107 CANOPY FOUNDATION PLAN - AREA B
 S108 CANOPY ROOF FRAMING PLAN - AREA A
 S109 CANOPY ROOF FRAMING PLAN - AREA B
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S110 FOUNDATION PLAN — AREA A

S111 FOUNDATION PLAN - AREA B

S118 TUG ROAD FOUNDATION PLAN

S119 TUG ROAD ROOF FRAMING PLAN

S301 BRACING ELEVATIONS AND DETAILS S302 BRACING ELEVATIONS AND DETAILS

S401 COLUMN SCHEDULE AND DETAILS

S501 STRUCTURAL DETAILS

S502 STRUCTURAL DETAILS S503 STRUCTURAL DETAILS S504 STRUCTURAL DETAILS S505 STRUCTURAL DETAILS

S701 STRUCTURAL DETAILS S702 STRUCTURAL DETAILS S703 STRUCTURAL DETAILS S704 STRUCTURAL DETAILS S705 STRUCTURAL DETAILS S706 STRUCTURAL DETAILS

S112 SECOND LEVEL FRAMING PLAN - AREA A

S113 SECOND LEVEL FRAMING PLAN - AREA B S114 THIRD LEVEL FRAMING PLAN - AREA A

S115 THIRD LEVEL FRAMING PLAN - AREA B S116 ROOF LEVEL FRAMING PLAN - AREA A

S117 ROOF LEVEL FRAMING PLAN - AREA B

HEIGHTS AND CLEARANCES, SEE A002



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2432 East First Street, Duluth MN 55812 TEL: (218) 591-5079

ARCHITECTURAL CERTIFICATION I hereby certify that the architectural plans, specifications or report was prepared by me or under my direct supervision and that I am a duly licensed Professional Architect under

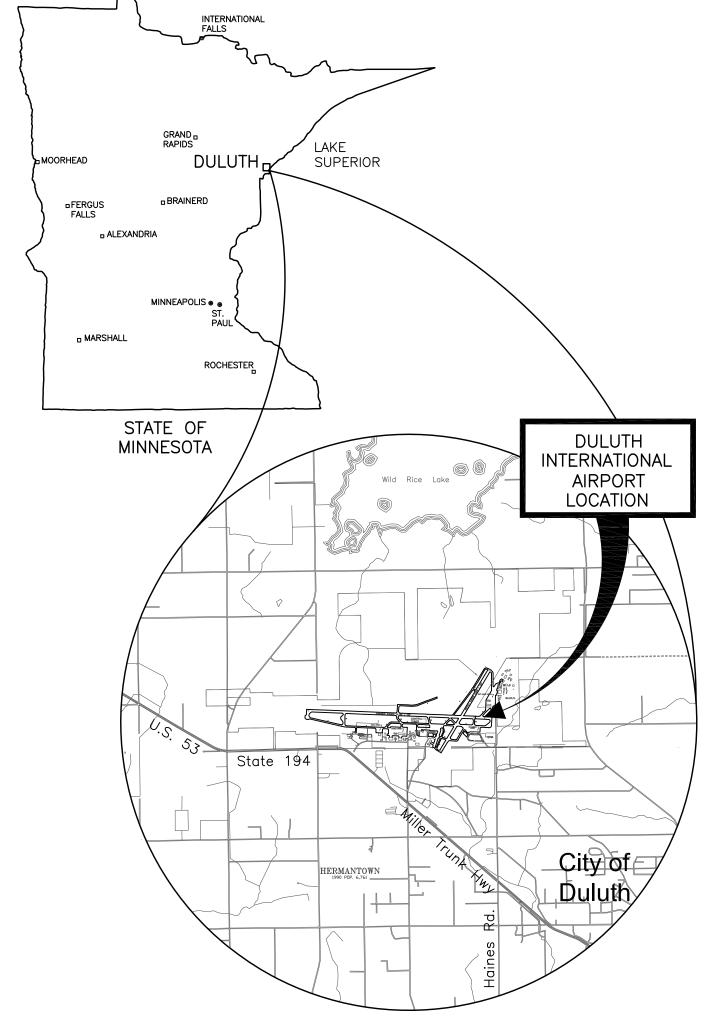
Print Name: Mark Ip

the laws of the State of Minnesota.

Date: 06-03-10 Reg. No.: 46001

REVISIONS

DESCRIPTION DATE ADDENDUM 1 **DATE ISSUED: 05-26-10**



LOCATION MAP

DRAWING LIST

AEP PROJECT NUMBER

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REVIEWED BY: SBS/TC DRAWN BY: MKG/MI DESIGNED BY: SBS/TC

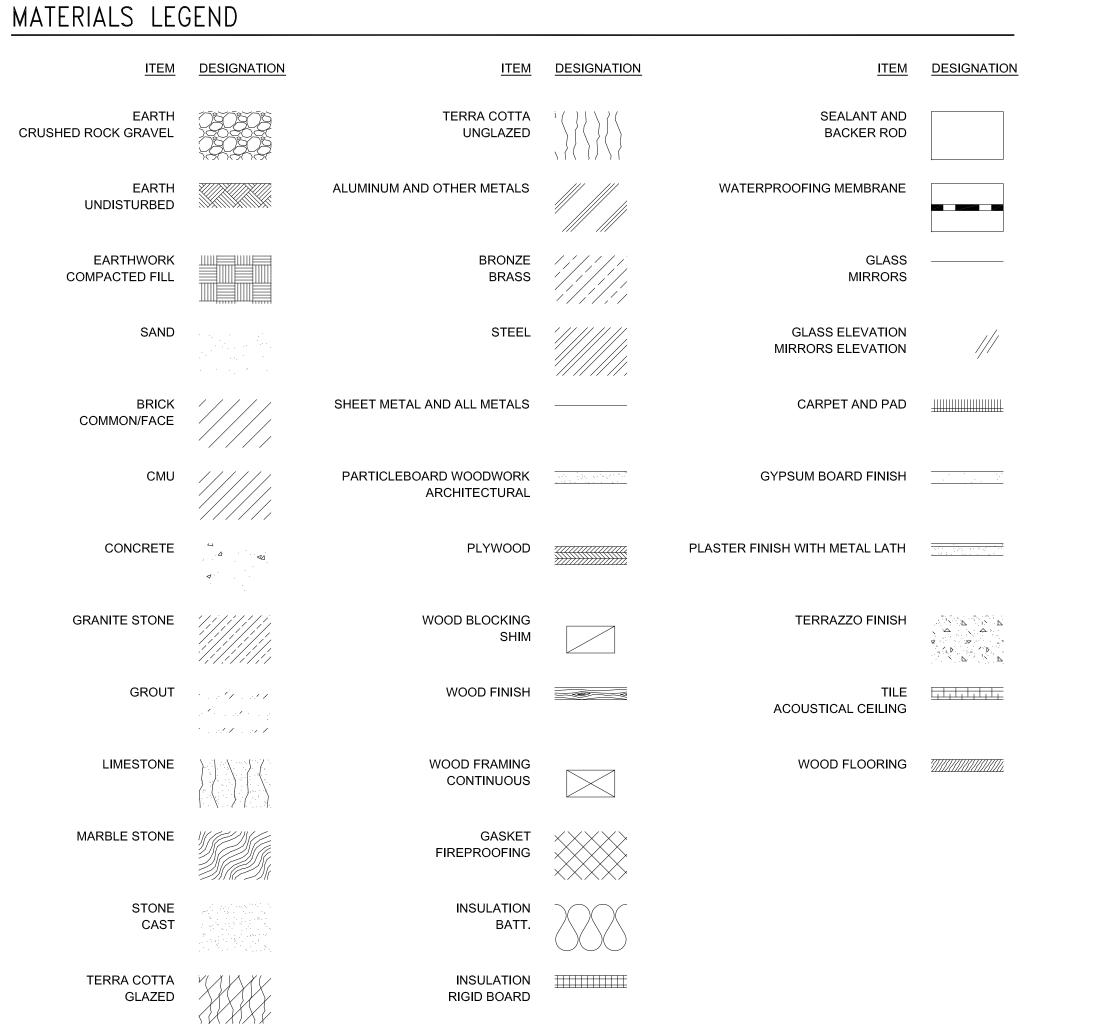
SHEET NUMBER

G101

BID PACKAGE 1 ADDENDUM 1 NOT FOR CONSTRUCTION

Drawing: T:\P\2131882.091 Duluth New Terminal\Cad\A\Sheets_G101 Drawing List.dwg Plotted on: 6/10/2010 3:14 PM Plotted by: Godzina, Marc


GENERAL NOTE: FOR ADA STANDARDS, PLUMBING FIXTURES' MOUNTING



11" MIN DRINKING FOUNTAIN

URINAL

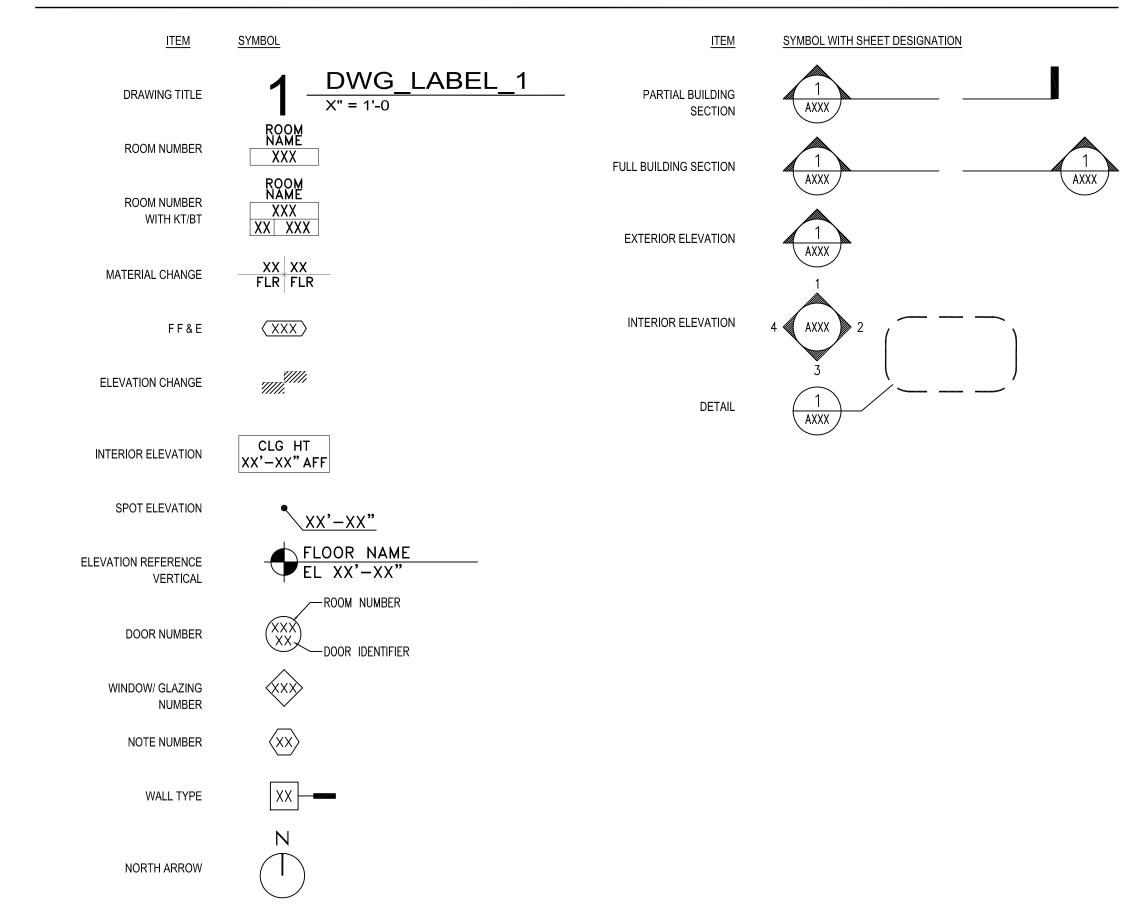SYMBOLS LEGEND



ACCESSIBILITY NOTES

A. GENERAL REQUIREMENTS

THIS PROJECT WILL COMPLY WITH ALL IAC 400.310 - NEW CONSTRUCTION.

1. THE ENTRANCE IS ACCESSIBLE PER IAC 400.310(k).

2. ALL PASSENGER ELEVATORS PROVIDED IN A BUILDING OR FACILITY SHALL BE ACCESSIBLE, SHALL SERVE ALL LEVELS OF A BUILDING OR FACILITY, SHALL BE ON AN ACCESSIBLE ROUTE AND SHALL COMPLY WITH THE ASME A 17.1-1996.

3. ALL DOORS LEADING TO REQUIRED ACCESSIBLE ROOMS AND SPACES SHALL BE A MINIMUM OF 3'-0" WIDE, HAVE LEVER OPERATED HARDWARE (OR EQUAL), HAVE A MININUM OPENING FORCE OF 5 LBF, AND FULLY COMPLY WITH IAC

4. ALL DOORS LEADING TO HAZARDOUS ROOMS WILL COMPLY WITH THE ABOVE AND, IN ADDITION, WILL HAVE KNURLED OPERATING HARDWARE (I.E., ELECTRICAL/TELEPHONE ROOMS).

5. ALL ENVIRONMENTAL CONTROLS AND OPERATING MECHANISMS WILL COMPLY WITH IAC 400.310(r) (FRONT REACH BETWEEN 15" AND 48" AFF).

6. ALL EMERGENCY WARNING ALARMS, WHERE PROVIDED, SHALL BE BOTH AUDIBLE AND VISUAL AND COMPLY WITH IAC 400.310(s). THE VISUAL ALARMS WILL BE FLASHING TYPE WHERE THE FLASHING IS SYNCHRONIZED AND IN COMPLIANCE FOR INTENSITY AND FREQUENCY, ALL TENANT SPACES WILL BE WIRED FOR FUTURE INSTALLATION OF EMERGENCY WARNING ALARMS ON AN AS NEEDED BASIS (SEE SECURITY DRAWINGS).

7. ANY NEW REQUIRED SIGNAGE IN CONTRACT SHALL BE INSTALLED AS REQUIRED PER IAC 400.310(u).

8. TOILET ROOMS SERVING PUBLIC AREAS (I.E., LOBBIES, CONCOURSE, ETC.) WILL FULLY COMPLY WITH IAC 400.310(n).

9. REFER TO CHAPTER 1341 MN BUILDING CODE

ACCESSIBILITY CLEARANCES NOTE Y=48" MIN. X=12" MIN. IF DOOR HAS BOTH A LATCH AND CLOSER NOTE Y=54" MIN. IF DOOR HAS CLOSER X=12" IF DOOR HAS BOTH A CLOSER AND LATCH X=36" MIN. IF Y=60" X=42" MIN. IF Y=54" PULL SIDE DOOR CLEARANCE PULL SIDE DOOR CLEARANCE PULL SIDE DOOR CLEARANCE PUSH SIDE DOOR CLEARANCE PUSH SIDE DOOR CLEARANCE TOP OF REFLECTIVE (735mm) LAVATORY PART OF MIRROR MIN. NOTE Y=48" MIN. IF DOOR FLOOR SPACE 8" MIN. _ | | _6" MAX. KNEE PH HAS CLOSER 2'-6" MIN CLEARANCE LEARANCE NOTE X=42" MIN. LATCH APPROACH 17" MIN.DEPTH U-TURN AND LAVATORY CLEARANCES PUSH SIDE DOOR CLEARANCE X=48" MIN. ALL OTHER DOORWAY OPENING LAVATORY CLEARANCES PASSING SPACES APPROACHES_____ SIDE TRANSFER STALL SPACES - LIGHT SWITCH, ALARM OR — SANITARY NAPKIN / THERMOSTAT CONTROL ■ AND DATA - SANTARY NAPKIN/

TOILET ROOM ACCESSORIES

WATER CLOSET ELEVATIONS

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ARCHITECTURAL CERTIFICATION

I hereby certify that the architectural plans, specifications or report was prepared by me or under my direct supervision and that I am a duly licensed Professional Architect under the laws of the State of Minnesota.

Print Name: Mark Ip

Date: 06-03-10 Reg. No.: 46001

REVISIONS

NO. DESCRIPTION DATE ADDENDUM 1 **DATE ISSUED: 05-26-10**

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AEP PROJECT NUMBER

213-1882-091

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SYMBOLS AND **ACCESSIBILITY CLEARANCES**

SHEET NUMBER


OUTSETS

TAMPON VENDOR

A002

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Drawing: T:\P\2131882.091 Duluth New Terminal\Cad\A\Sheets\A002 Symbols.dwg Plotted on: 6/10/2010 3:15 PM Plotted by: Godzina, Marc



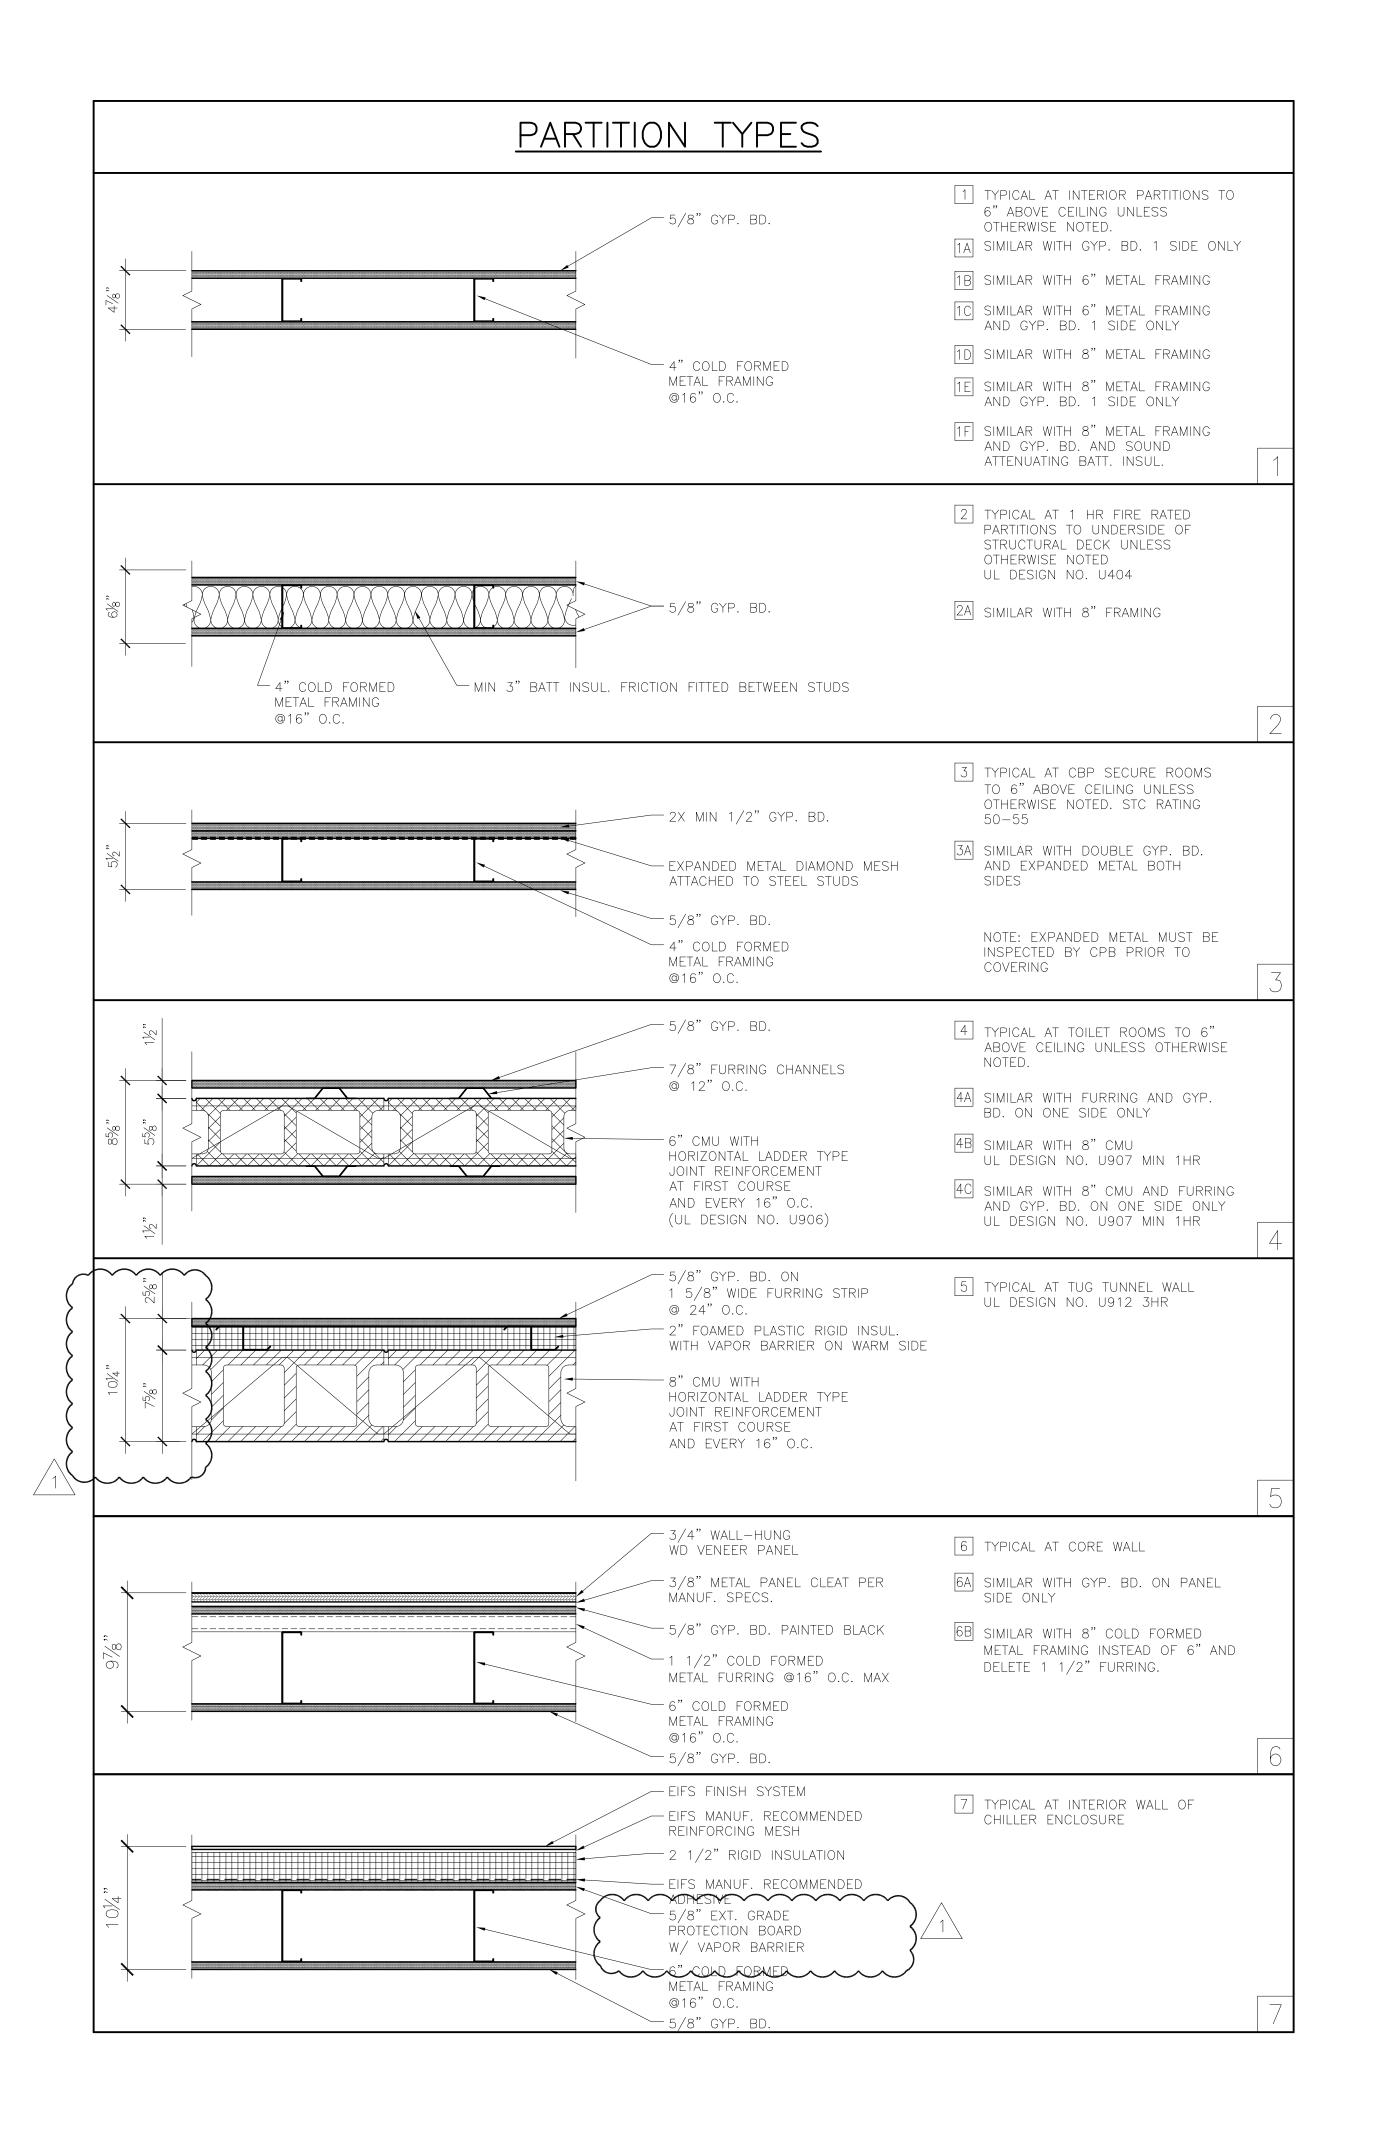

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DULUTH, MN

NEW PASSENGER TERMINAL

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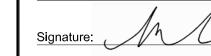
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Date: 06-03-10 Reg. No.: 46001

REVISIONS

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6.11.10

PEOLONED BY: SBS/TC

DRAWN BY: MKG/MI

DESCRIPTION OF THE PROPERTY OF THE PROP

DESIGNED BY: SBS/TC

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PARTITION


TYPES

SHEET NUMBER

A003

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ADDENDUM 1
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NEW PASSENGER TERMINAL

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Signature:

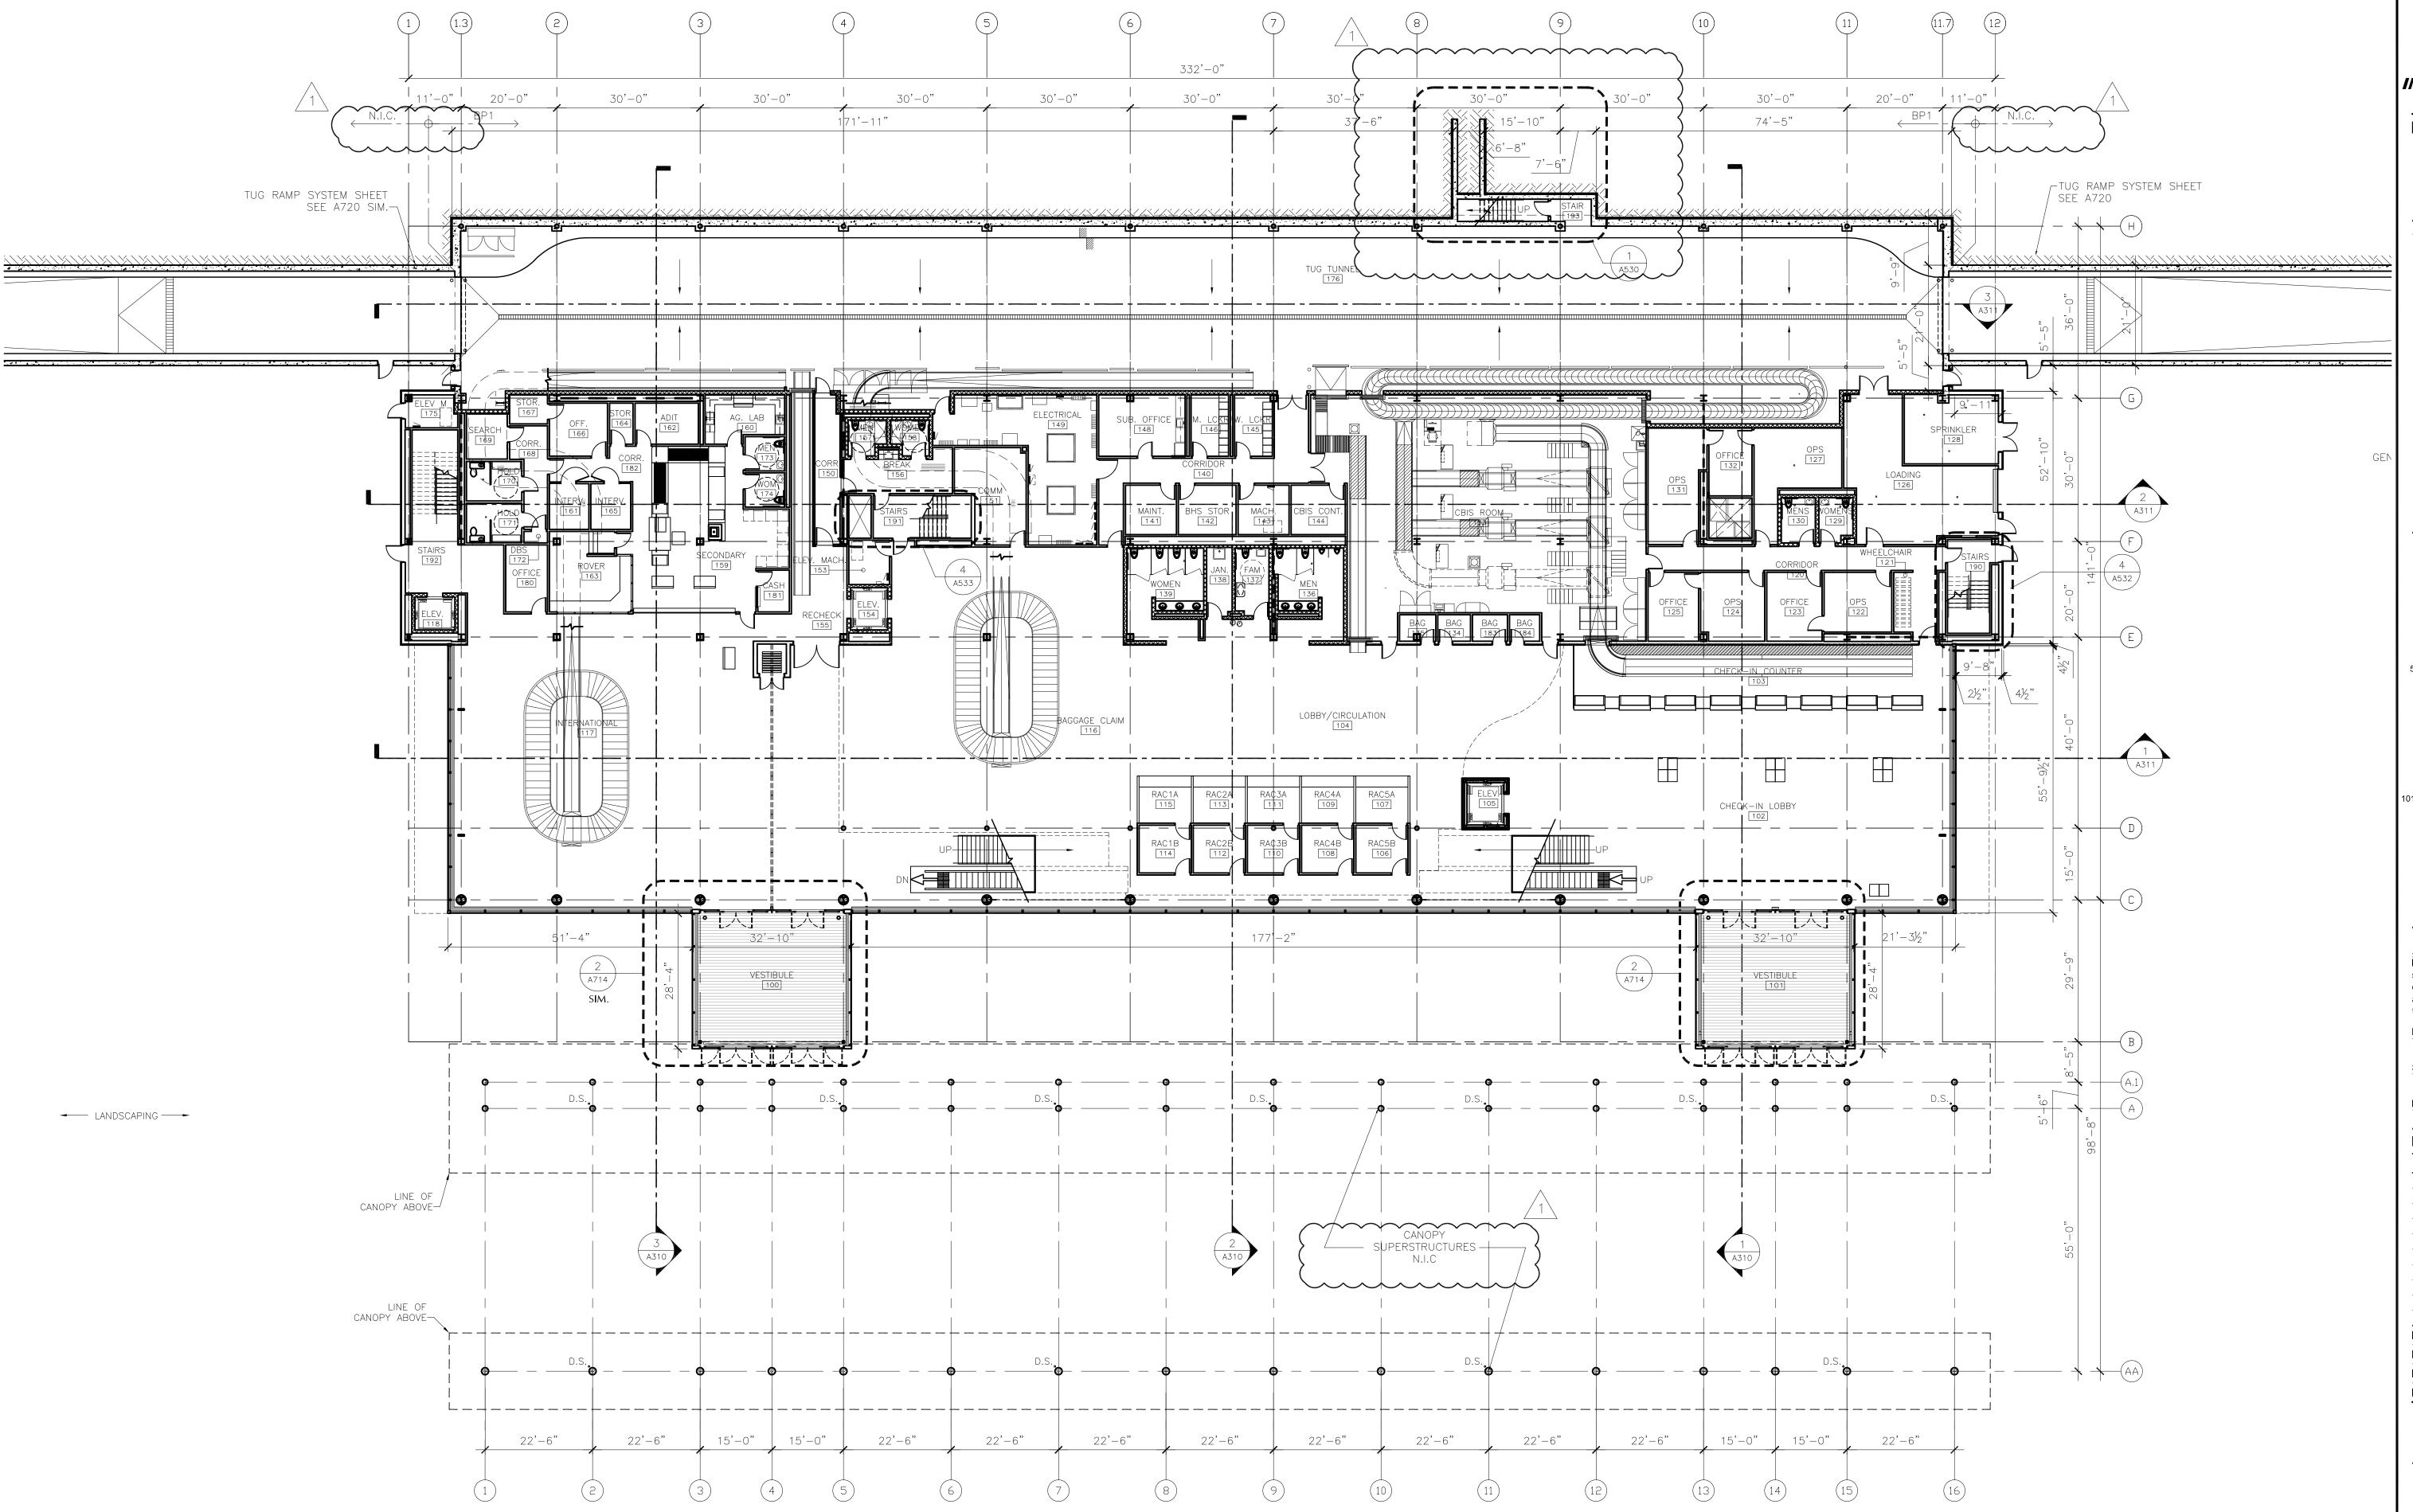Date: 06-03-10 Reg. No.: 46001

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NO. DESCRIPTION

1 ADDENDUM 1 6.11.10

DATE ISSUED: 05-26-10

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DRAWN BY: MKG/MI
DESIGNED BY: SBS/TC

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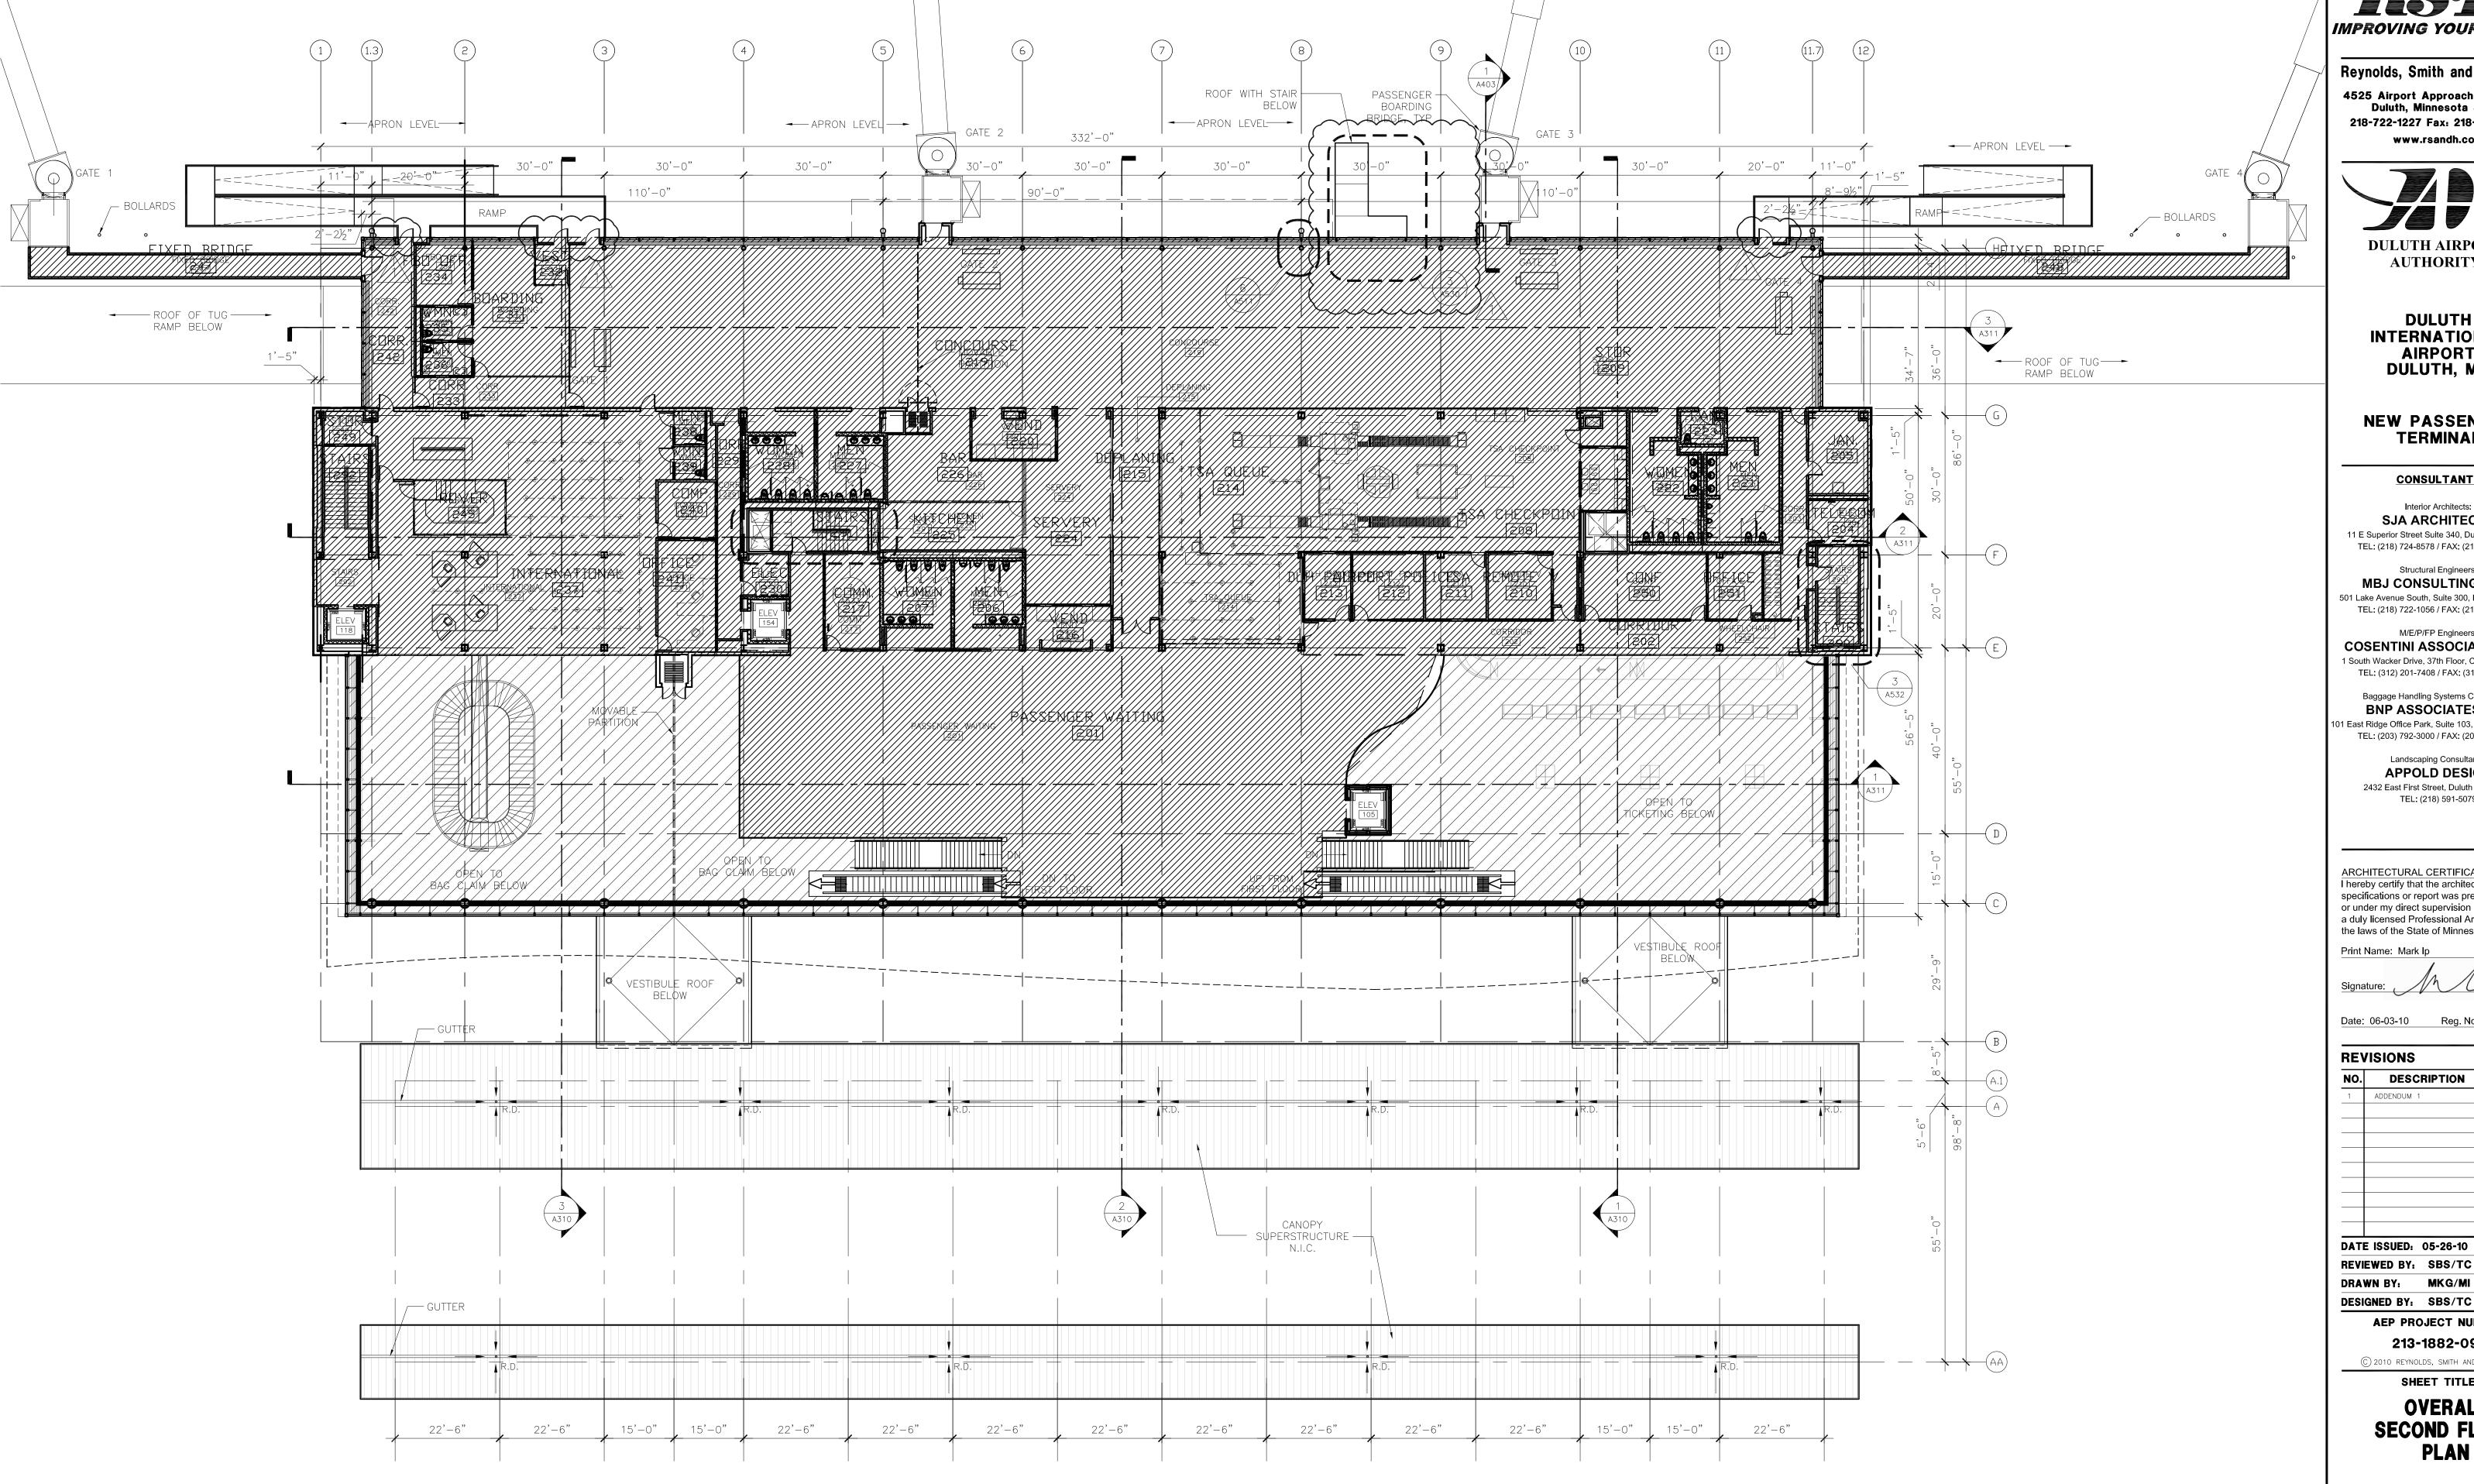
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SHEET TITLE

OVERALL FIRST FLOOR PLAN

SHEET NUMBER

A101



NOTE: IN FLOOR AIR DISTRIBUTION SYSTEM N.I.C.



SECOND LEVEL FLOOR PLAN

Drawing: T:\P\2131882.091 Duluth New Terminal\Cad\A\Sheets\A102 Overall Second Floor Plan.dwg Plotted on: 6/10/2010 3:16 PM Plotted by: Godzina, Marc

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Date: 06-03-10 Reg. No.: 46001

REVISIONS NO. DESCRIPTION DATE ADDENDUM 1

REVIEWED BY: SBS/TC DRAWN BY: MKG/MI DESIGNED BY: SBS/TC

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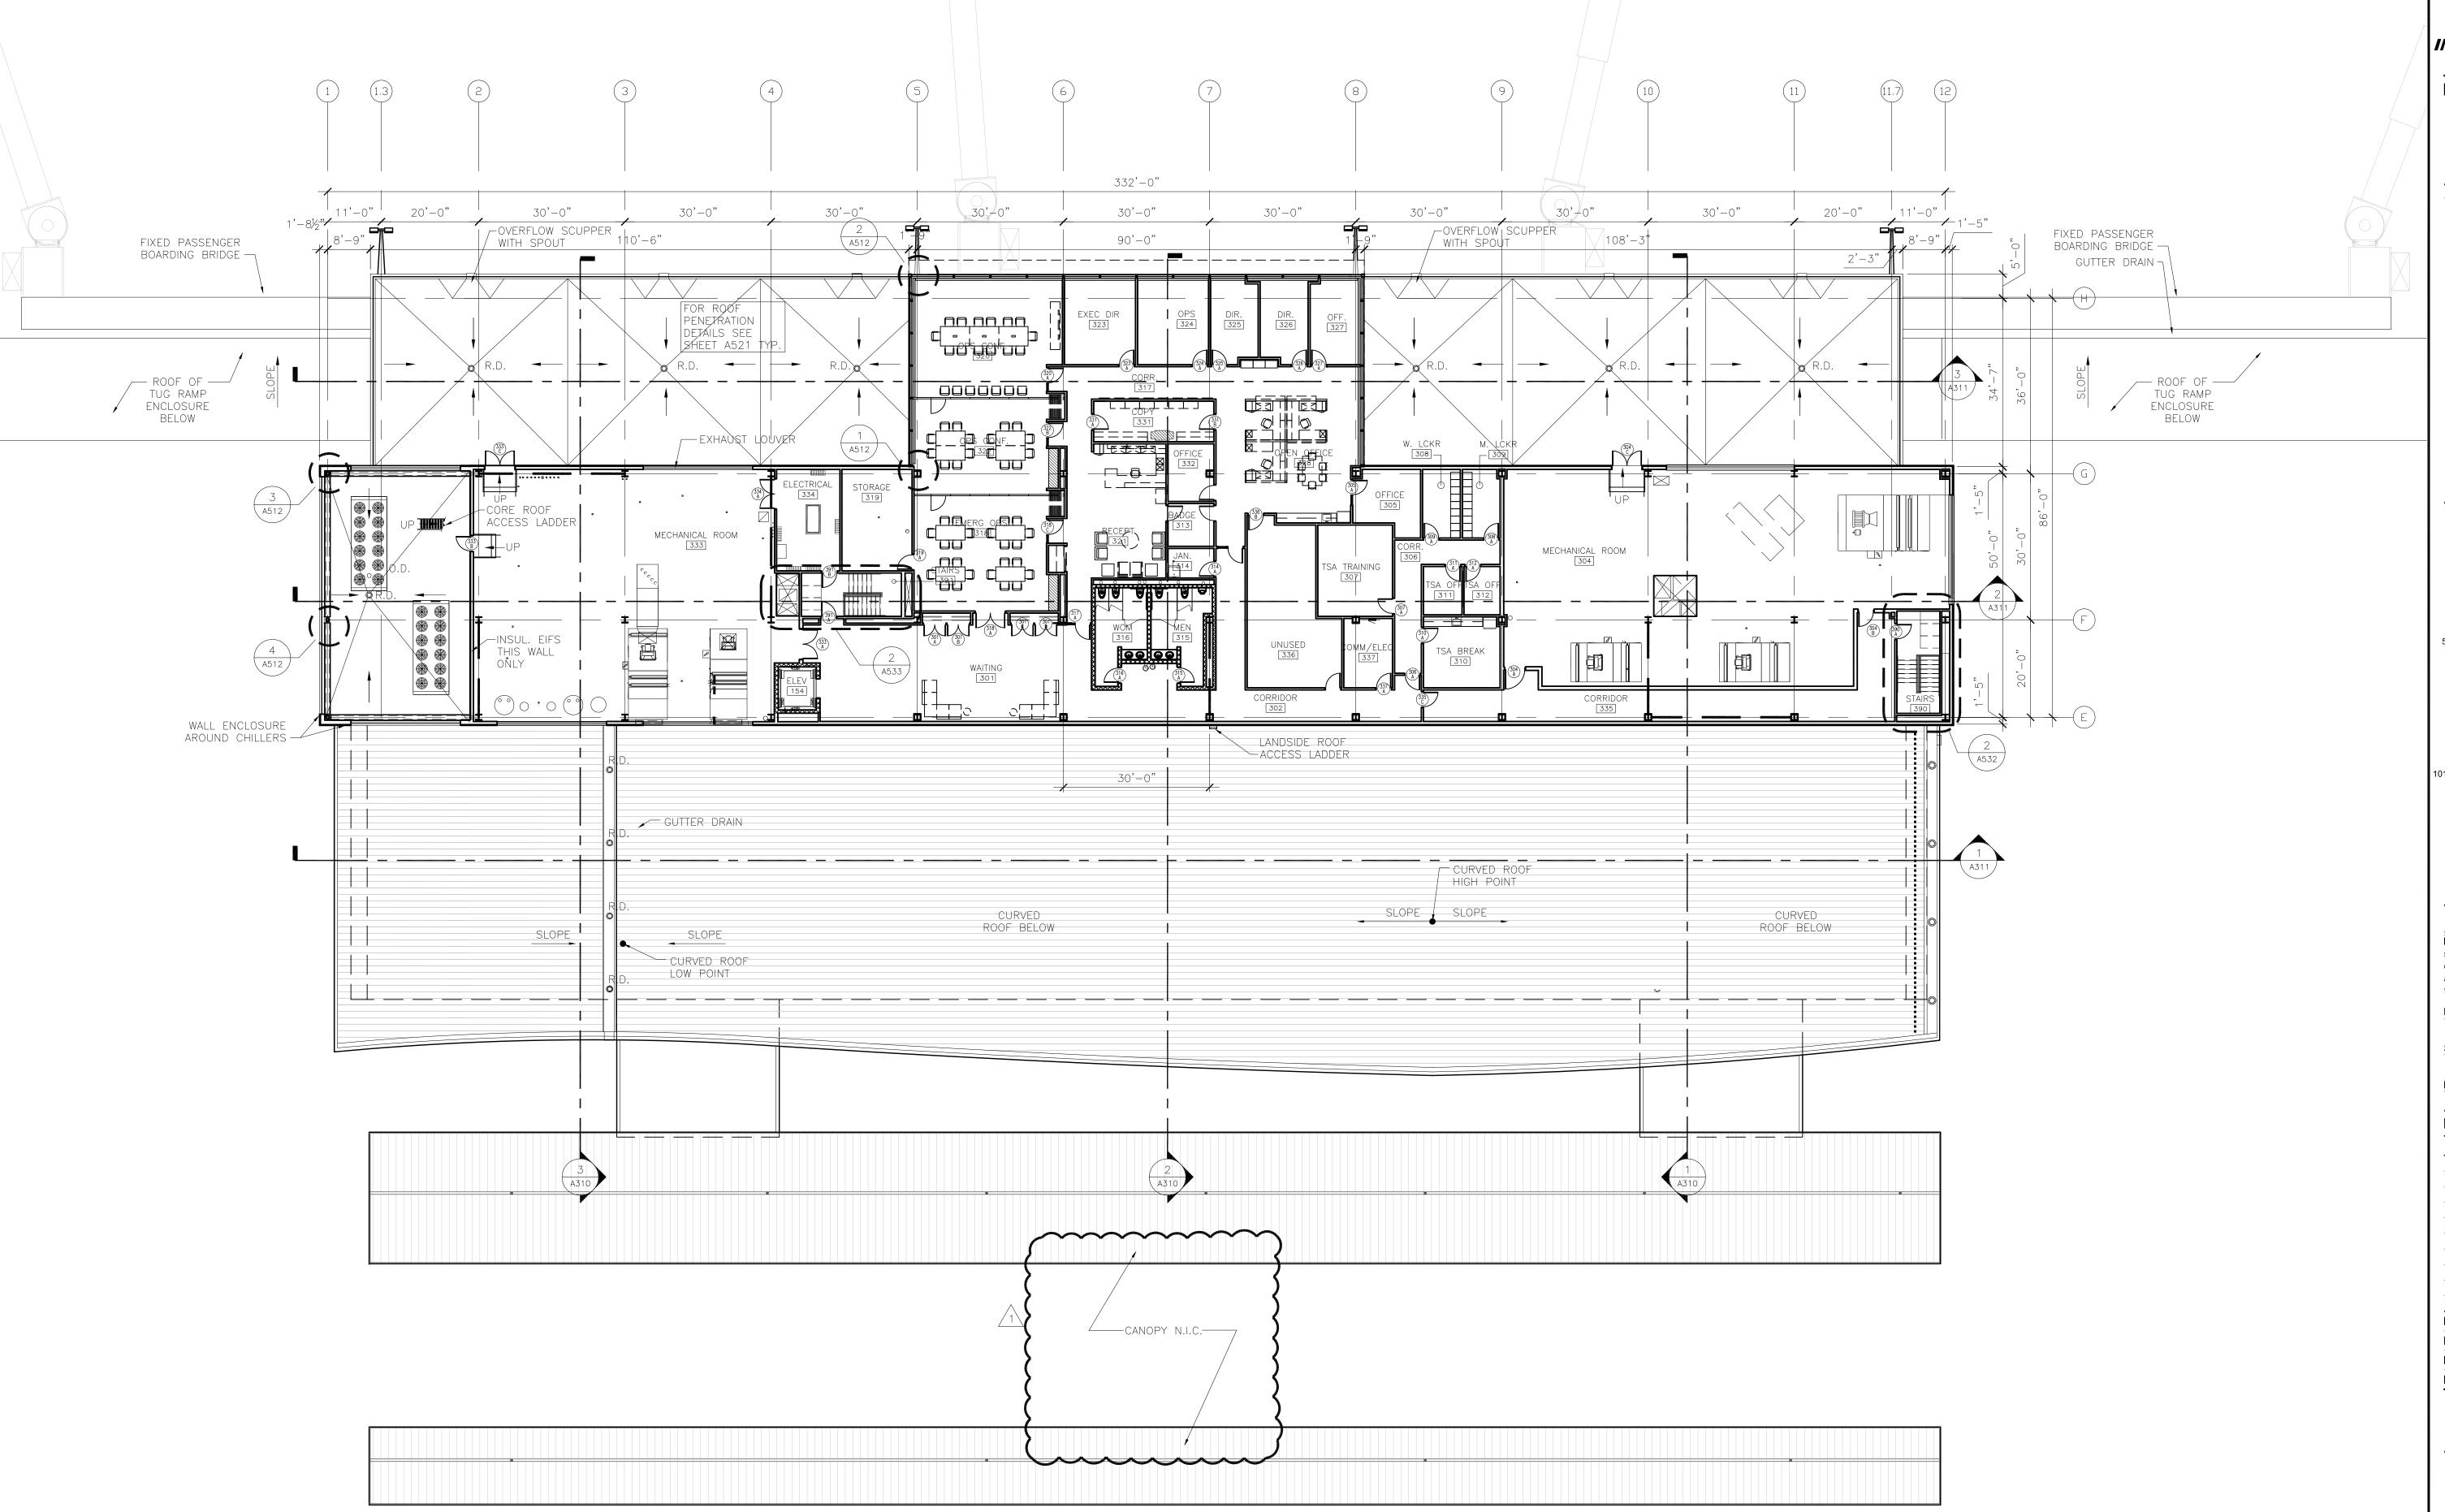
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SHEET TITLE

OVERALL SECOND FLOOR **PLAN**

SHEET NUMBER

A102



THIRD LEVEL FLOOR PLAN

1/16" = 1'-0"

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REVIEWED BY: SBS/TC DRAWN BY: MKG/MI

DESIGNED BY: SBS/TC **AEP PROJECT NUMBER**

213-1882-091


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OVERALL

THIRD FLOOR **PLAN**

SHEET NUMBER

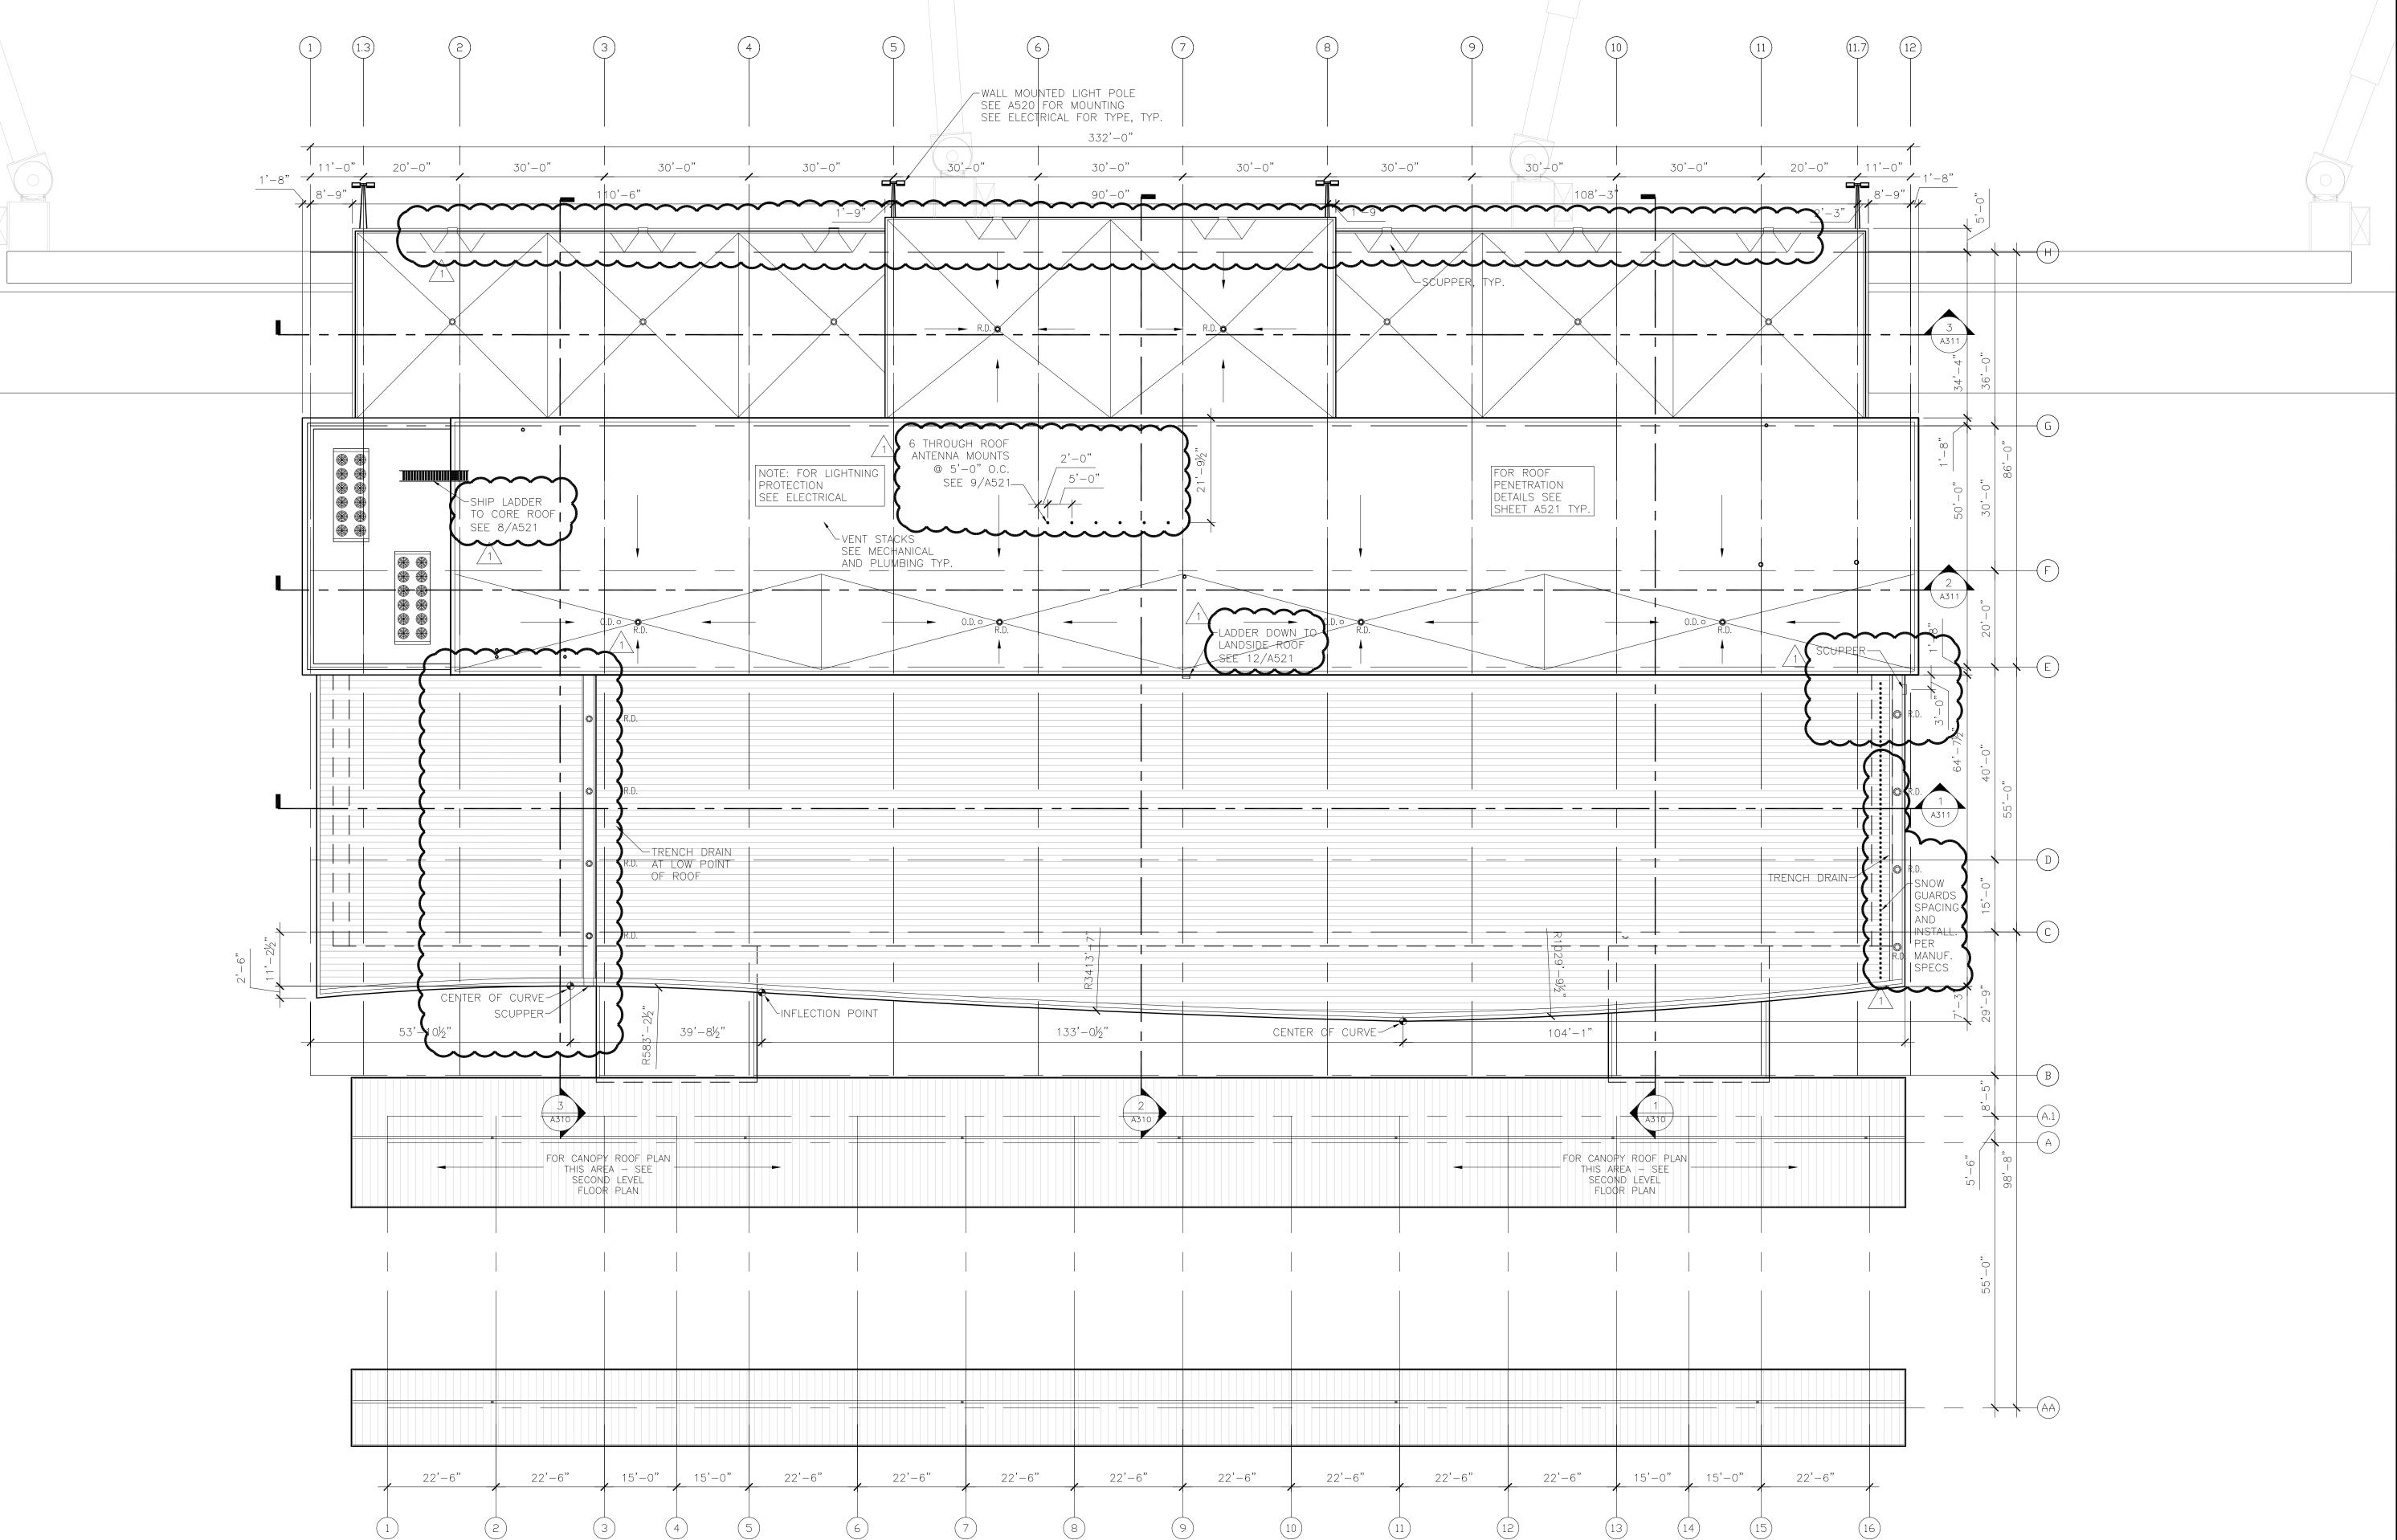A103



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DESIGNED BY: SBS/TC

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> **OVERALL ROOF PLAN**

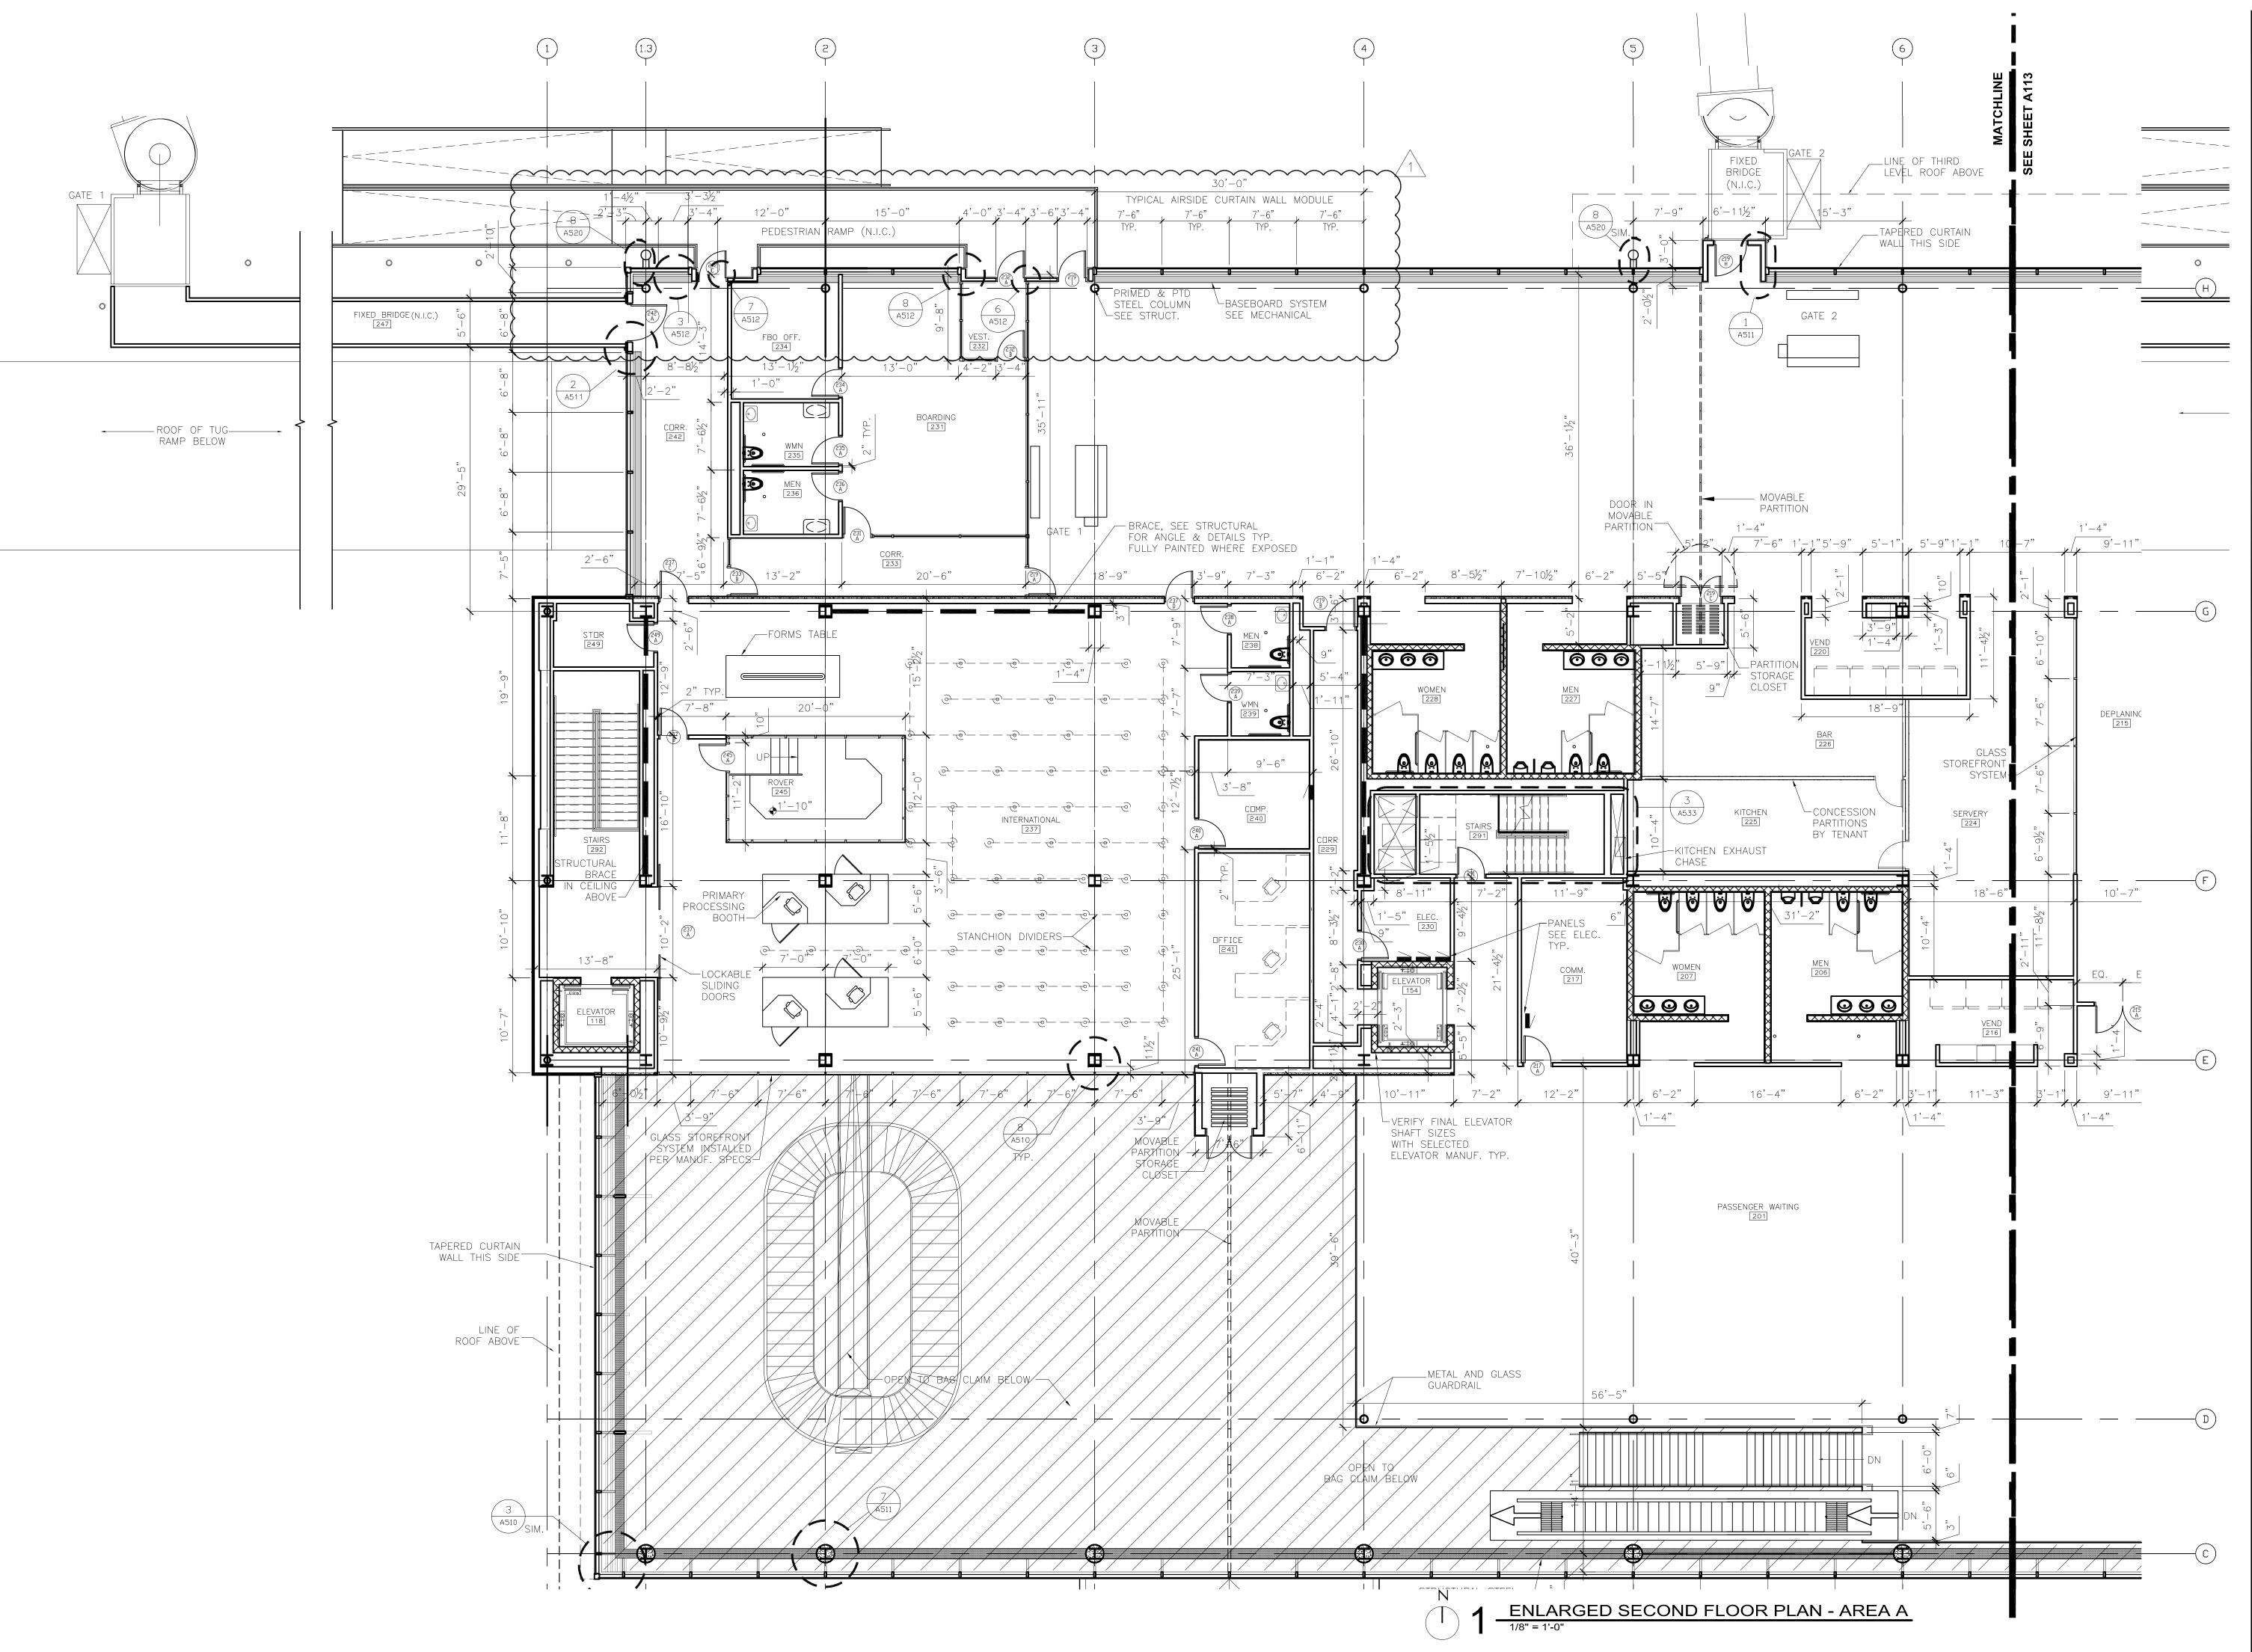
SHEET NUMBER

A104

BID PACKAGE 1 ADDENDUM 1 NOT FOR CONSTRUCTION

Drawing: T:\P\2131882.091 Duluth New Terminal\Cad\A\Sheets\A104 Overall Roof Plan.dwg Plotted on: 6/10/2010 3:17 PM Plotted by: Godzina, Marc

ROOF PLAN





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Duluth, Minnesota 55811

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DULUTH, MN

NEW PASSENGER TERMINAL

CONSULTANTS

Interior Architects:
SJA ARCHITECTS

11 E Superior Street Suite 340, Duluth MN 55802 TEL: (218) 724-8578 / FAX: (218) 724-8717

MBJ CONSULTING ENG.
501 Lake Avenue South, Suite 300, Duluth MN 55802
TEL: (218) 722-1056 / FAX: (218) 722-9306

Structural Engineers:

M/E/P/FP Engineers:

COSENTINI ASSOCIATES INC.

1 South Wacker Drive, 37th Floor, Chicago IL 60606
TEL: (312) 201-7408 / FAX: (312) 201-0031

Baggage Handling Systems Consultants: **BNP ASSOCIATES INC.**D1 East Ridge Office Park, Suite 103, Danbury CT 06810

east Ridge Office Park, Suite 103, Danbury CT 068 TEL: (203) 792-3000 / FAX: (203) 792-4900 Landscaping Consultants:

APPOLD DESIGN

2432 East First Street, Duluth MN 55812

TEL: (218) 591-5079

ARCHITECTURAL CERTIFICATION
I hereby certify that the architectural plans, specifications or report was prepared by me or under my direct supervision and that I am a duly licensed Professional Architect under the laws of the State of Minnesota.

Print Name: Mark Ip

Signature:

Date: 06-03-10 Reg. No.: 46001

REVISIONS

NO. DESCRIPTION DATE

1 ADDENDUM 1 6.11.10

DATE ISSUED: 05-26-10

REVIEWED BY: SBS/TC

DRAWN BY: MKG/MI
DESIGNED BY: SBS/TC

AEP PROJECT NUMBE

AEP PROJECT NUMBER 213-1882-091

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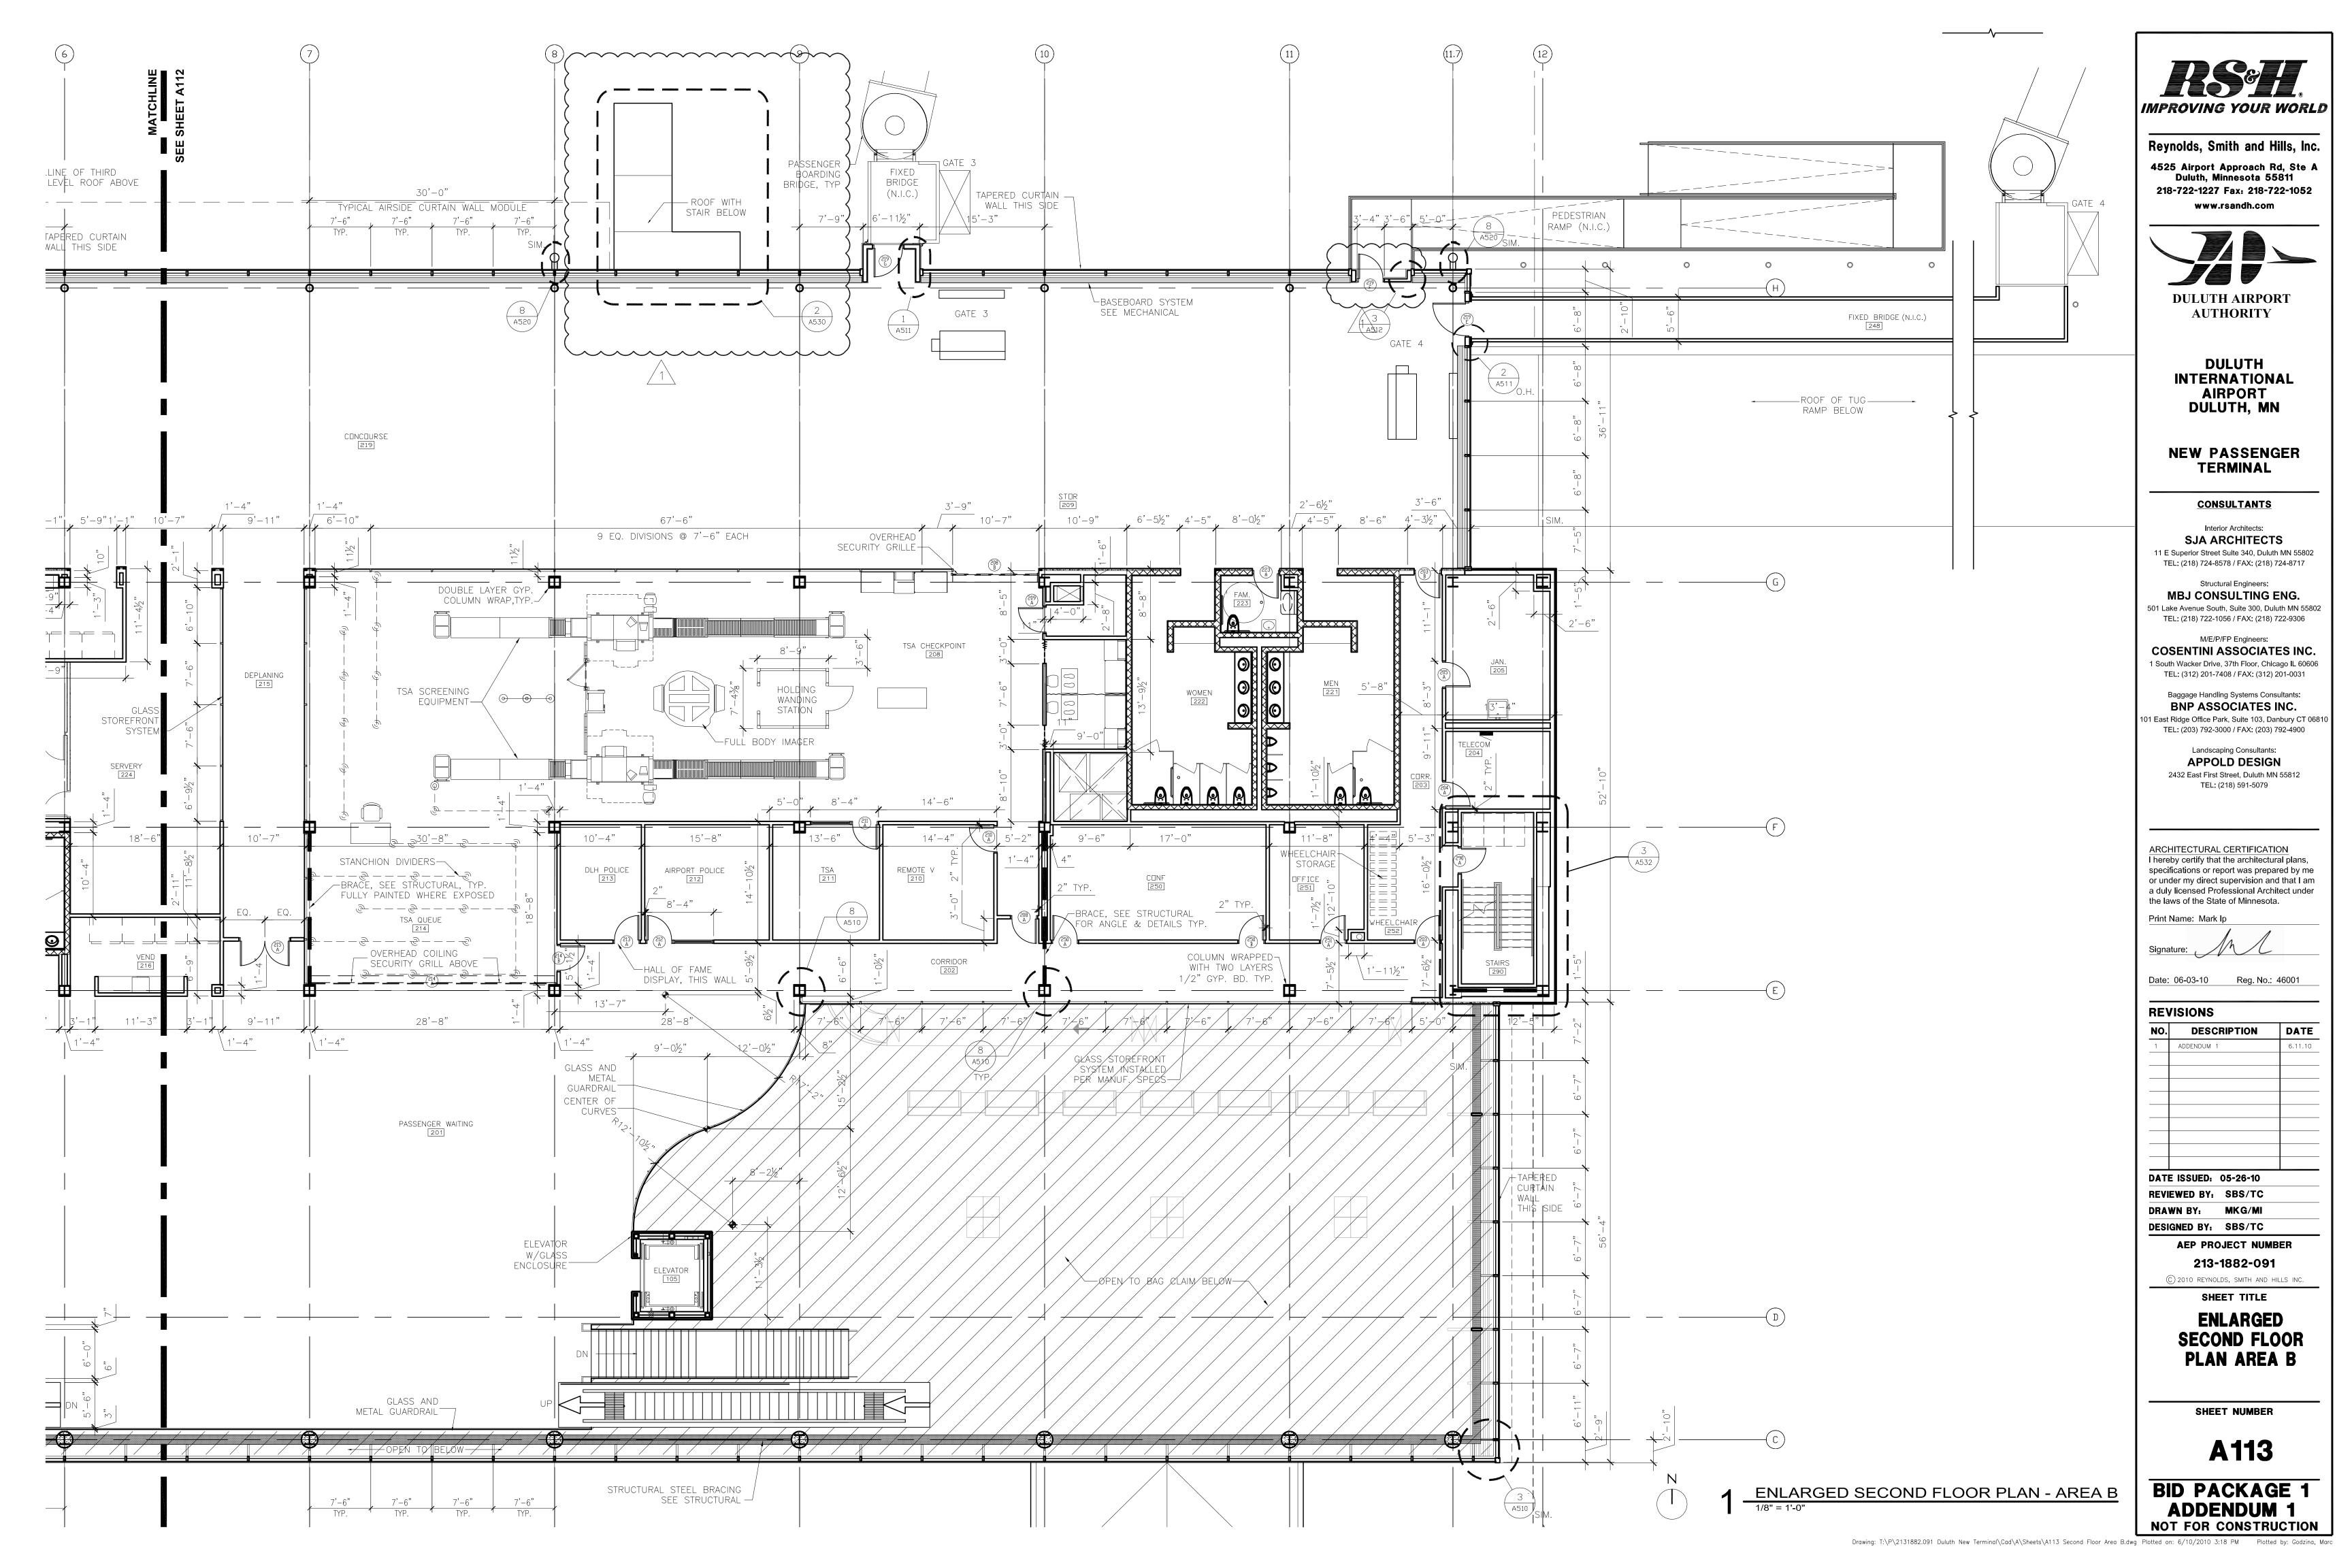
ENLARGED SECOND FLOOR PLAN AREA A


SHEET NUMBER

A112

BID PACKAGE 1
ADDENDUM 1
NOT FOR CONSTRUCTION

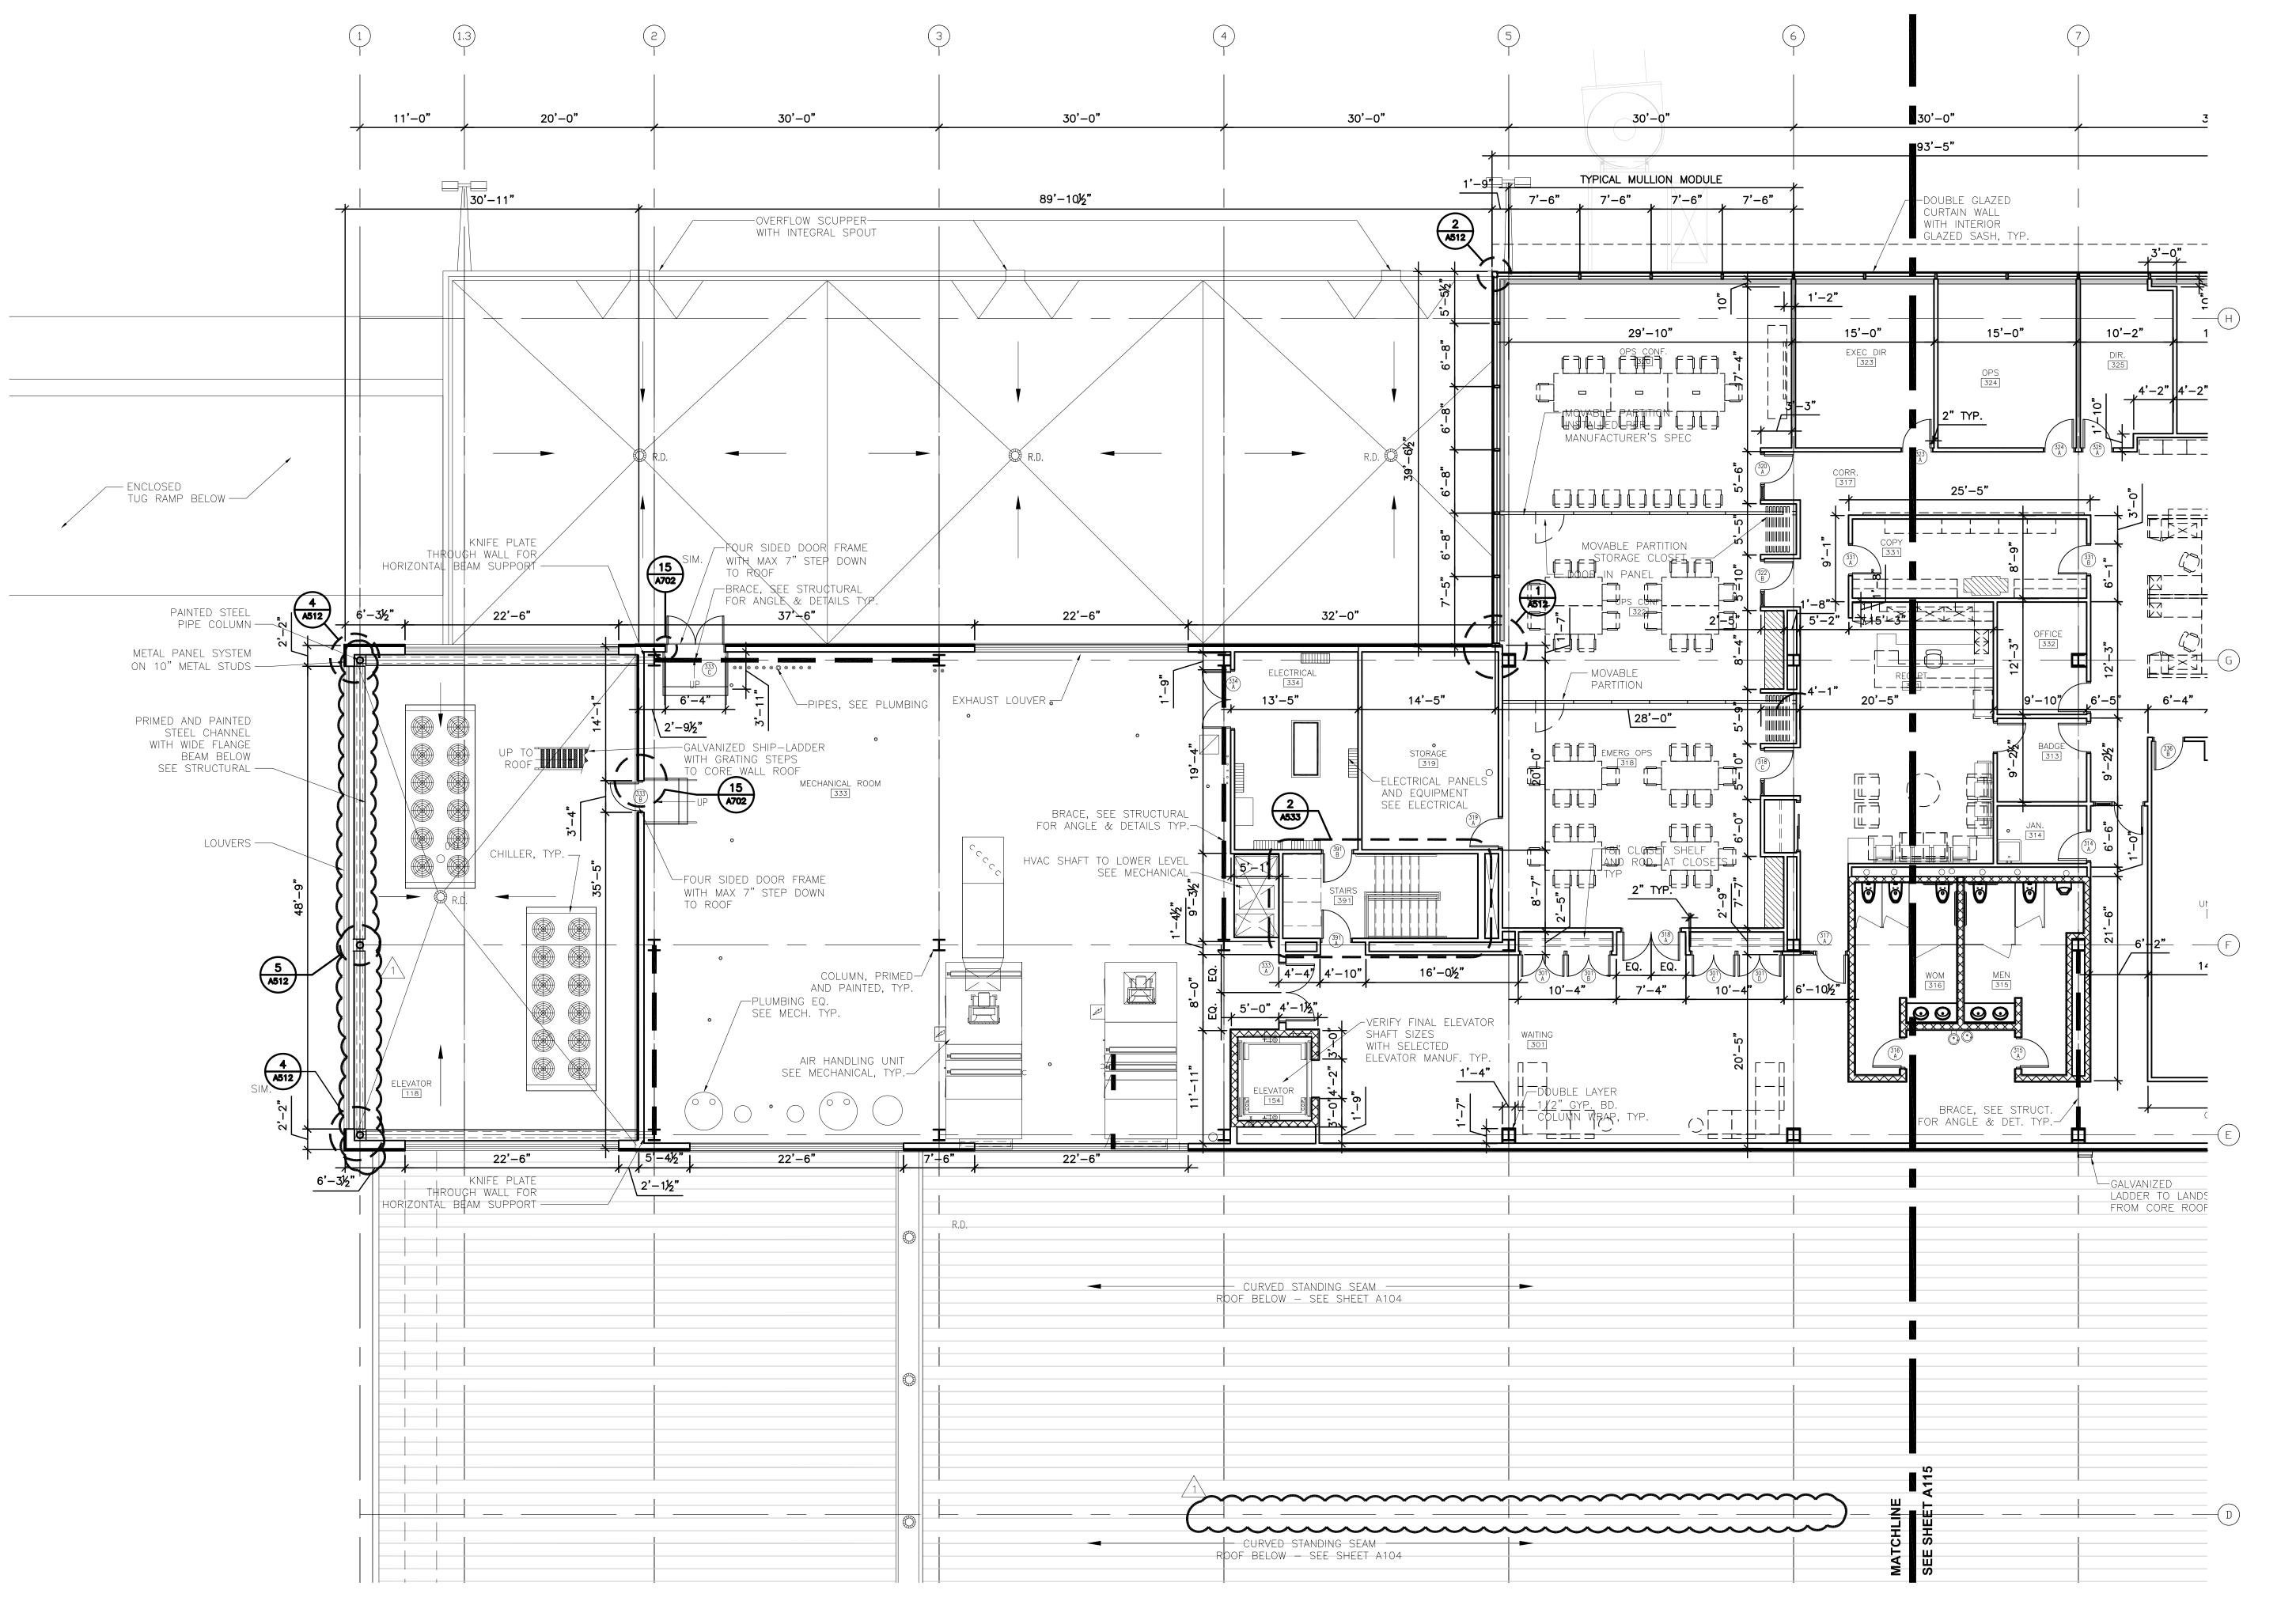Drawing: T:\P\2131882.091 Duluth New Terminal\Cad\A\Sheets\A112 Second Floor Area A.dwg Plotted on: 6/10/2010 3:18 PM Plotted by: Godzina, Marc





1 ENLARGED THIRD LEVEL FLOOR PLAN - AREA A

1/8" = 1'-0"



Reynolds, Smith and Hills, Inc.

4525 Airport Approach Rd, Ste A
Duluth, Minnesota 55811

218-722-1227 Fax: 218-722-1052
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DULUTH
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AIRPORT
DULUTH, MN

NEW PASSENGER TERMINAL

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AEP PROJECT NUMBER

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REVIEWED BY: SBS/TC

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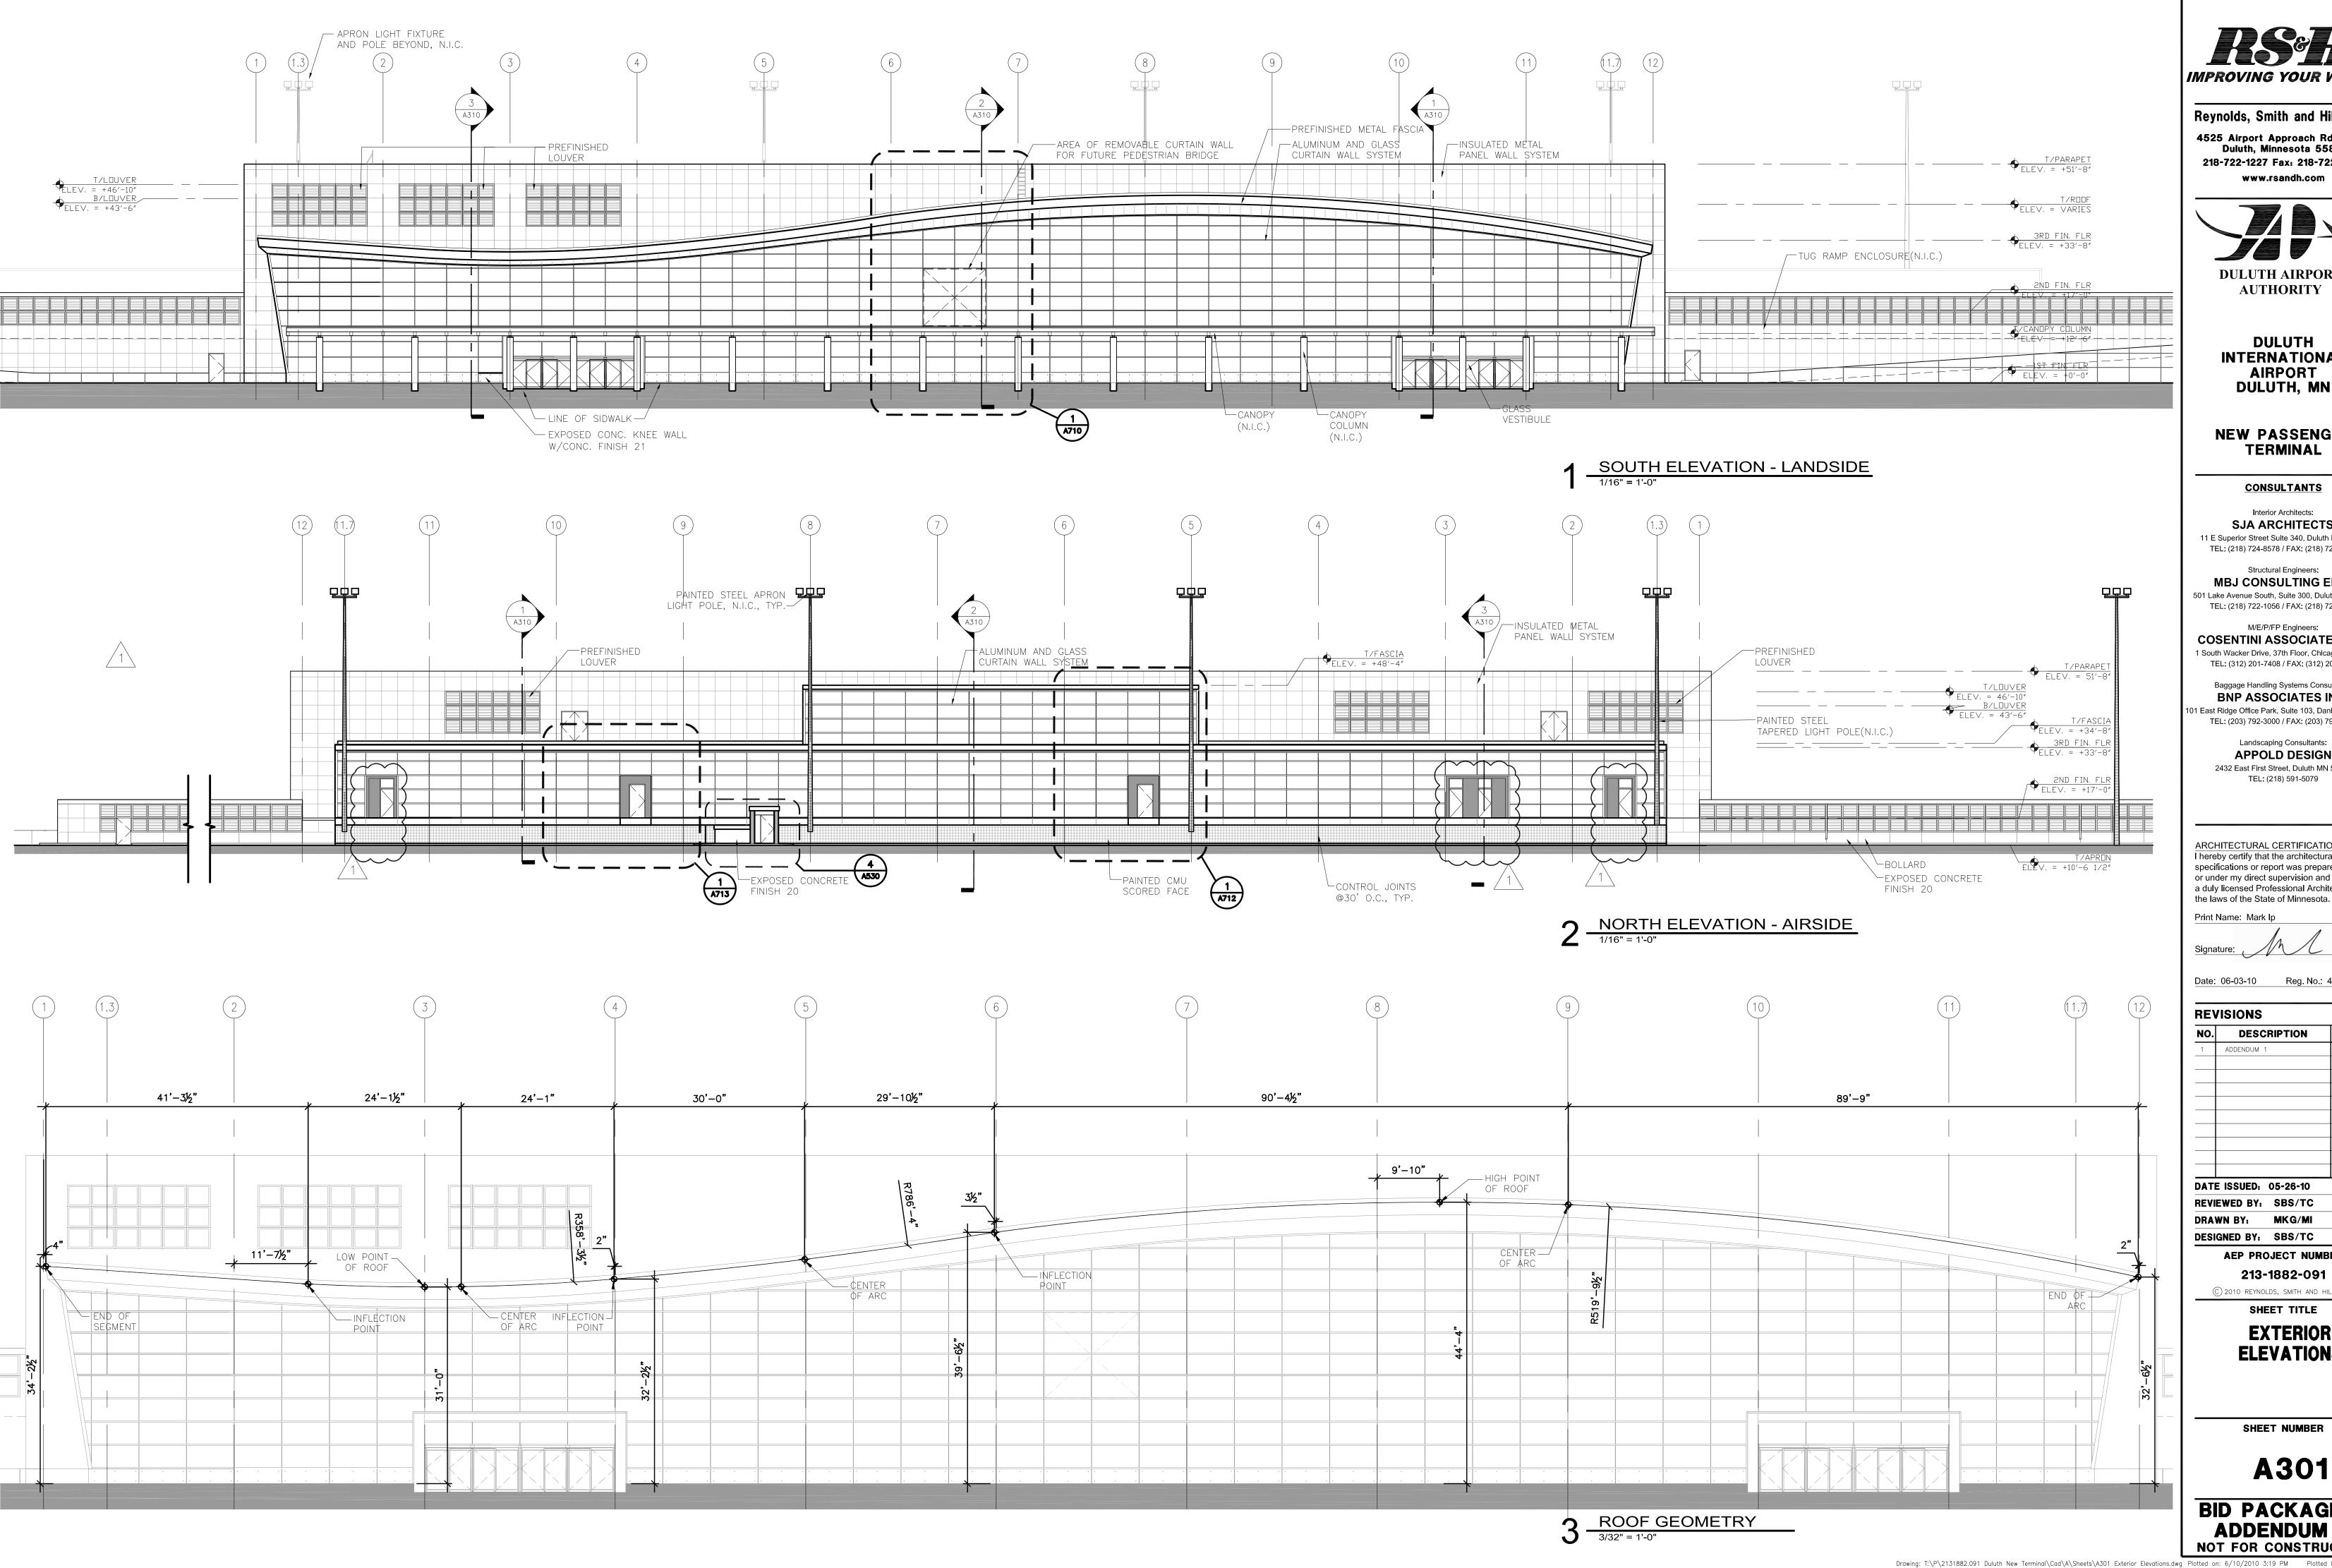
ENLARGED THIRD FLOOR PLAN AREA A

SHEET NUMBER

A114

BID PACKAGE 1
ADDENDUM 1
NOT FOR CONSTRUCTION

Drawing: T:\P\2131882.091 Duluth New Terminal\Cad\A\Sheets\A114 Third Floor Area A.dwg Plotted on: 6/10/2010 3:19 PM Plotted by: Godzina, Marc





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NEW PASSENGER TERMINAL

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Print Name: Mark Ip

Date: 06-03-10 Reg. No.: 46001

REVISIONS

DATE NO. DESCRIPTION ADDENDUM 1 **DATE ISSUED: 05-26-10**

REVIEWED BY: SBS/TC DRAWN BY: MKG/MI

DESIGNED BY: SBS/TC **AEP PROJECT NUMBER**

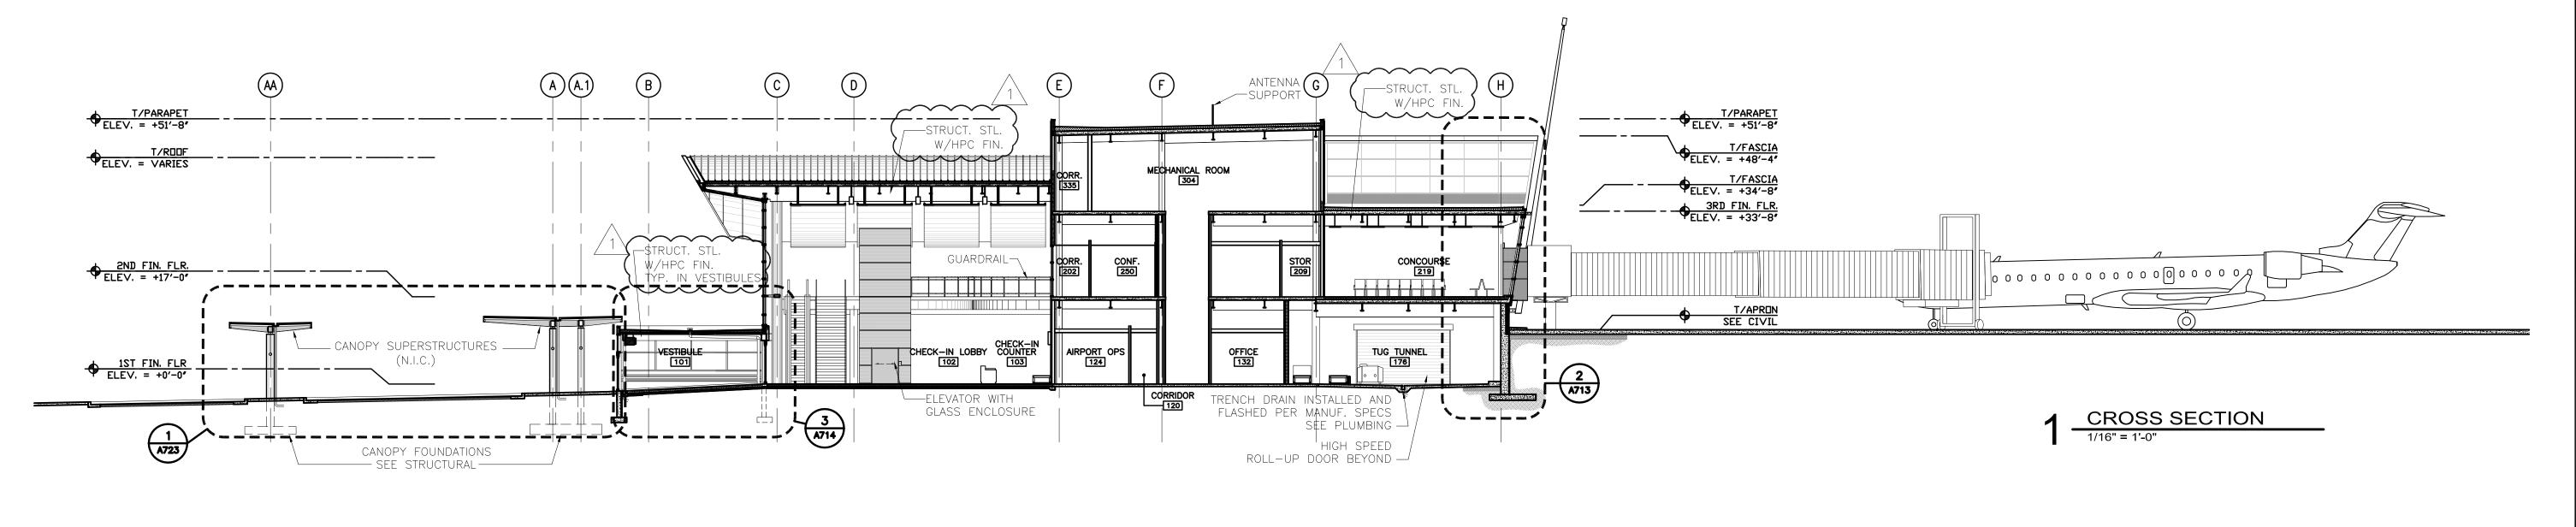
213-1882-091

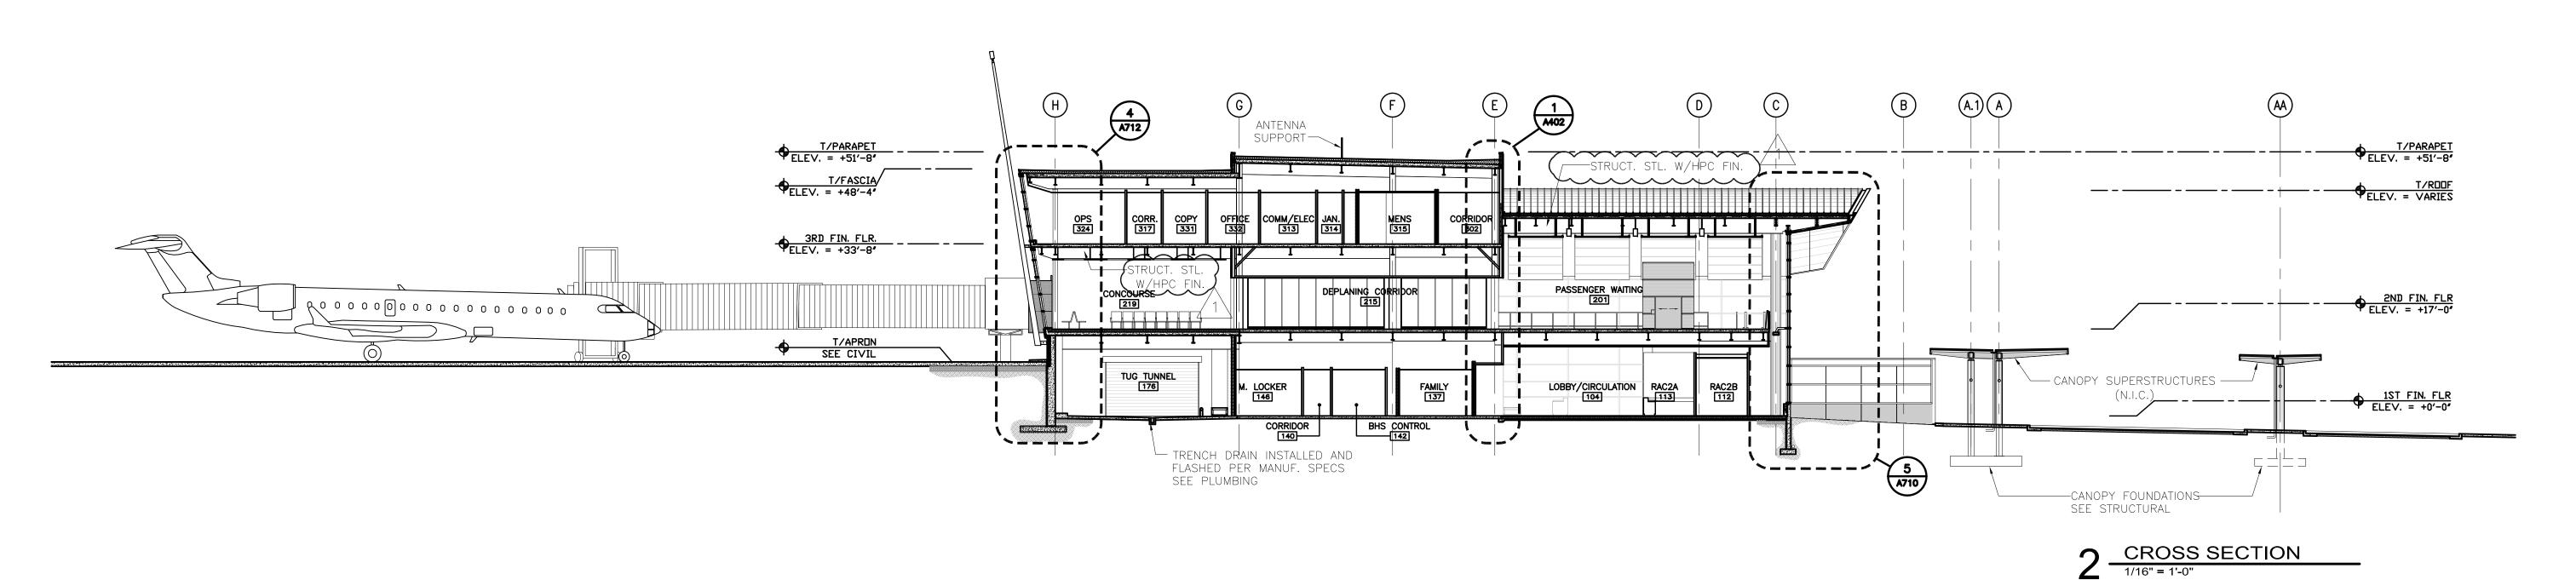
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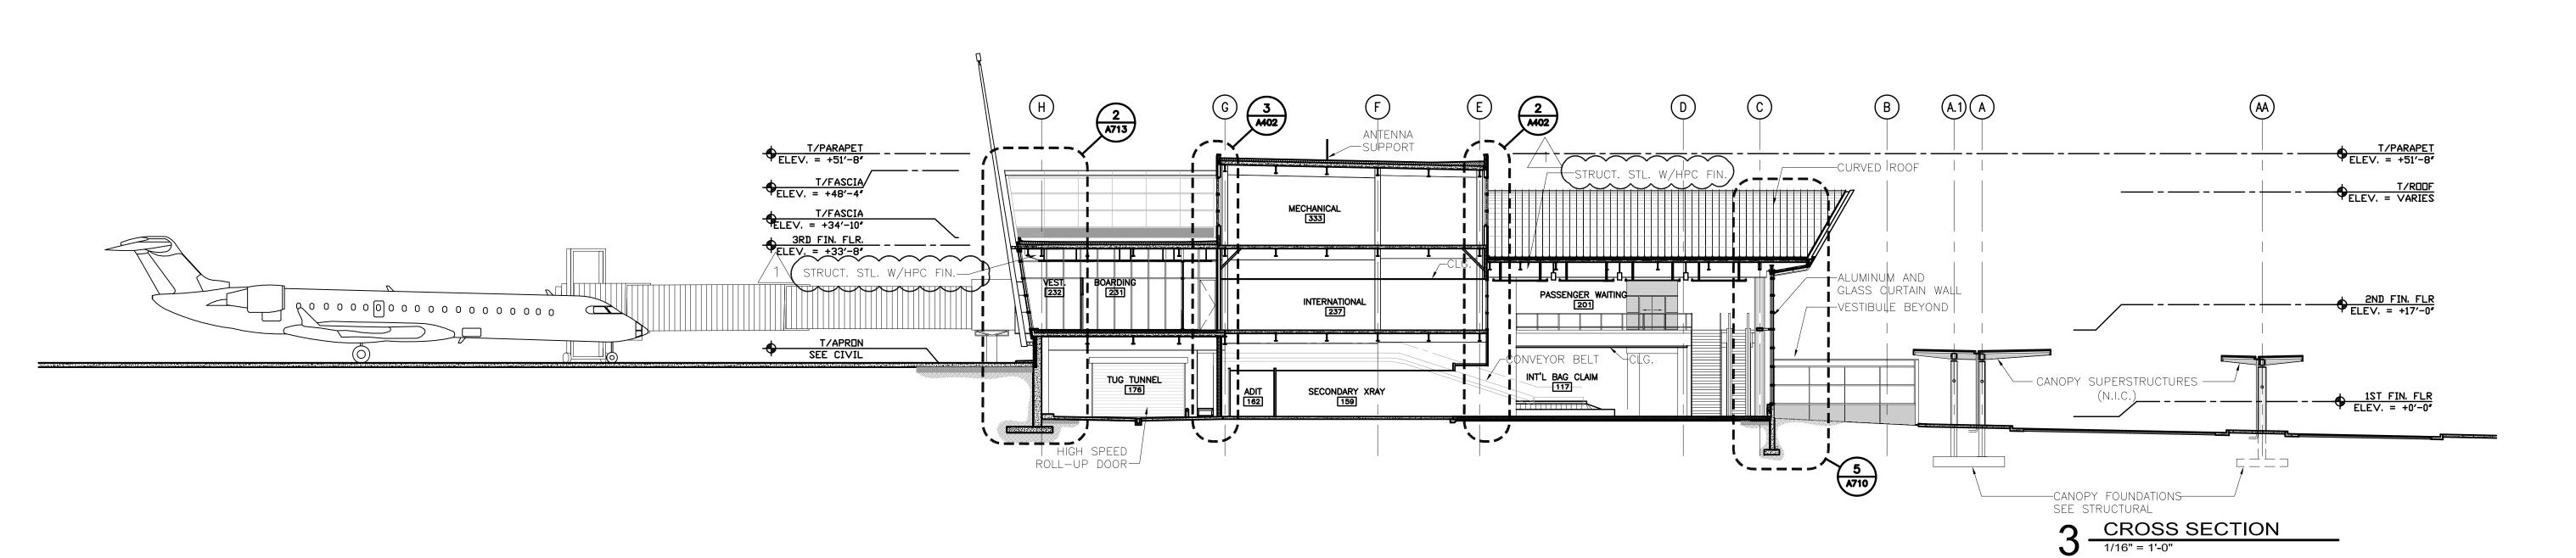
> **EXTERIOR ELEVATIONS**

SHEET NUMBER

A301









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Date: 06-03-10 Reg. No.: 46001

	1
ADDENDUM 1	6.11.10
ISSUED: 05-26-10	
	ISSUED: 05-26-10

DRAWN BY: MKG/MI DESIGNED BY: SBS/TC

AEP PROJECT NUMBER

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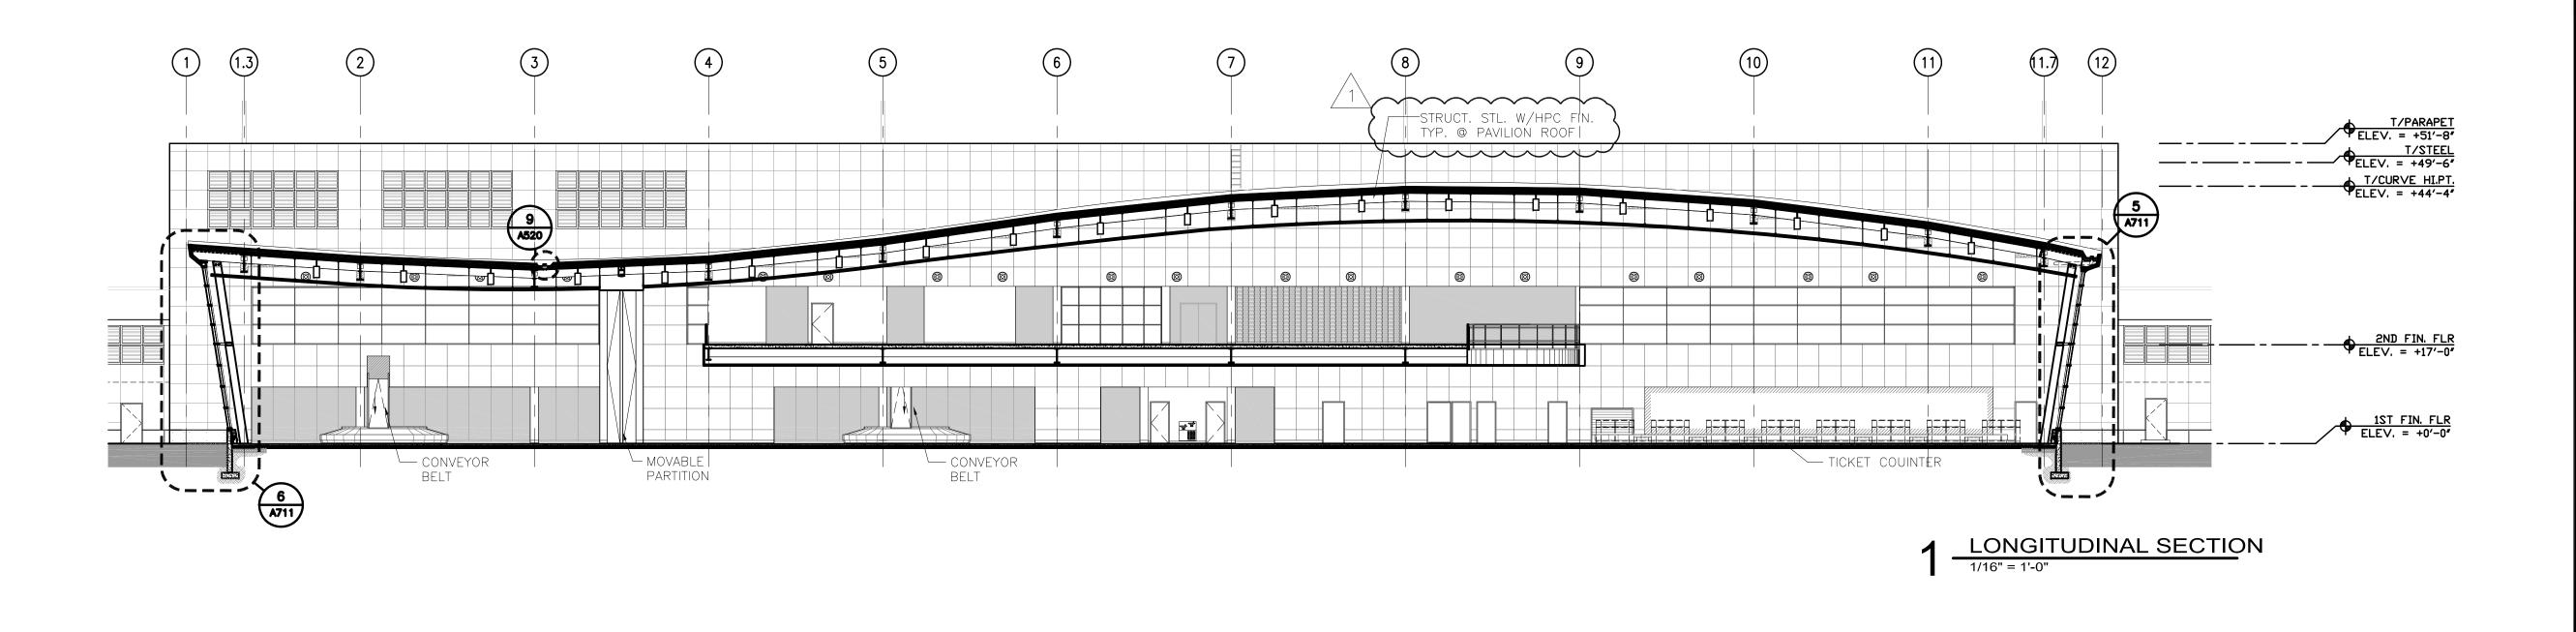
BUILDING SECTIONS

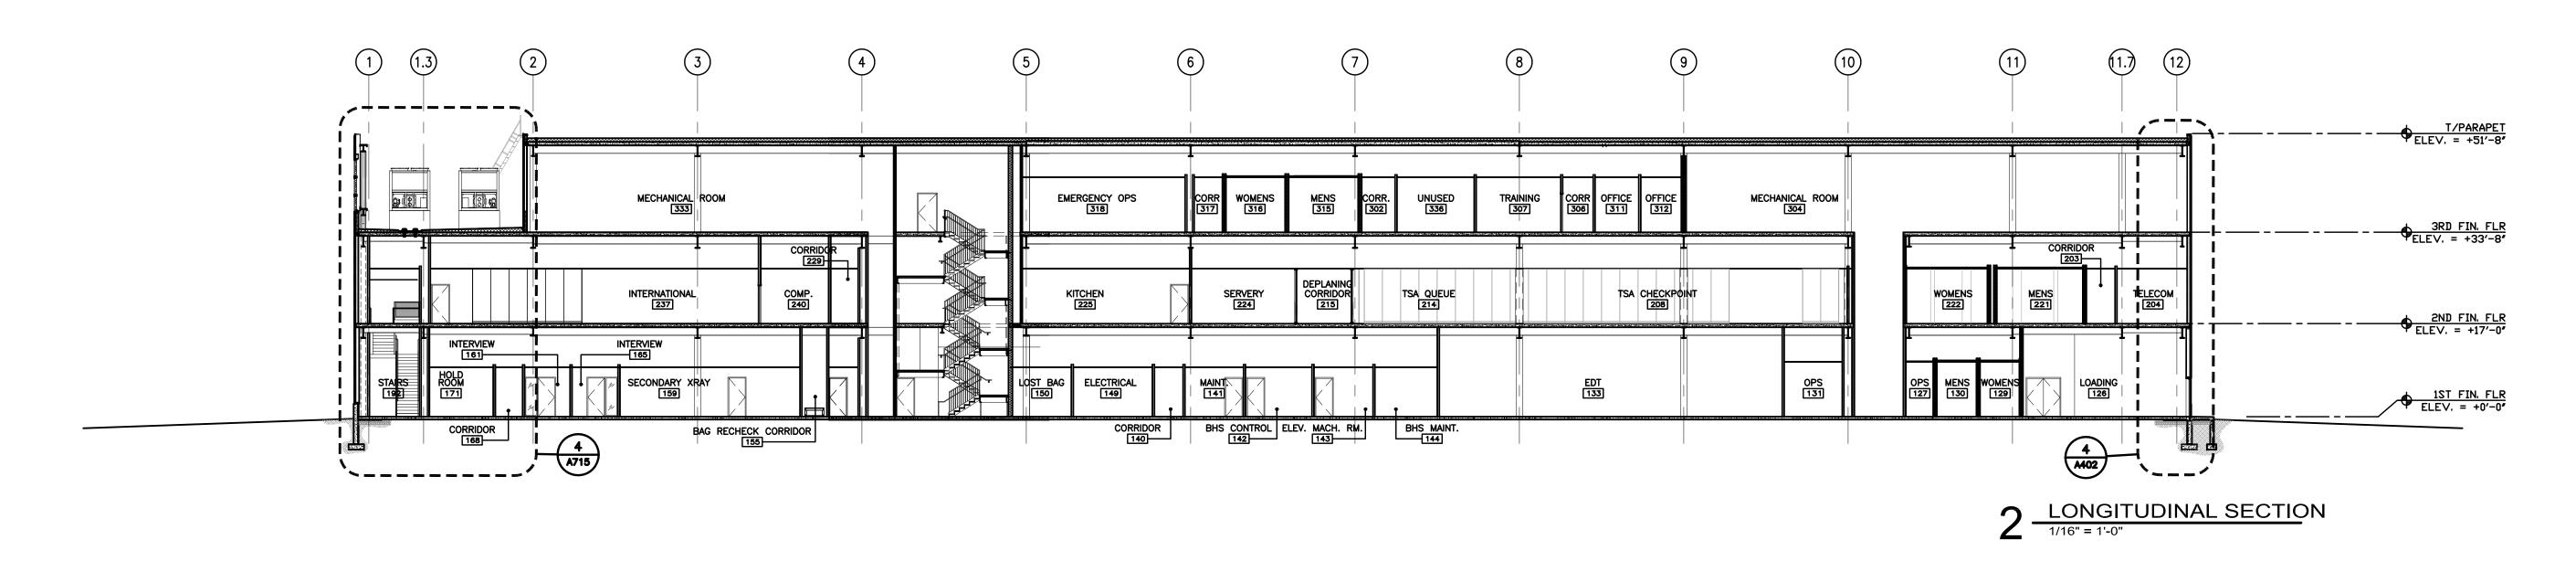
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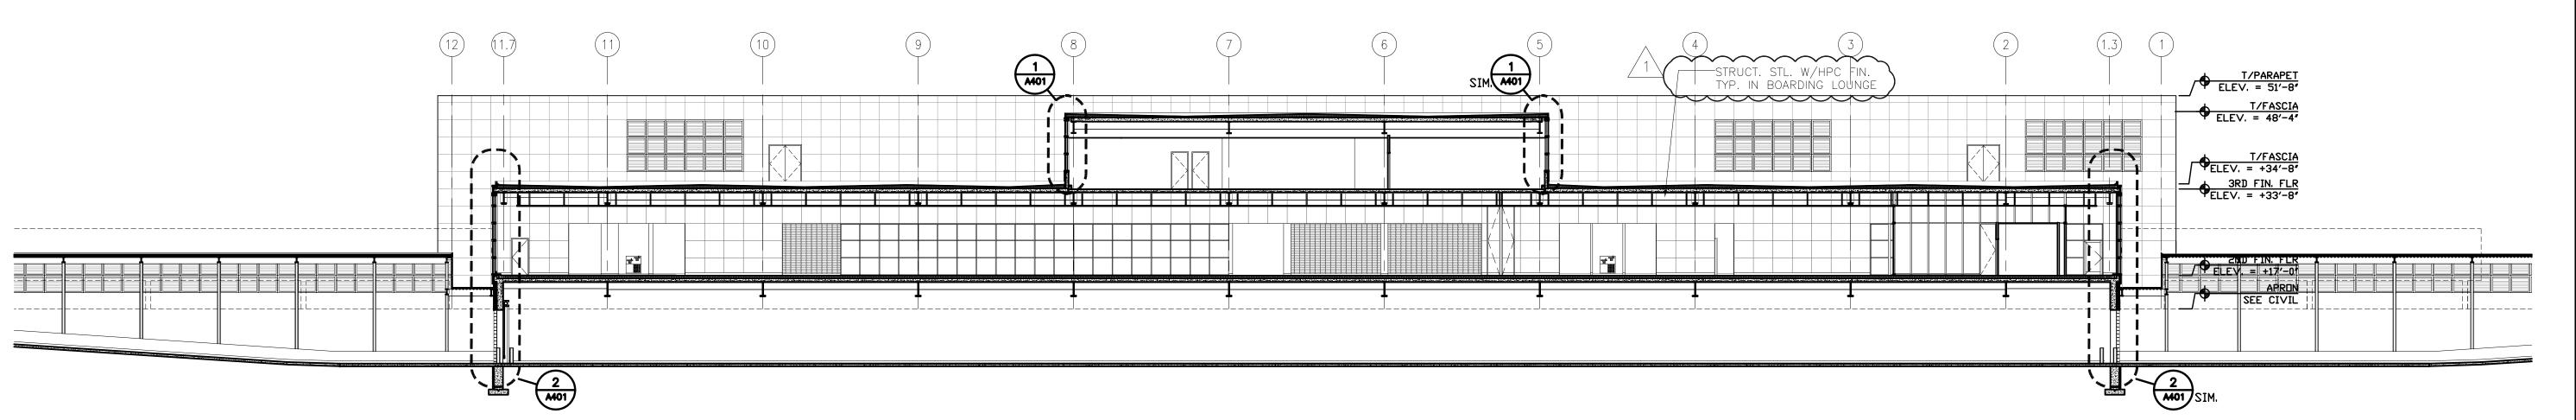
A310

BID PACKAGE 1 ADDENDUM 1 NOT FOR CONSTRUCTION

Drawing: T:\P\2131882.091 Duluth New Terminal\Cad\A\Sheets\A310 Building Sections.dwg Plotted on: 6/10/2010 3:21 PM Plotted by: Godzina, Marc







3 LONGITUDINAL SECTION

1/16" = 1'-0"



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DULUTH INTERNATIONAL **AIRPORT** DULUTH, MN

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Date: 06-03-10 Reg. No.: 46001

DEVICIONS

NO.	DESCRIPTION	DATE
1	ADDENDUM 1	6.11.10
DATE	ISSUED: 05-26-10	
REVIE	WED BY: SBS/TC	

DRAWN BY: MKG/MI DESIGNED BY: SBS/TC

AEP PROJECT NUMBER

213-1882-091

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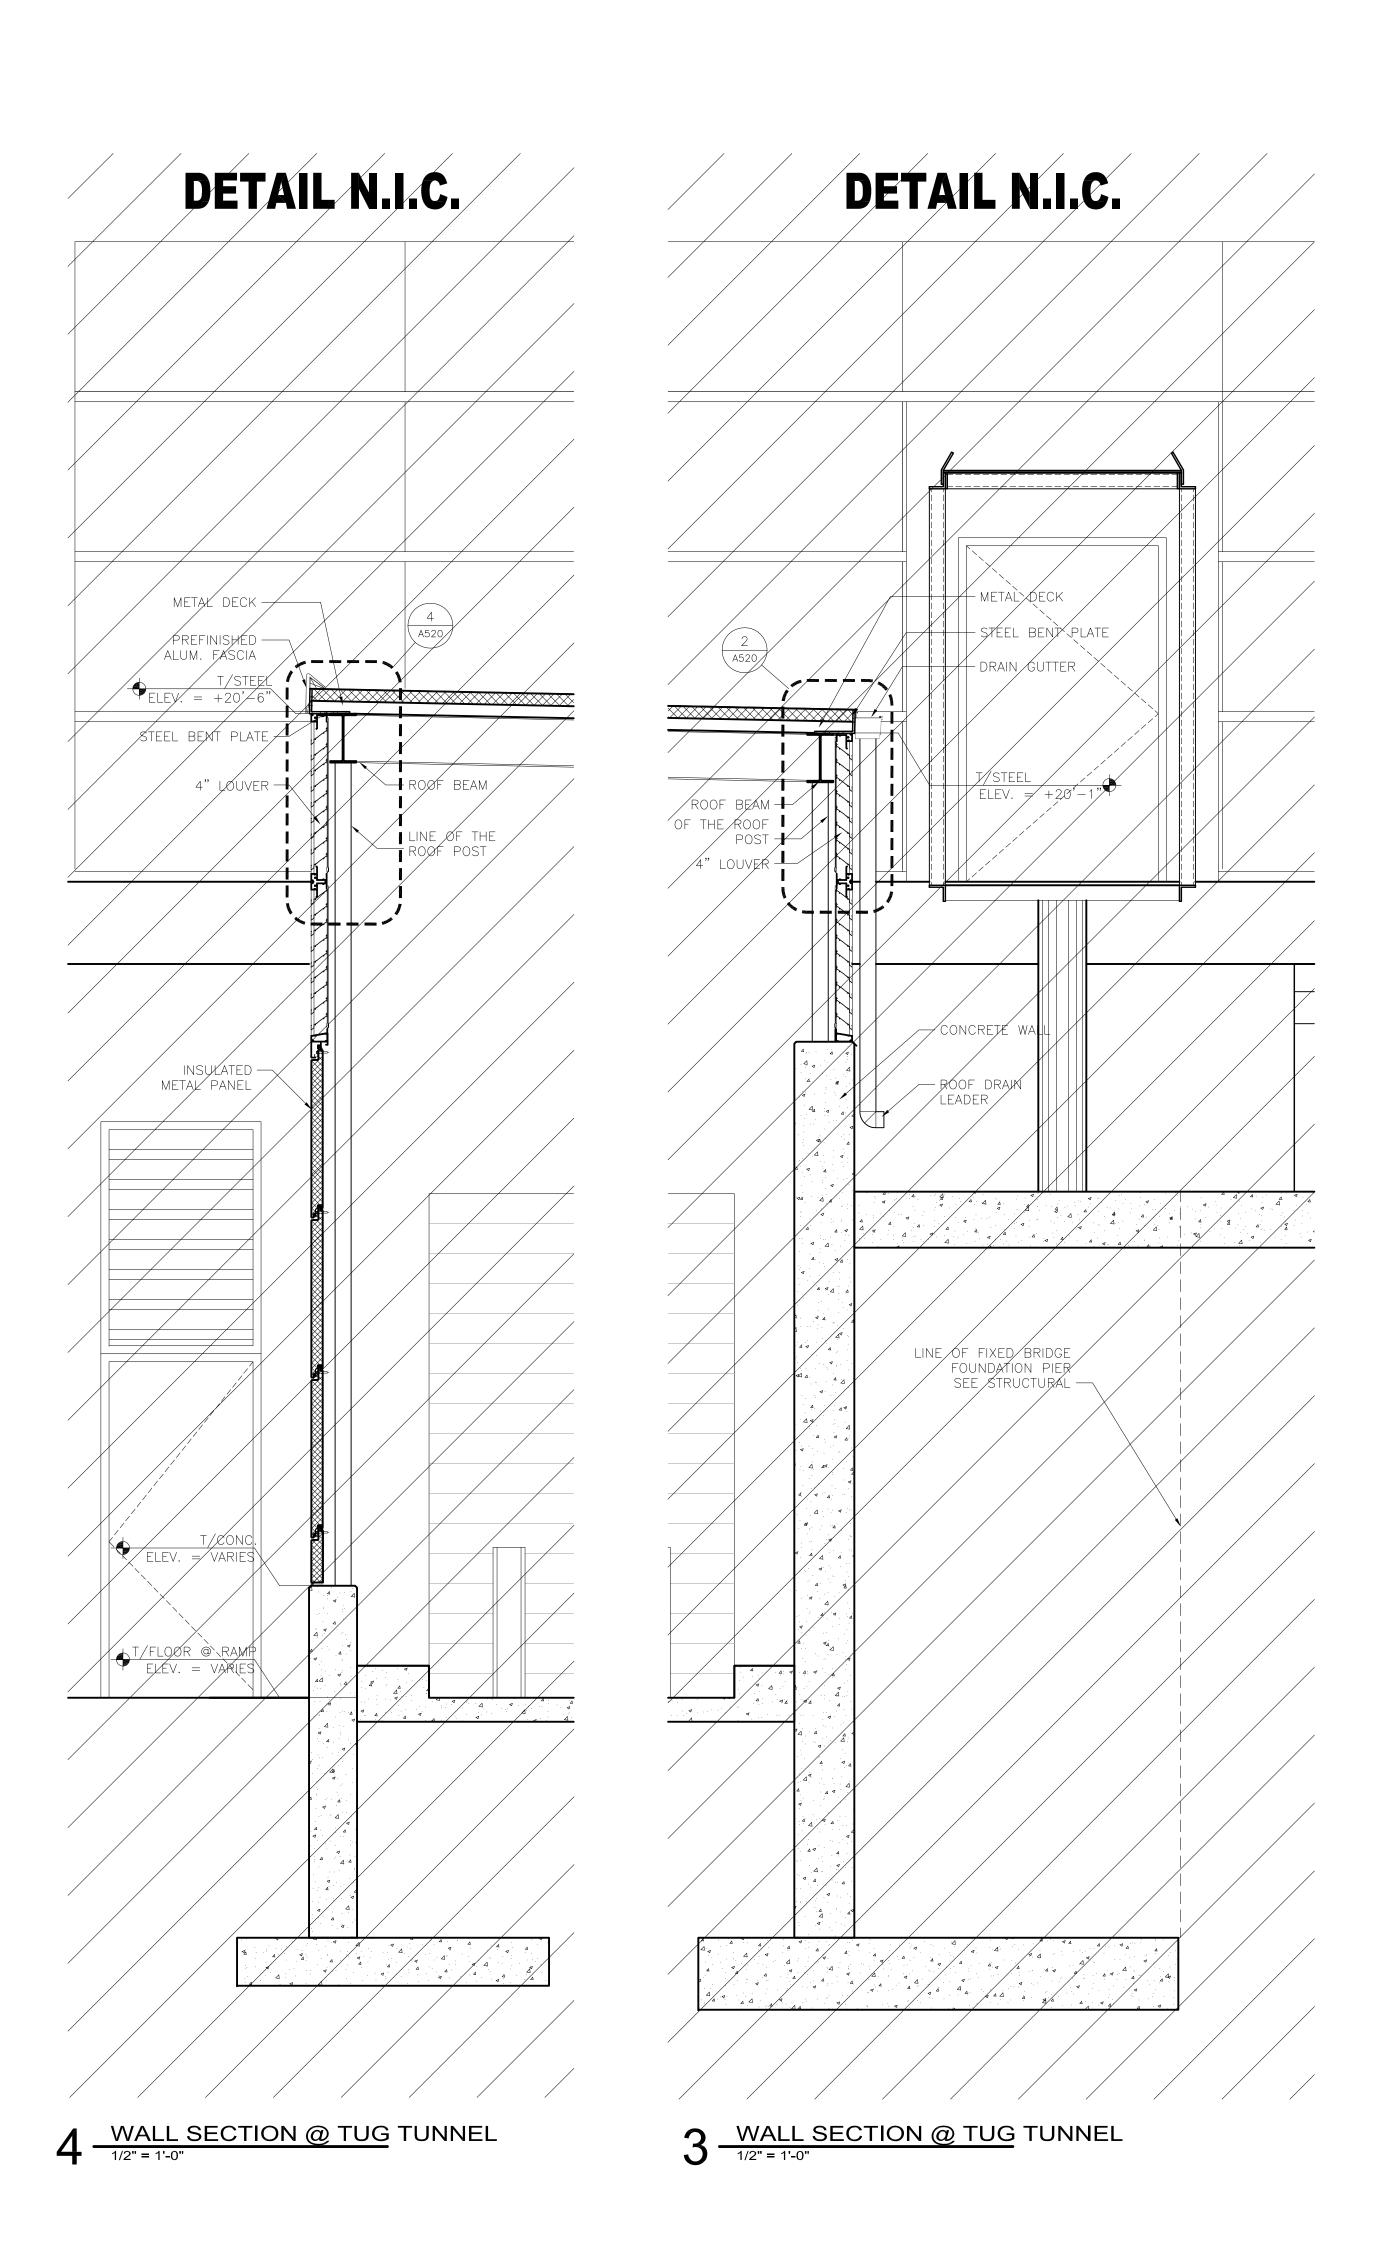
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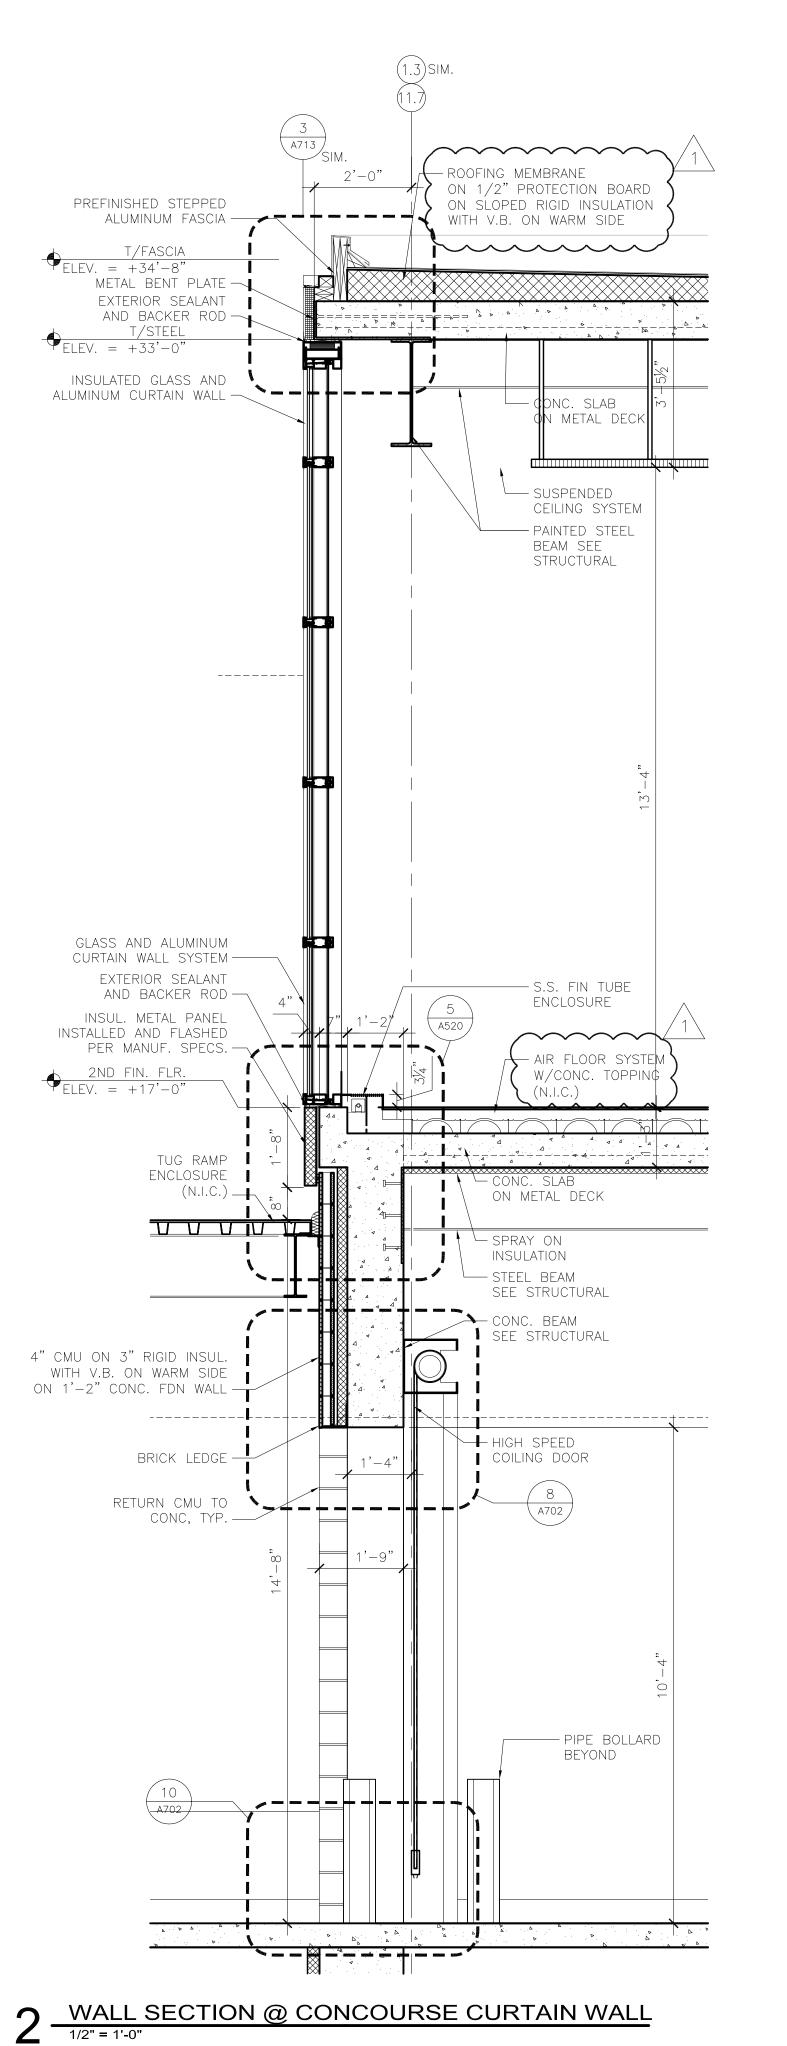
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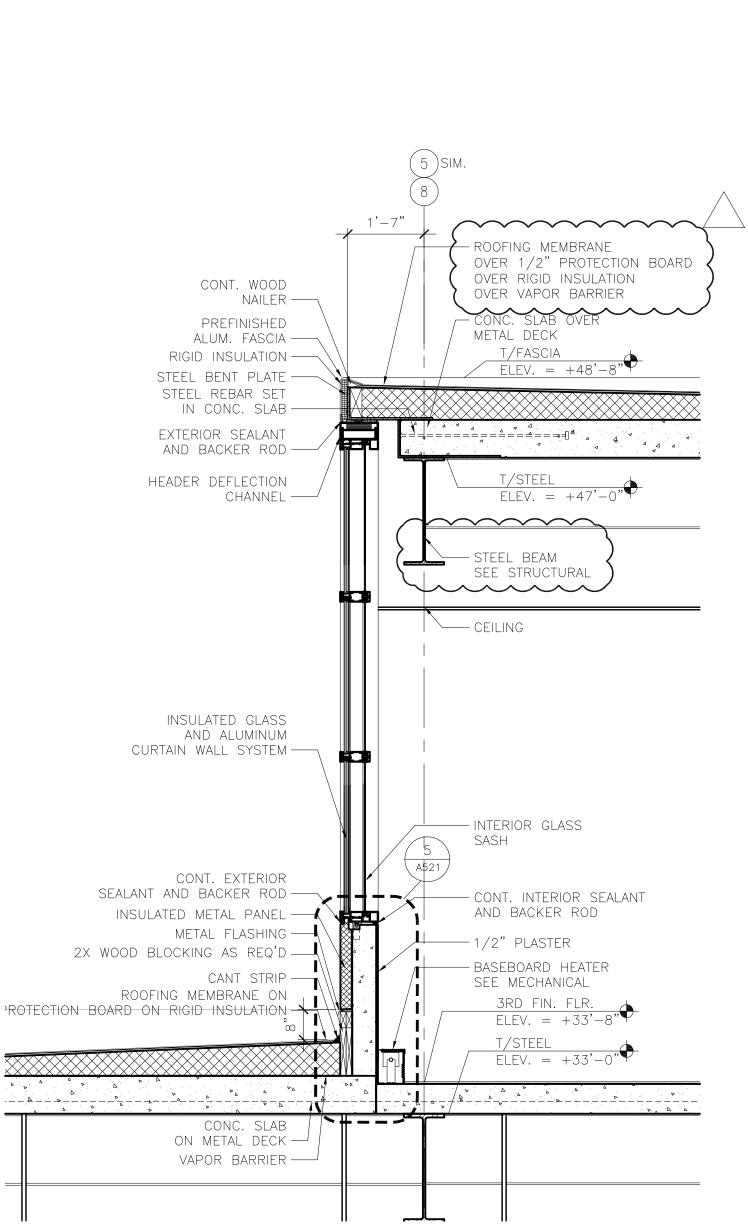
A311

BID PACKAGE 1 ADDENDUM 1 NOT FOR CONSTRUCTION

Drawing: T:\P\2131882.091 Duluth New Terminal\Cad\A\Sheets\A311 Building Sections.dwg Plotted on: 6/10/2010 3:24 PM Plotted by: Godzina, Marc







WALL SECTION @ ADMIN CURTAIN WALL

REVISIONS SHEET TITLE

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Print Name: Mark Ip

Date: 06-03-10 Reg. No.: 46001

NO. DESCRIPTION DATE ADDENDUM 1 **DATE ISSUED: 05-26-10** REVIEWED BY: SBS/TC DRAWN BY: MKG/MI


DESIGNED BY: SBS/TC AEP PROJECT NUMBER

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WALL SECTIONS

SHEET NUMBER

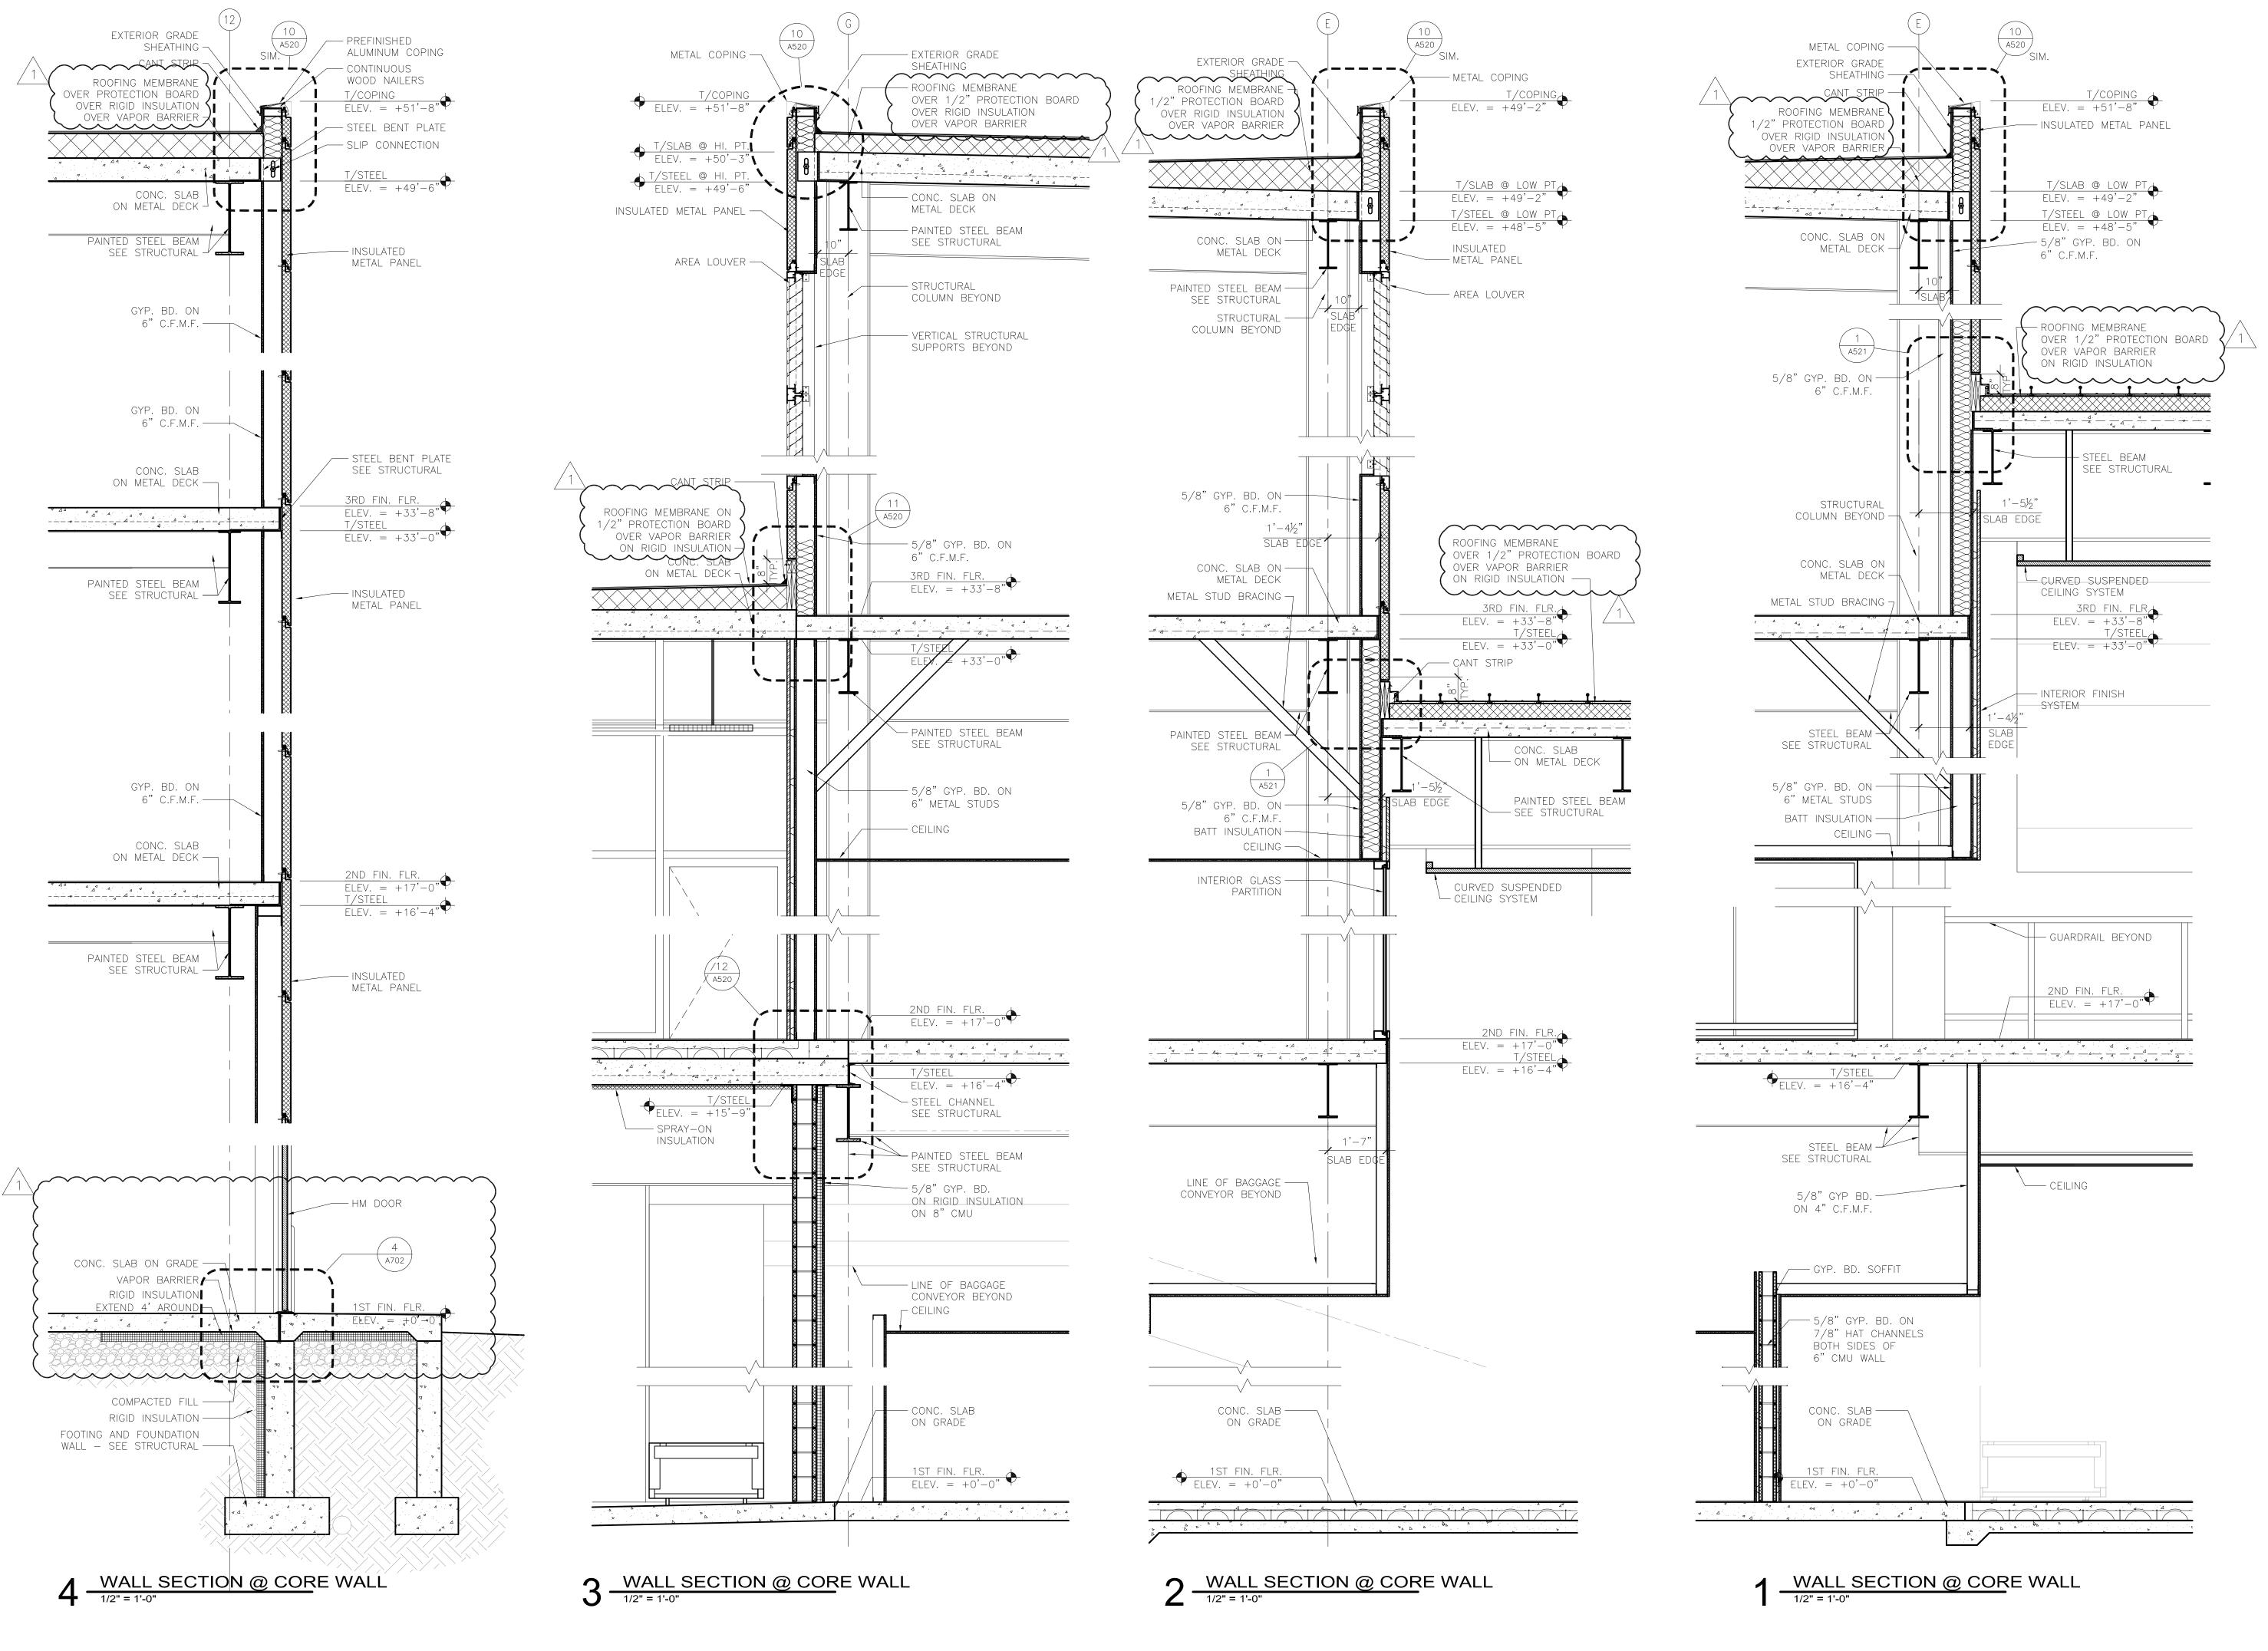A401



ISSET.

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DATE ISSUED: 05-26-10

REVIEWED BY: SBS/TC

DRAWN BY: MKG/MI

DESIGNED BY: SBS/TC

AEP PROJECT NUMBER

213-1882-091
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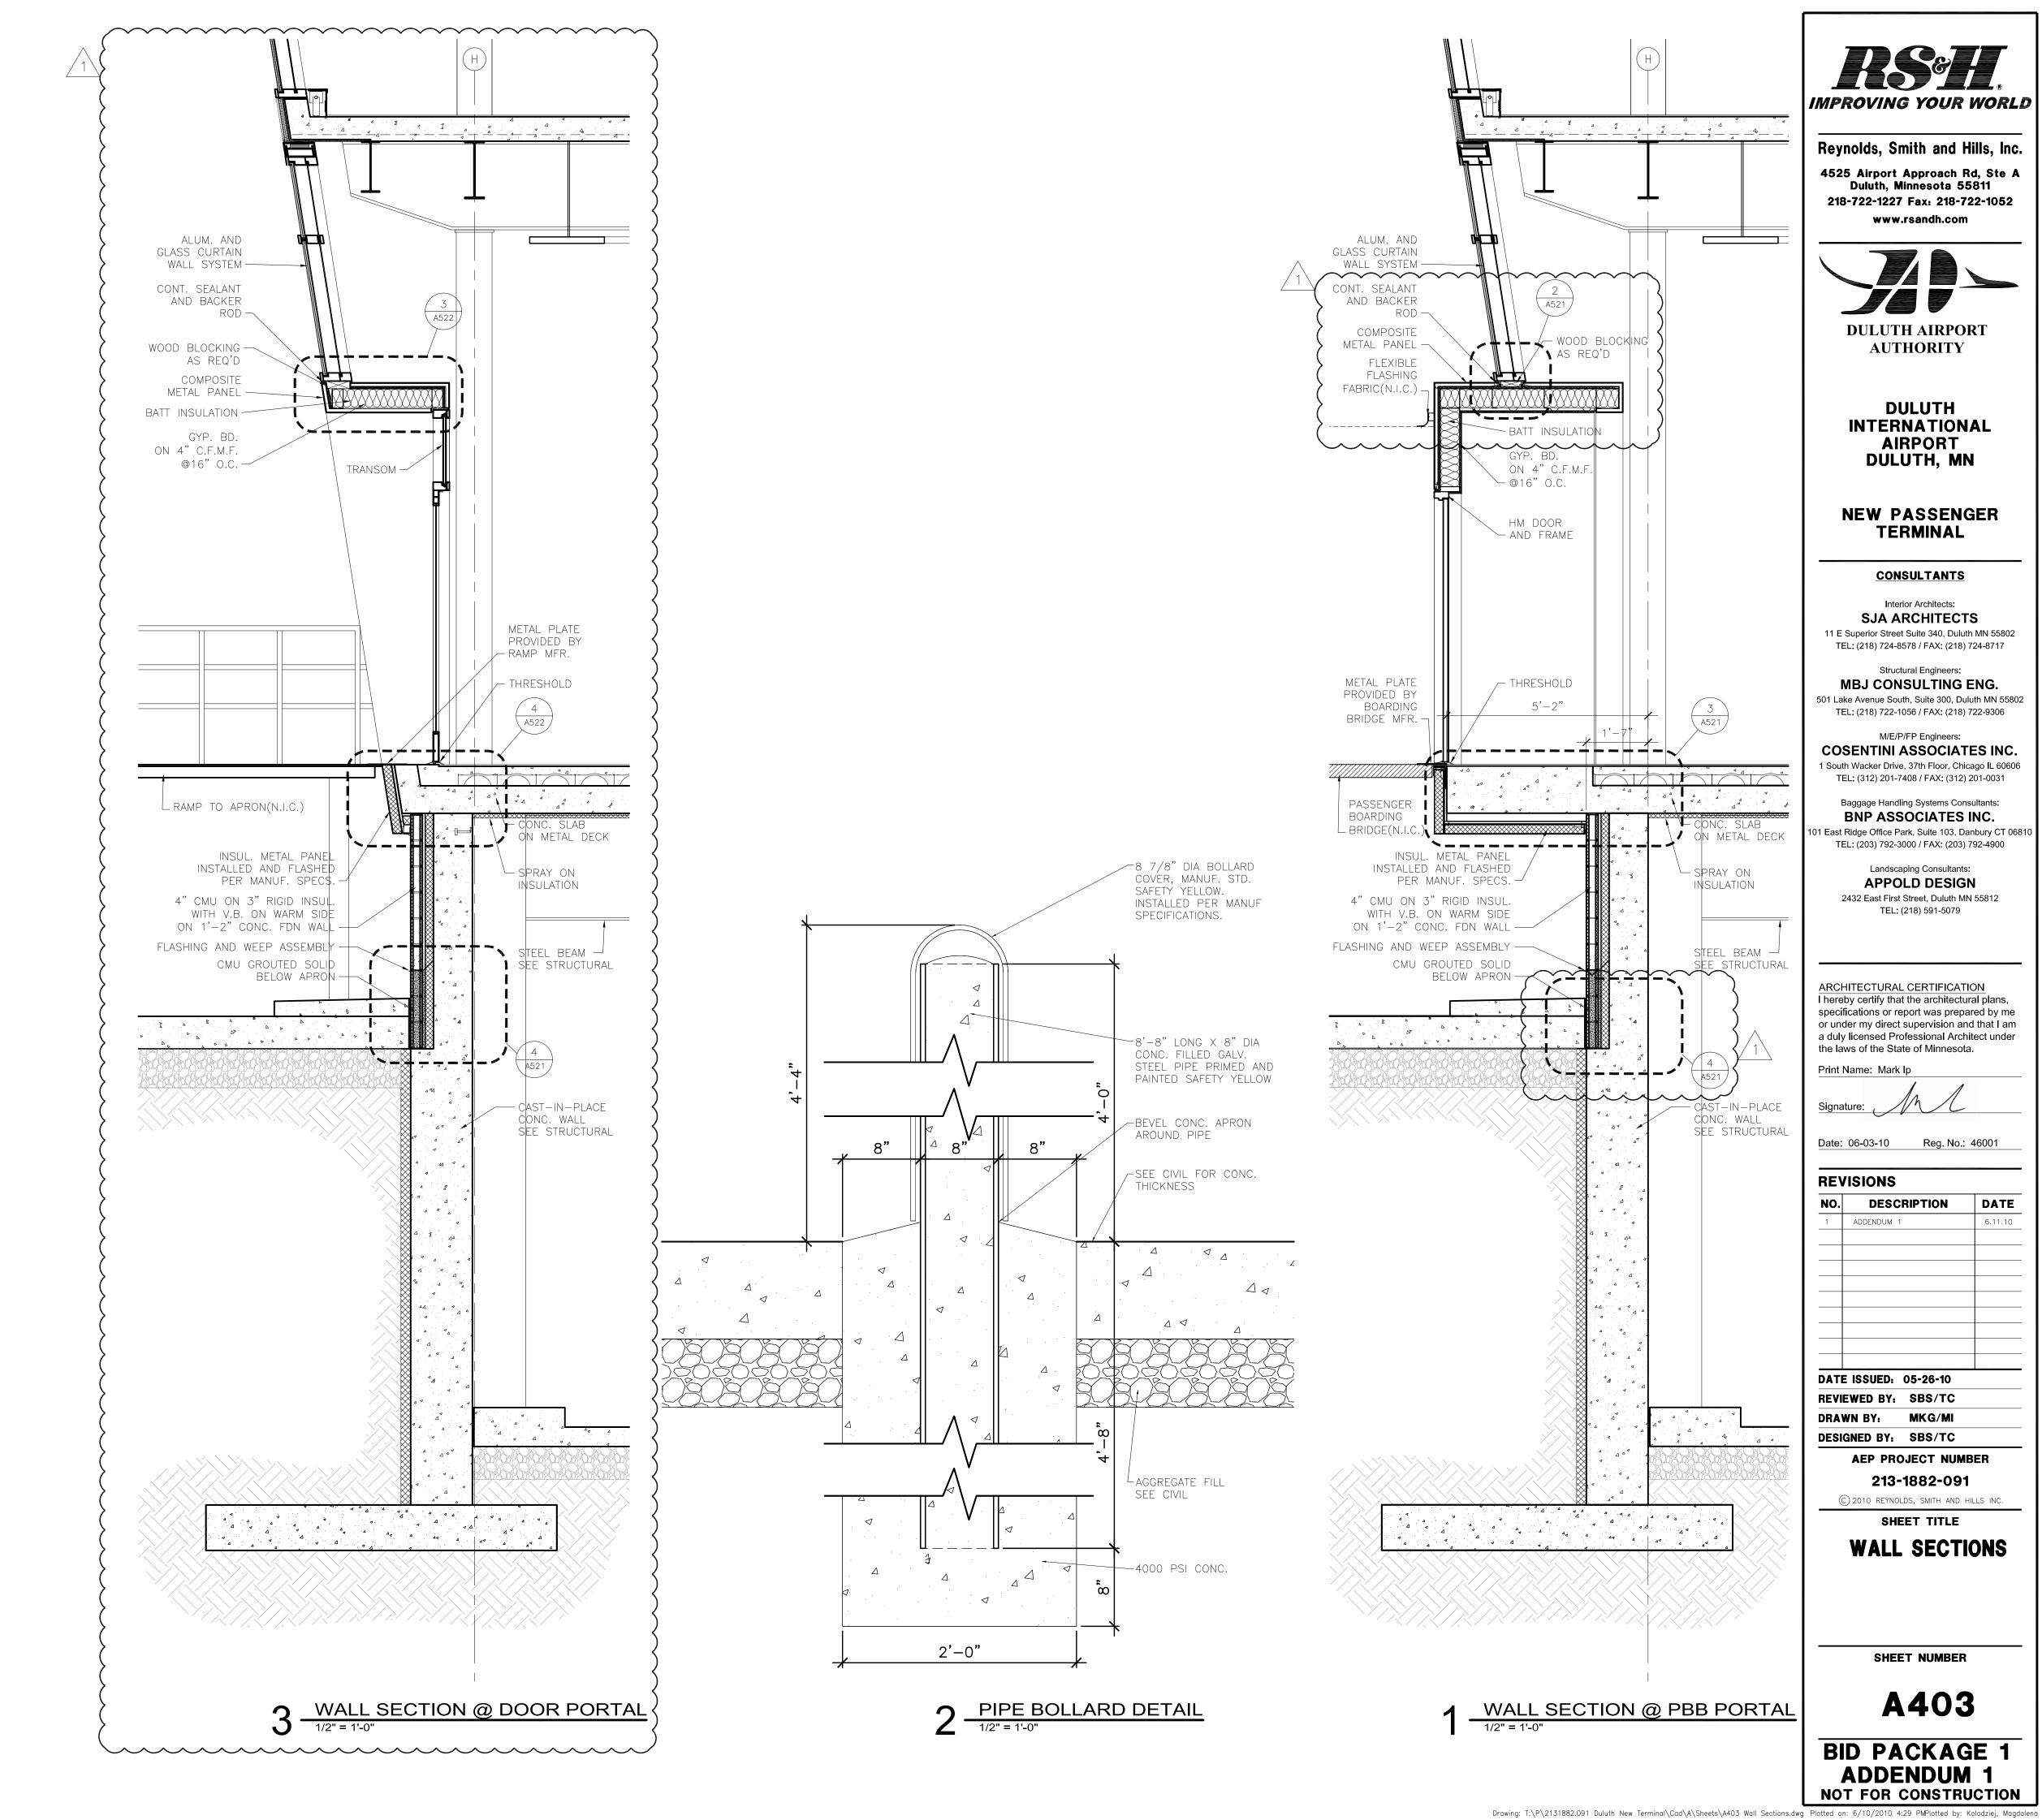
WALL SECTIONS

SHEET NUMBER

A402

BID PACKAGE 1
ADDENDUM 1
NOT FOR CONSTRUCTION

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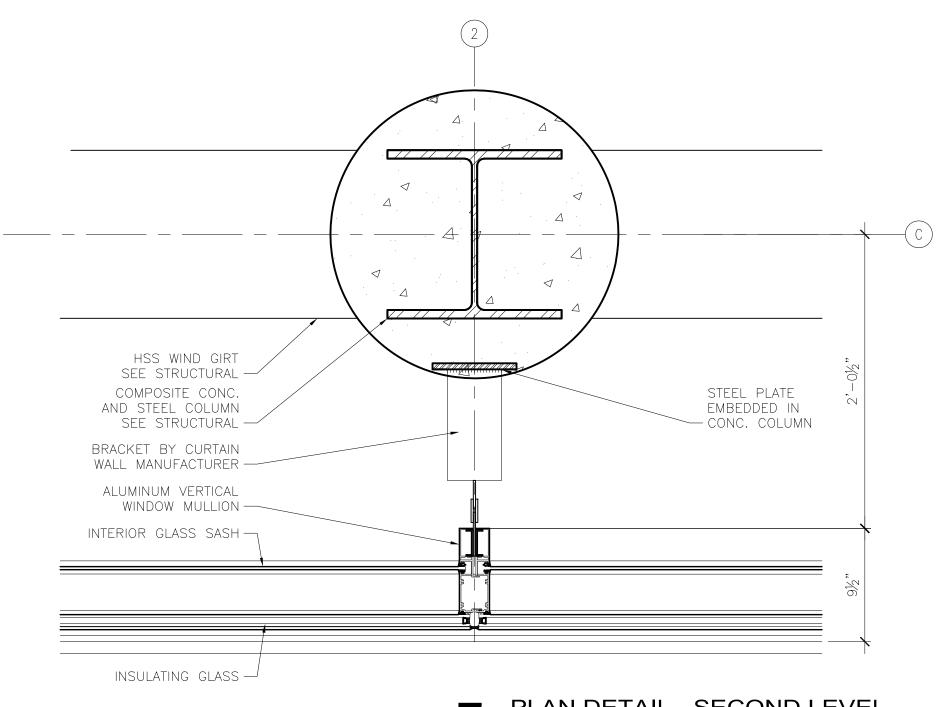
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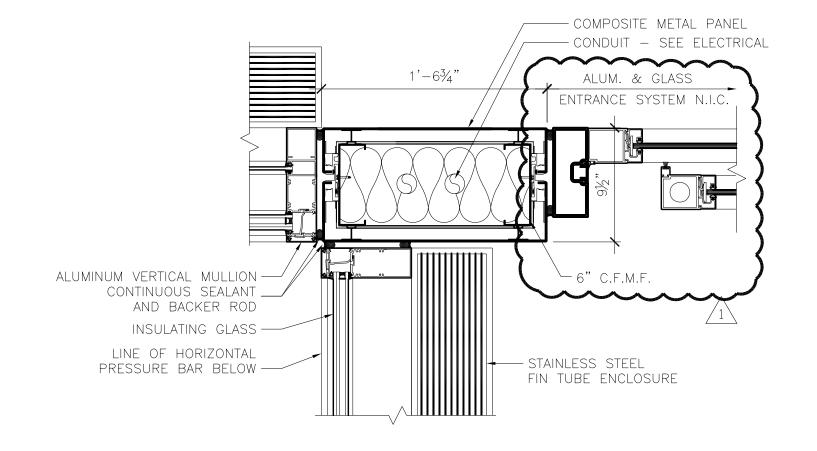


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1 South Wacker Drive, 37th Floor, Chicago IL 60606

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1'-8"

 $1'-6\frac{3}{4}$ "

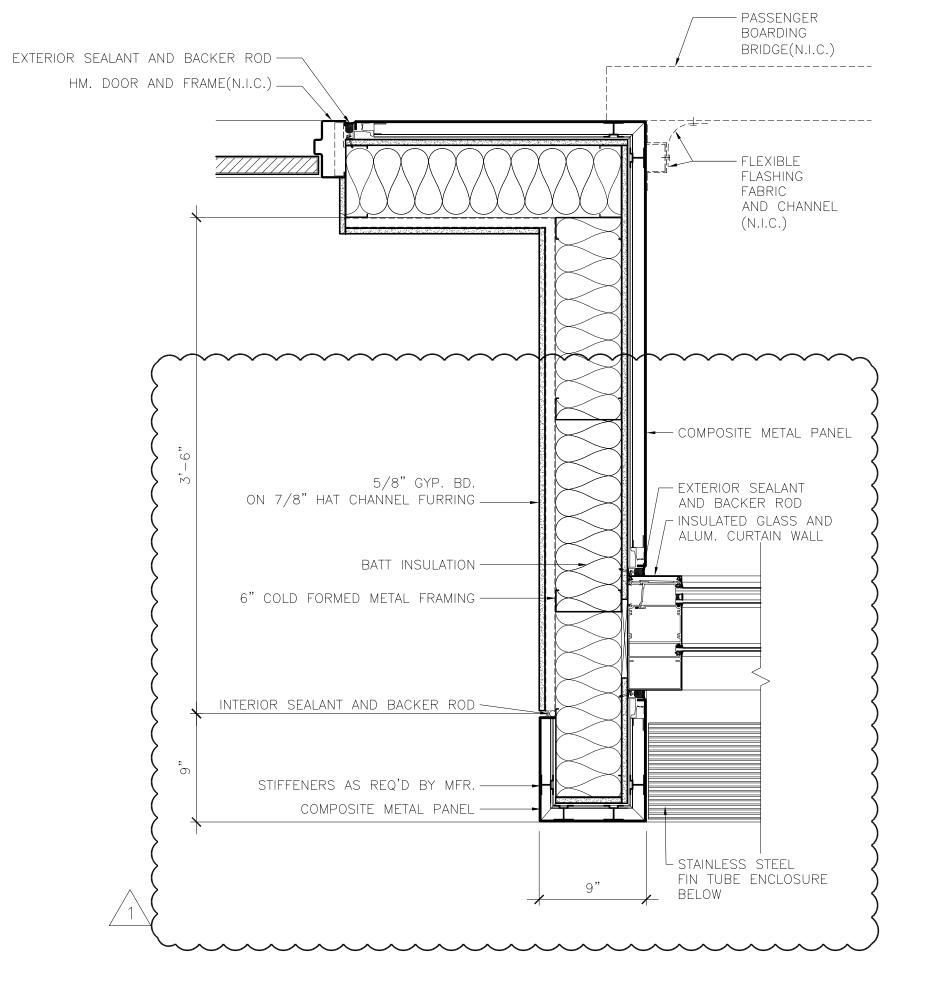
INSULATING GLASS —

COMPOSITE METAL PANEL ---


BATT INSULATION —

ALUMINUM VERTICAL MULLION —

6" C.F.M.F. ———



PLAN DETAIL - SECOND LEVEL

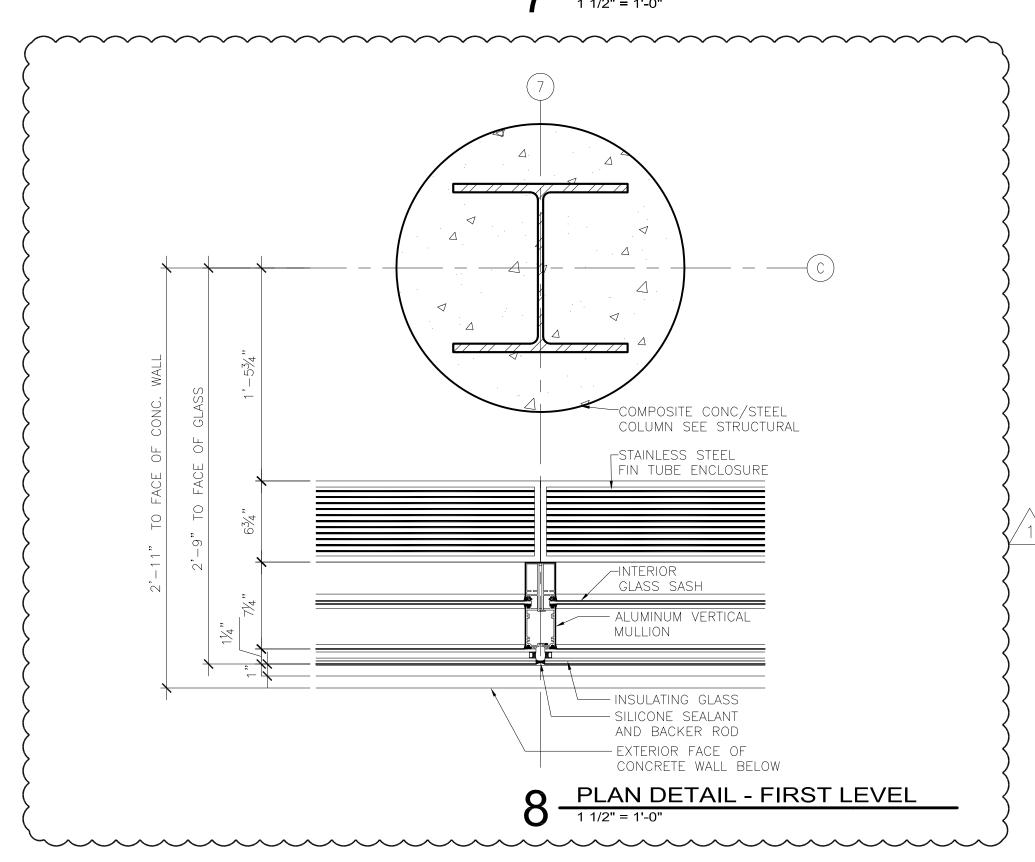



PLAN DETAIL @ VESTIBULE

- STAINLESS STEEL

-6"x6" HSS TUBE

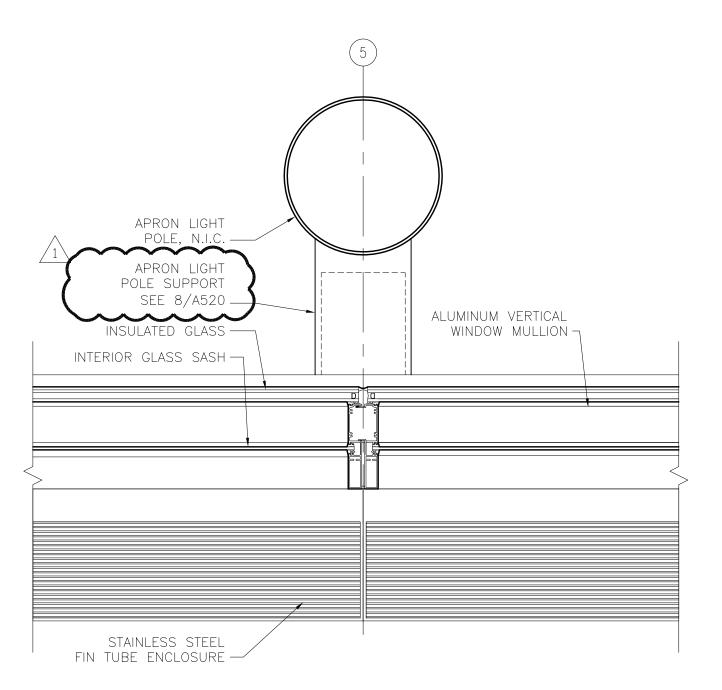
STEEL COLUMN

ALUM. & GLASS

ENTRANCE SYSTEM N.I.C.


SEE STRUCTURAL

FIN TUBE ENCLOSURE



6 PLAN DETAIL - SECOND LEVEL



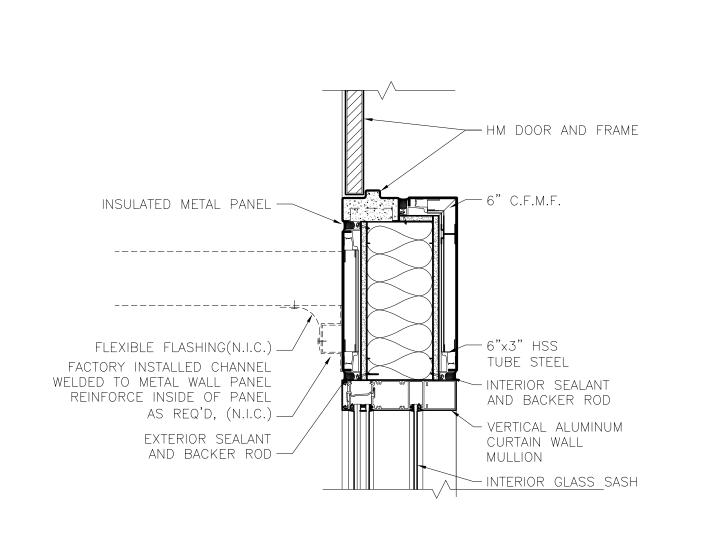

2 PLAN DETAIL @ FIXED BRIDGE
1 1/2" = 1'-0"

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DULUTH AIRPORT AUTHORITY

> **DULUTH INTERNATIONAL AIRPORT** DULUTH, MN

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DRA	WN BY:	MKG/MI	
DESI	GNED BY:	SBS/TC	

AEP PROJECT NUMBER

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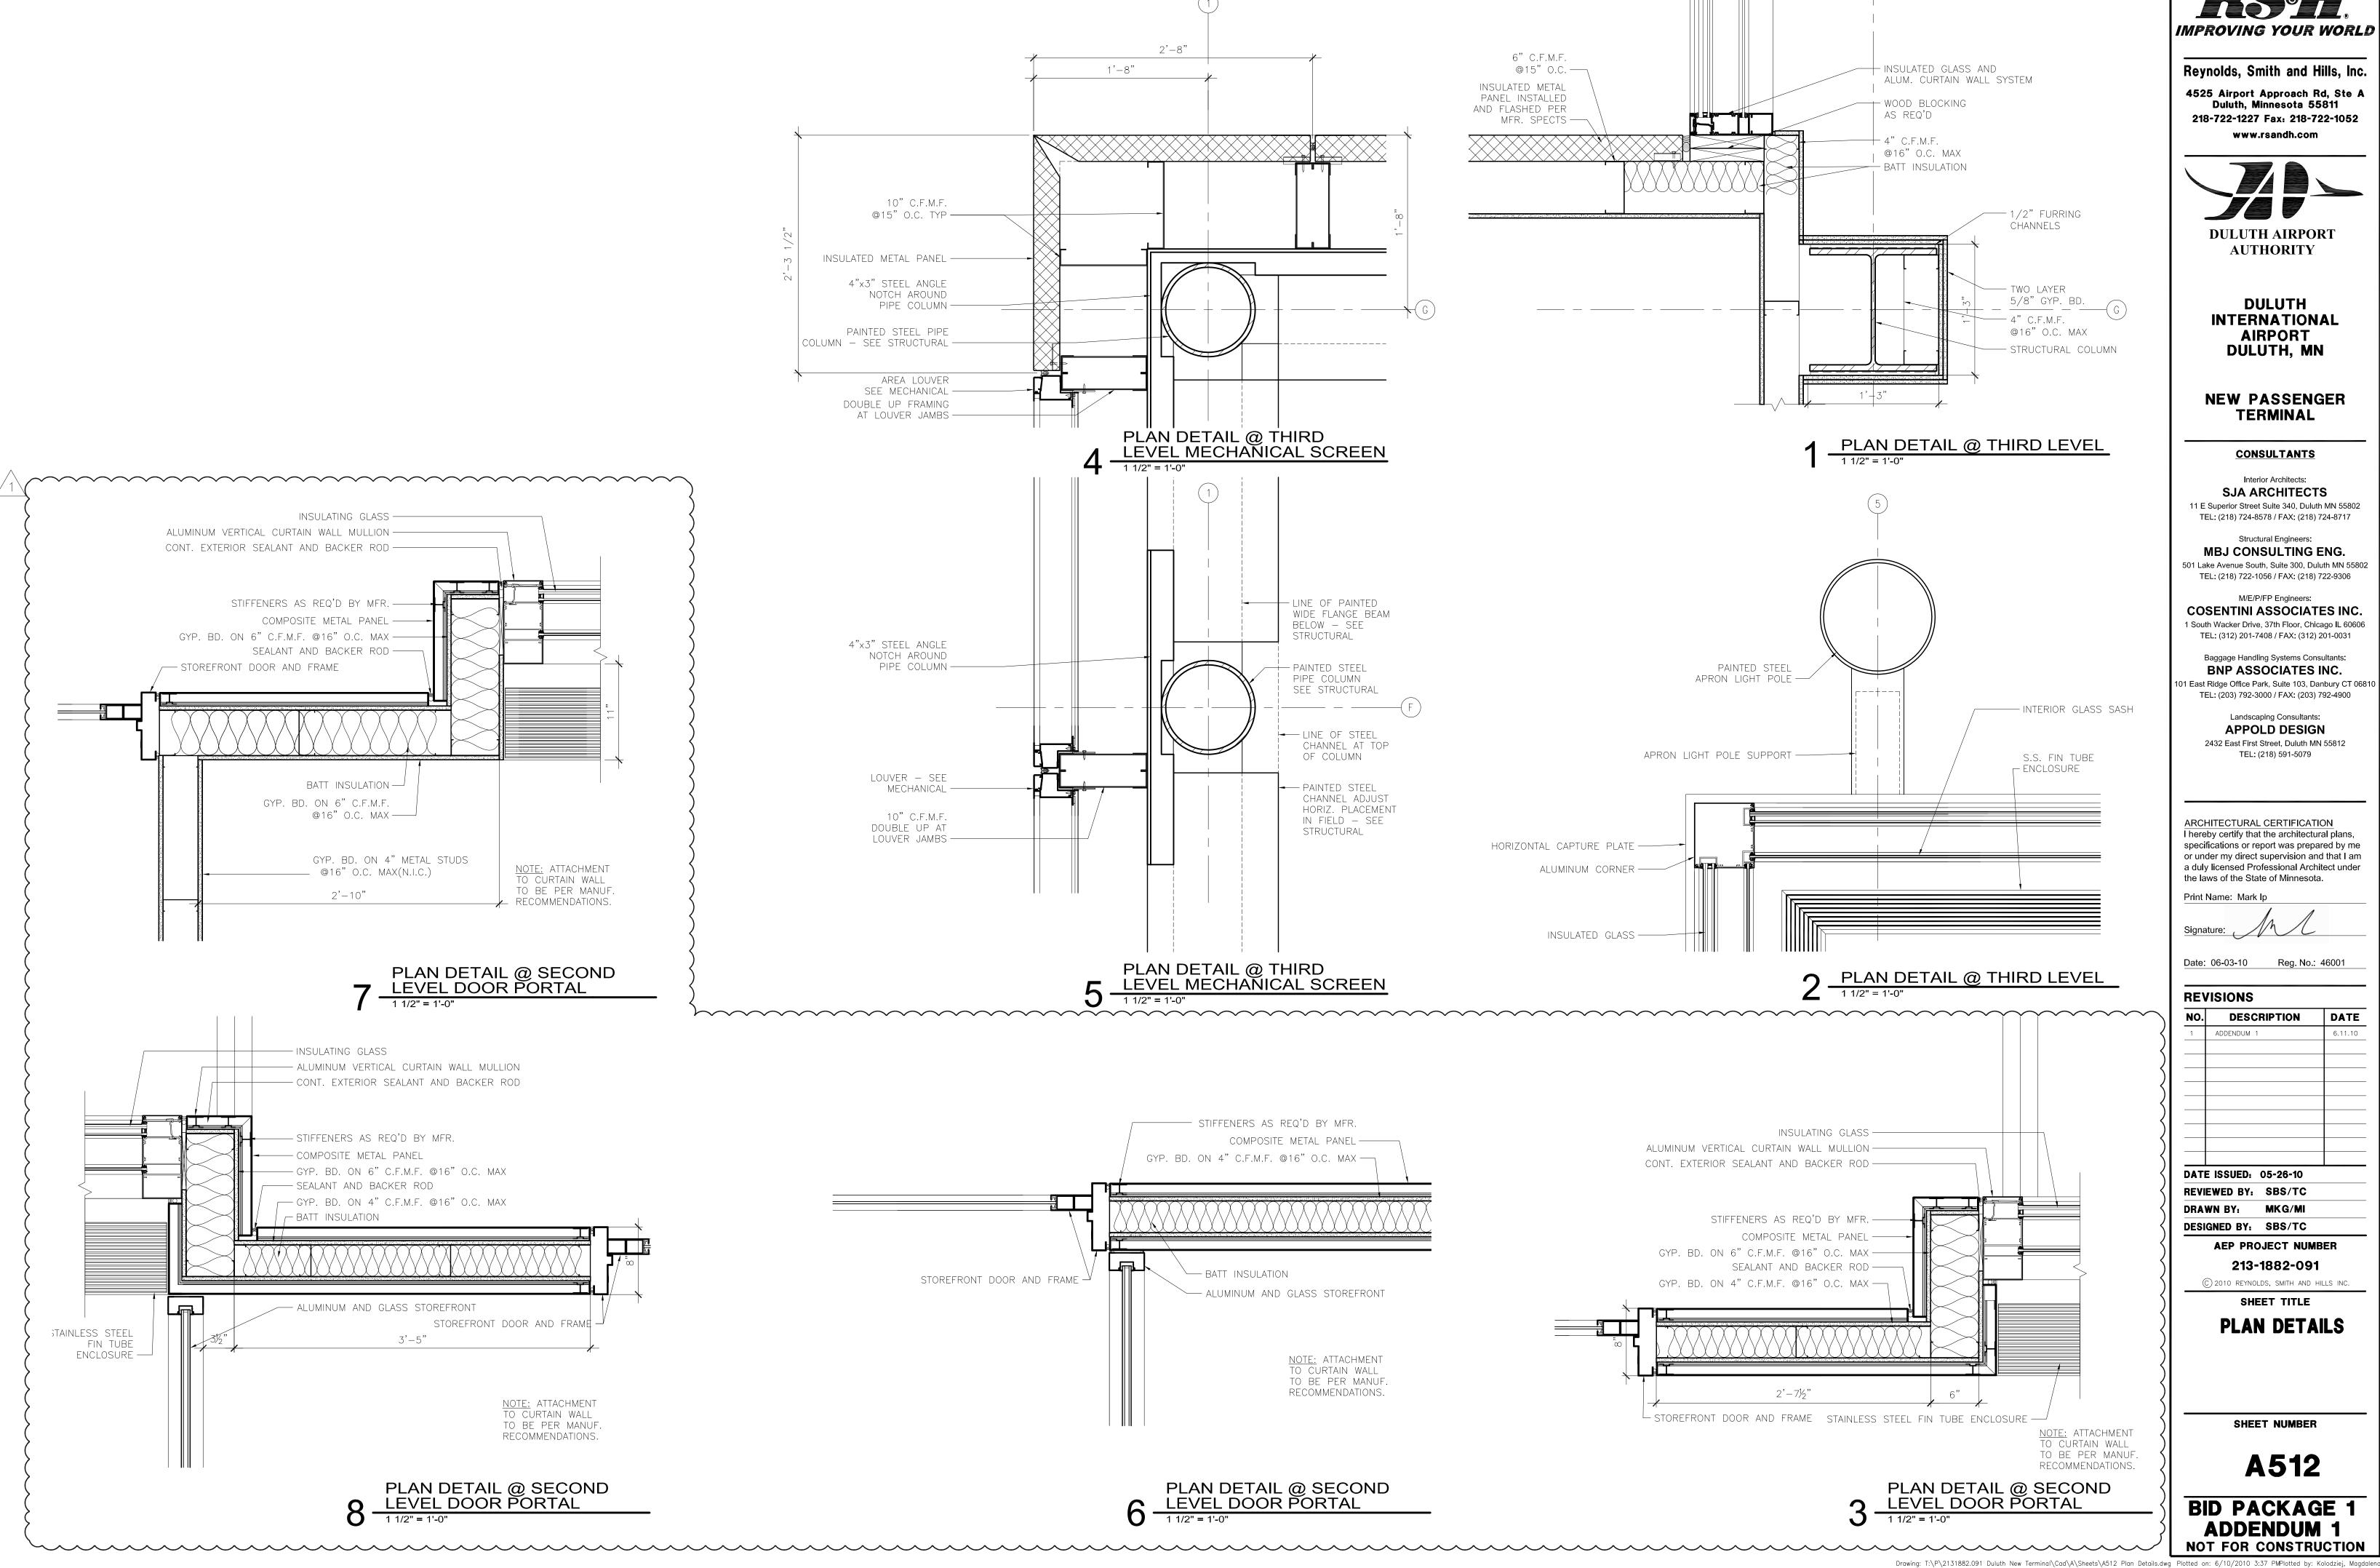
SHEET TITLE **PLAN DETAILS**

SHEET NUMBER

A511

BID PACKAGE 1 ADDENDUM 1 NOT FOR CONSTRUCTION

Drawing: T:\P\2131882.091 Duluth New Terminal\Cad\A\Sheets\A511 Plan Details.dwg Plotted on: 6/10/2010 3:36 PMPlotted by: Kolodziej, Magdalena



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DULUTH AIRPORT

DULUTH INTERNATIONAL **AIRPORT** DULUTH, MN

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> Landscaping Consultants: APPOLD DESIGN

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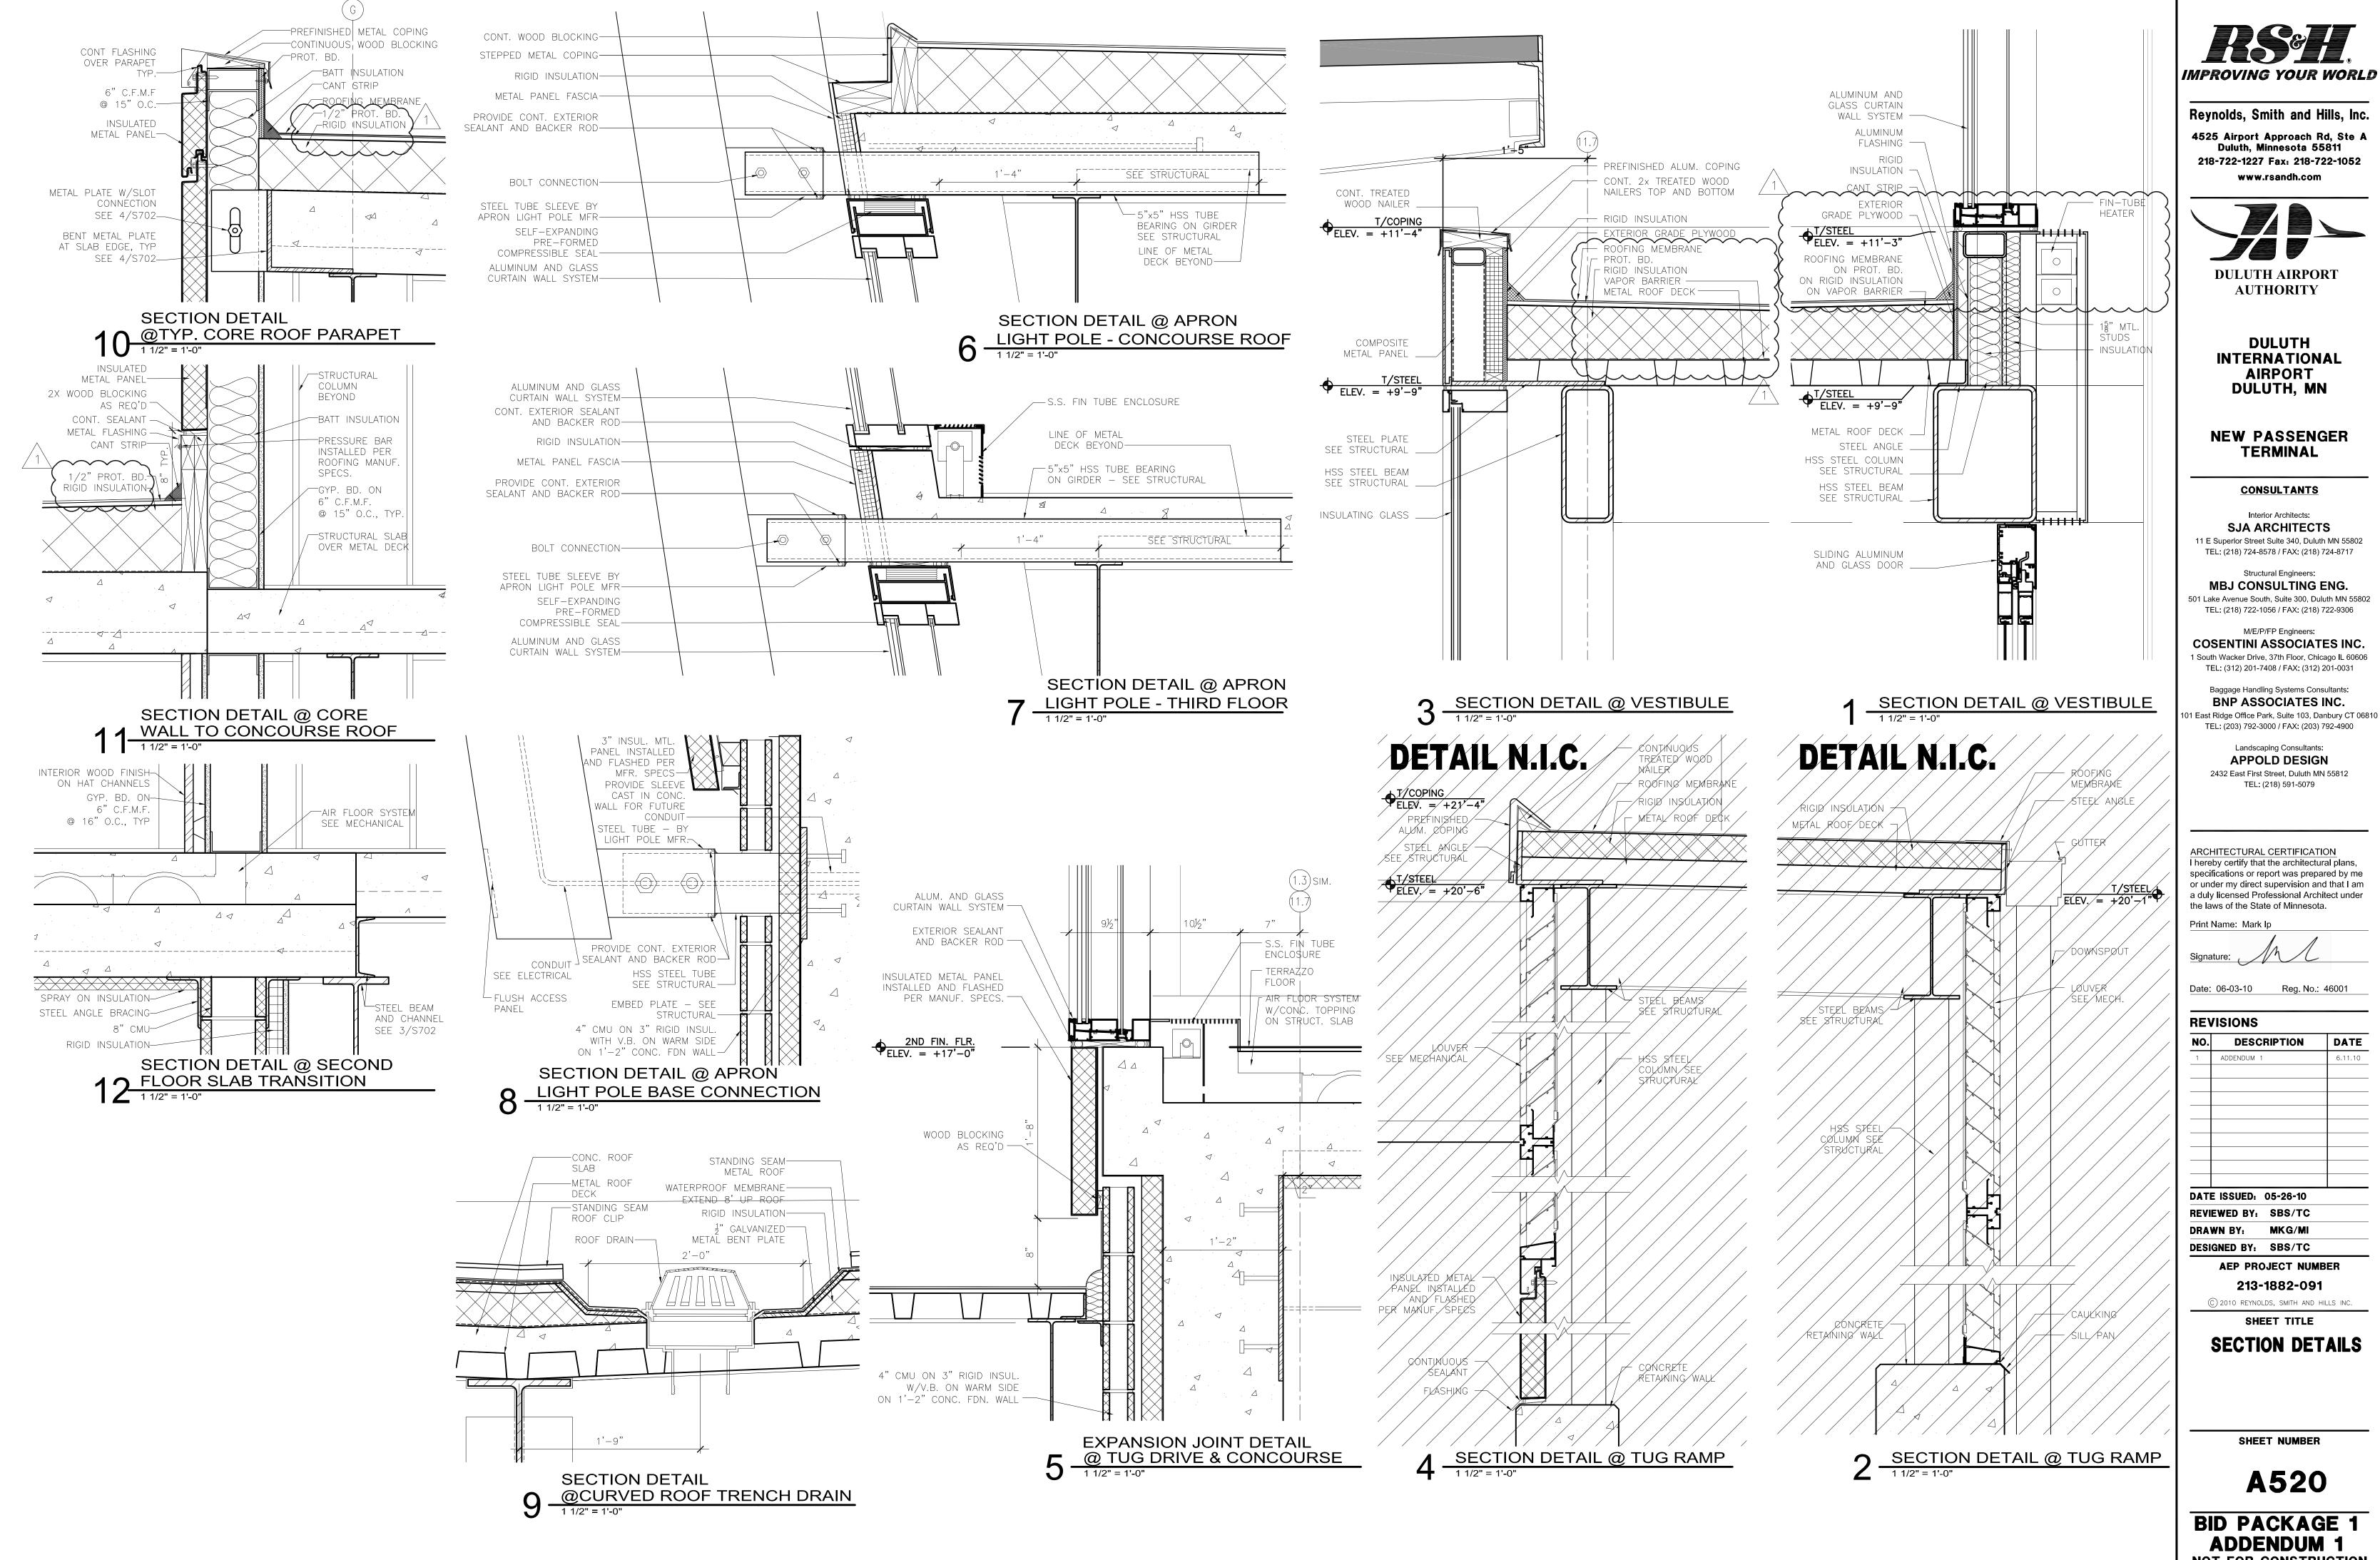
NO. DESCRIPTION DATE DATE ISSUED: 05-26-10 REVIEWED BY: SBS/TC DRAWN BY: MKG/MI DESIGNED BY: SBS/TC

AEP PROJECT NUMBER

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PLAN DETAILS

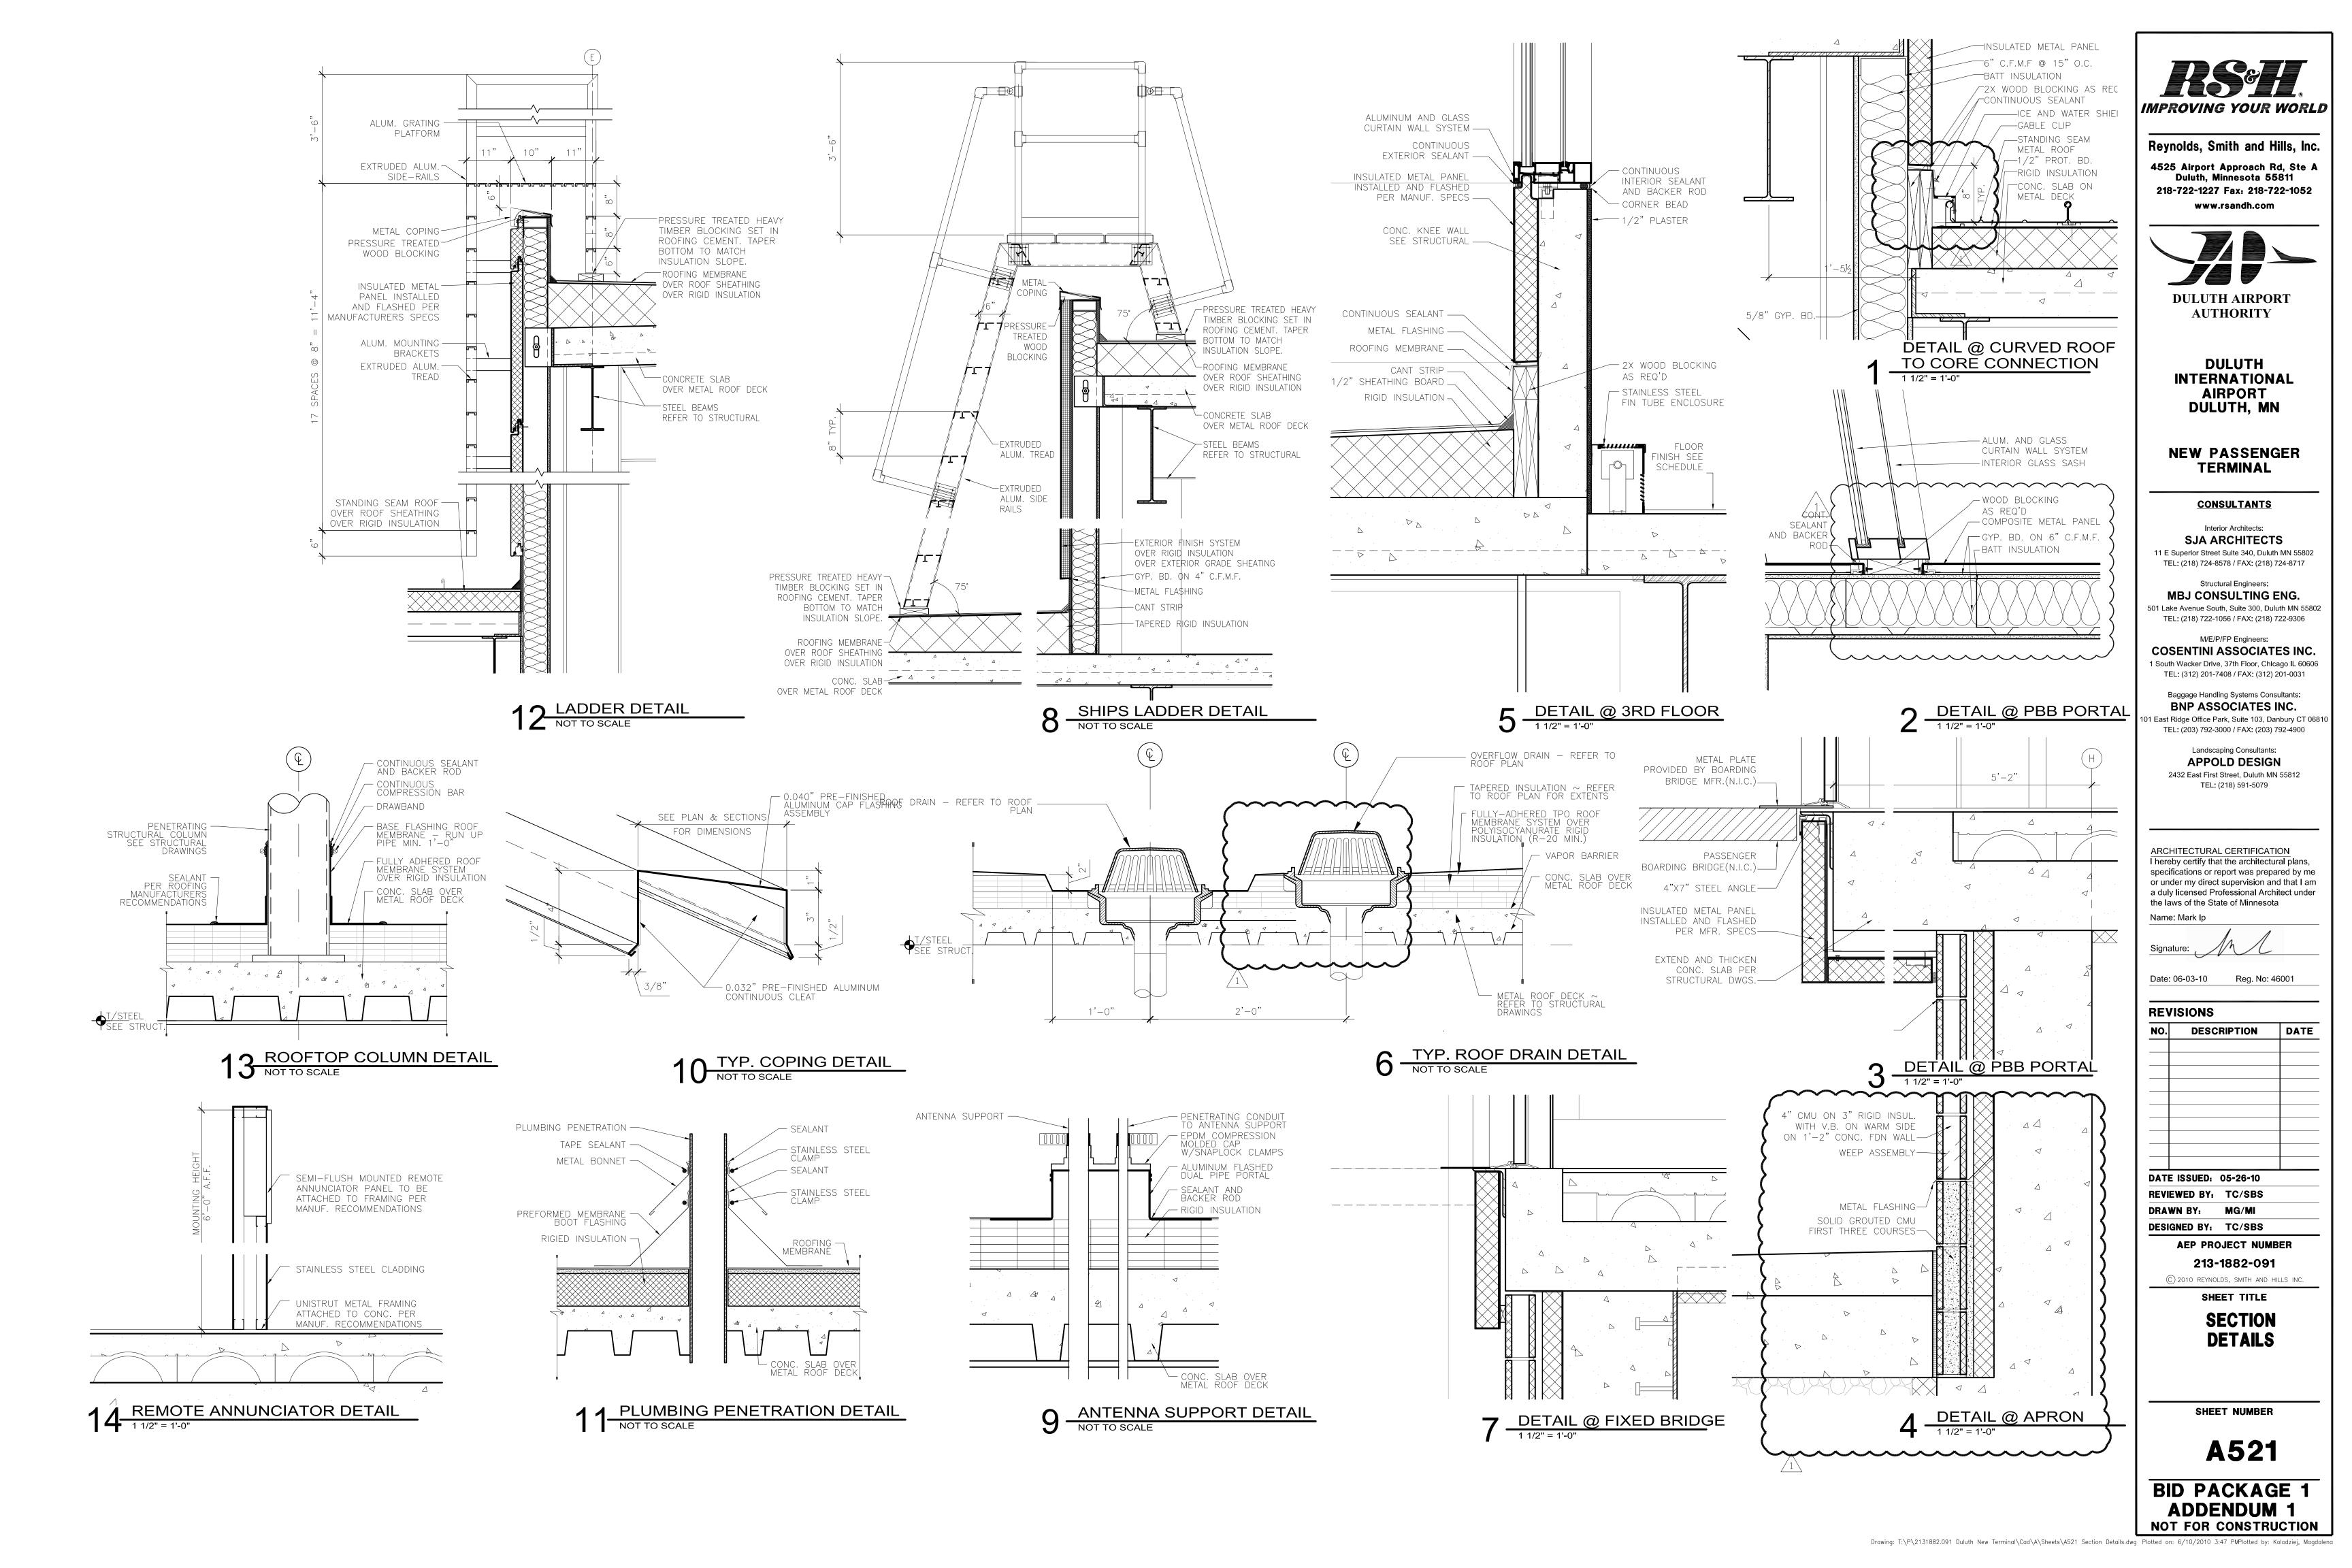


COSENTINI ASSOCIATES INC. 1 South Wacker Drive, 37th Floor, Chicago IL 60606

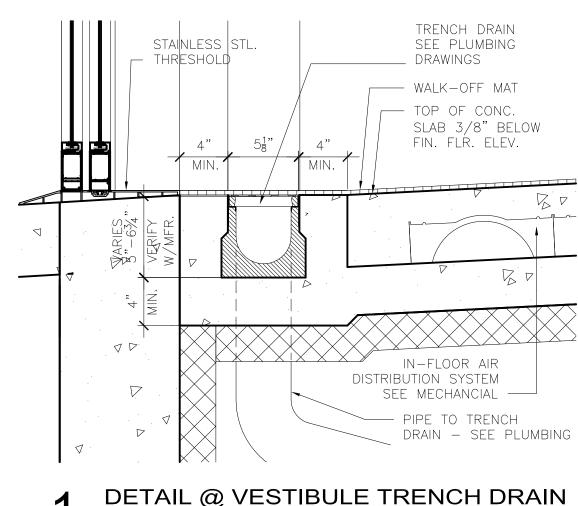
East Ridge Office Park, Suite 103, Danbury CT 0681

NOT FOR CONSTRUCTION

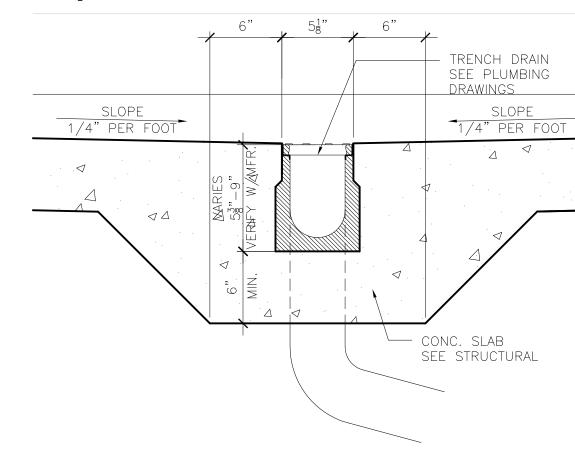
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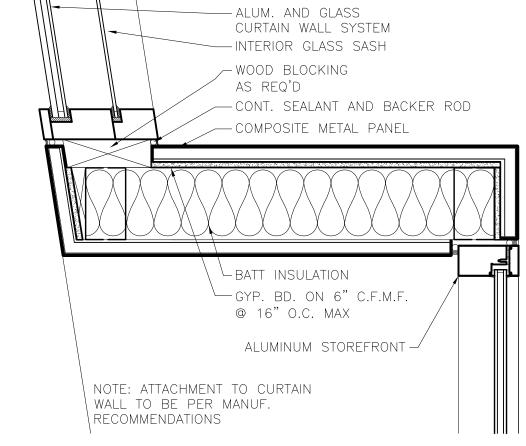





DETAIL @ VESTIBULE TRENCH DRAIN 1 1/2" = 1'-0"



2 DETAIL @ TUG TUNNEL TRENCH DRAIN 1 1/2" = 1'-0"



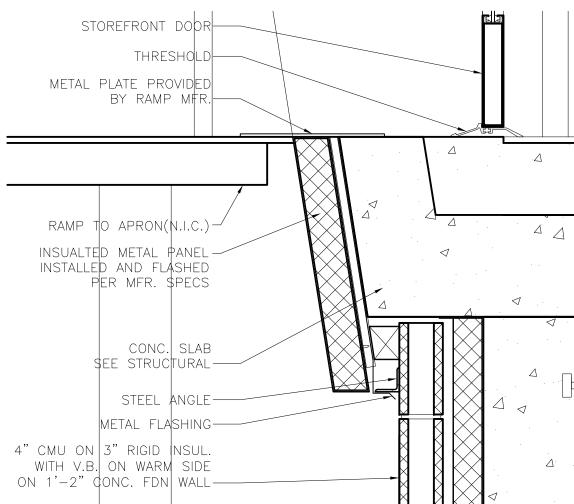3 DETAIL @ DOOR PORTAL 1 1/2" = 1'-0"



4 DETAIL @ DOOR PORTAL
1 1/2" = 1'-0"

Drawing: T:\P\2131882.091 Duluth New Terminal\Cad\A\Sheets\A522 Section Details.dwg Plotted on: 6/10/2010 3:49 PMPlotted by: Kolodziej, Magdalena

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Date: 06-03-10 Reg. No: 46001

REVISIONS

NO. DESCRIPTION DATE **DATE ISSUED: 05-26-10** REVIEWED BY: TC/SBS DRAWN BY: MG/MI DESIGNED BY: TC/SBS

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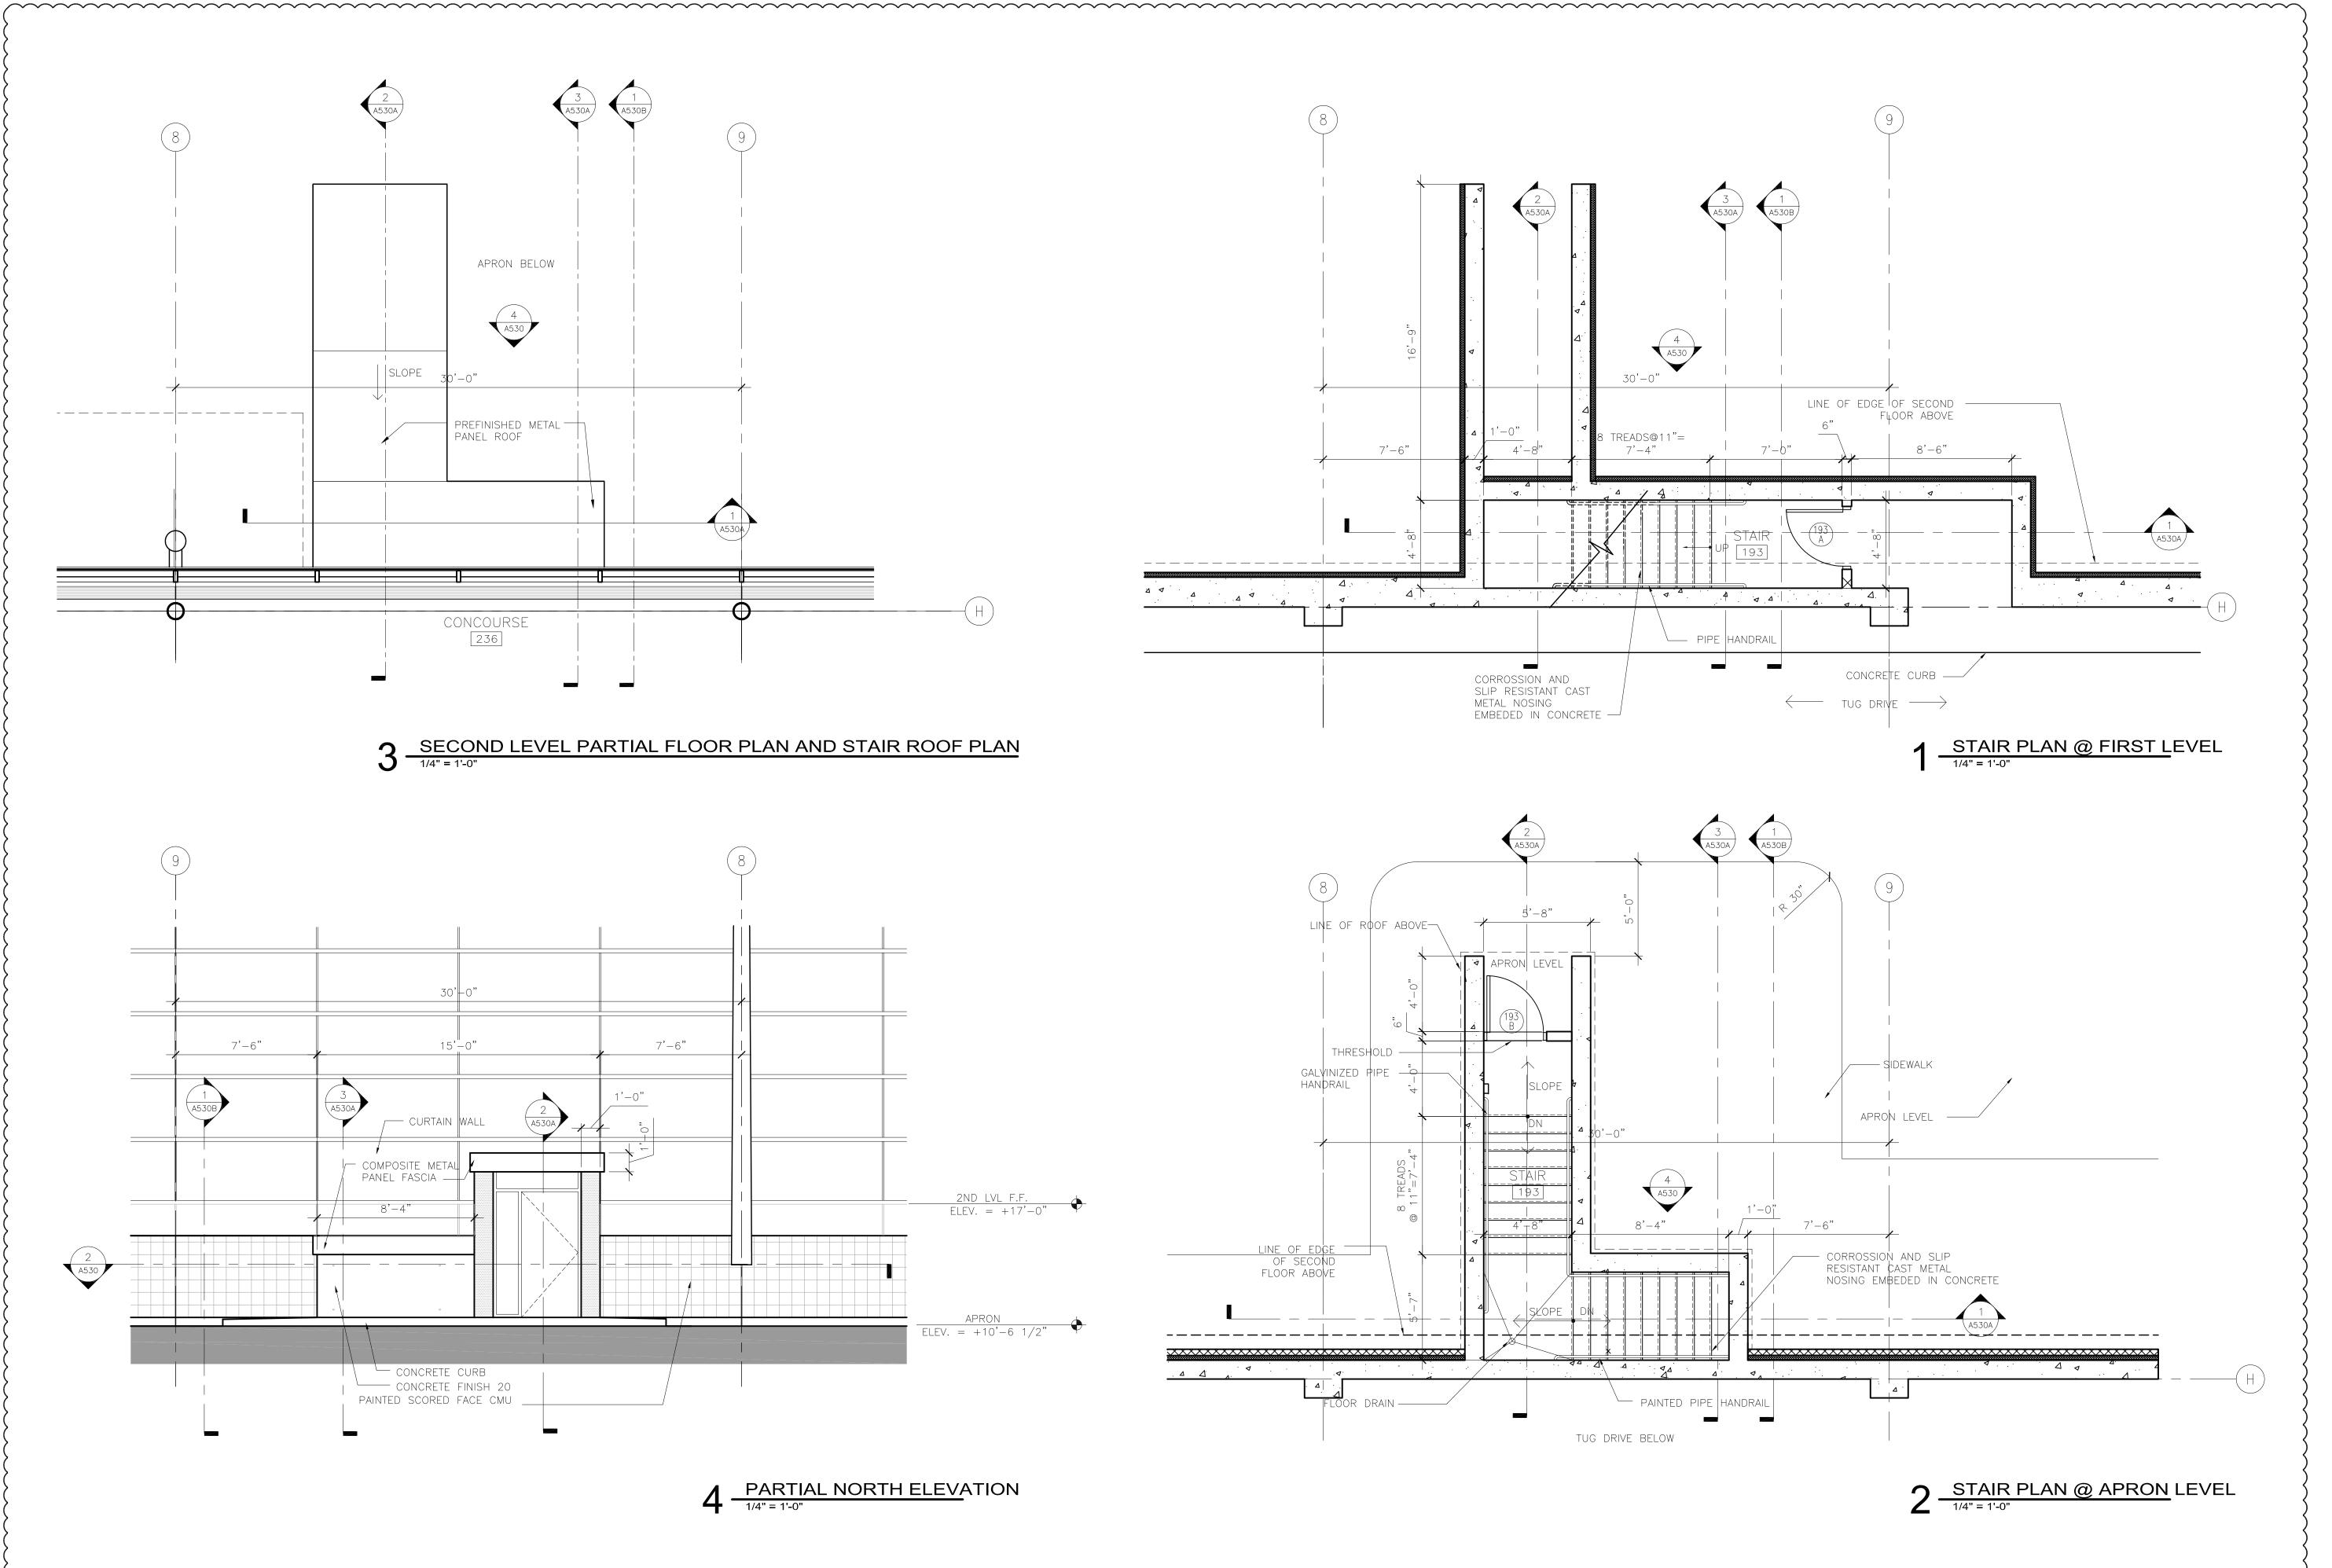
SHEET TITLE

SECTION **DETAILS**

SHEET NUMBER ~~~~

BID PACKAGE 1 ADDENDUM 1

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NEW PASSENGER TERMINAL

CONSULTANTS

Interior Architects:

SJA ARCHITECTS

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TEL: (218) 724-8578 / FAX: (218) 724-8717

Structural Engineers:

MBJ CONSULTING ENG.

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TEL: (218) 722-1056 / FAX: (218) 722-9306

TEL: (312) 201-7408 / FAX: (312) 201-0031

M/E/P/FP Engineers:

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1 South Wacker Drive, 37th Floor, Chicago IL 60606

Baggage Handling Systems Consultants: **BNP ASSOCIATES INC.**101 East Ridge Office Park, Suite 103, Danbury CT 06810

TEL: (203) 792-3000 / FAX: (203) 792-4900

Landscaping Consultants:

APPOLD DESIGN

2432 East First Street, Duluth MN 55812

TEL: (218) 591-5079

ARCHITECTURAL CERTIFICATION

I hereby certify that the architectural plans, specifications or report was prepared by me or under my direct supervision and that I am

a duly licensed Professional Architect under

the laws of the State of Minnesota.

Print Name: Mark Ip

Signature:

Date: 06-03-10 Reg. No.: 46001

REVISIONS

NO.	DESCRIPTION	DATE
1	ADDENDUM 1	6.11.10
DATI	F ISSUED. 05-28-10	

DATE ISSUED: 05-26-10
REVIEWED BY: TC
DRAWN BY: MK

DESIGNED BY: SBS

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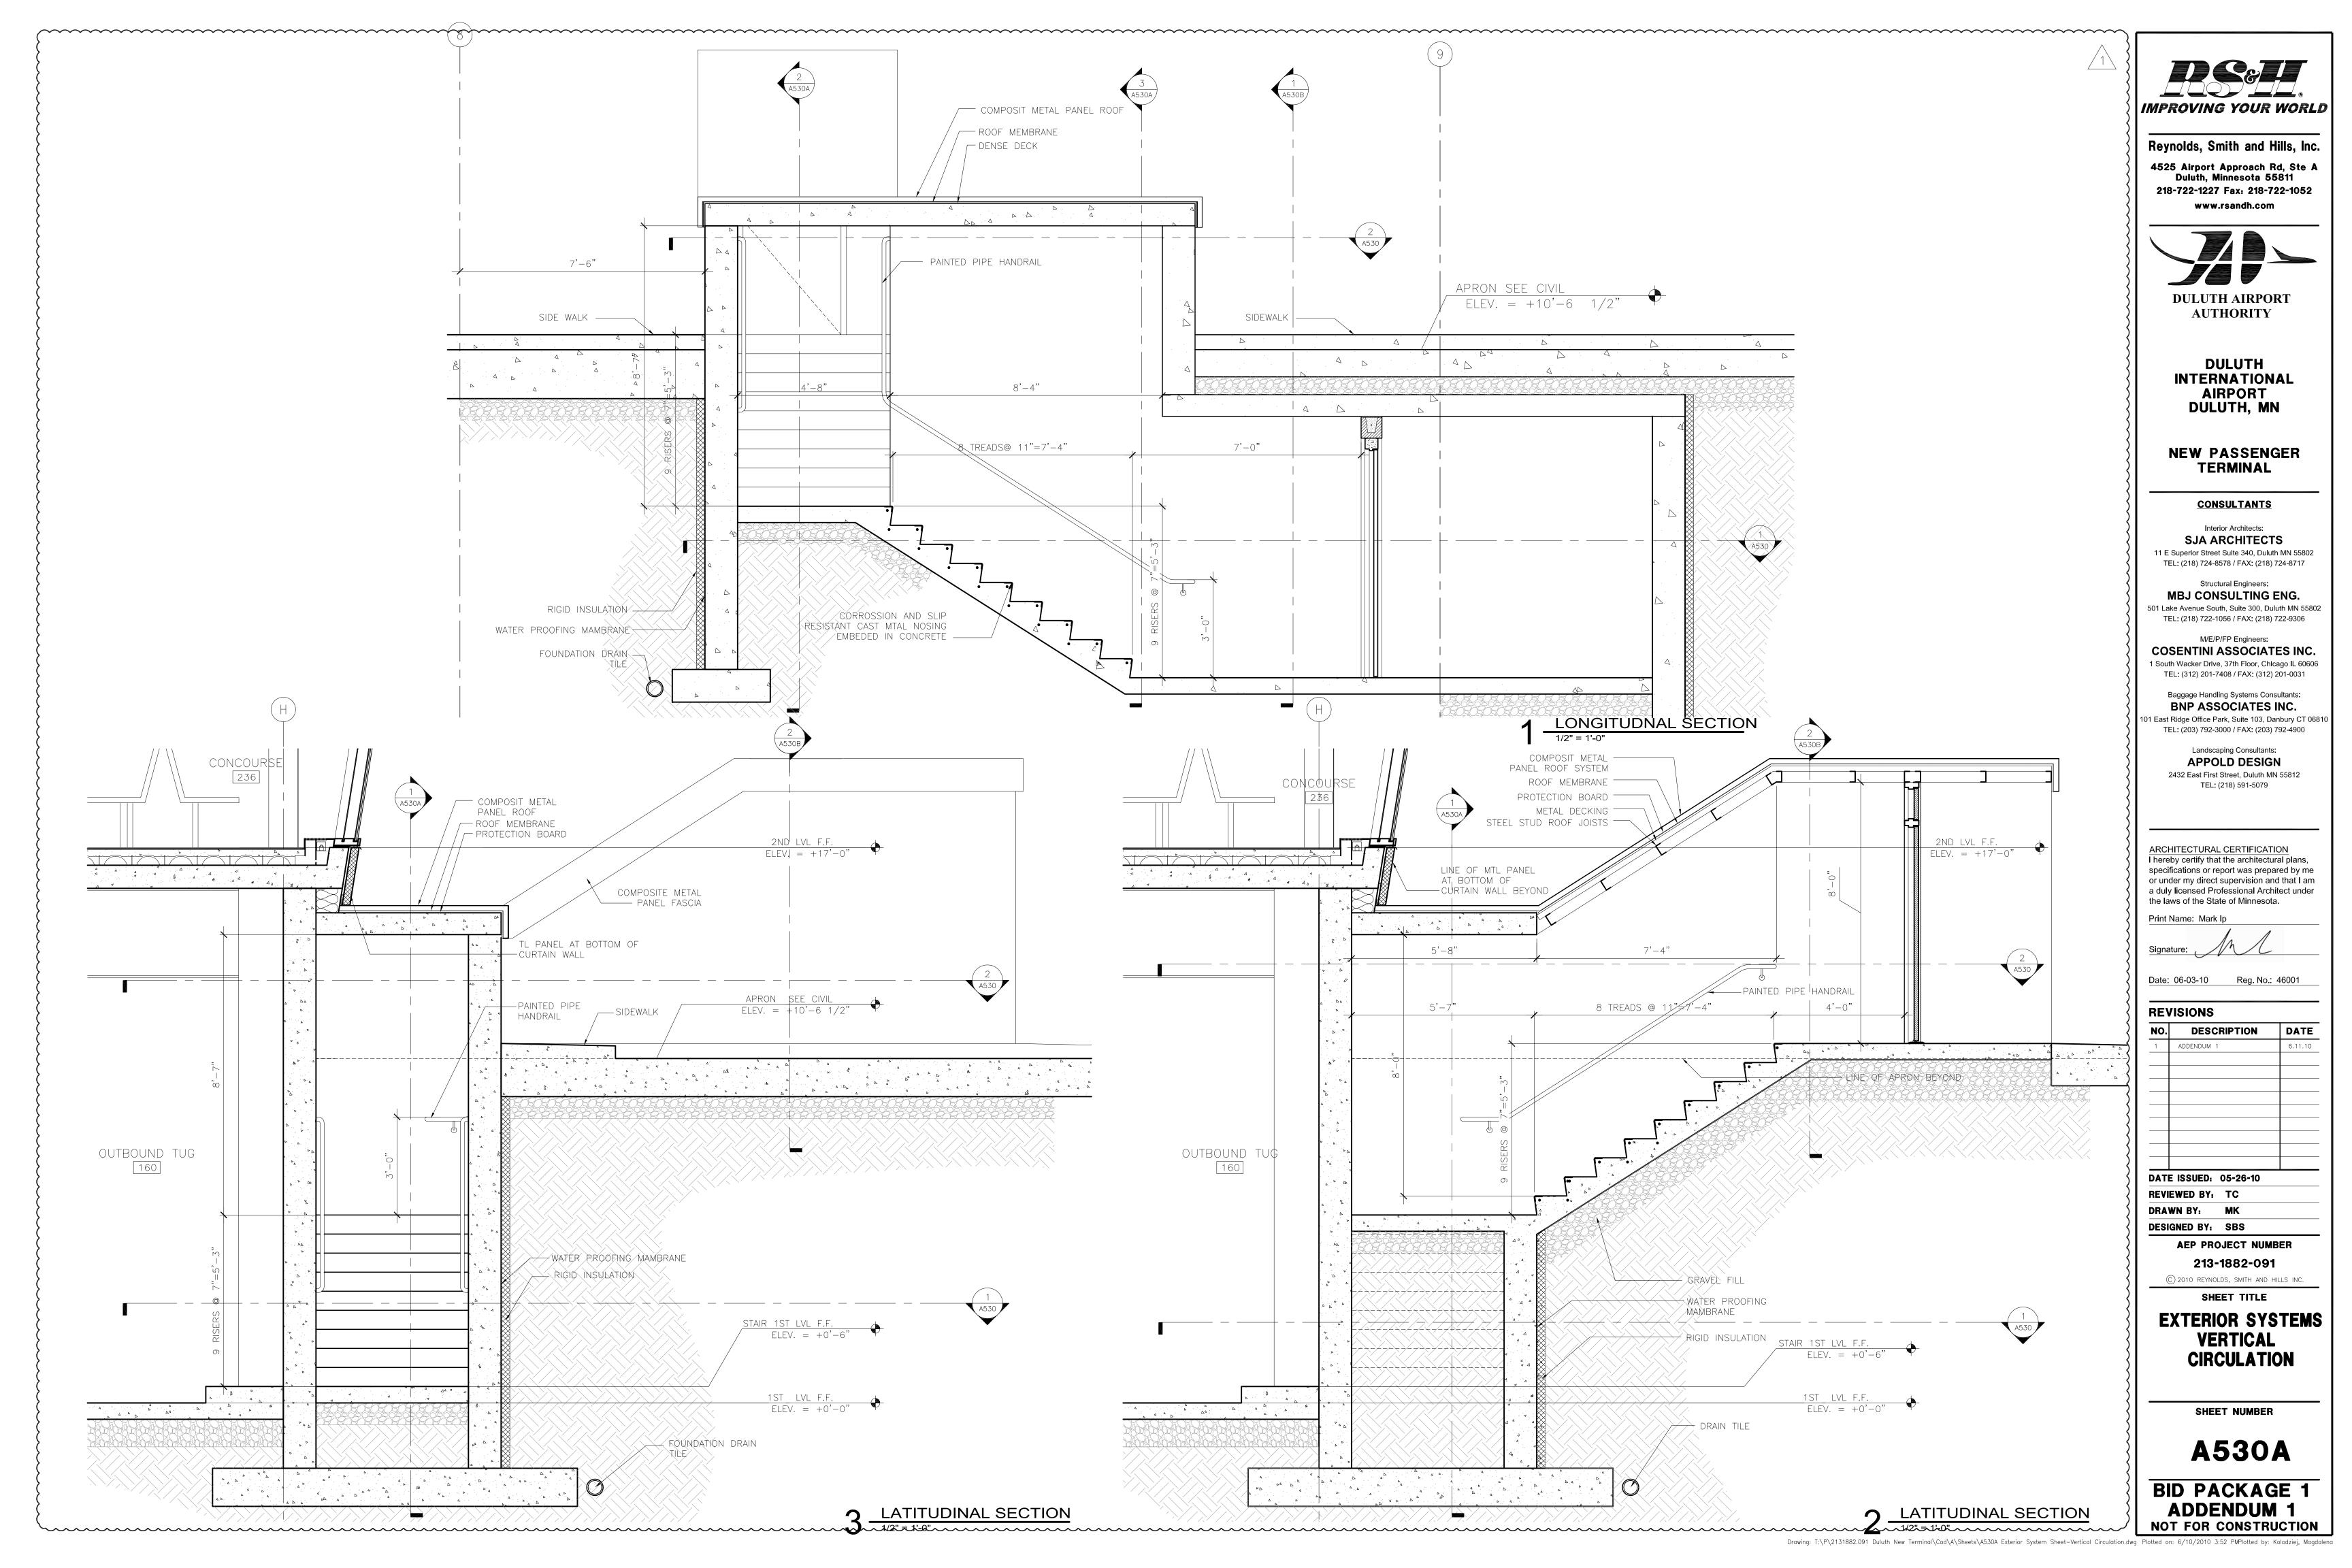
EXTERIOR SYSTEMS
VERTICAL
CIRCULATION


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A530

BID PACKAGE 1
ADDENDUM 1





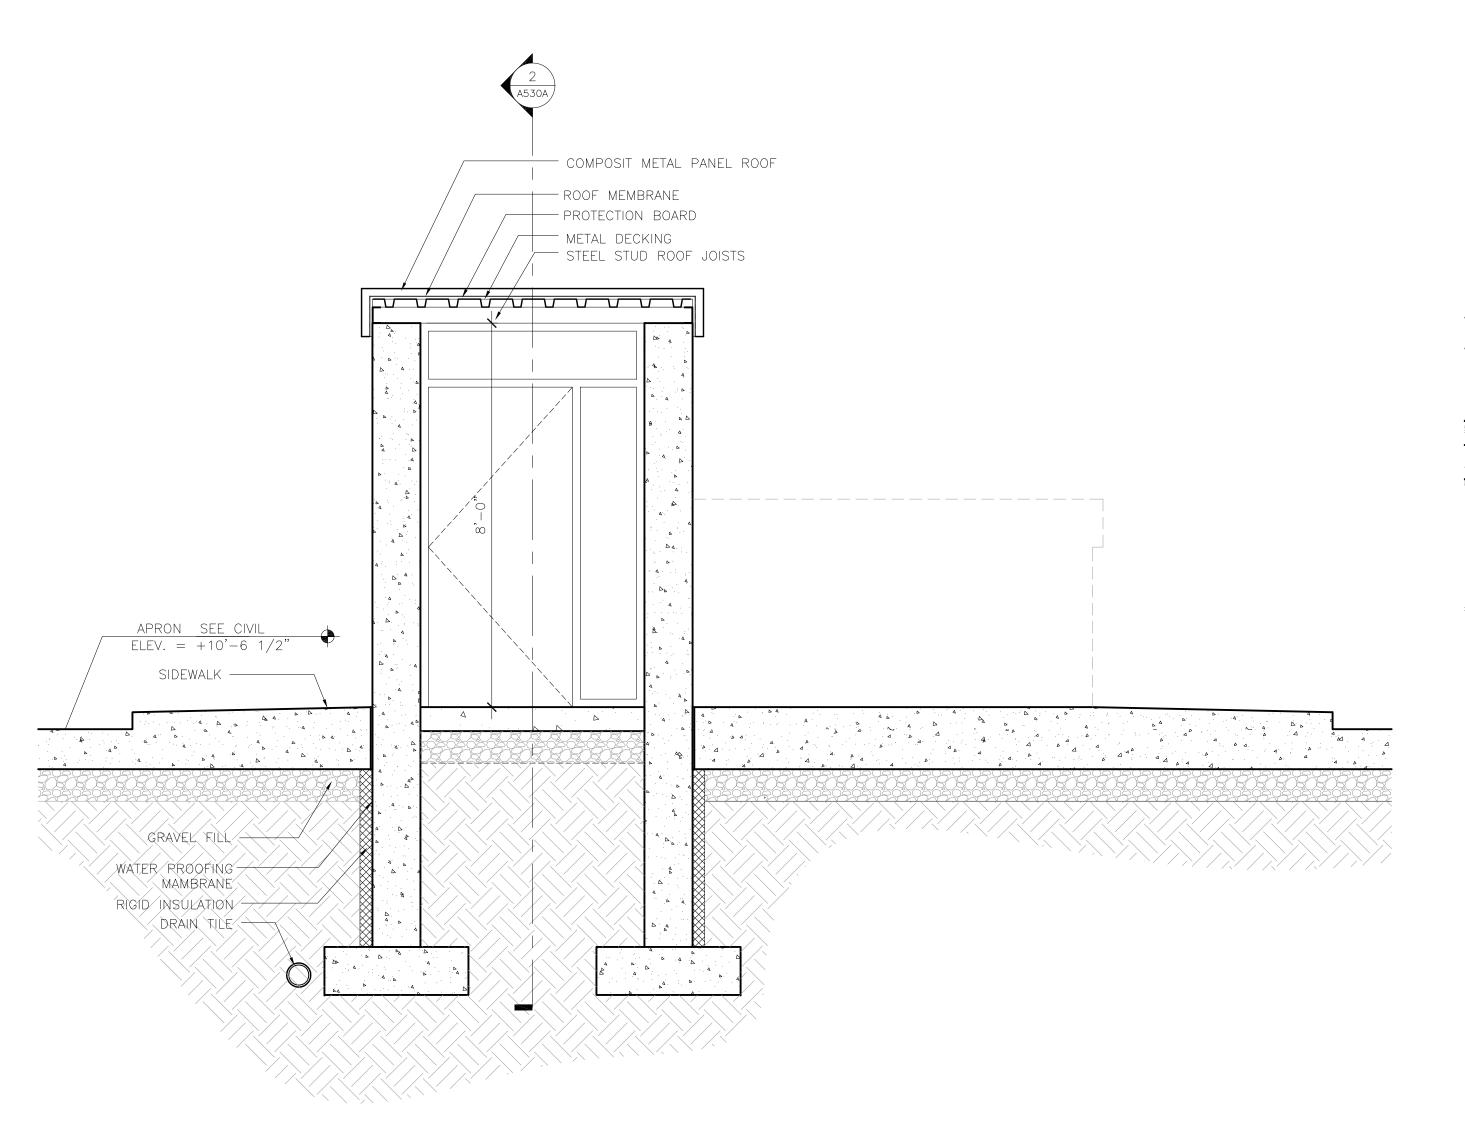ELEV. = +10'-61/2" 4'-8" — GRAVEL FILL - WATER PROOFING MAMBRANE - RIGID INSULATION STAIR LVL F.F.

ELEV. = +0'-6" DRAIN TILE LATITUDINAL SECTION

1/2" = 1'-0"

2 LONGITUDNAL SECTION

1/2" = 1'-0"

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Date: 06-03-10 Reg. No.: 46001

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a duly licensed Professional Architect under

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DRAWN BY: MK DESIGNED BY: SBS

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EXTERIOR SYSTEMS


VERTICAL CIRCULATION

SHEET NUMBER

A530B

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ADDENDUM 1 NOT FOR CONSTRUCTION

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Date: 06-03-10 Reg. No.: 46001
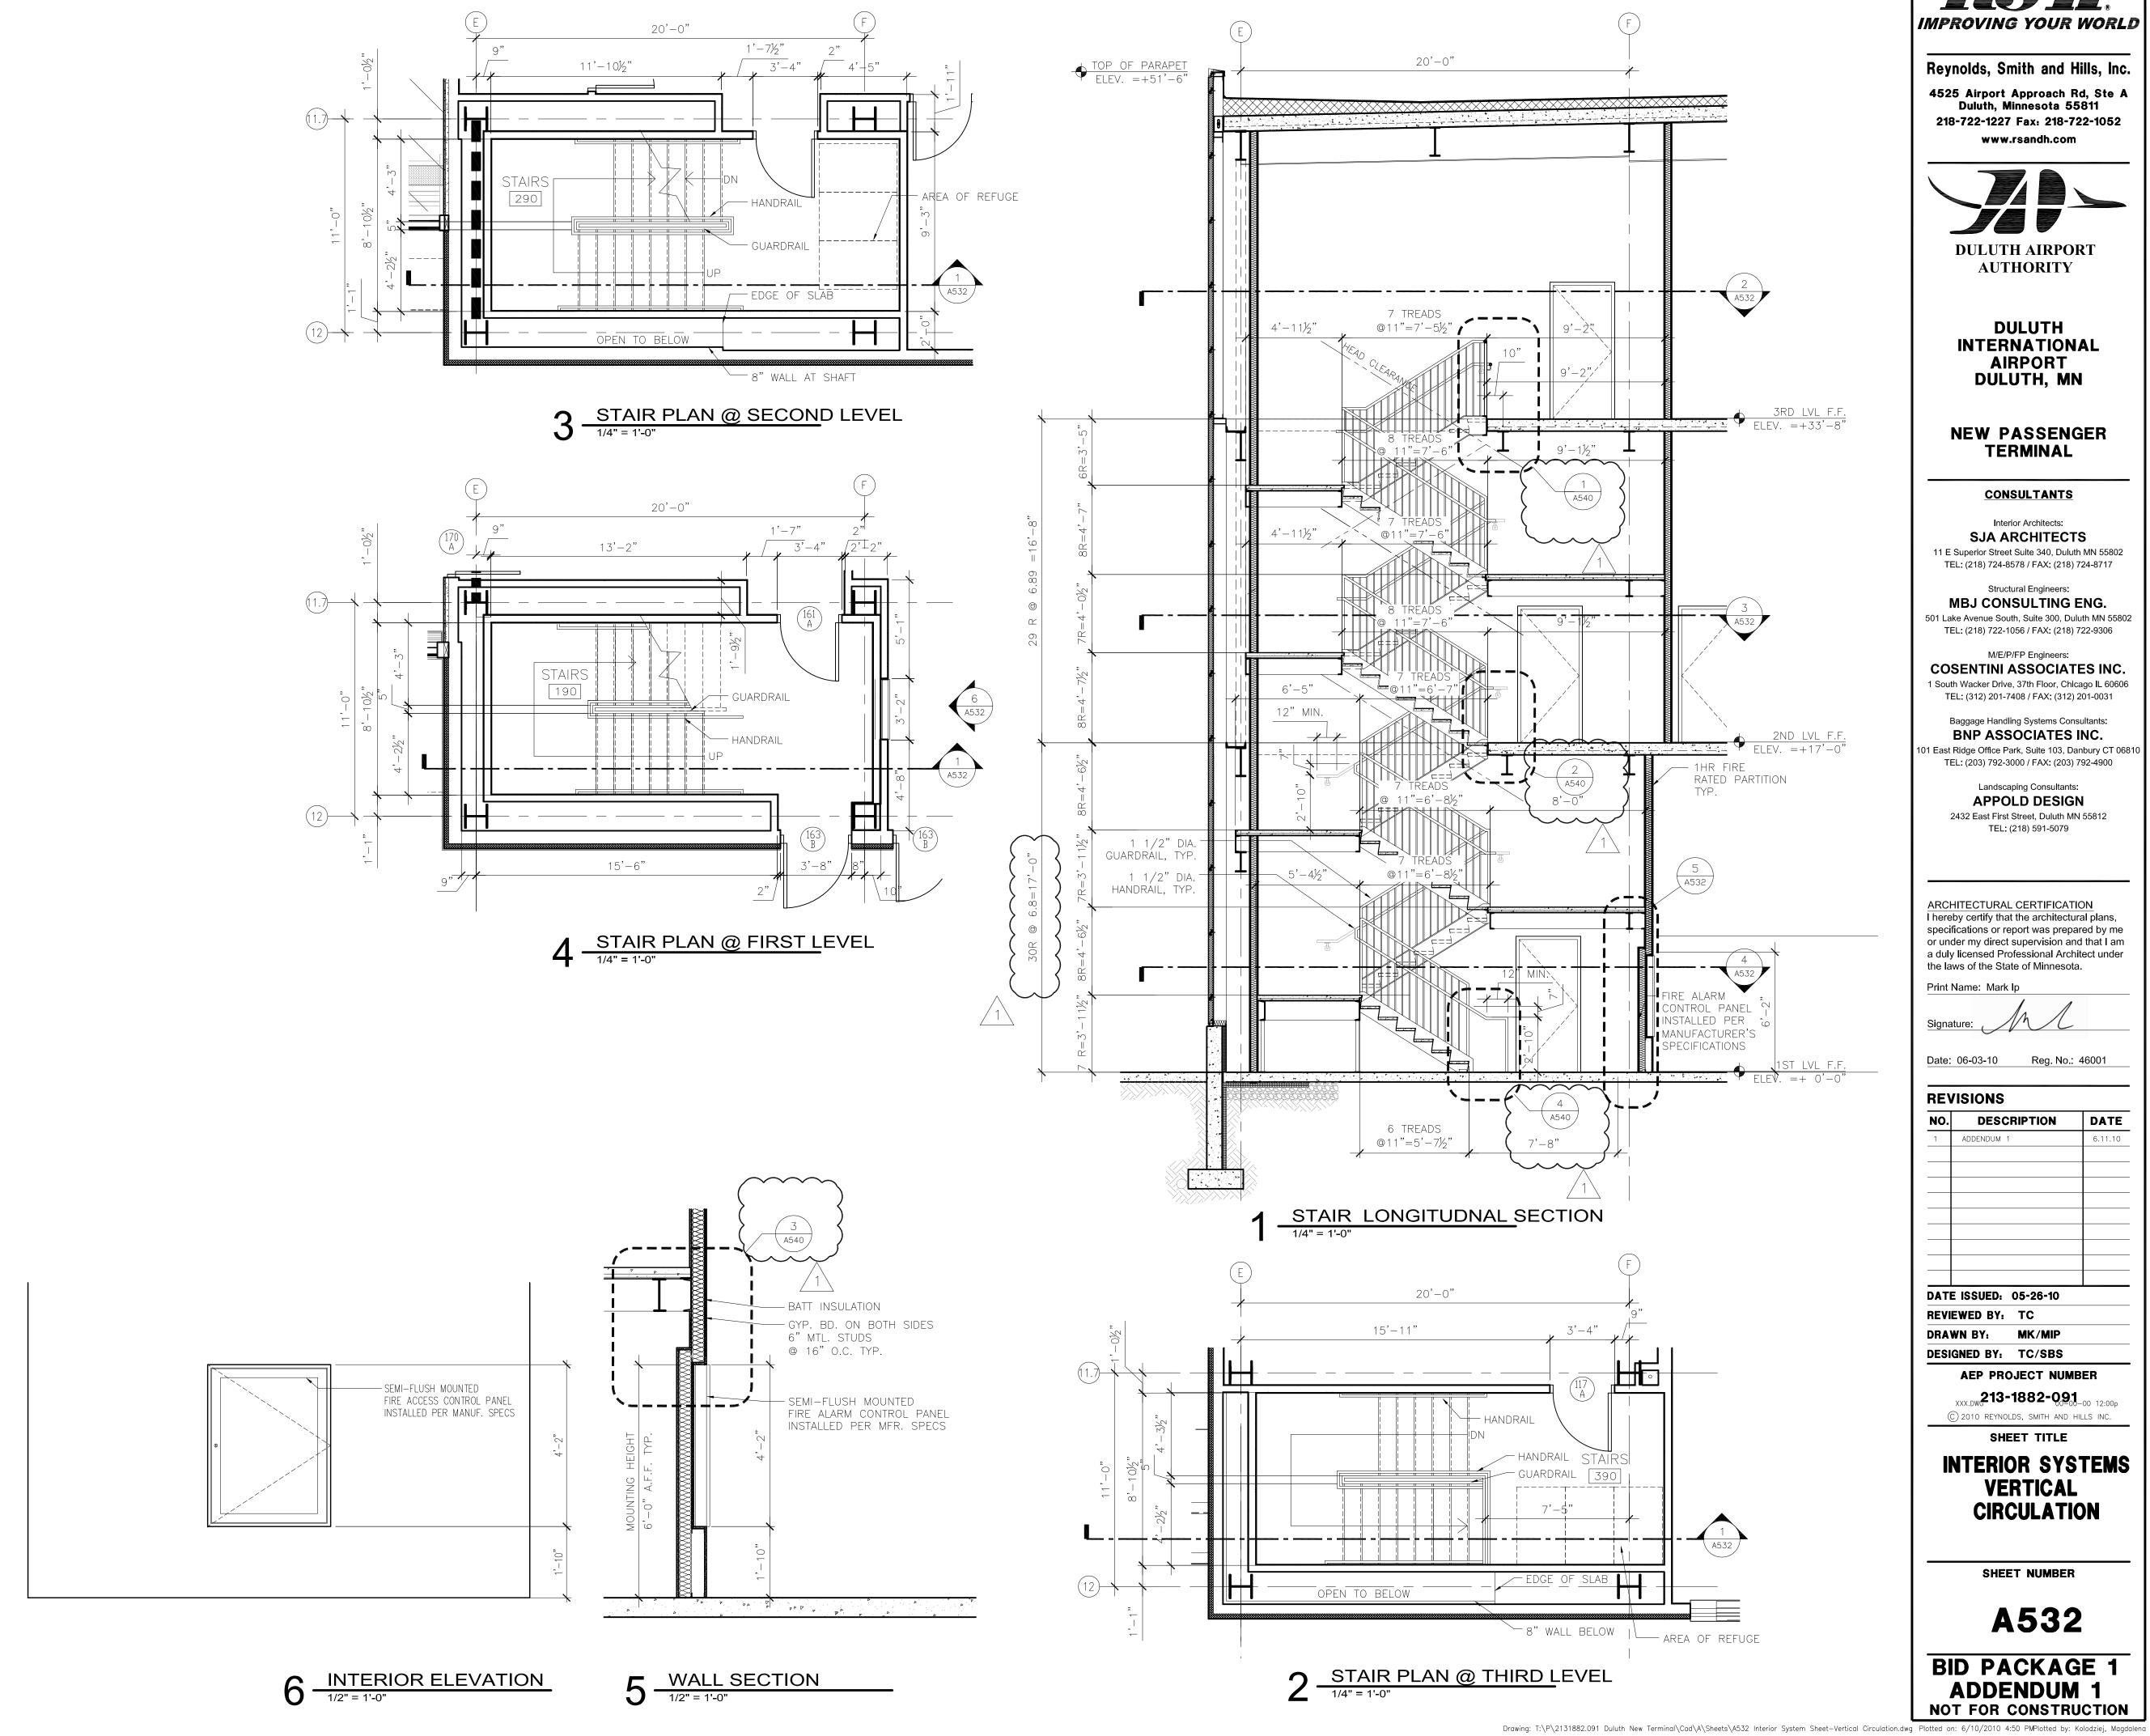
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1	ADDENDUM 1	6.11.
	ISSUED: 05-26-10	

REVIEWED BY: TC

DRAWN BY: MK/MIP DESIGNED BY: TC/SBS

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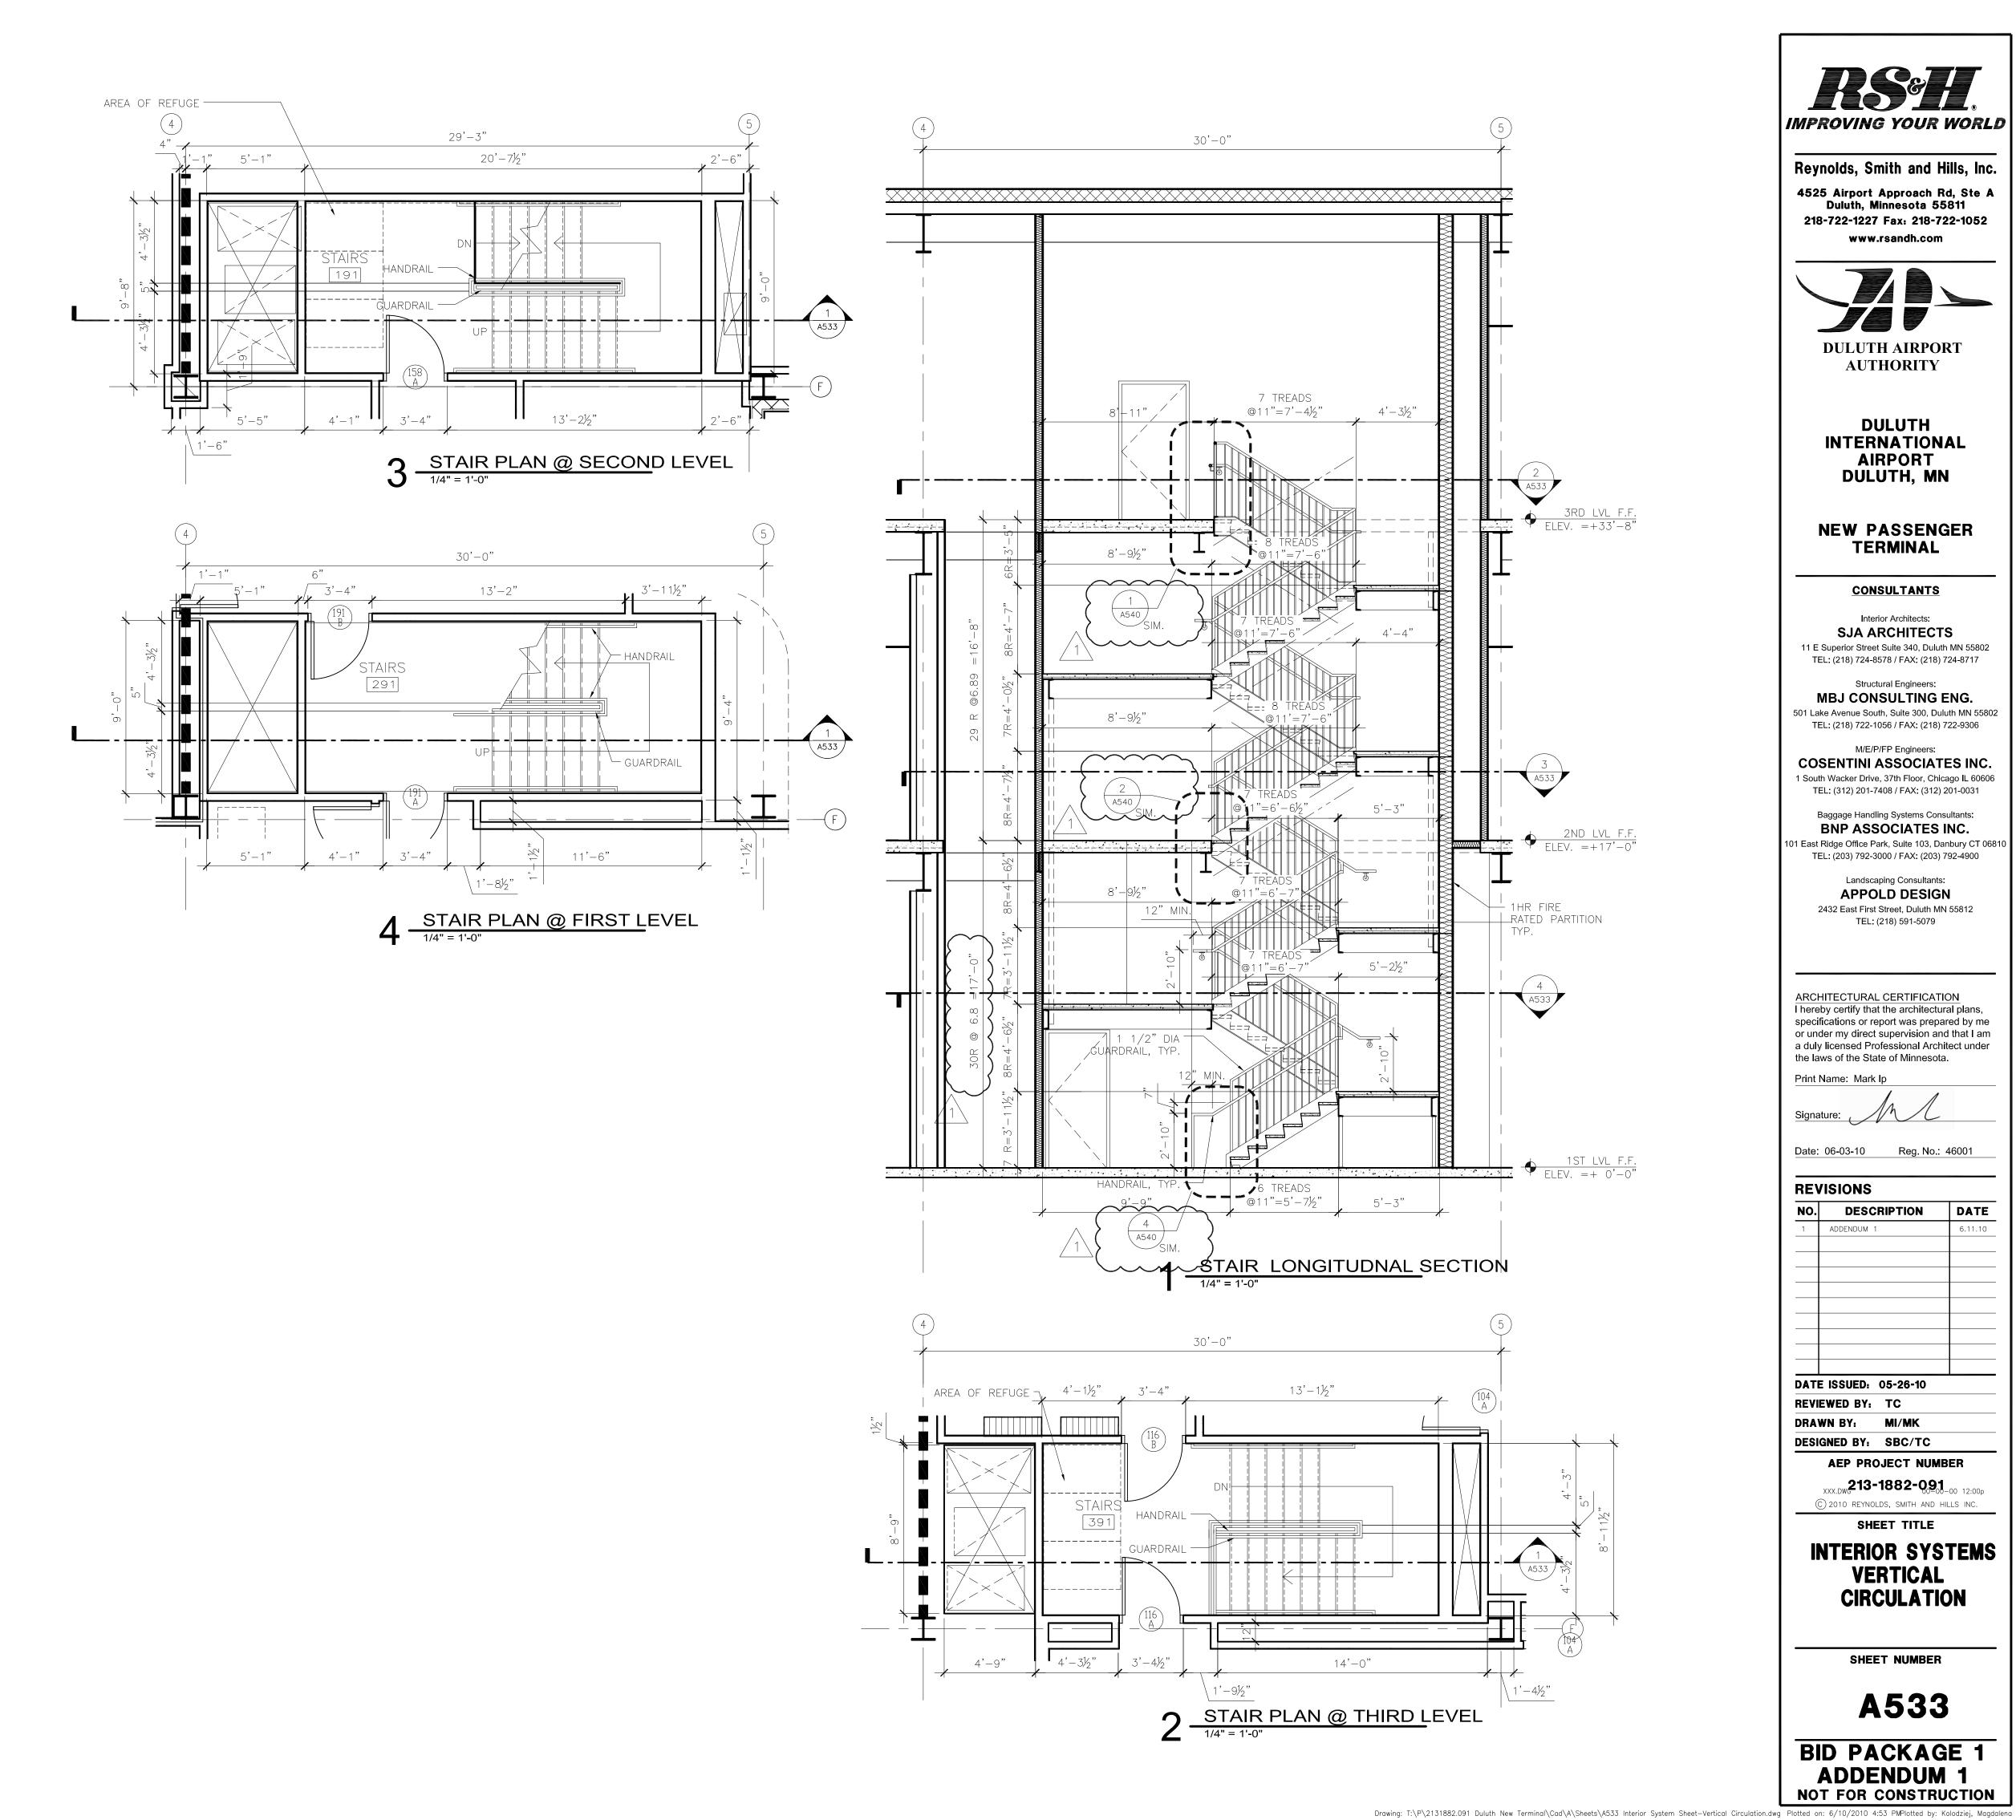
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SHEET TITLE

INTERIOR SYSTEMS **VERTICAL CIRCULATION**

SHEET NUMBER

A532





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AUTHORITY

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NEW PASSENGER TERMINAL

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Date: 06-03-10 Reg. No.: 46001

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	ISSUED: 05-26-10	

REVIEWED BY: TC

DRAWN BY: MI/MK

DESIGNED BY: SBC/TC

AEP PROJECT NUMBER

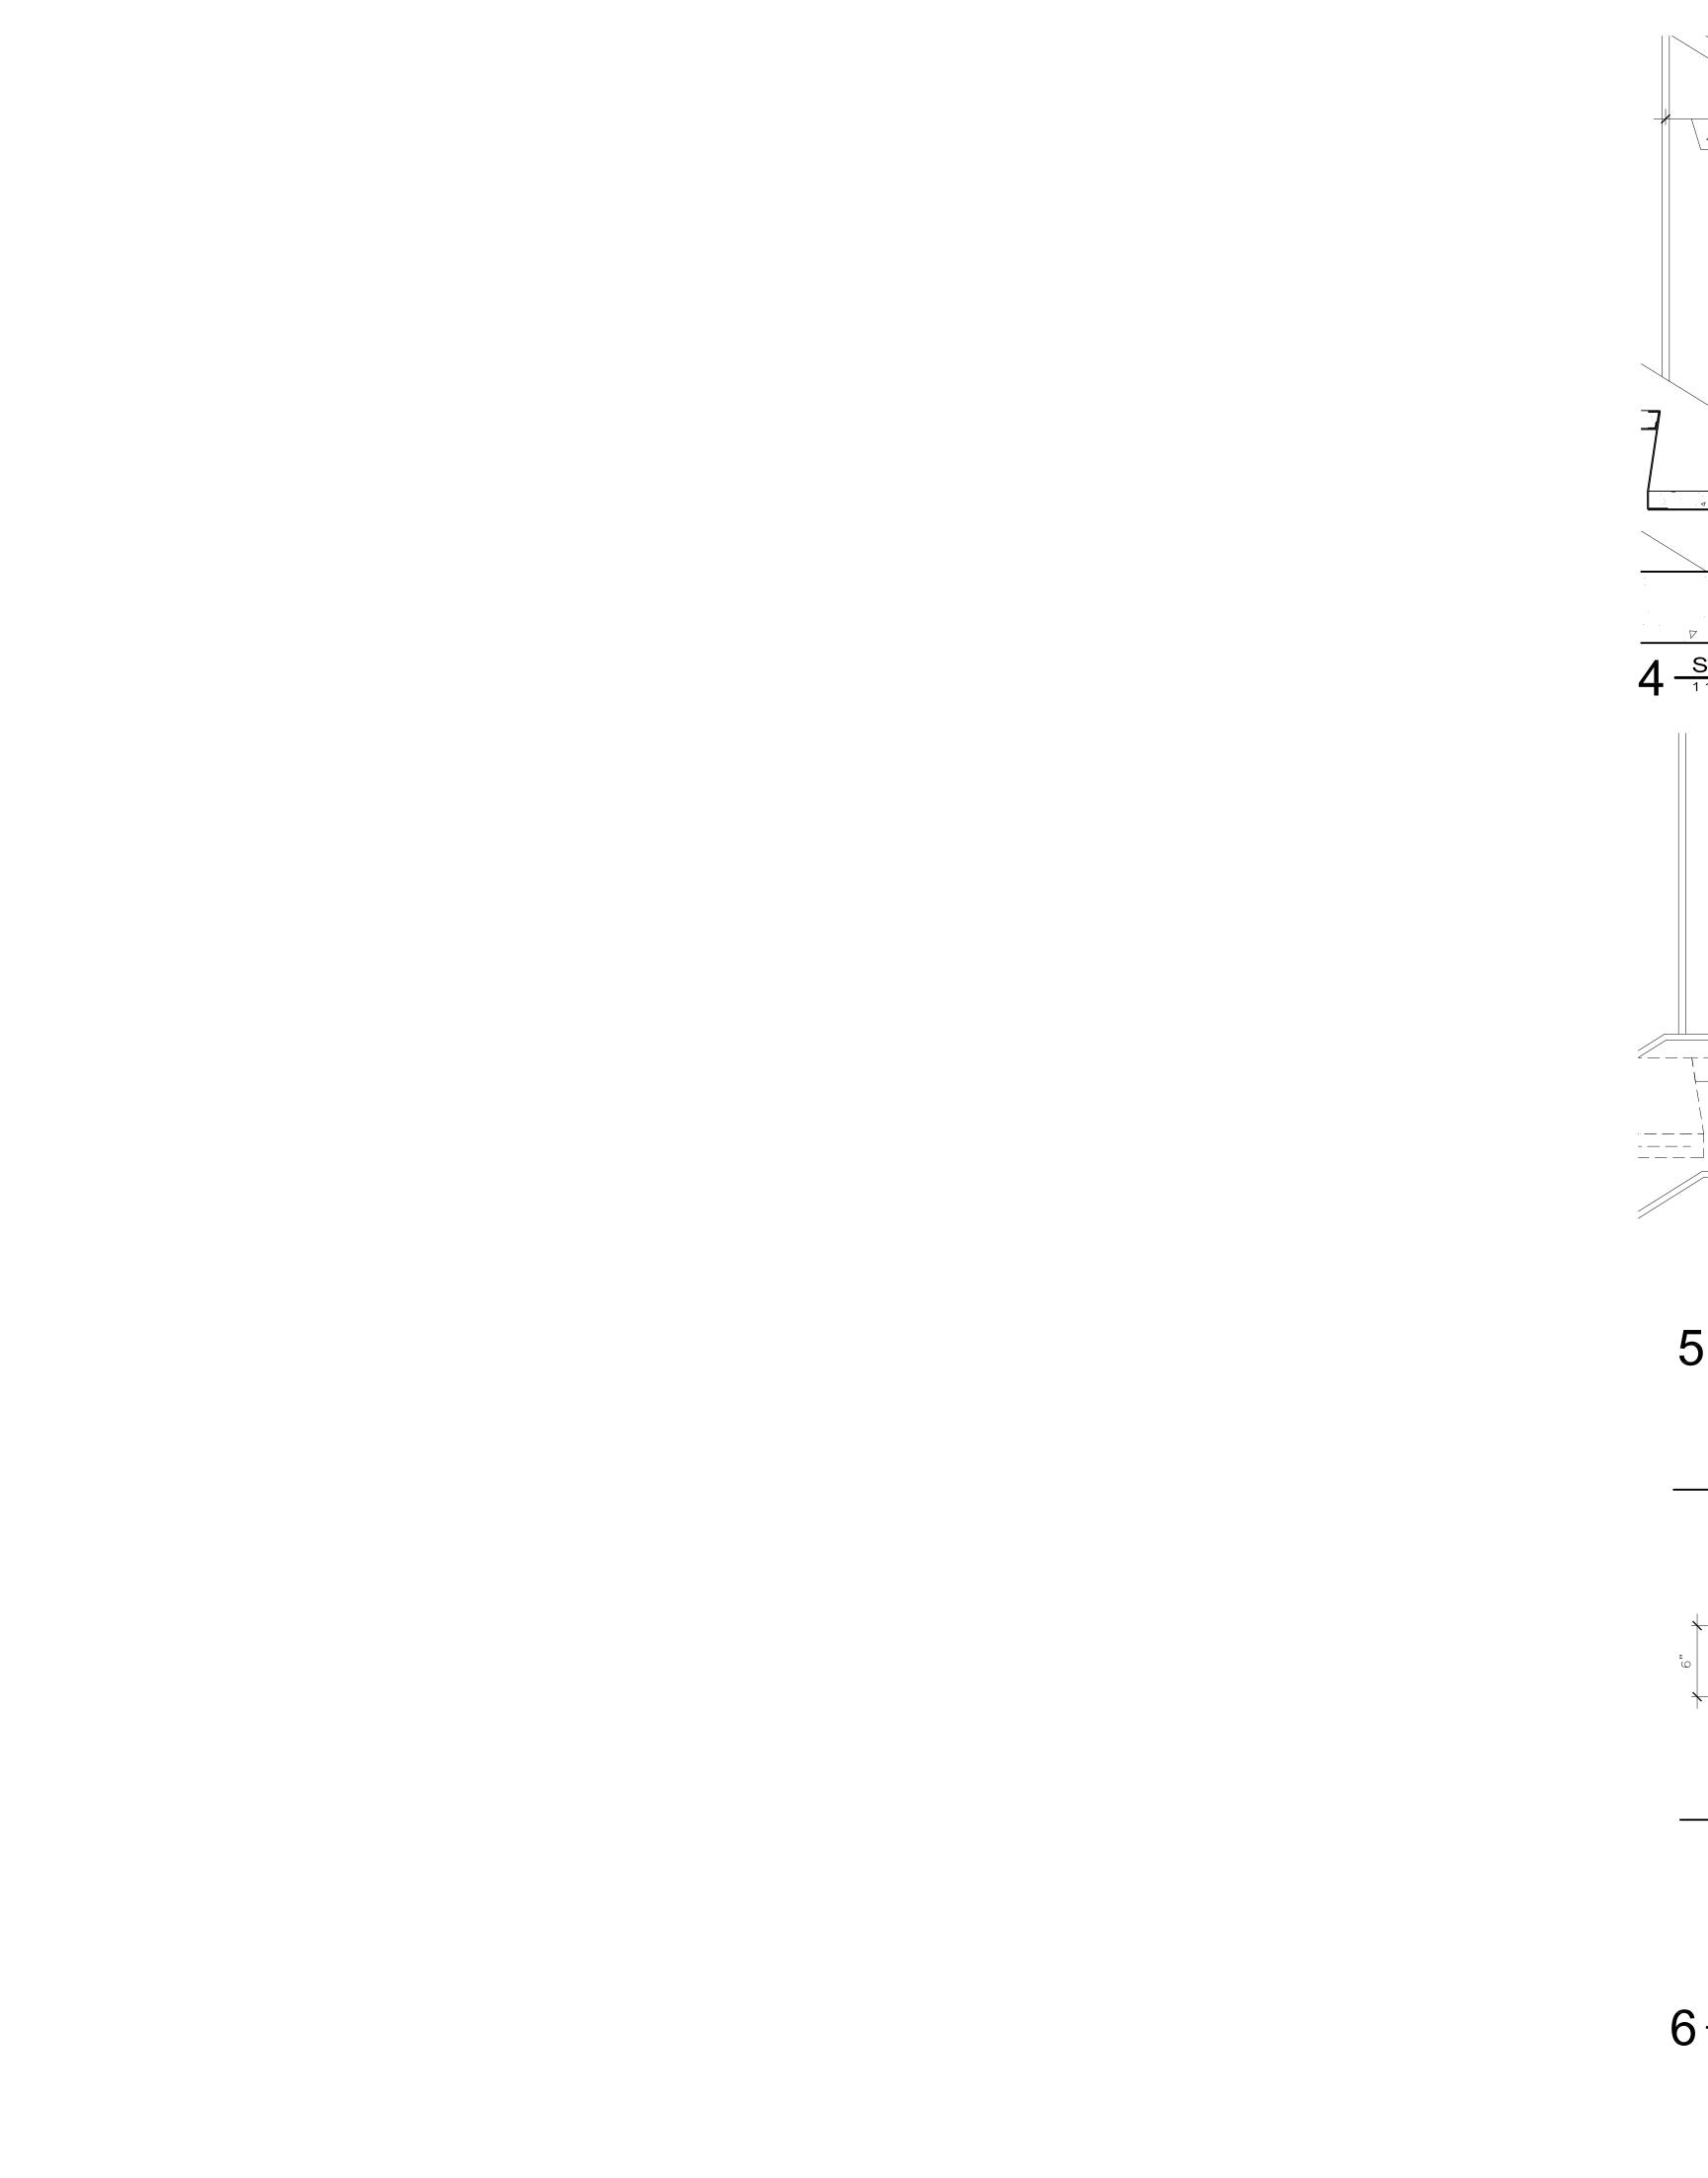
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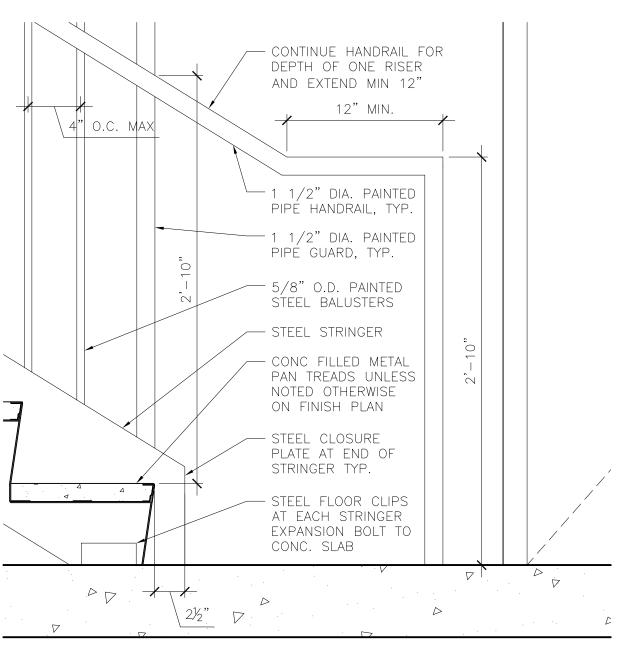
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INTERIOR SYSTEMS **VERTICAL CIRCULATION**

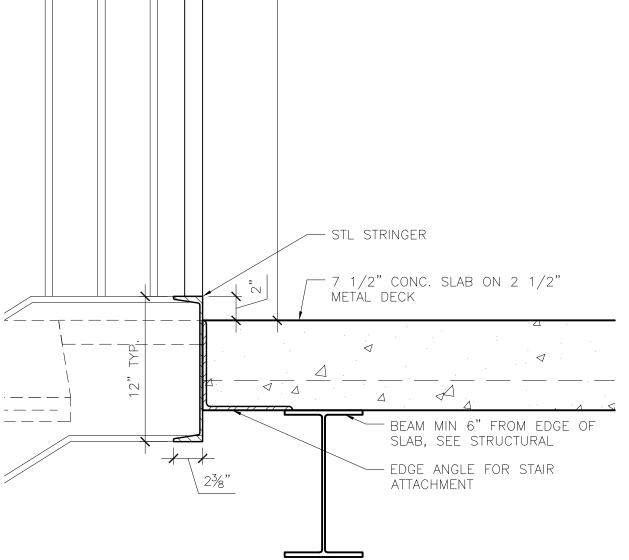
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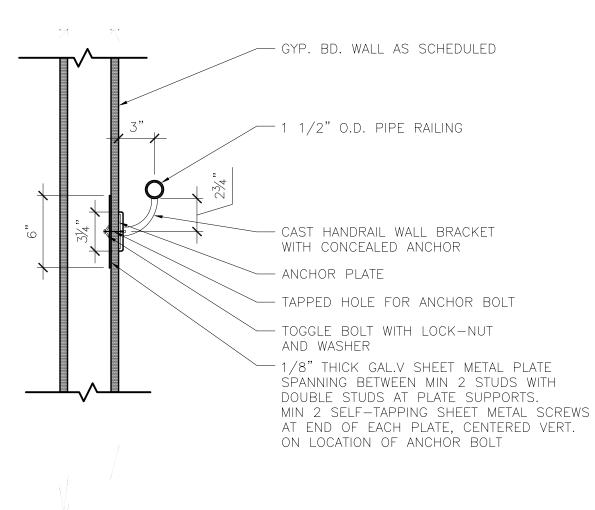





4 STAIR STRINGER @ FIRST LEVEL




5 RAIL TERMINATION DE TAIL



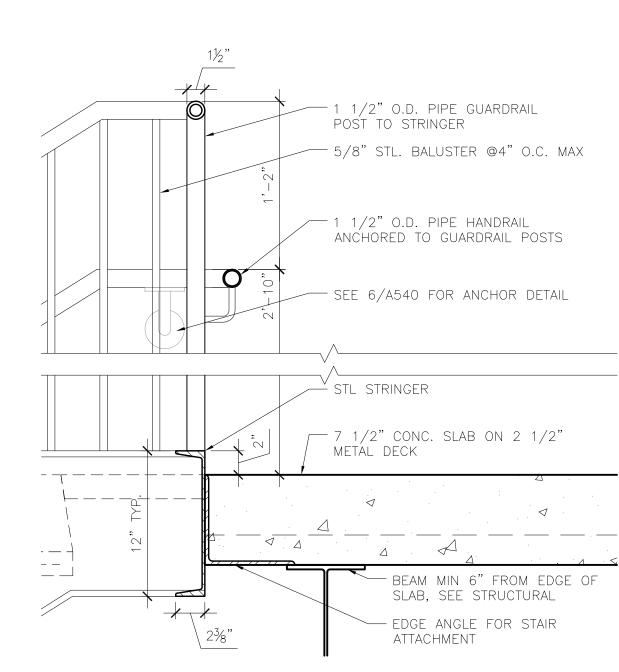
6 HANDRAIL DETAIL AT GYP. BD.



DETAIL AT TOP LANDING 1 1/2" = 1'-0"

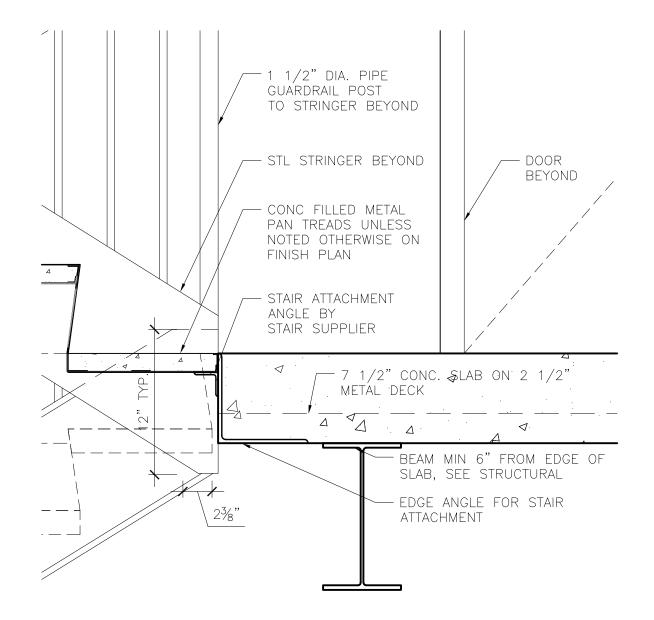

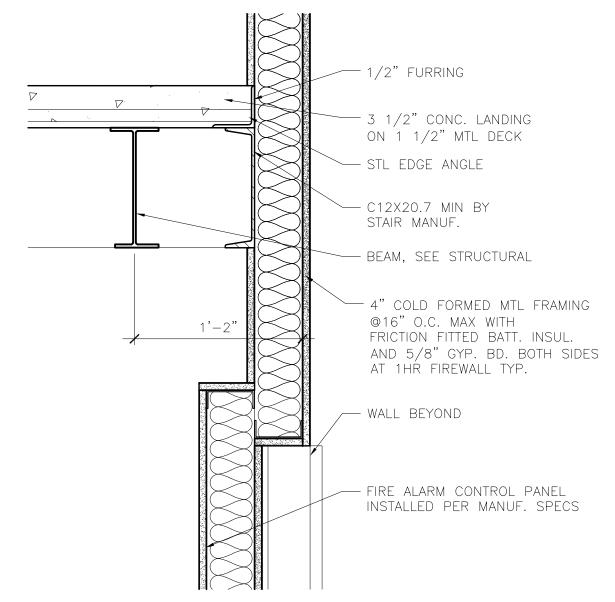2 DETAIL AT INTERMEDIATE LANDING 1 1/2" = 1'-0"



3 DETAIL AT FIRE ALARM ALCOVE



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AUTHORITY

DULUTH
INTERNATIONAL
AIRPORT
DULUTH, MN

NEW PASSENGER TERMINAL

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Landscaping Consultants:

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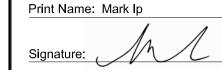
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Date: 06-03-10 Reg. No.: 46001

REVISIONS

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DATE ISSUED: 05-26-10
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DRAWN BY: XX
DESIGNED BY: XX

AEP PROJECT NUMBER

XXX.DW. 213-1882-091 12:00p

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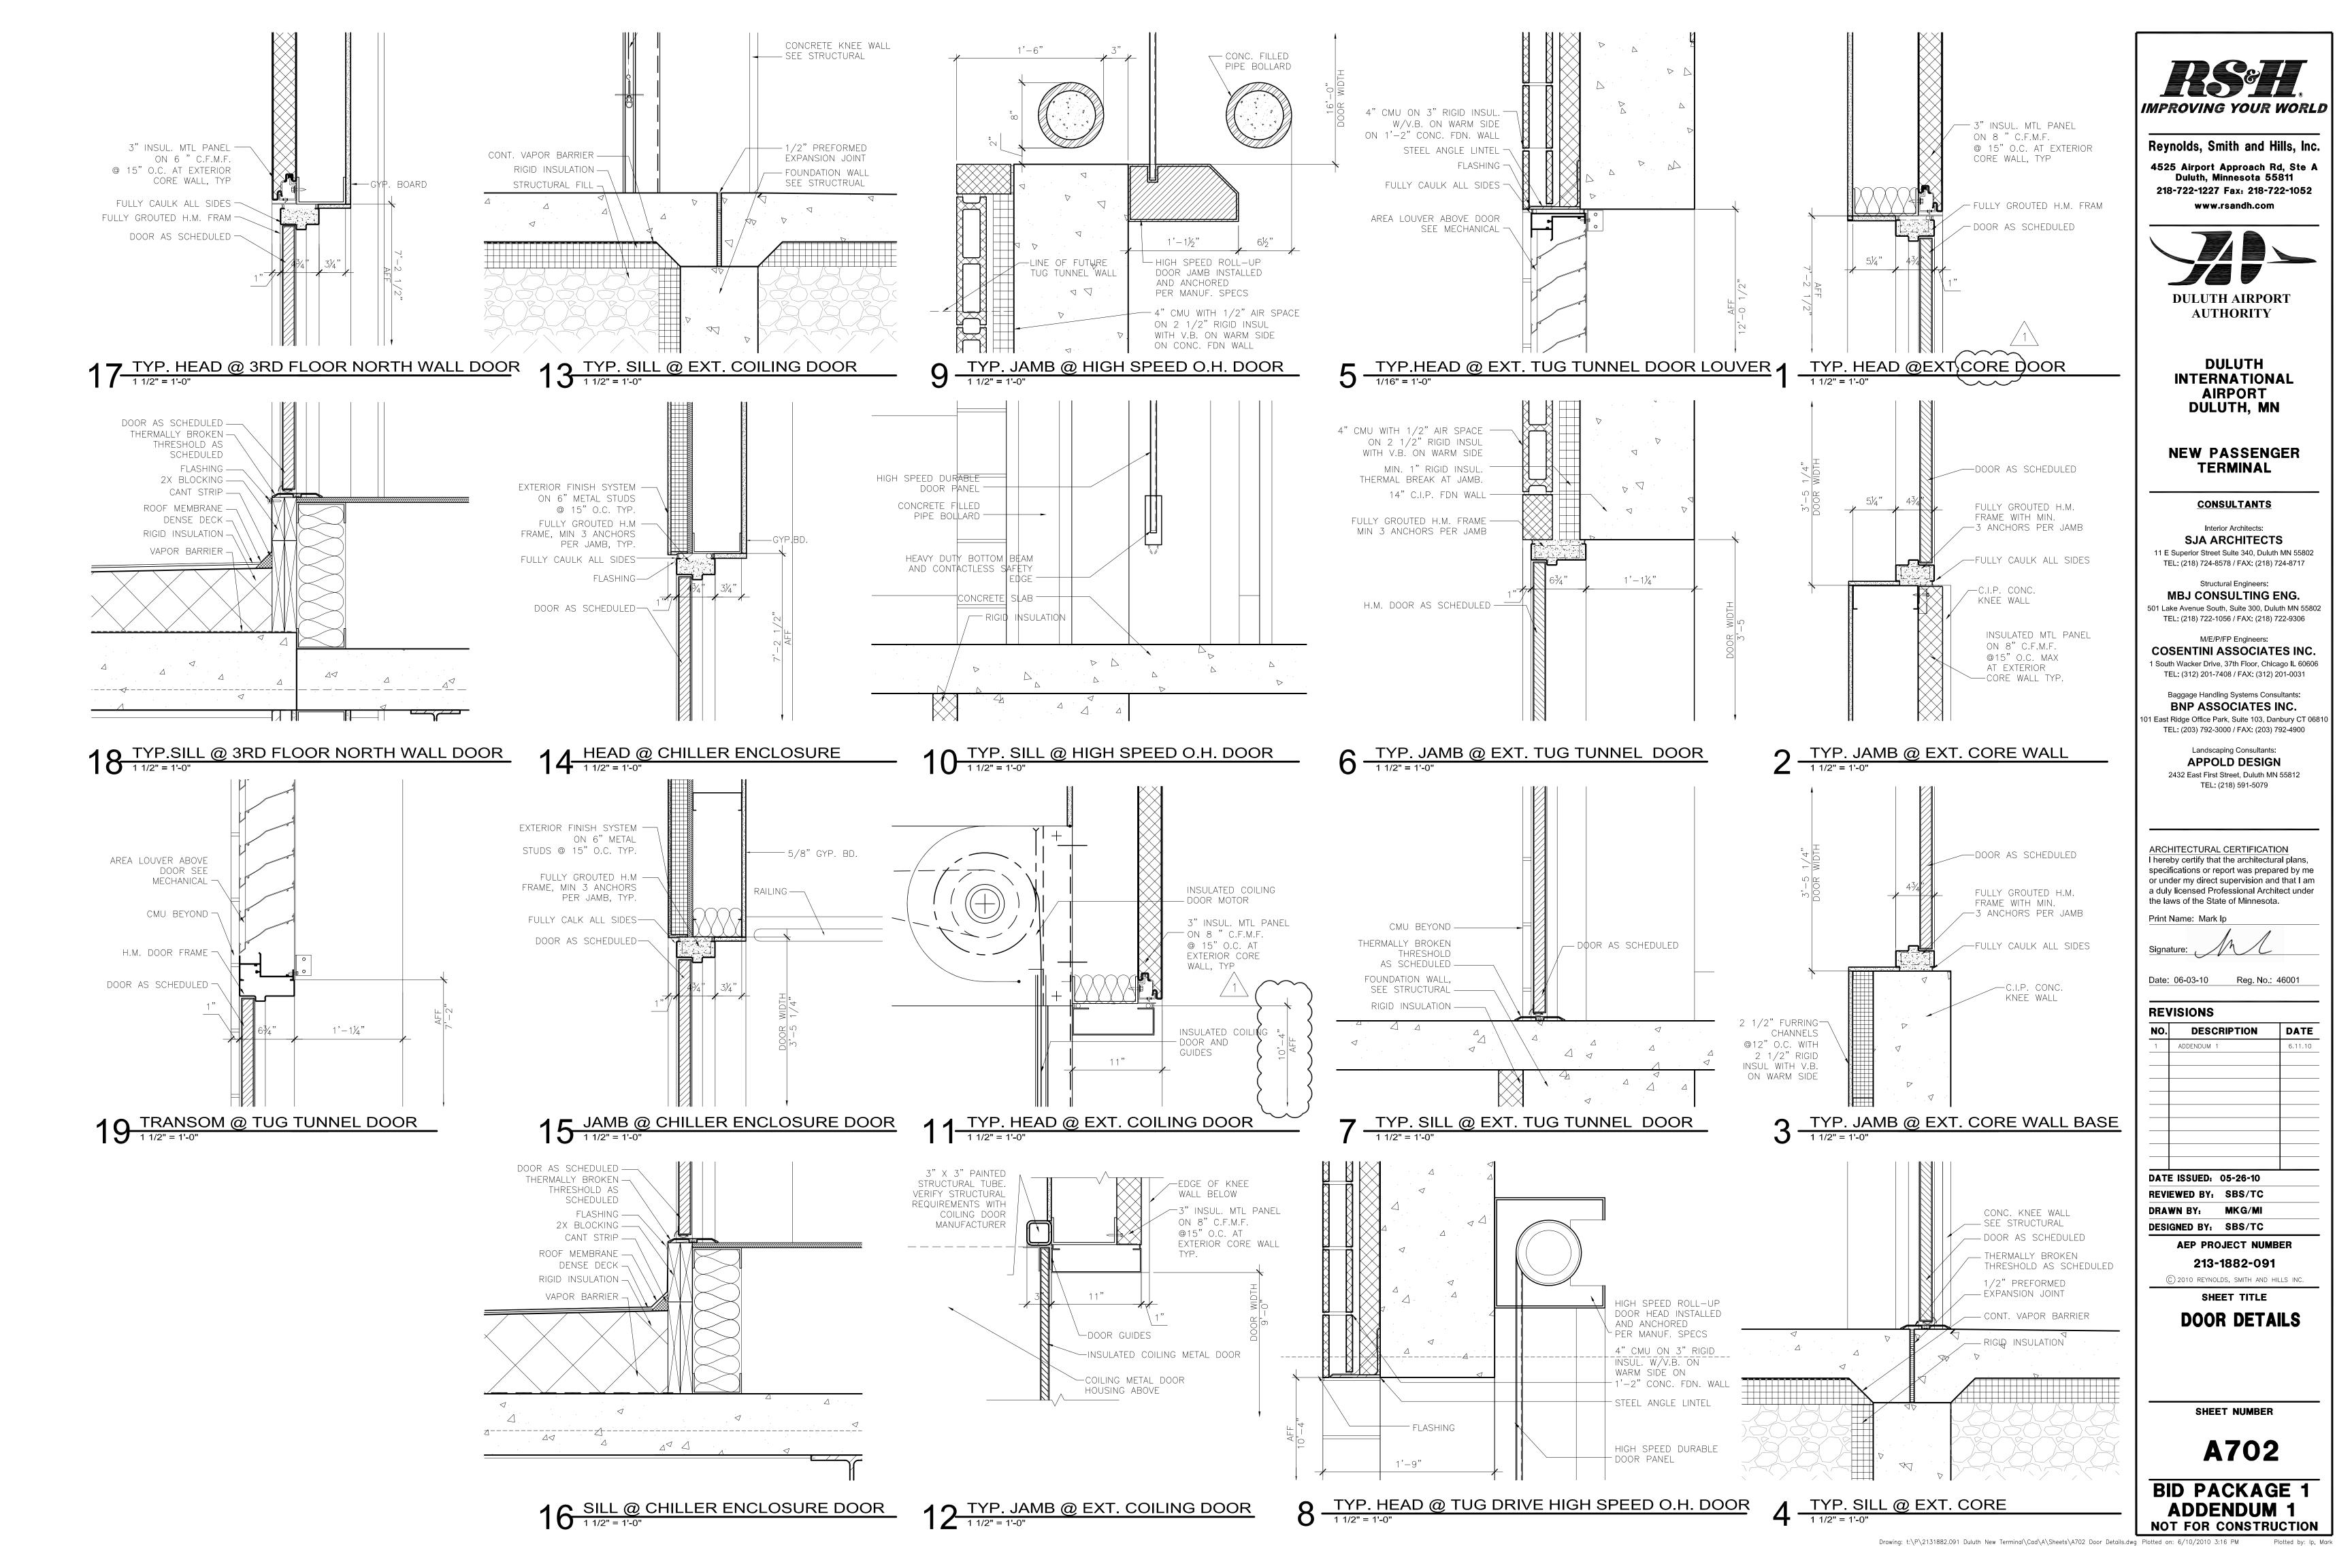
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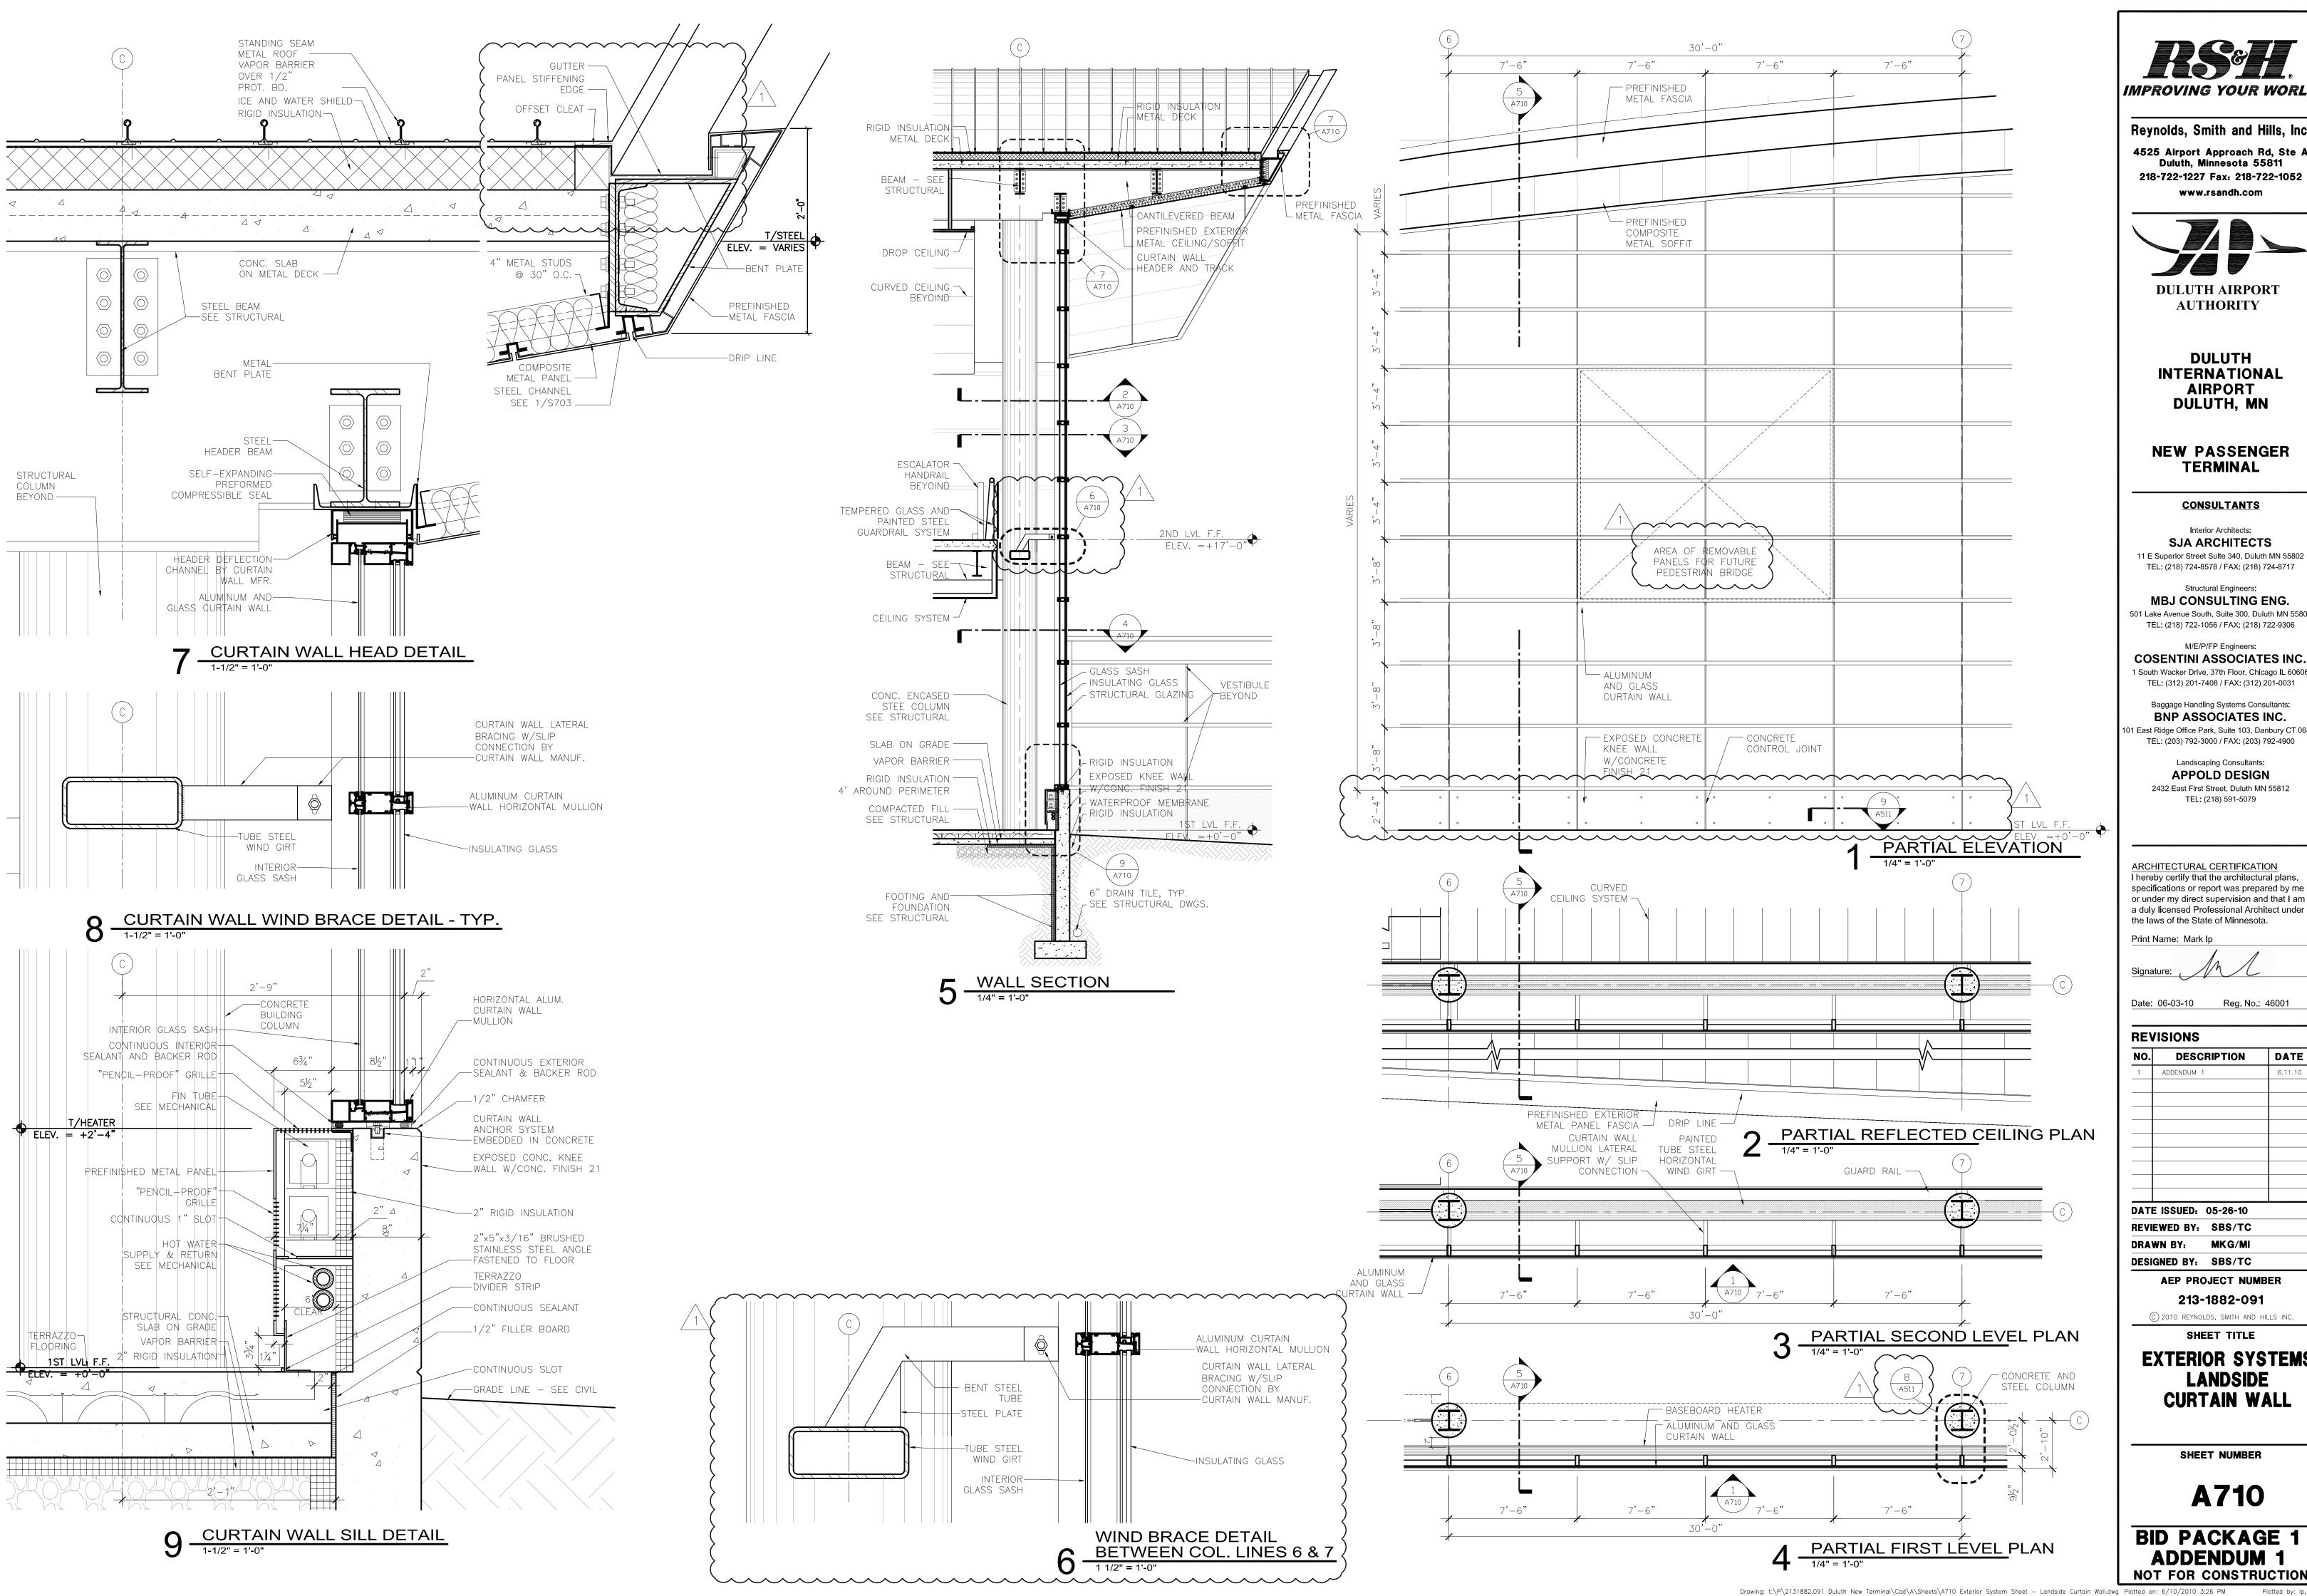
CIRCULATION
DETAILS

A540

BID PACKAGE 1
ADDENDUM 1
NOT FOR CONSTRUCTION

Drawing: T:\P\2131882.091 Duluth New Terminal\Cad\A\Sheets\A540 Vertical Circulation Details.dwg Plotted on: 6/10/2010 3:55 PMPlotted by: Kolodziej, Magdalena





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NO. DESCRIPTION DATE **DATE ISSUED: 05-26-10**

REVIEWED BY: SBS/TC DRAWN BY: MKG/MI

AEP PROJECT NUMBER


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EXTERIOR SYSTEMS LANDSIDE CURTAIN WALL

SHEET NUMBER

A710



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CONSULTANTS
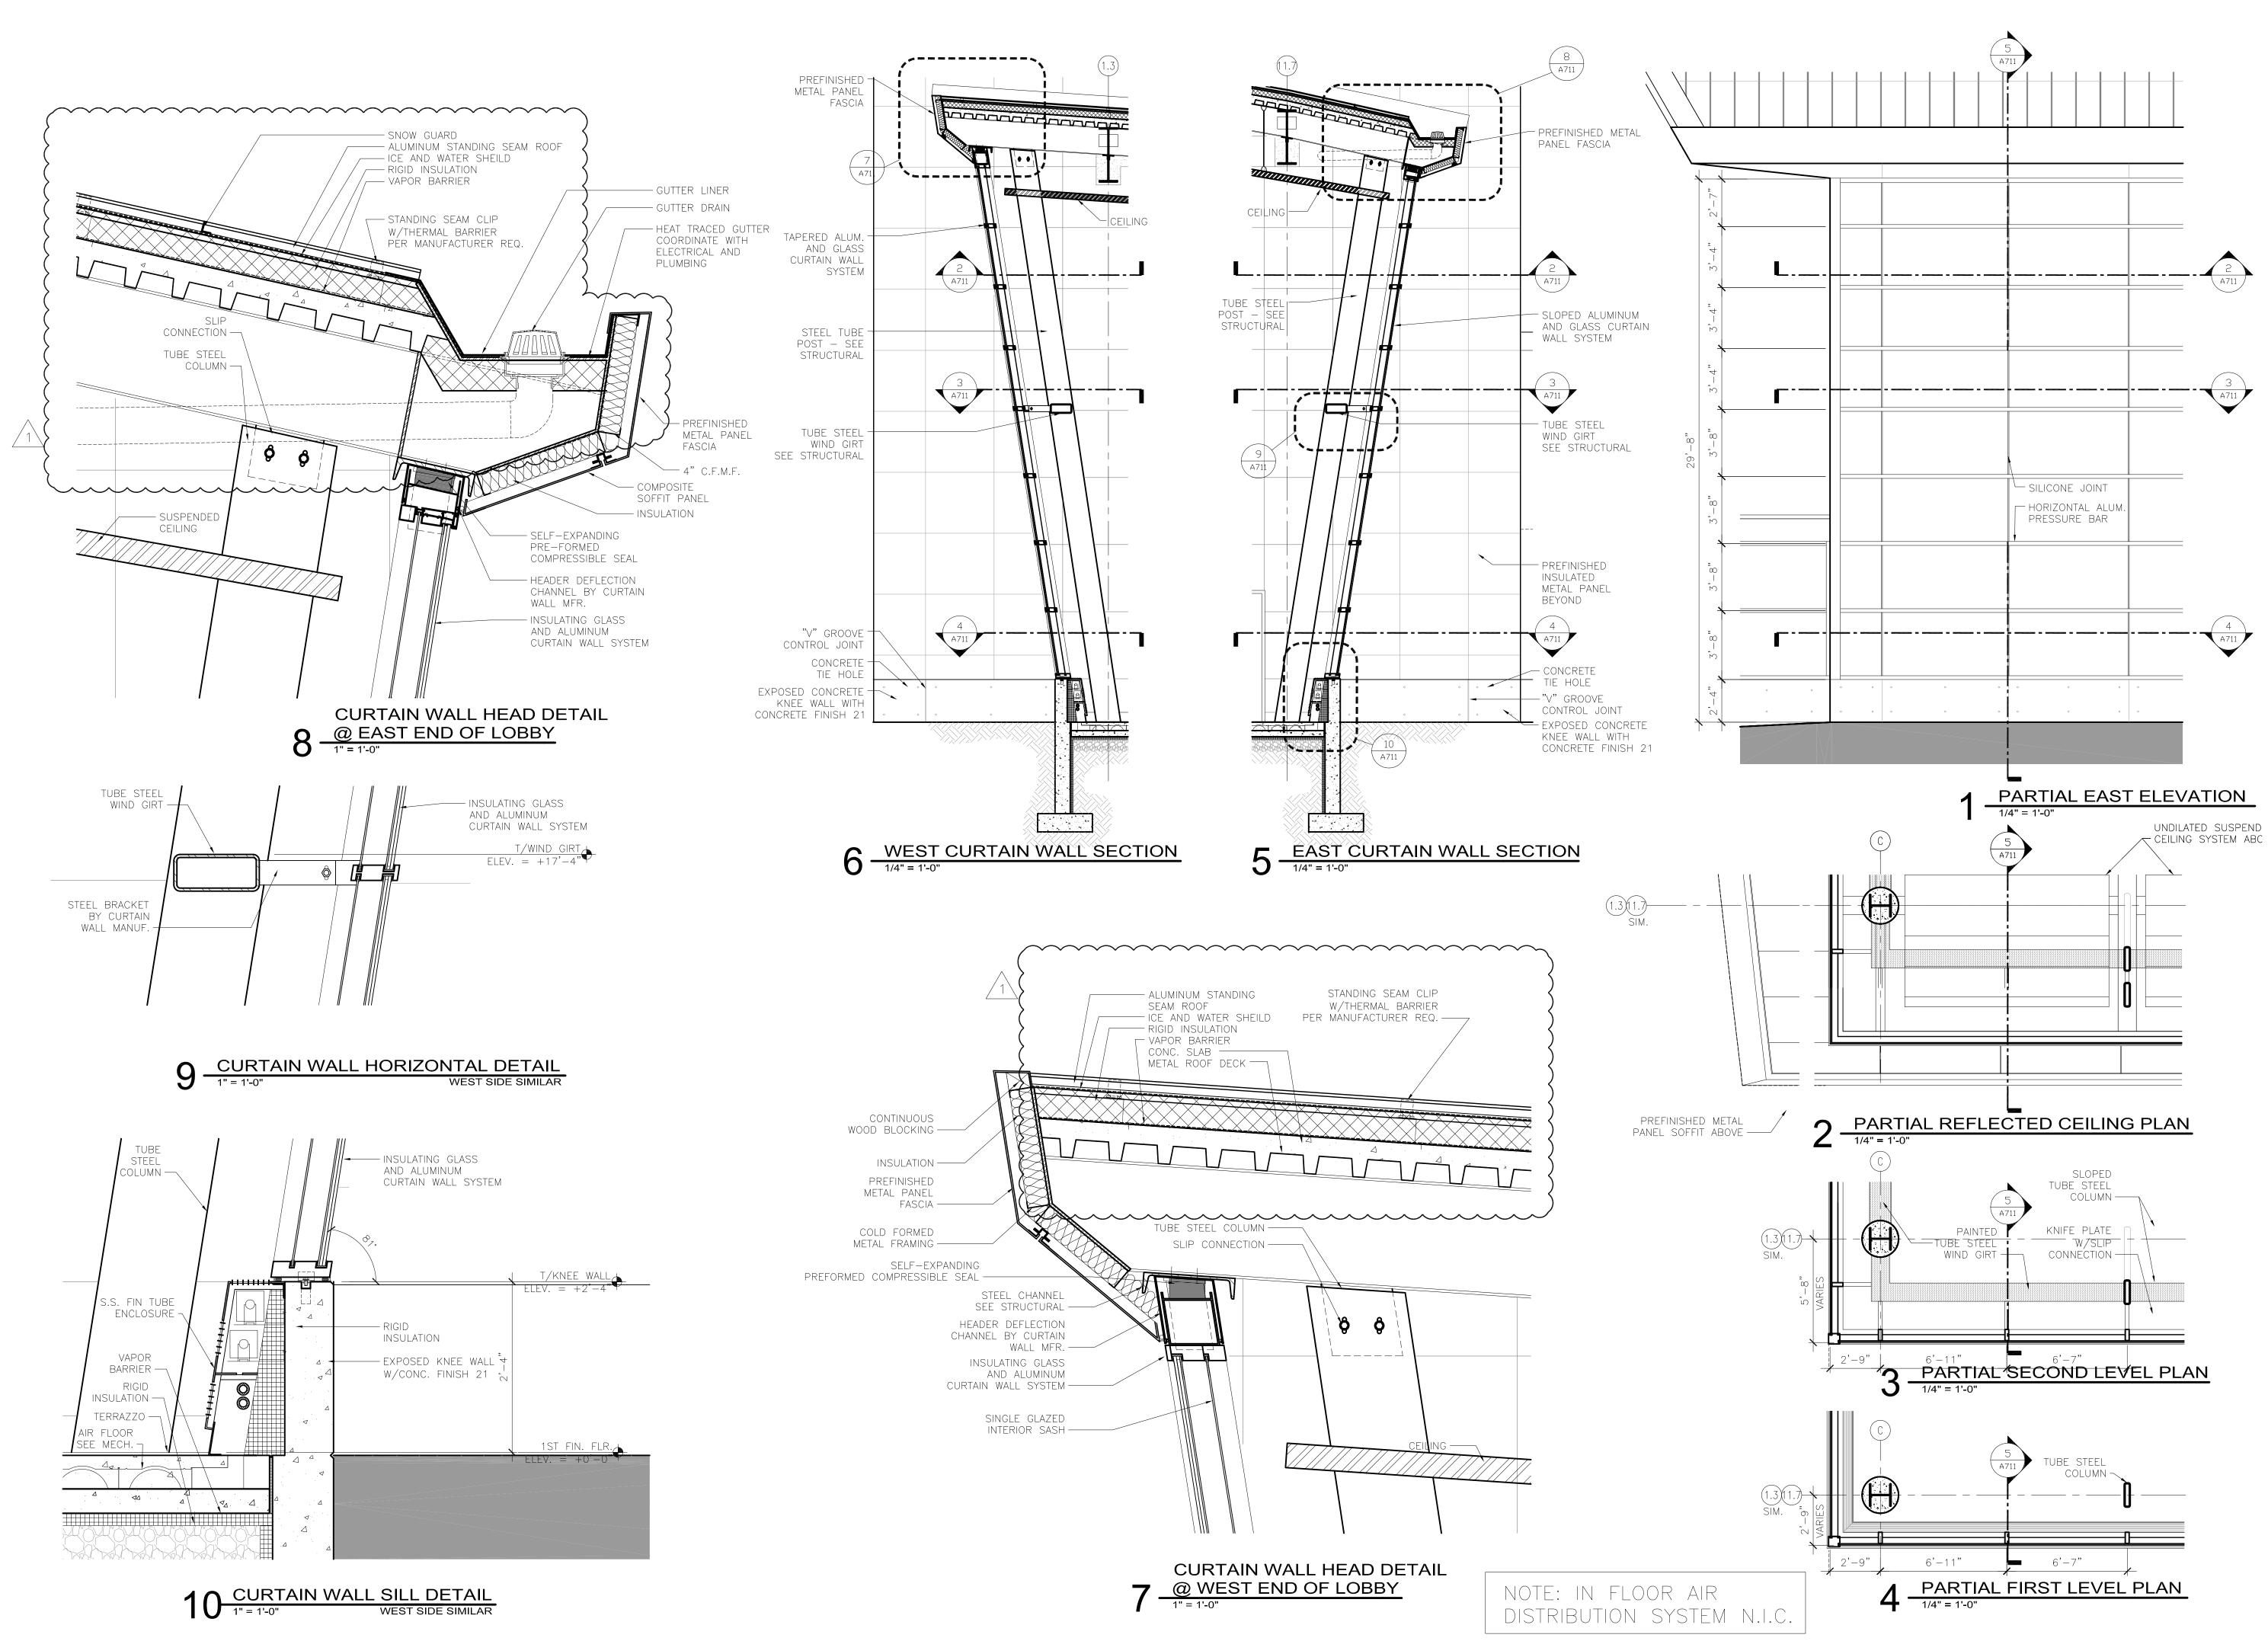
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TEL: (218) 591-5079

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ARCHITECTURAL CERTIFICATION

Print Name: Mark Ip

Date: 06-03-10 Reg. No.: 46001

REVISIONS

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DRAWN BY: MKG/MI DESIGNED BY: SBS/TC

AEP PROJECT NUMBER 213-1882-091

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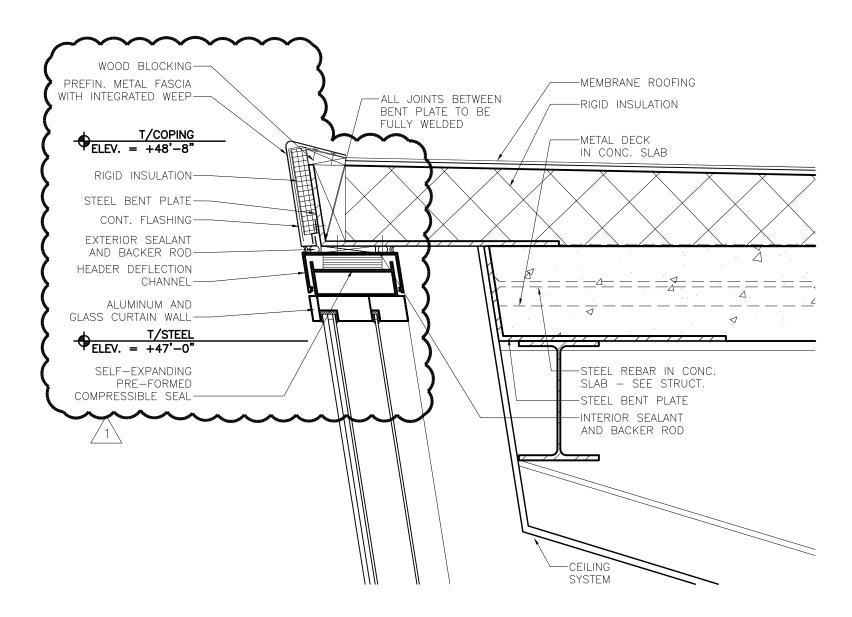
EXTERIOR SYSTEMS **LANDSIDE CURTAIN WALL**

SHEET NUMBER

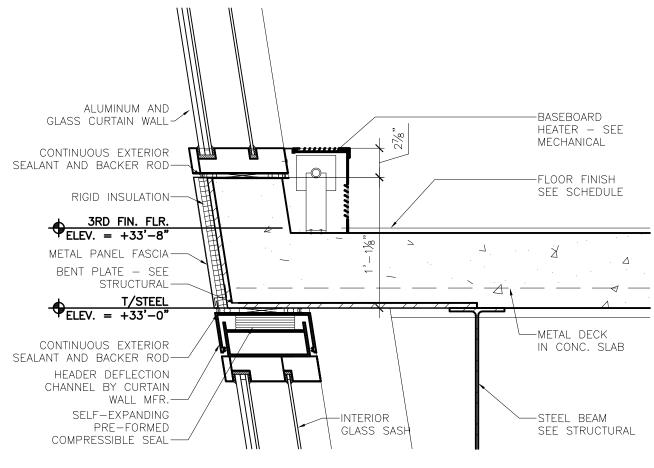
A711

BID PACKAGE 1 ADDENDUM 1 NOT FOR CONSTRUCTION


Drawing: t:\P\2131882.091 Duluth New Terminal\Cad\A\Sheets\A711 Exterior System Sheet - Landside Curtain Wall.dwg Plotted on: 6/10/2010 3:42 PM







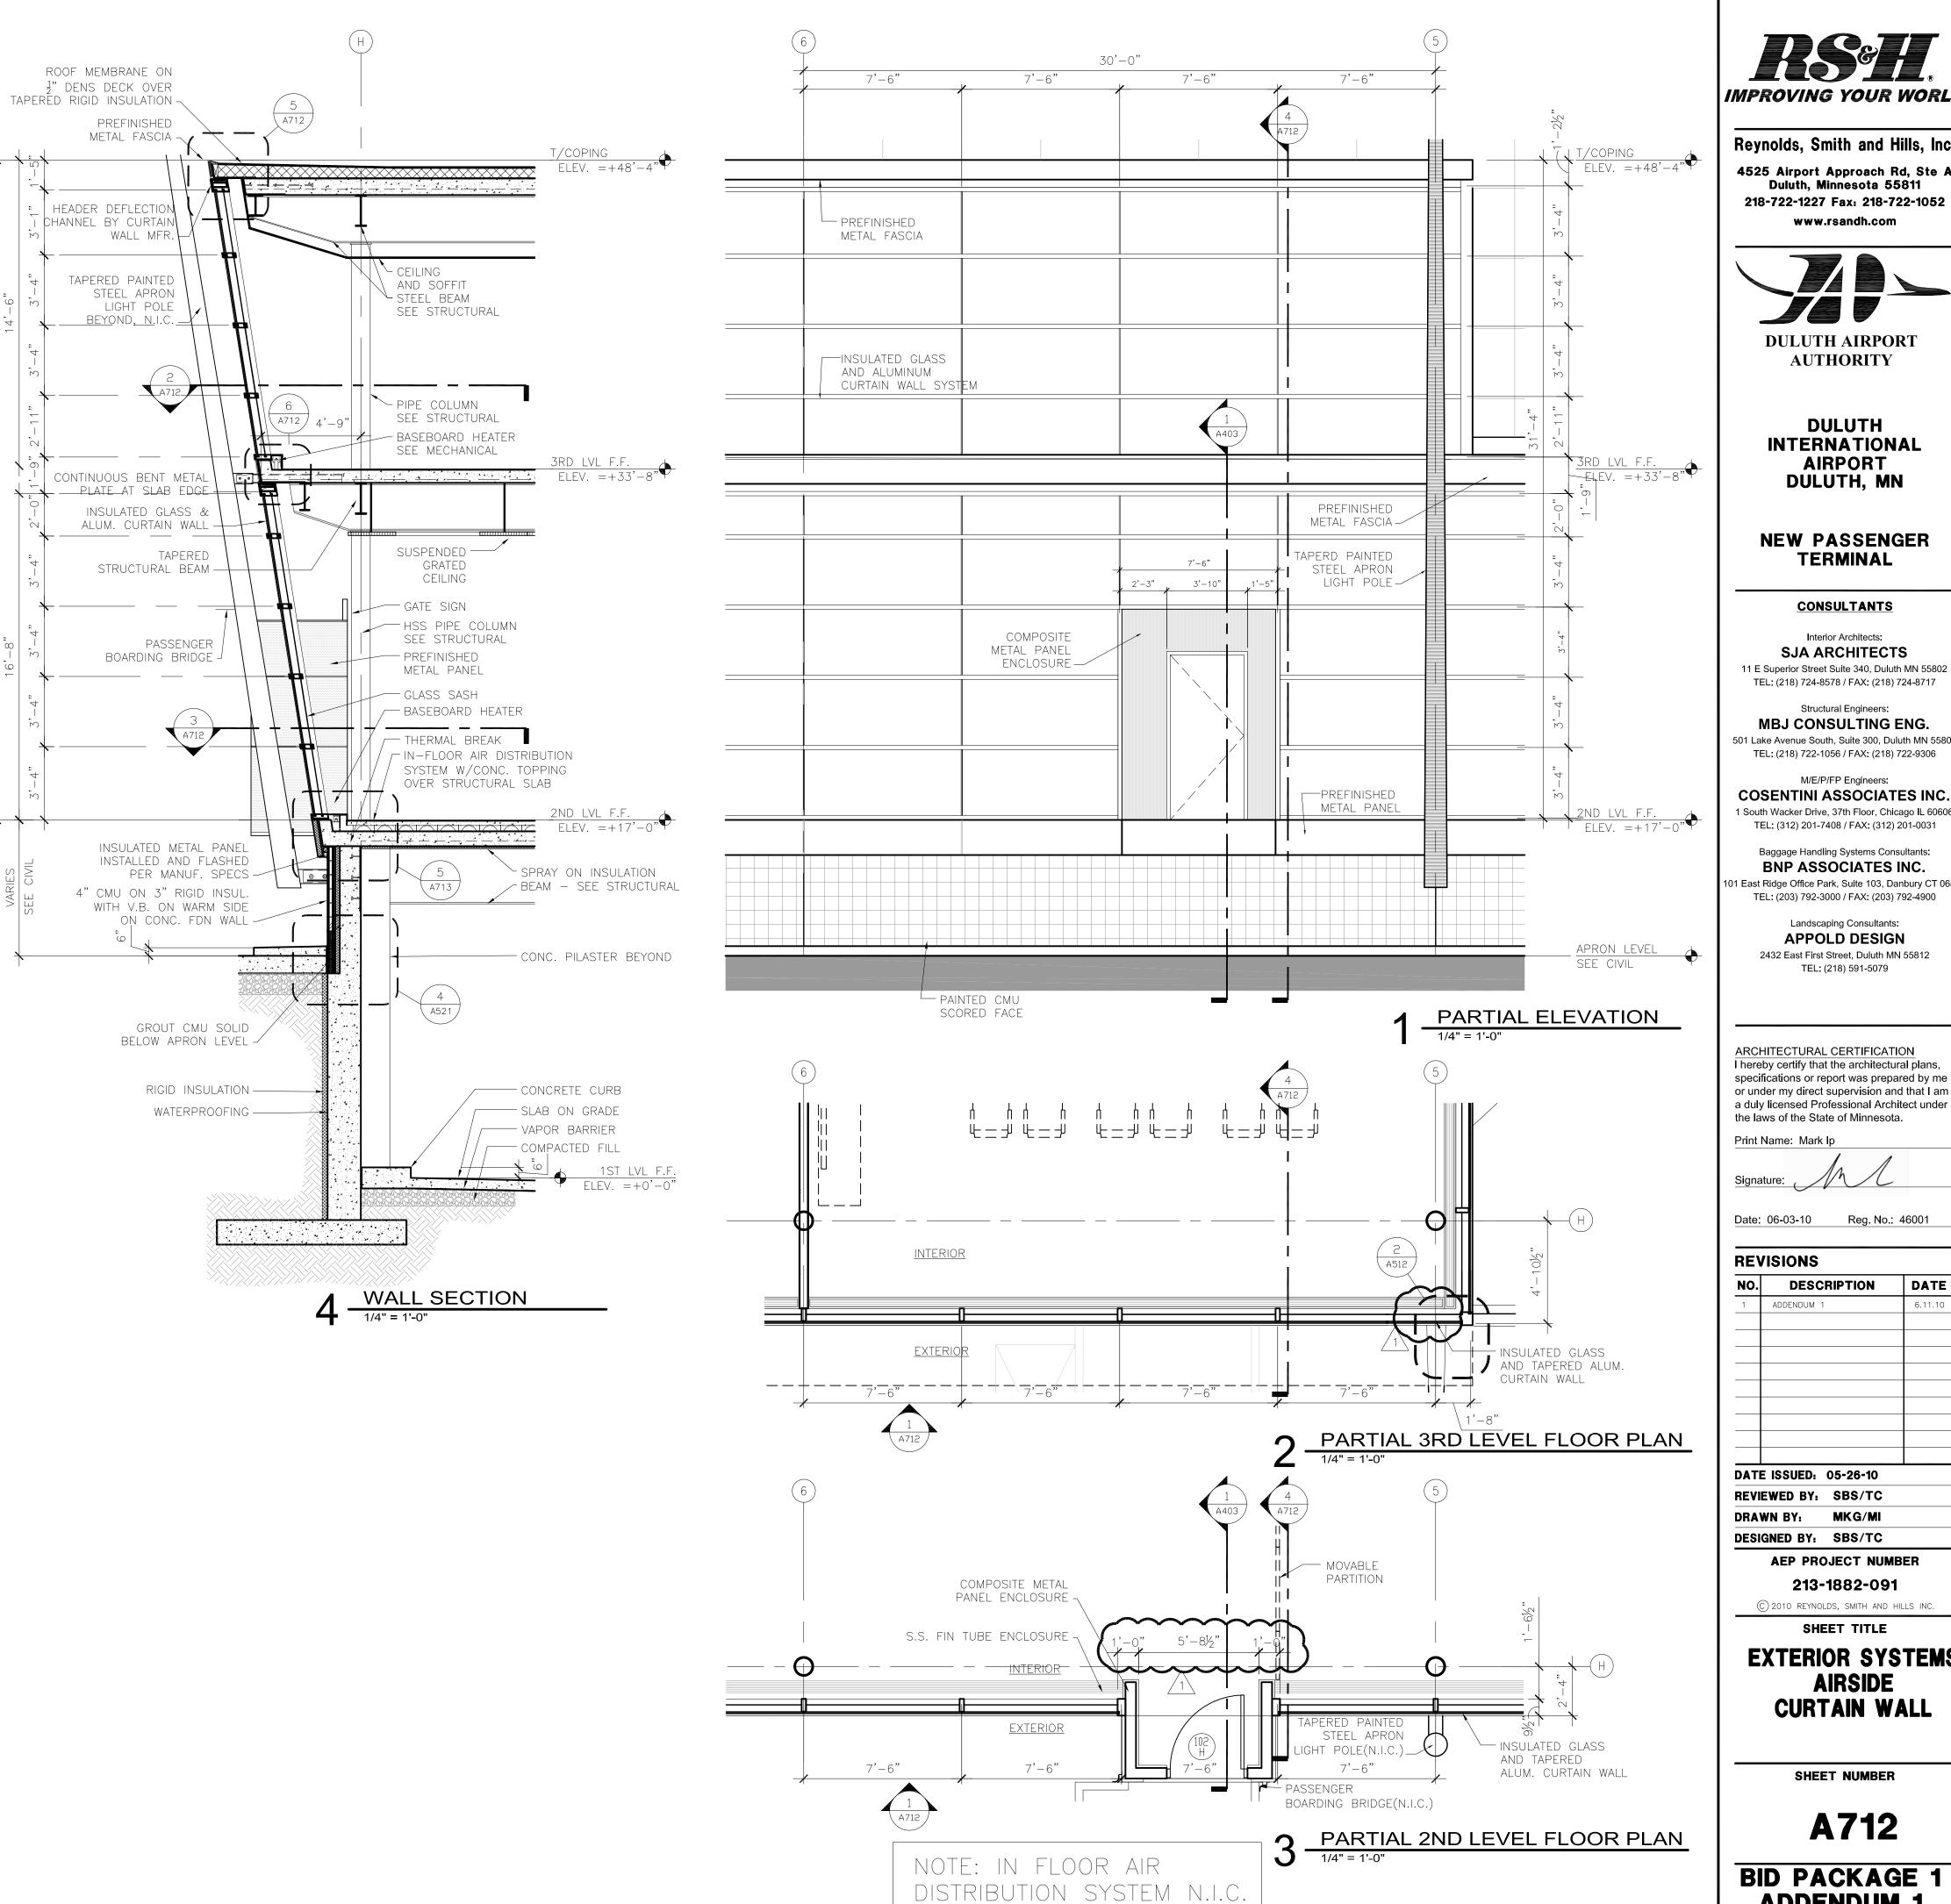CURTAIN WALL HORIZONTAL 6 MULLION DETAIL @ 2ND LEVEL
1 1/2" = 1'-0"





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AUTHORITY

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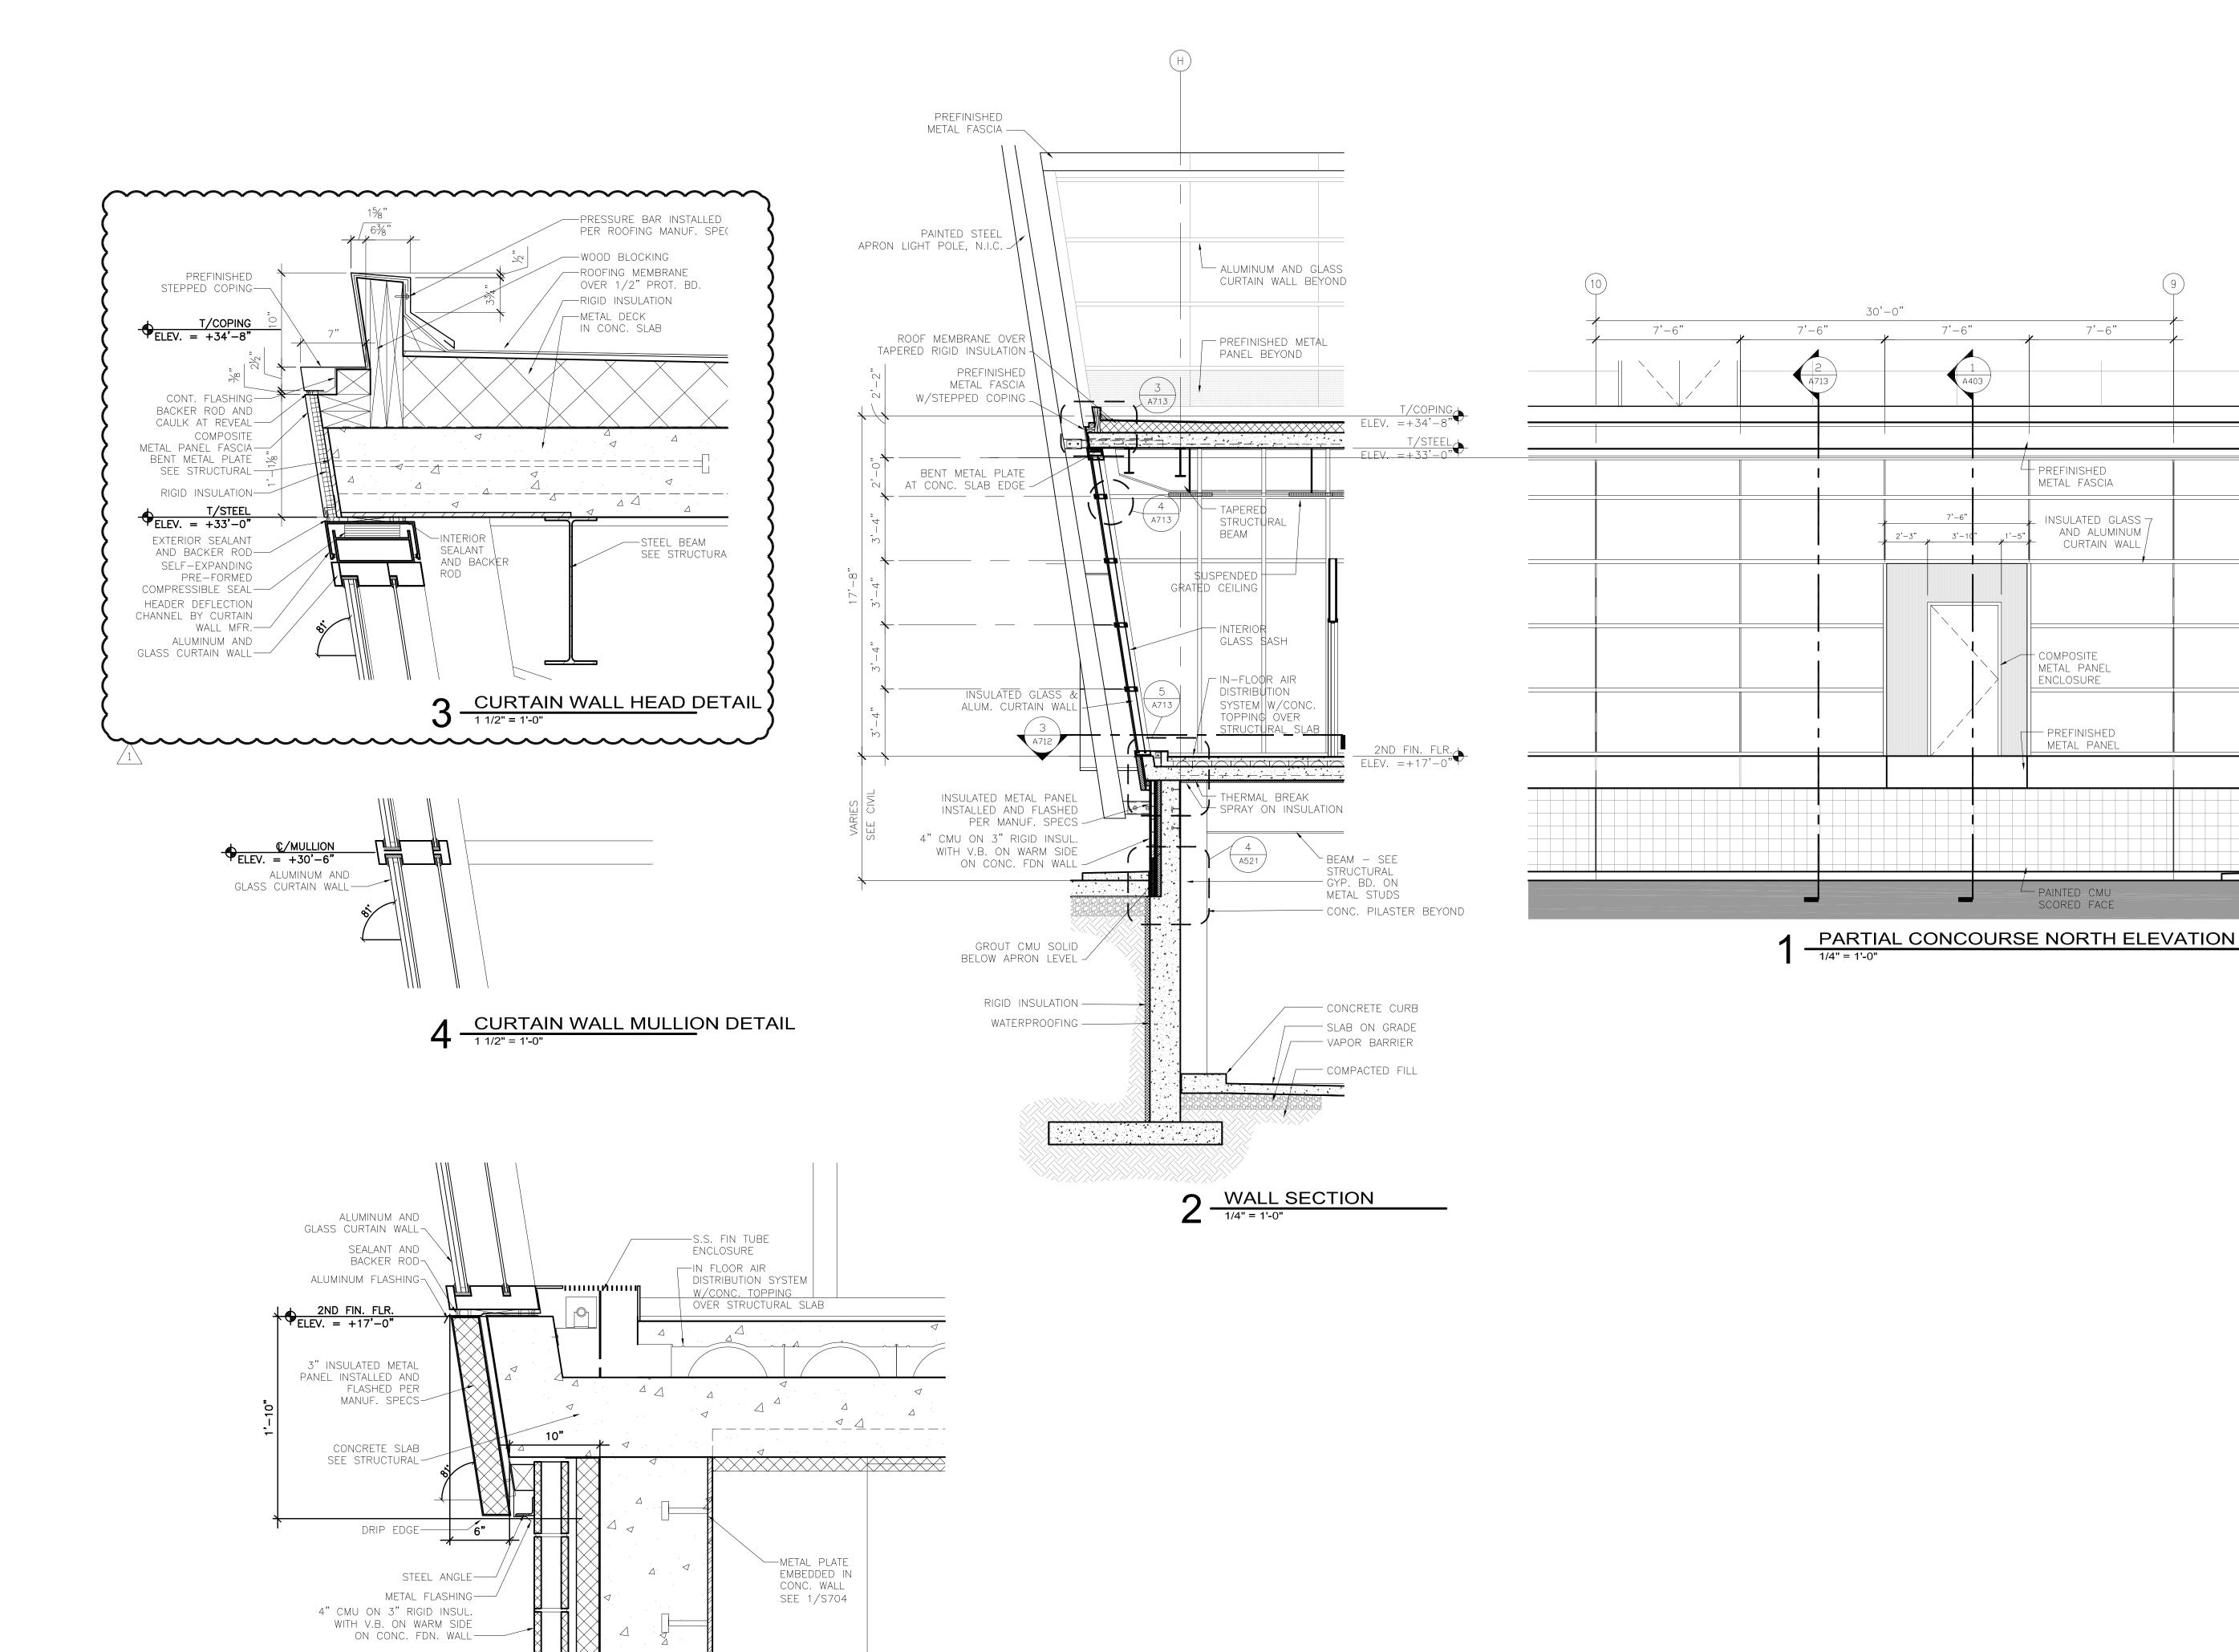
EXTERIOR SYSTEMS AIRSIDE CURTAIN WALL

SHEET NUMBER

A712

BID PACKAGE 1 ADDENDUM 1 NOT FOR CONSTRUCTION

Drawing: t:\P\2131882.091 Duluth New Terminal\Cad\A\Sheets\A712 Exterior System Sheet - Airside Curtain Wall.dwg Plotted on: 6/10/2010 3:50 PM



5 CURTAIN WALL SILL DETAIL
1 1/2" = 1'-0"

NOTE: IN FLOOR AIR

7'-6"

INSULATED GLASS 7

AND ALUMINUM /

CURTAIN WALL ,

METAL PANEL

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DULUTH INTERNATIONAL AIRPORT DULUTH, MN

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DRAWN BY: MKG/MI DESIGNED BY: SBS/TC

AEP PROJECT NUMBER


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EXTERIOR SYSTEMS AIRSIDE CURTAIN WALL

SHEET NUMBER

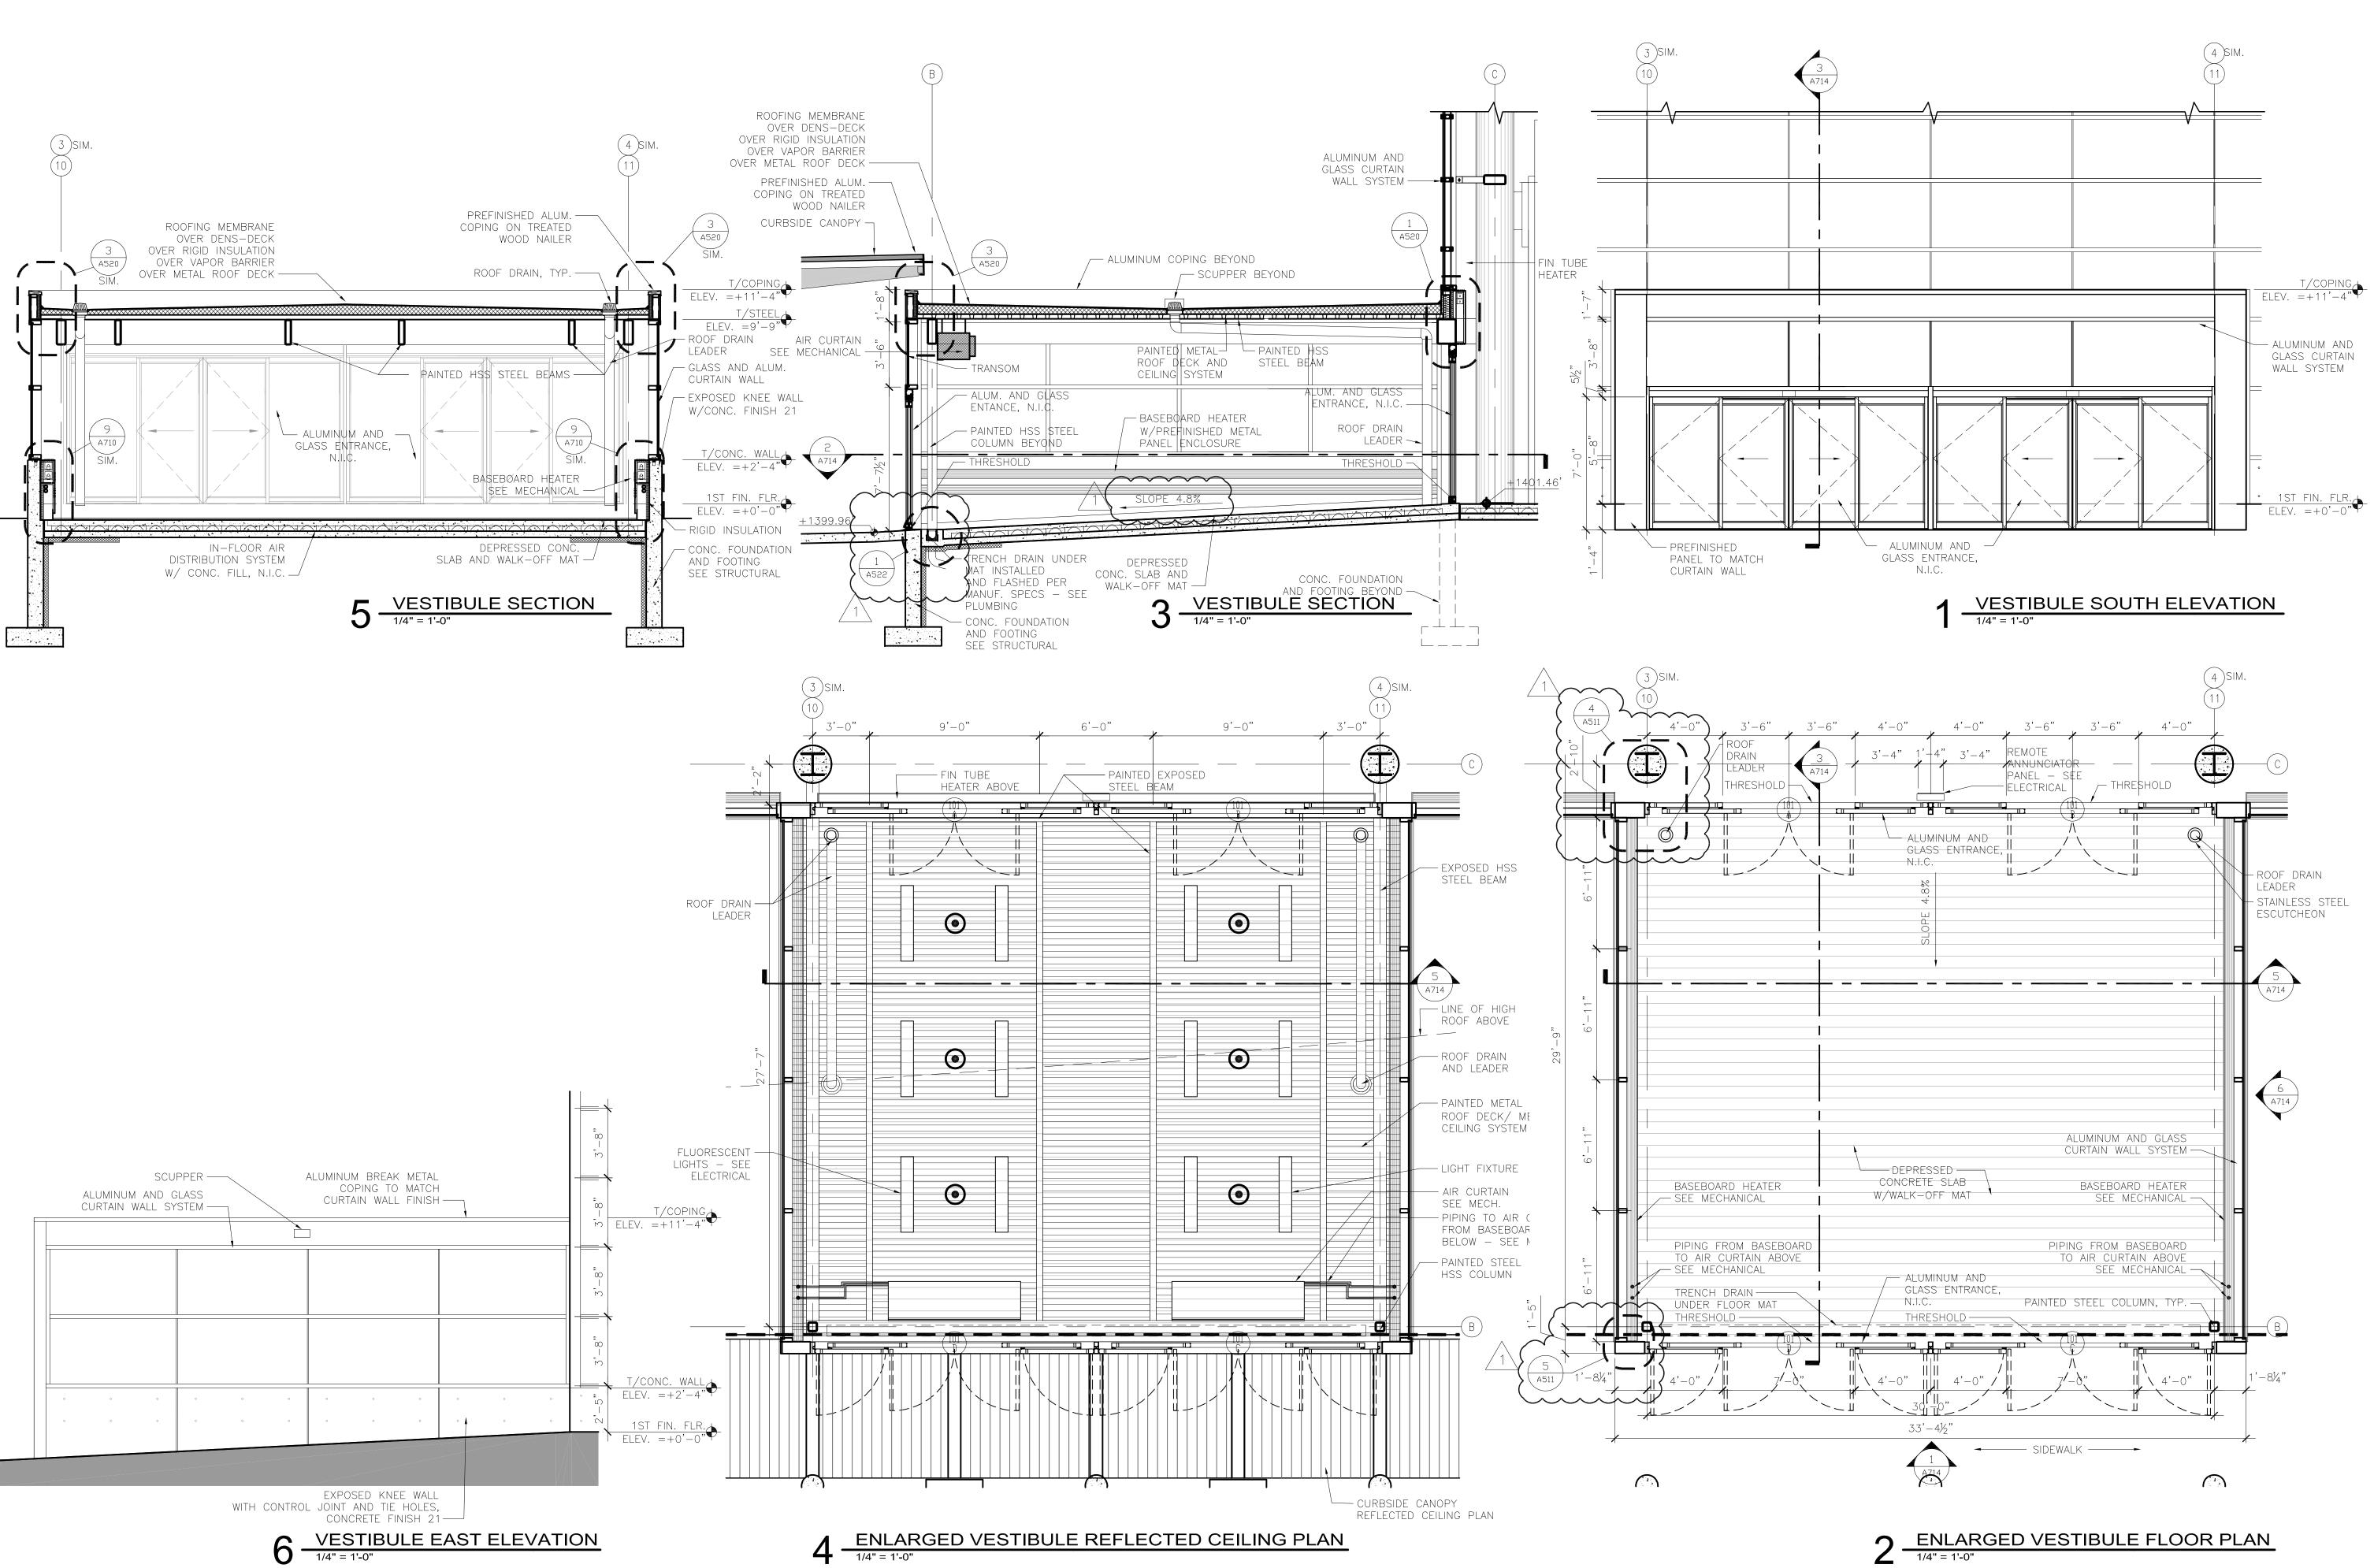A713





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DULUTH, MN

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NO. DESCRIP

NO. DESCRIPTION DATE

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DRAWN BY: MKG/MI

DESIGNED BY: SBS/TC

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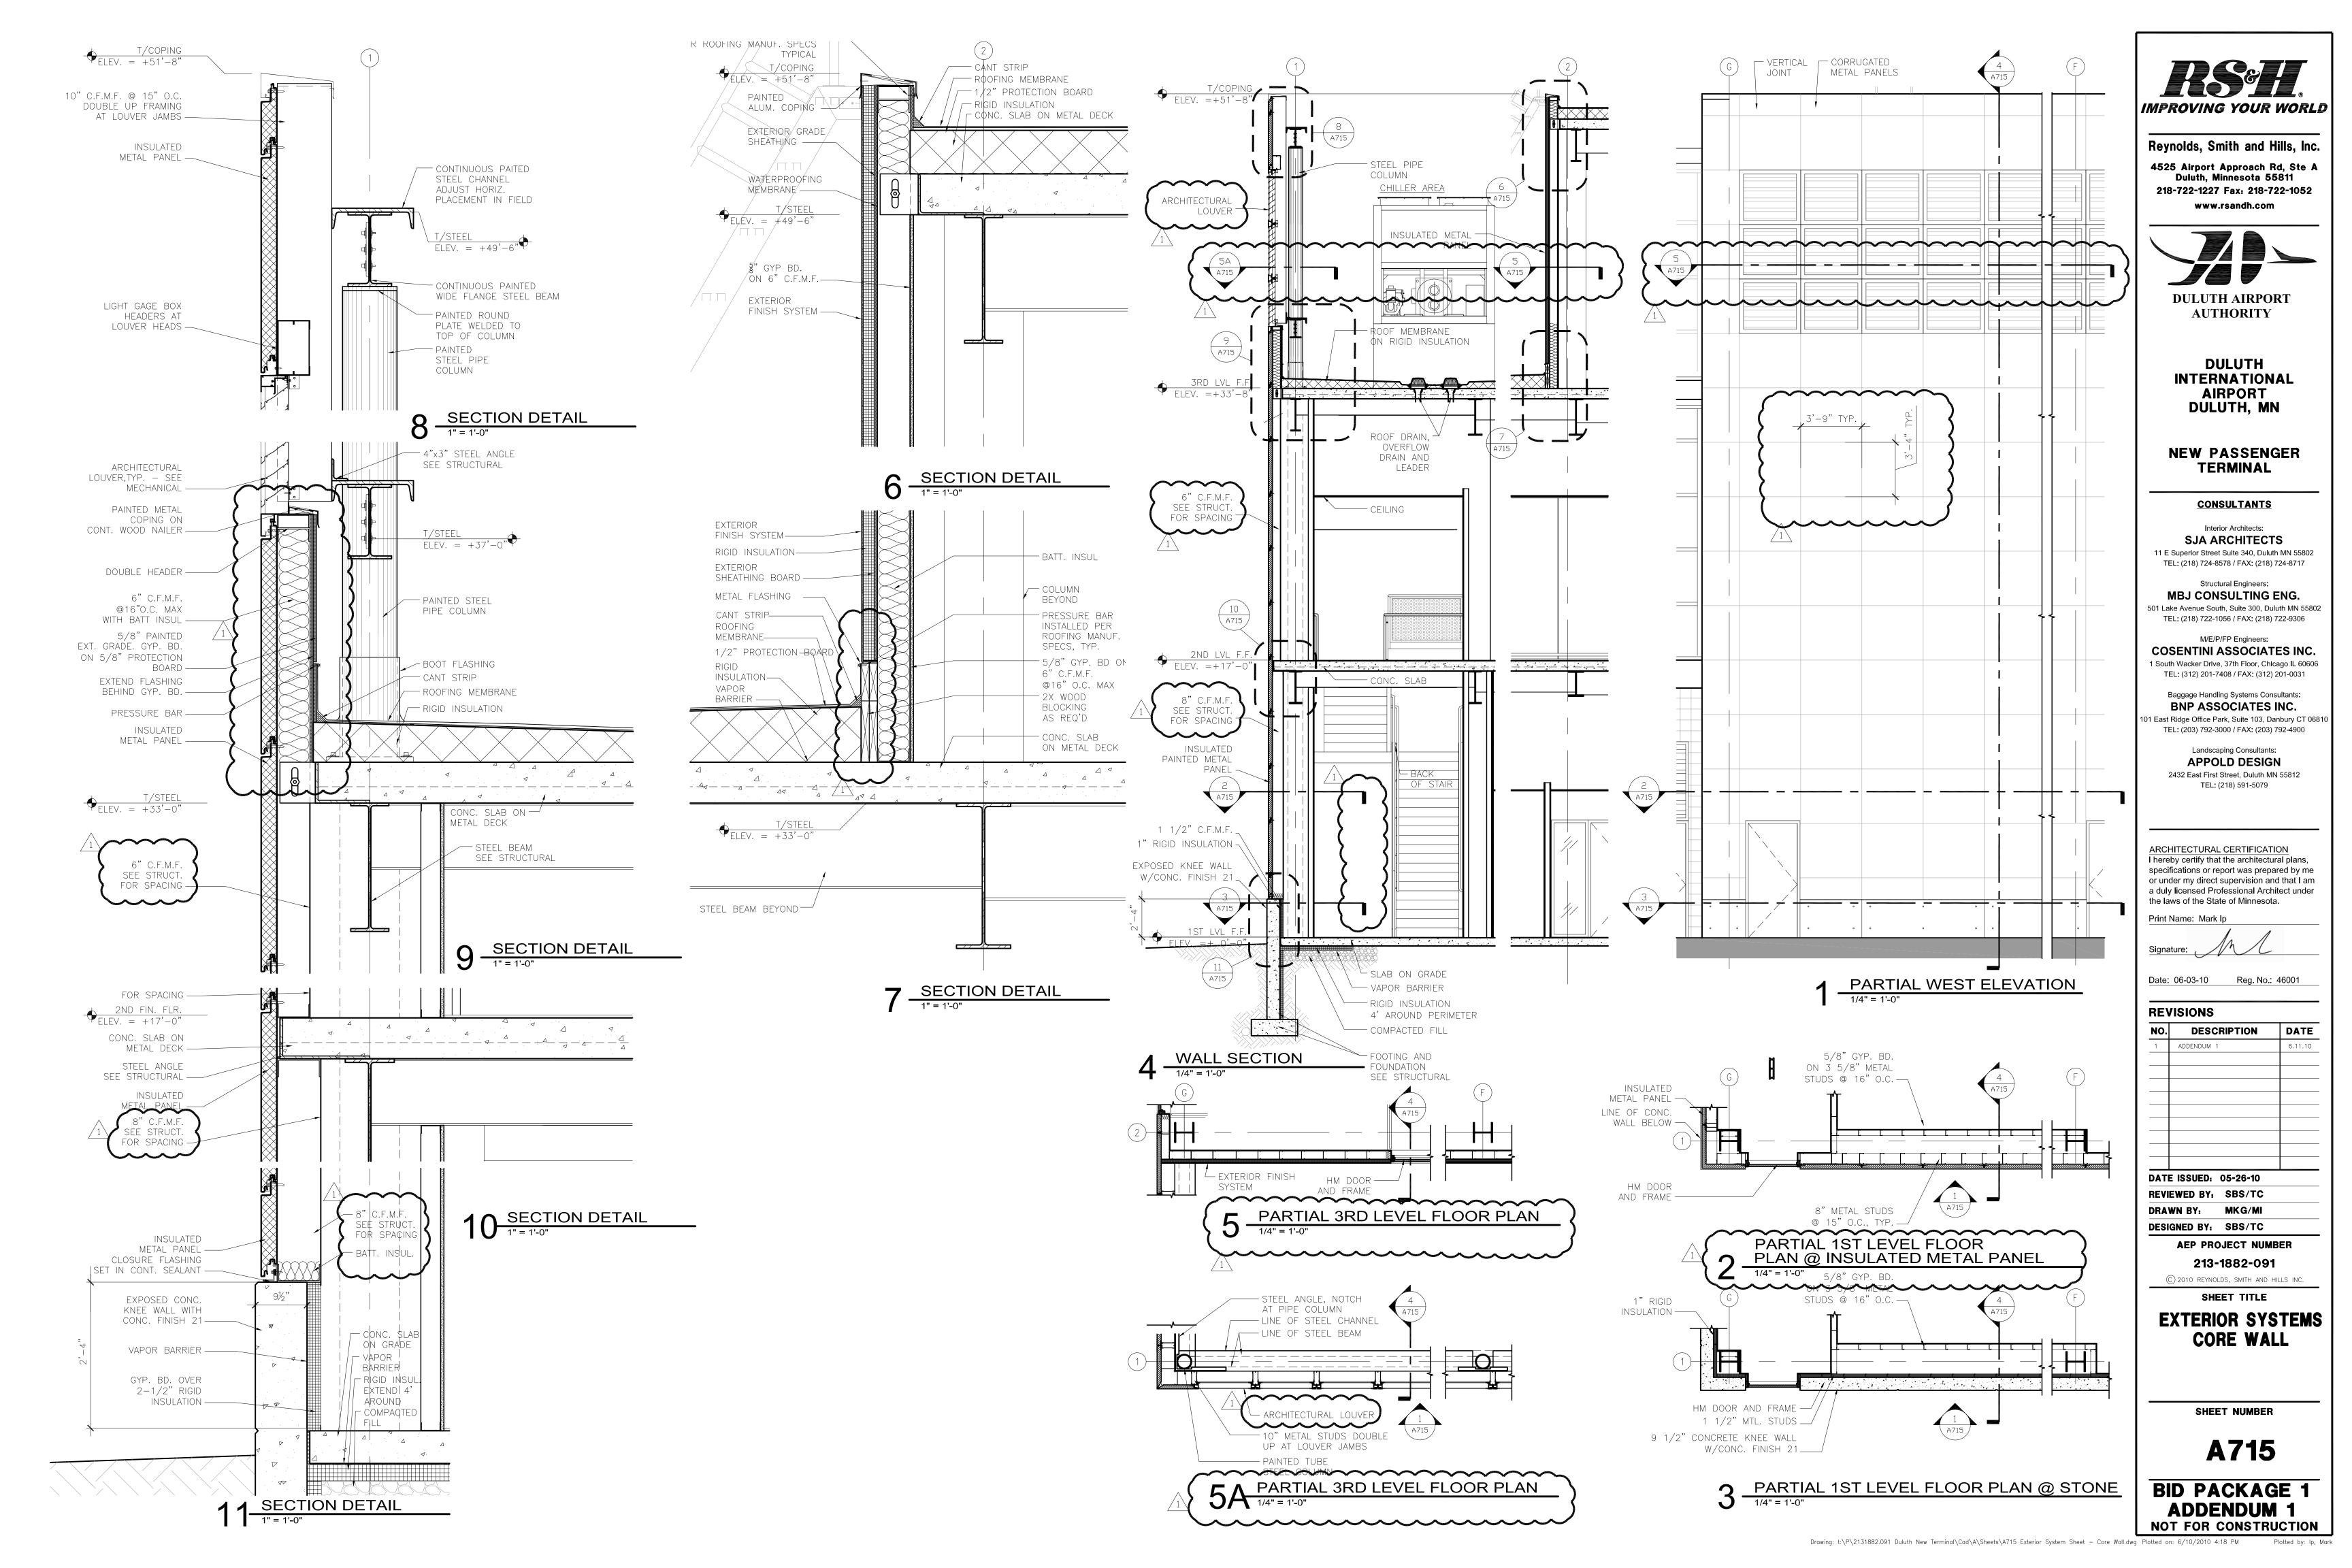
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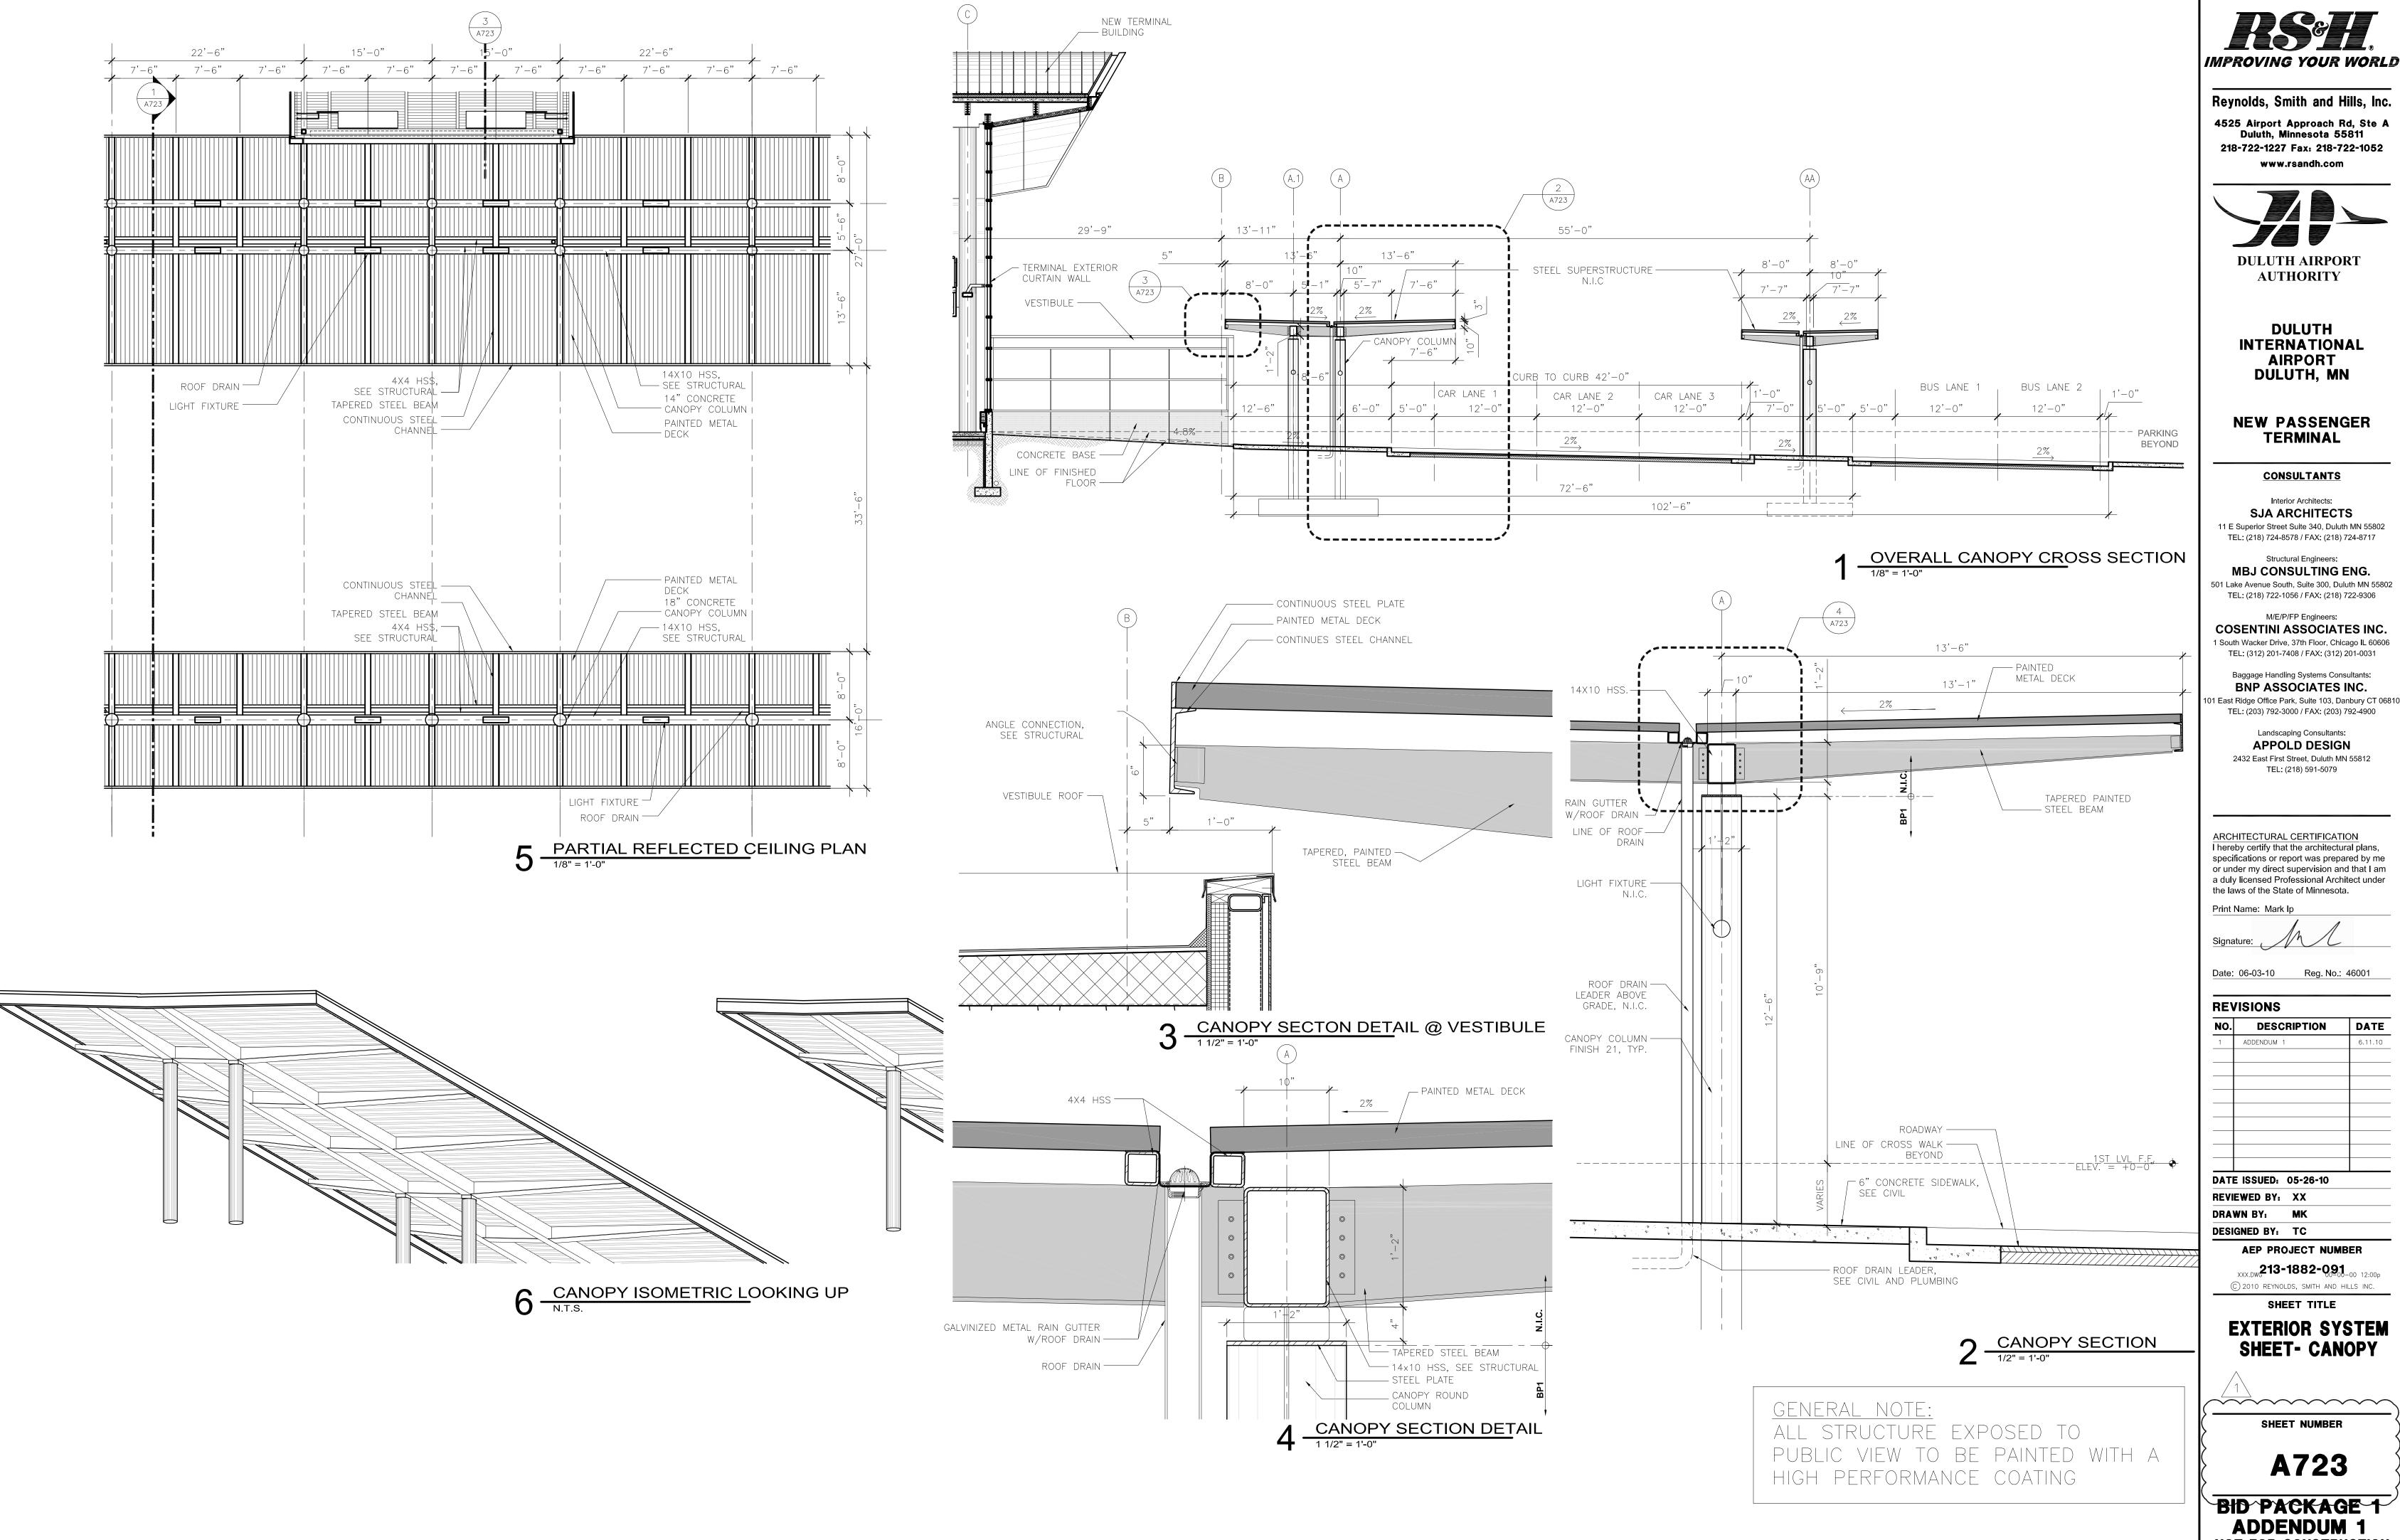
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EXTERIOR SYSTEMS ENTRY VESTIBULE

SHEET NUMBER

A714





NOT FOR CONSTRUCTION

Drawing: t:\P\2131882.091 Duluth New Terminal\Cad\A\Sheets\A723 Exterior System Sheet - Canopy.dwg Plotted on: 6/10/2010 4:26 PM

The contractor shall verify all dimensions and existing conditions in the field that affect construction prior to commencing work on the affected element or shop drawing submittals. Resolve any discrepancies with the architect prior to construction.

The contract structural drawings and specifications represent the completed structure. The contractor is responsible for bracing and shoring (without overstressing) all structural elements as necessary at any stage of construction until completion of the project. The Structural Engineer is not responsible for the contractor's means, methods, sequences or procedures of construction. Contractor shall recognize and consider effects of thermal movements of structural elements during construction period.

The contractor is solely responsible for site safety including all temporary precautionary measures and safety programs. Site observation visits by the Structural Engineer do not include review of the contractor's safety precautions.

Refer to architectural, mechanical and electrical drawings for locations, elevations, dimensions, and details of sleeves, inserts, openings, recesses, curbs, housekeeping pads, etc. that are not shown on the structural drawings and do not damage structural members.

Information shown in the structural drawings regarding existing conditions represents the current and general field conditions related to the new work, to the best of our knowledge. Report all discrepancies to the Architect for resolution prior to performing related new work.

Requests for information shall be submitted in writing and shall reference the part of the construction

documents that is in question.

Contractor shall read and understand their duties in the specification and under the building code for special inspections and coordinate as necessary the owner's responsibilities.

The special inspectors shall be provided and shall only use approved shop drawings.

Special inspection reports are to be submitted immediately to the SER, Architect, and Contractor daily when inspections are performed.

The general contractor shall provide timely notice to the special inspector and sufficient time for the inspector to perform their inspection

SHOP DRAWINGS

All engineering design provided by others and submitted for review shall bear the certification stamp and signature of a qualified professional engineer who is licensed in the state of Minnesota.

Submit shop drawing schedule with construction schedule that includes consideration for review period. See specification for additional information.

DEFERRED SUBMITTALS: The following items shall be issued as deferred submittals per IBC:

Steel Connections Light gage metal framing

All items issued as deferred submittals shall be issued a minimum of 30 days prior to installation and shall not be installed until their design and submittal documents have been reviewed for general conformance to the drawings by the general contractor, the engineer of record and the building official. A copy of the deferred submittal shall be forwarded to the city after the engineer of record has reviewed the documents and prior to erection of the deferred submittal items.

DESIGN CODES AND STANDARDS: Minnesota State Building Code, MSBC 2007

2006 International Building Code, as amended and adopted by the MSBC 2007

ACI 318-05 Building Code Requirements for Reinforced Concrete

ACI 530-05 Building Code Requirements for Masonry Structures, Allowable Stress Design

ACI 530.1-05 Masonry Structures

AISC 360-05 Specification for Structural Steel Buildings

AISI NAS-01 North American Specification for the design of Cold-Formed Steel Structural Members including 2004 supplement.

ASCE 7-05 Minimum design loads for buildings and other structures including supplement NO. 1 and excluding Chapter 14 and Appendix 11A.

ASCE 3-01 Structural Design of Composite Slabs

MATERIAL PROPERTIES: Reinforcing Steel (Fy):

Controlled Low

ATSM A615 Grade 60 60,000 psi Weldable ASTM A706 Grade 60 60,000 psi

1.200 psi (at 5 days) Maximum

Minimum

ASTM A53

ASTM A572 or A36 as indicated

Cast-in-Place Concrete (f'c) at 28 days, UNO:

Strength Material (CLSM)	500 psi (at 5 days)
Footings	4,000 psi
Piers and Walls	4,000 psi
Columns	4,000 psi
Concrete placed over Metal Floor Deck	4,000 psi
Slabs on Grade	4,000 psi
Exterior Concrete	4,000 psi
Masonry Corefill Concrete	3,000 psi
All Concrete not otherwise noted	4,000 psi

Concrete Masonry- Prism (f'm): Typical Units:

Grade B Steel Pipe

Plates, Bars

Structural Steel (Fy): Wide Flanges 50,000 psi ASTM A992 Angles, Channels 36.000 psi ASTM A36 46,000 psi ASTM A500 Grade B Rectangular HSS Grade B Round HSS 42,000 psi ASTM A500

2,000 psi

35,000 psi

50,000 psi Structural Fasteners: ASTM A325 Typical High-Strength Bolts 92,000 psi ASTM A490 High-Strength Bolts as noted on plan 150,000 psi A STM E1554

Grade 30 Andrior Rous, UNO	30,000 psi	A31101 F 1334
Threaded Rods	36,000 psi	ASTM A36
Direct -Tension Indicator Washers	as noted on plan	ASTM F959
old-formed Light Gauge Metal Framing (Fy	y):	

Studs, Joists, Braces-16 ga. and heavier 50,000 psi ASTM A653 Studs, Joists, Braces-18 ga. and lighter 33,000 psi ASTM A653 33,000 psi Track, Channels and Accessories ASTM A653 **DESIGN LOADS:** Primary Frame Wind Data: Basic Wind Speed: Wind Importance Factor: 1.15 Exposure:

Primary Seismic Data: No design required

Component Loads: Exterior Component/Cladding: Supplier to develop based on MSBC 2007 and to indicate on shop drawings.

GRAVITY LOADS: Roof Snow Load:

```
Ground Snow Load, Pg:
                                       60 psf
                                       46 psf
Flat-Roof Snow Load, Pf:
Snow Exposure Factor, Ce:
                                       0.70
Snow Load Importance Factor, I:
Unbalanced/Drift Snow Load:
                                       As required by ASCE 7
```

Floor Loads:

100 psf (not reducible) Live Load: Hanging loads at underside of 2nd floor: 40 psf superimposed Stairs, Corridors and Lobbies: 100 psf (not reducible) Stair Tread Concentrated Load: 300 lbs

Mechanical Rooms: Exterior Site Surcharge Loads: Fire Trucks:

Sidewalk:

250 psf 250 psf North terminal retaining wall and north

HS20-44 axle load as defined by IBC 2006 table 1607.6 at a tug tunnel retaining wall: distance of 5 feet from the north wall edge. Provisions For Future Expansion:

150 psf (not reducible)

Design for additional 30' bay (3 story) between grids "E" and "G", east of grid 12 and west of grid 1. Design for one story expansion of 3rd floor office space north of grid "G".

Refer to Geotechnical report number AET #07-04216.2 by American Engineering Testing, Inc., dated October 14, 2009 and the subsequent addendum (AET project #07-04216.3) dated January 29, 2010.

The contractor shall verify the location of all existing and new underground utilities and tanks prior to beginning excavation and contact Gopher State One Call.

The minimum dimension from exterior grade to bottom of footing and foundation shall be 72" in unheated areas.

For underground utilities adjacent to foundations and through foundations reference drawings for detail showing step footings below utilities as required to avoid undermining of structure by utilities.

See geotechnical report for water table elevations. Contractor to make adequate provisions for dewatering as

Footings are designed for a maximum allowable soil bearing pressure of 8000 pounds per square foot on undisturbed native soil or lean mix concrete/controlled low strength material fill. Soil bearing pressure is to be verified in the field during construction by a qualified Geotechnical Engineer.

All topsoil, fill, organic swamp deposits, and/or other unsuitable bearing material shall be removed below the footings and/or within the building area to the depths indicated in the geotechnical engineering report and extent of removal shall be field verified by the Geotechnical Engineer.

All excavations shall be observed by a qualified geotechnical engineer to verify removal of unsuitable material and

confirm the proper preparation of bearing conditions. For footings that do not bear on natural undisturbed soil, extend engineered fill laterally beyond bottom edge of footing

for a distance equal to the depth of engineered fill. Reference drawings for details. Foundation and retaining walls shall be back filled with free draining fill approved by the Geotechnical Engineer.

Provide drain tile required by the contract documents and verify with architect and civil engineer.

Backfill equally on both sides of foundation walls to prevent overturning or lateral wall movement, or temporarily brace as necessary until permanent bracing elements are complete and cured to design strength.

All temporary bracing, cribbing, shoring or underpinning not fully designed or detailed on these drawings shall be designed by a licensed specialty engineer engaged directly by the contractor.

For stepping of wall footings reference drawings for detail.

REINFORCED CONCRETE

The detailing, fabrication and erection of all reinforcing shall be done in accordance with the latest edition of ACI-315, "Manual of Standard Practice for Detailing Reinforced Concrete Structures and ACI-318, "Building Code

All reinforcing bars are deformed and continuous, unless noted otherwise. Refer to drawings for reinforcing lap length schedule.

Provide suitable wire spacers, chairs, etc. for support of reinforcing steel in proper position while placing concrete. All bars shall be tied to prevent displacement while placing concrete. All chairs and slab bolsters shall be plastic or steel with plastic tips. When reinforcing steel is epoxy coated or p/t tendons are fully encapsulated, all chairs and slab bolsters shall be epoxy coated or plastic and all support bars shall be epoxy coated. Chairs are to be stable and resist tipping. Acceptable products are GTI or approved equal.

The fabricator shall submit a complete list of accessories and placing details with the shop drawings.

No horizontal construction joints shall be placed in beams, joists, or slabs, unless shown on drawings.

Refer to drawings and ACI 318 Chapter 6 for placement guidelines of embedded pipes, sleeves, and conduits. Conduits are not permitted in slabs 3 inches or less in thickness. The maximum size of conduits within any slab shall be 1 1/4" outside diameter and shall be spaced no closer (to each other or any reinforcing steel) than 4" unless prior approval is obtained from the structural engineer. Additional reinforcing steel and chairs may be

Locate vertical construction joints in beams and slabs at central one third of span. Refer to drawings for details.

Submit proposed construction joint locations to the Structural Engineer of Record for review prior to placement of concrete. Where new concrete is placed against existing concrete, the existing concrete shall be roughened to a

required to support embedded conduit. All conduit shall be placed in the middle 1/3 of the slab thickness above the metal deck, typical. Conduit may <u>not</u> be tied to parallel reinforcing steel. Conduit may <u>not</u> be paced in deck flutes. Conduit may not cross within slabs 5" or less in thickness. Conduit placement drawings may be required in areas of high conduit concentricity.

Provide a 3/4 inch chamfer for all exposed concrete corners. See Architectural drawings for details and additional

The general contractor shall notify the Special Inspector a sufficient period in advance of placing concrete to allow required inspections and testing to occur in a timely fashion.

Formwork and all shoring for flatwork shall be left in place until the concrete reaches at least 75 percent of the 28day compressive strength. Design of shoring and reshoring is the responsibility of the contractor and shall conform

Aluminum conduit, aluminum sleeves and aluminum embeds are not permitted in concrete.

Exterior concrete to have 6% +/- 1% entrained air.

Calcium chloride is not permitted as a concrete additive

Concrete Cover on Reinforcing:

Topping Slab: 3/4" clear top. See drawings for cover at composite slabs Slab on Grade: 3" bottom

Footings: 3" clear bottom and sides

2" clear top Walls: #5 and smaller 1 1/2" clear earth or weather face #6 and greater 2" clear earth or weather face

3/4" interior face Columns and Beams: 1 1/2" clear to ties or stirrups CONCRETE SLABS ON GRADE: Slabs on grade shall be place in lane fashion.

The control or construction joints shall be placed as shown on the drawings. The joints shall align with the column grids and be spaced as noted below:

Exterior slabs 24 times slab thickness, maximum; Interior slabs 36 times slab thickness maximum: Interior slabs 48 times slab thickness, maximum, with carpeting

The panels formed by control or construction joints shall not be "L" shaped and a rectangular panel's aspect ratio shall not exceed 1.5.

Refer to the drawings for the typical slab on grade construction and saw cut control joint detail. Control and construction joints must be continuous and not offset.

Refer to drawings for detail of isolation diamonds or circles at columns.

Refer to drawings for reinforcing at re-entrant corners. Bend bars as necessary at obstructions.

Refer to the specification for the existence, type, and thickness of interior ground vapor retarder. Locate a vapor retarder directly beneath the slab on grade on top of a 6 inch compactable granular base. Refer to the specification for requirements for the compactable granular base.

Mechanically vibrate concrete around trench drains, floor ducts, construction joint dowels, loading docks, architectural features and other embedded items.

Refer to the specification for slab on grade pre-placement meeting.

Refer to the specification for acceptable methods of curing the concrete.

Refer to flooring manufacturer's specification for levelness, flatness and curing of concrete slabs on grade to receive special architectural floor finishes.

REINFORCED MASONRY: All masonry units are placed in running bond fashion. Corners shall have a standard bond by overlapping units.

Special shapes shall be provided for jambs, columns, pilasters, control joints, corners, and lintels.

All masonry walls shall have horizontal joint reinforcing spaced at 16" o.c. Horizontal joint reinforcing shall be truss style and fabricated with galvanized nine-gauge wire and shall include corner and intersecting wall pieces. Provide minimum 6" laps at all splices.

Vertical reinforcing shall be held in place by rebar positioners, crossties, chairs, or tying to every other layer of horizontal reinforcing steel. Refer to the detail in the drawings for vertical reinforcing bar location in a core.

Refer to detail in the drawings for reinforcing bar lap lengths.

Provide concrete cover of minimum 1/2" to face shell.

Extend vertical reinforcing from footings to 2" clear top of wall or to beam bearing. Extend vertical reinforcing into the next level of construction and lap in accordance with the lap schedule.

When typical vertical wall reinforcing is interrupted by long wall openings, provide typical vertical wall reinforcing above and below opening, and extend into horizontal bond beams. Refer to the schedule on the drawings, for masonry wall opening lintels. Refer to the detail in the drawings for masonry openings minimum jamb reinforcing.

Provide vertical reinforcing at the ends of walls and at wall intersections to match specified reinforcing. Run reinforcing full height of walls.

All masonry units shall be placed with full face shell mortar coverage on horizontal and vertical face shells. Webs shall also have full mortar coverage around all grouted cells.

Fill block core at vertical reinforcing (8" minimum length along wall) with concrete grout. Filling cores with mortar is not allowed. Vibrate in place. Rodding and puddling are not allowed.

Maximum lift height is four feet. For concrete core fill pour height up to maximum 8'-0", provide cleanouts if pour height exceeds 5'-0".

Masonry cement mortar is not allowed.

Calcium chloride or admixtures containing chloride shall not be used in mortar or grout.

For reinforced masonry bond beams, provide bent corner bars at corners and intersections that match reinforcing. Step bond beams as necessary to match roof slopes. Lap reinforcing bars per schedule.

For construction of masonry control joints refer to detail in drawings.

Unless noted otherwise on the drawings place control joints in masonry walls such that no straight run of wall exceeds 24'-0" and within 4'-0" of corners. Do not place control joints within 48 inches of a masonry opening jamb or

Place bond beam reinforcing continuously through control joints. Do not splice bond beam reinforcing within 6'-0" of a control joint.

Provide bond beam with reinforcing at all floor lines, roof lines, and top of walls. Refer to details in the drawings.

Grout below steel bearing plate and refer to the drawings for additional information. Refer to drawings for reinforcing schedule, top of wall bracing, thickened bearing slab and lintel schedule for non-

MASONRY BEAMS (HIGH-LOW BOND BEAMS):

For all masonry beams use lintel blocks. Masonry beams are to bear 8" minimum at jambs. Extend vertical reinforcing through masonry beam bearing.

Extend horizontal reinforcing full length.

Grout masonry beams solid. Mechanically vibrate grout in place.

bearing masonry walls. Refer to Architectural drawings for location and extent.

EXPANSION AND ADHESIVE ANCHORS: Anchors in concrete or concrete masonry when not exposed to earth, weather, or corrosive environment

and zinc plated in accordance with ASTM B633.

Expansion anchors shall be stud type with a single piece three section wedge

Types I, II, IV, and V, Grade 3, Classes B and C as noted on plans.

Threaded anchor rod for adhesive anchors in concrete shall be ASTM A193. Grade B7. or ASTM A36, as noted in the drawings. The adhesive used for anchors shall be a structural grade, two part epoxy or acrylic material that meets the requirement of ASTM C-881

Holes shall be drilled with a bit and cleaned using a method that complies with the manufacturer's guidelines, and specifications. Do not cut or damage reinforcing steel or P-T tendons.

Upon the request of the structural engineer the anchors shall be proof tested by the manufacturer to verify capacity of anchors that do not meet the conditions in the construction documents.

Minimum embedment depths in concrete and concrete masonry for expansion and adhesive anchors shall be as noted below:

For 1/2", 5/8", and 3/4" diameter expansion anchors provide 4 3/4" embed, UNO on plan.

For 1/2" and 5/8" diameter adhesive anchors provide 5" embed. For 3/4" diameter adhesive anchors provide 7" embed, UNO on plan.

Grouted solid concrete masonry unit material: For 1/2", 5/8", and 3/4" diameter expansion anchors provide 4 3/4"embed, UNO on plan.

For adhesive anchors refer to the product's ICBO Report.

Pre-approved manufacturer are as follows: HILTI, ITWR Ramset/Redhead, Powers Fasteners, and Simpson Strong-Tie. For review of alternate products, submit manufacture's product data and product's current ICBO report prior to construction.

Anchors in concrete or concrete masonry when exposed to earth, weather, or corrosive environment shall be manufactured from AISI 304/316 Stainless Steel.

Structural steel shall be detailed, fabricated and erected in compliance with AISC Specification for the design, fabrication, erection of structural steel for building, and Code of standard practice, and OSHA steel erection standards.

All beams and girders shall be cambered at mid-span as indicated on the structural drawings. The cambers indicated shall be present in the beam in its erected position after completion of the end connections and shall be verified prior to placing concrete. Cambering tolerances shall be (-0", +1/4"). No center point cambering allowed.

Splicing structural members where not detailed on the drawings is prohibited without prior approval of the

Modification of structural steel members in the field is not allowed without written approval by the structural

All composite beams using the concrete slab as a compression flange are designed for unshored construction unless noted otherwise.

Anchor rods shall be minimum 3/4" diameter or as detailed in drawings.

All steel connections shall be designed by the steel fabricator for the criteria indicated on the drawings unless noted or detailed otherwise. Connection design shall conform to the requirements of the AISC Specifications for the design, fabrication, erection of structural and OSHA regulations. Submit calculations certified by a Professional Engineer who is licensed in the state of Minnesota. All loads indicated on the drawings are unfactored, working loads.

Non-composite beams: Unless noted otherwise, design simple beam shear connections per the AISC Manual connection tables. The required end reaction shall be based on the reactions indicated on the plans. Design connections for the reactions indicated on plan or for the minimum connection requirements indicated in the Connection Schedule, whichever provides the greater capacity.

Composite beams: Design simple composite beam shear connections per the AISC Manual connection tables UNO. Design connections for the reactions indicated on the plans or the minimum connection requirements indicated in the Connection Schedule, whichever provides the greater capacity.

Unless detailed otherwise, beam shop connections may be welded or bolted and field connections are to be bolted. Bolts shall be a minimum 3/4" diameter for connections specified or detailed in the drawings. The fabricator may submit an alternate connection with the calculations that is certified by a professional engineer

All beam web copes must be made to a 1 inch minimum radius.

Welded connections shall be made in accordance with ANSI/AWS D1.1 Structural Welding Code using E70XX electrodes unless noted otherwise. Weld sizes not shown or controlled by the required forces shall be AWS code minimum size. Welds shall be visually inspected for compliance with the AWS code visual inspection criteria. Welders shall be qualified in accordance with ANSI/AWS D1.1 and shall be experienced in weld in structural steel.

Full penetration welds shall be tested using NDT methods such as ultrasonic, magnetic particle or other methods referenced in the AWS code. Welds subject to NDT methods shall also have been found compliant with the AWS visual inspection criteria.

STRUCTURAL STEEL STAIRS: Structural steel stair stringers, components, railings, posts, hangers, and connections to be designed by the fabricator's Qualified Professional Engineer for the loads indicated in the specifications. Configuration of stringers and railings shall be as indicated on the architectural drawings. Channel stringers to have a minimum

STEEL ROOF DECK:

Manufacturer shall be a current member of the Steel Deck Institute (SDI). Detail, manufacture and install steel roof deck and accessories in accordance with the SDI specifications and

codes and OSHA requirements.

documents.

COMPOSITE STEEL FLOOR DECK:

12" depth and a minimum 1 1/2" flange width.

Steel roof deck shall be as noted on plan. Welding shall be in accordance with AWS D1.3. Welders shall be qualified in accordance with AWS D1.3.

Where spray-on fireproofing of the deck is required, the contractor shall verify that the deck finish is compatible with the proposed fireproofing material to ensure proper bonding of the fireproofing. Coordinate fireproofing locations and requirements with the architect.

All steel deck shall span a minimum of three spans, unless otherwise approved by the engineer. Deck ends are to be lapped over supports.

Contractor shall verify the location and extent of acoustical steel deck with the architectural drawings. Reference drawings for detail on steel roof deck fastening requirements unless noted otherwise. Powder actuated or pneumatically driven fasteners are not allowed.

Provide reinforcement or frames for deck openings as indicated on the drawings.

LIMITATIONS ON M/E SUPPORT FROM PRIMARY STRUCTURE: All M/E systems shall be supported from the primary structural frame, unless noted otherwise. Do not connect to roof deck, floor slabs, or secondary members unless specifically allowed on the structural construction

All M/E support systems, hangers, brackets and connections to the primary structural frame shall be designed, provided and installed by the M/E contractor, unless noted otherwise on the structural construction documents.

All M/E supports and connections for loads in excess of 300 lbs shall be designed by a structural engineer licensed in the state of Minnesota and engaged by the M/E contractor.

Manufacturer shall be a current member of the Steel Deck Institute (SDI). Composite steel floor deck shall be as noted on plan.

Detail, manufacture and install composite steel floor deck and accessories in accordance with the SDI

specifications, codes and OSHA steel erection standards. Refer to drawings for composite steel floor deck fastening requirements unless noted otherwise. Powder actuated or pneumatically driven fasteners are not allowed.

Provide and install pour stops, column closures, end closures, cover plates and girder fillers and other accessories as required by the SDI unless otherwise indicated or detailed. Where spray-on fireproofing of the deck is required, the contractor shall verify that the deck finish is compatible

with the proposed fireproofing material to ensure proper bonding of the fireproofing. Coordinate fireproofing

locations and requirements with the architect.

Provide reinforcement or frames for deck openings as indicated on the drawings.

Do not cut control joints in structural slabs on metal deck.



Reynolds, Smith and Hills, Inc.

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DULUTH INTERNATIONAL **AIRPORT** DULUTH, MN

NEW TERMINAL DESIGN

CONSULTANTS

Interior Architects: SJA ARCHITECTS 11 E Superior Street Suite 340 Duluth MN 55802 TEL: (218) 724-8578 / FAX: (218) 724-8717

Structural Engineers: MBJ CONSULTING ENG. 501 Lake Avenue South, Suite 300, Duluth MN 55802 TEL: (218) 722-1056 / FAX: (218) 722-9306

M/E/P/FP Engineers: COSENTINI 1 East Wacker Drive, Suite 103, Chicago IL 60601

Baggage Handling Systems Consultants: BNP ASSOCIATES INC. 01 East Ridge Office Park, Suite 103, Danbury CT 06810

TEL: (312) 670-1800 / FAX: (312) 670-1801

TEL: (203) 792-3000 / FAX: (203) 792-4900

TEL: (218) 591-5079

Landscape Consultants: **APPOLD DESIGN** 2432 East First Street, Duluth MN 55812

I hereby certify that this plan, specification, or report was prepared by me or under my direct supervision and that I am a duly

laws of the State of Minnesota.

Print Name: Paul A. Johnson

licensed Professional Engineer under the

Date: June 3, 2010 Reg. No.: 20379

REVISIONS		
NO.	DESCRIPTION	DATE
1	Addendum 1	06-10-10

DATE ISSUED: 05-17-10

REVIEWED BY: PAJ / CWB

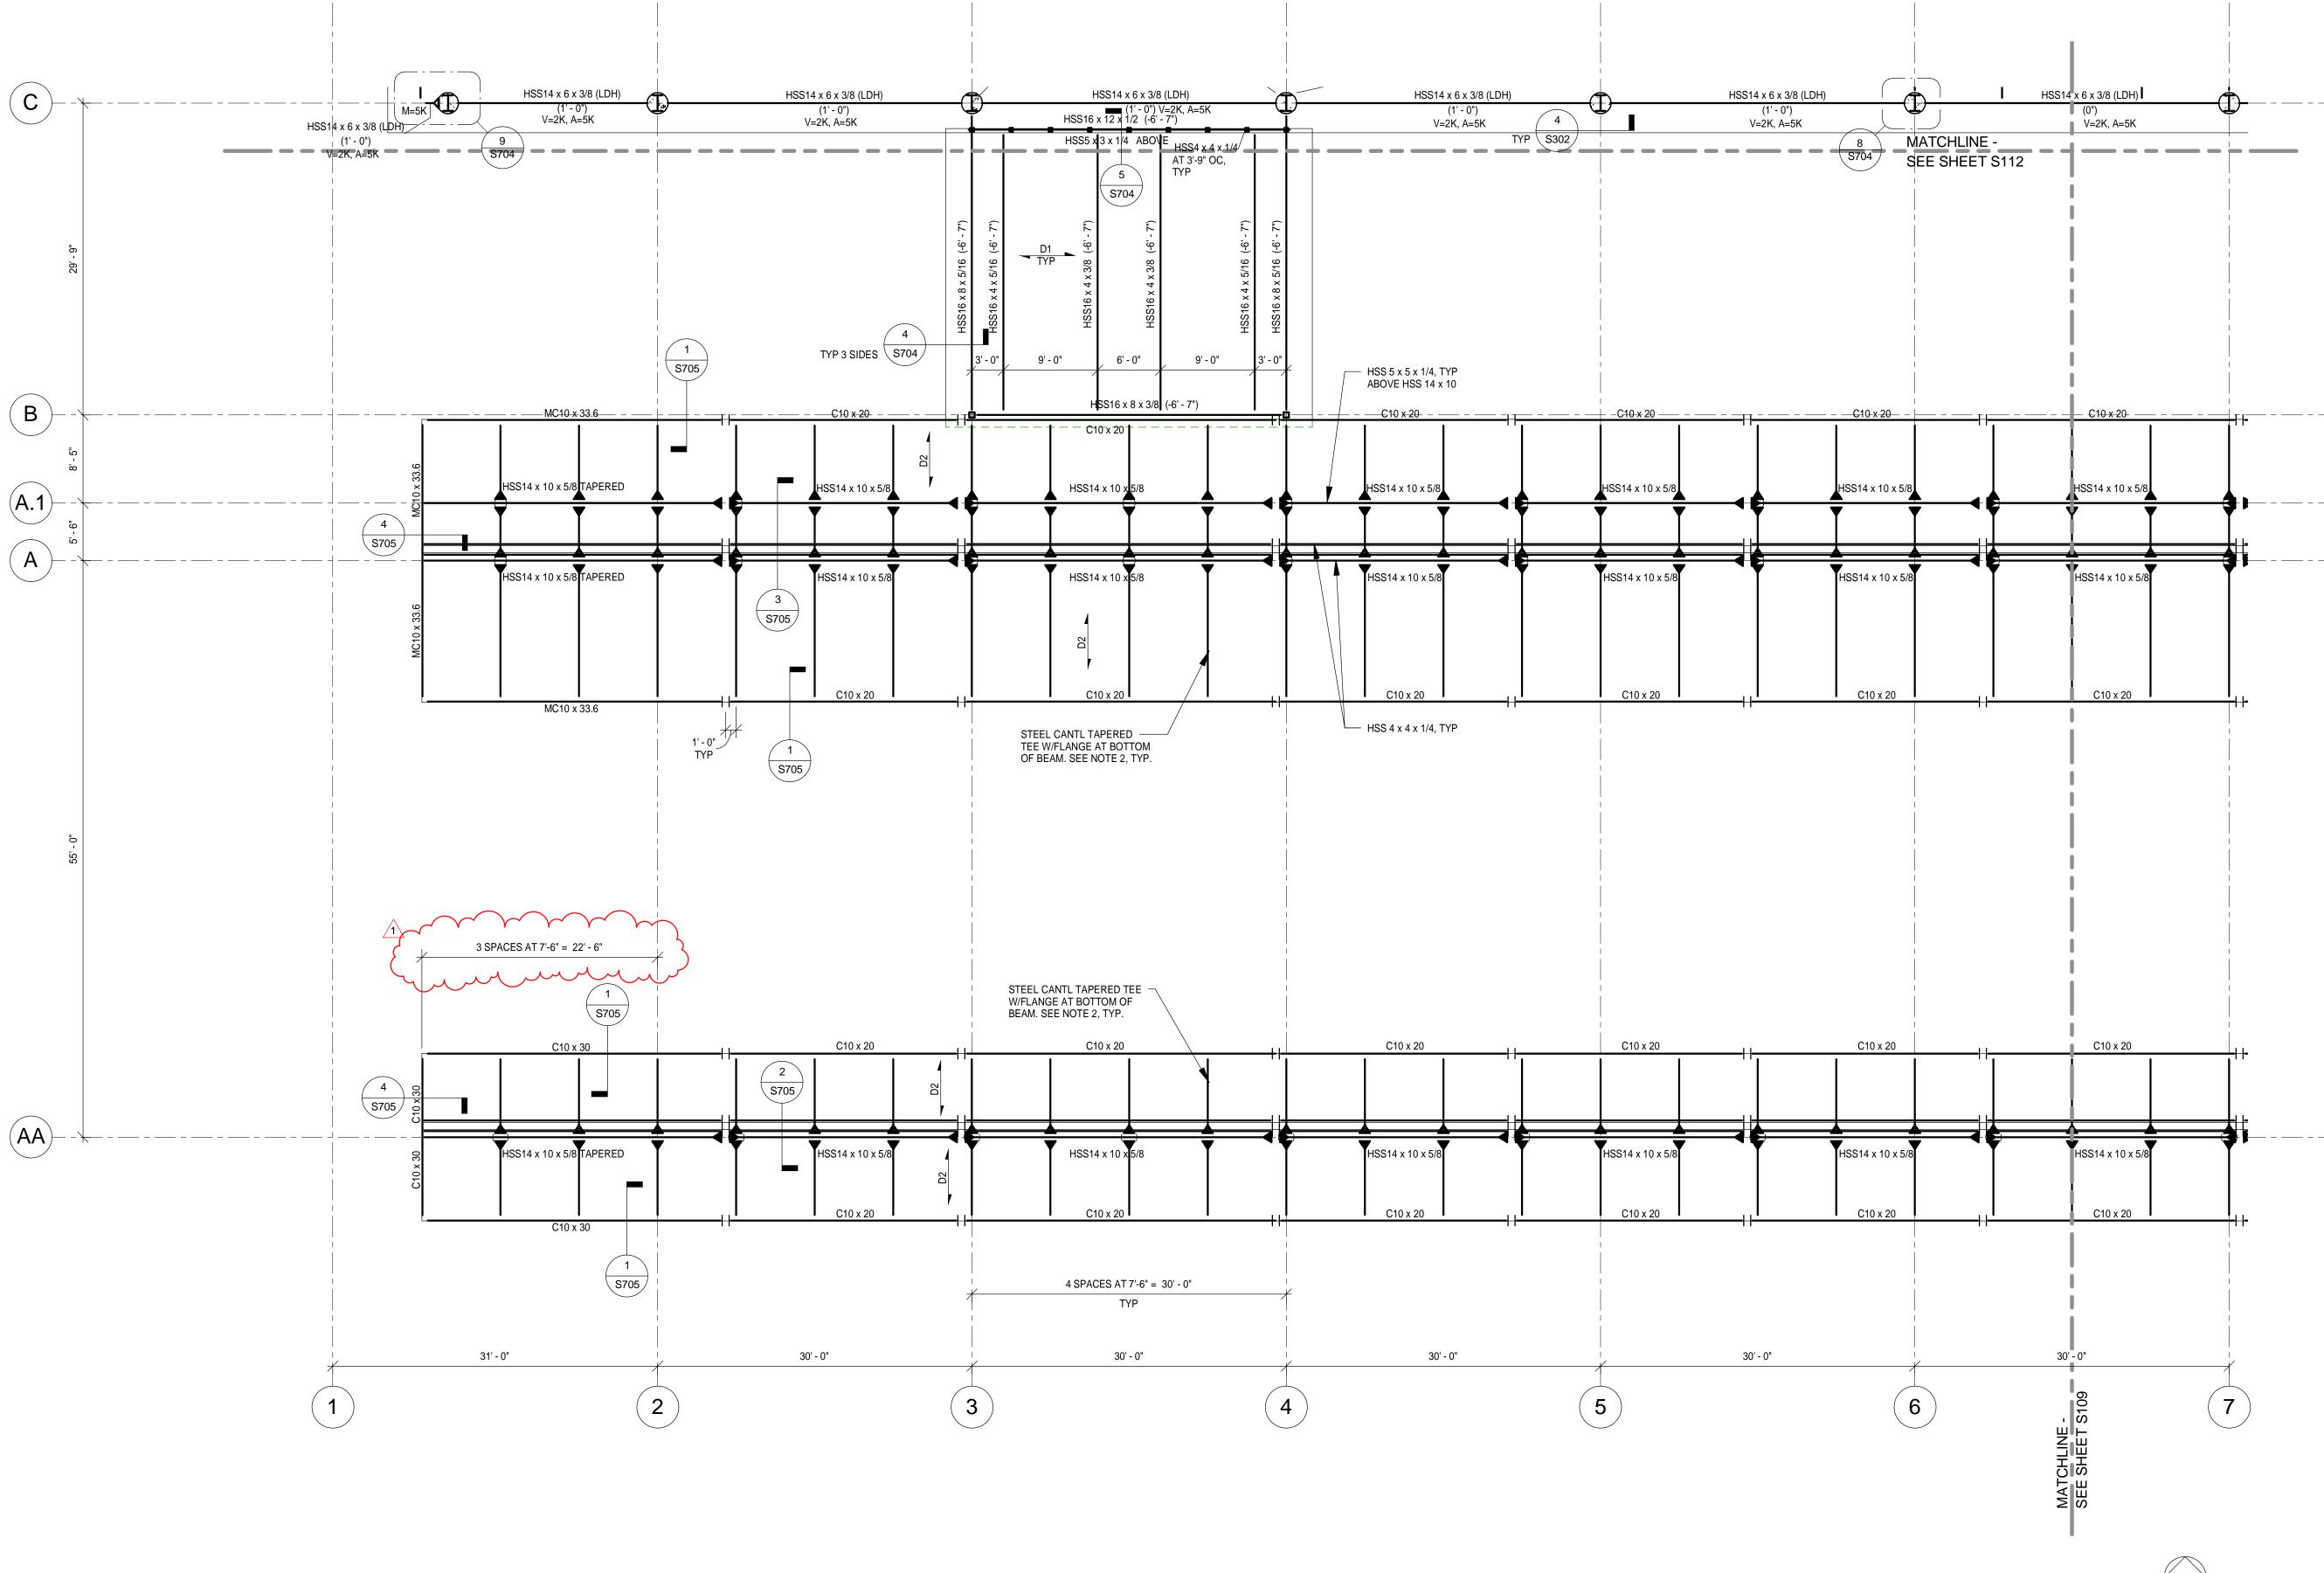
DRAWN BY: SJL **DESIGNED BY:** CWB AEP PROJECT NUMBER

213-1882-091 (C) 2009 REYNOLDS, SMITH AND HILLS INC SHEET TITLE **GENERAL**

SITE WORK AND

SHEET NUMBER

FNDN PERMI



CANOPY ROOF PLAN - AREA A

NORTH

NOTES:

1. REFER TO S115 FOR TYPICAL PLAN NOTES.

2. FABRICATOR TO PROVIDE SECTION (BUILT UP PLATE SECTION OR CUT WT OR CUT WIDE

FLANGE) WITH THE FOLLOWING DIMENSIONAL PROPERTIES: d max = 14"

d min = 6" bf = 12"

tf = 1 3/8" tw = 3/4" Fy = 50 ksi IMPROVING YOUR WORLD

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Print Name: Paul A. Johnson

Date: June 3, 2010 Reg. No.: 20379

NO.	DESCF	RIPTION	DATE
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DATE	E ISSUED:	05-17-10	
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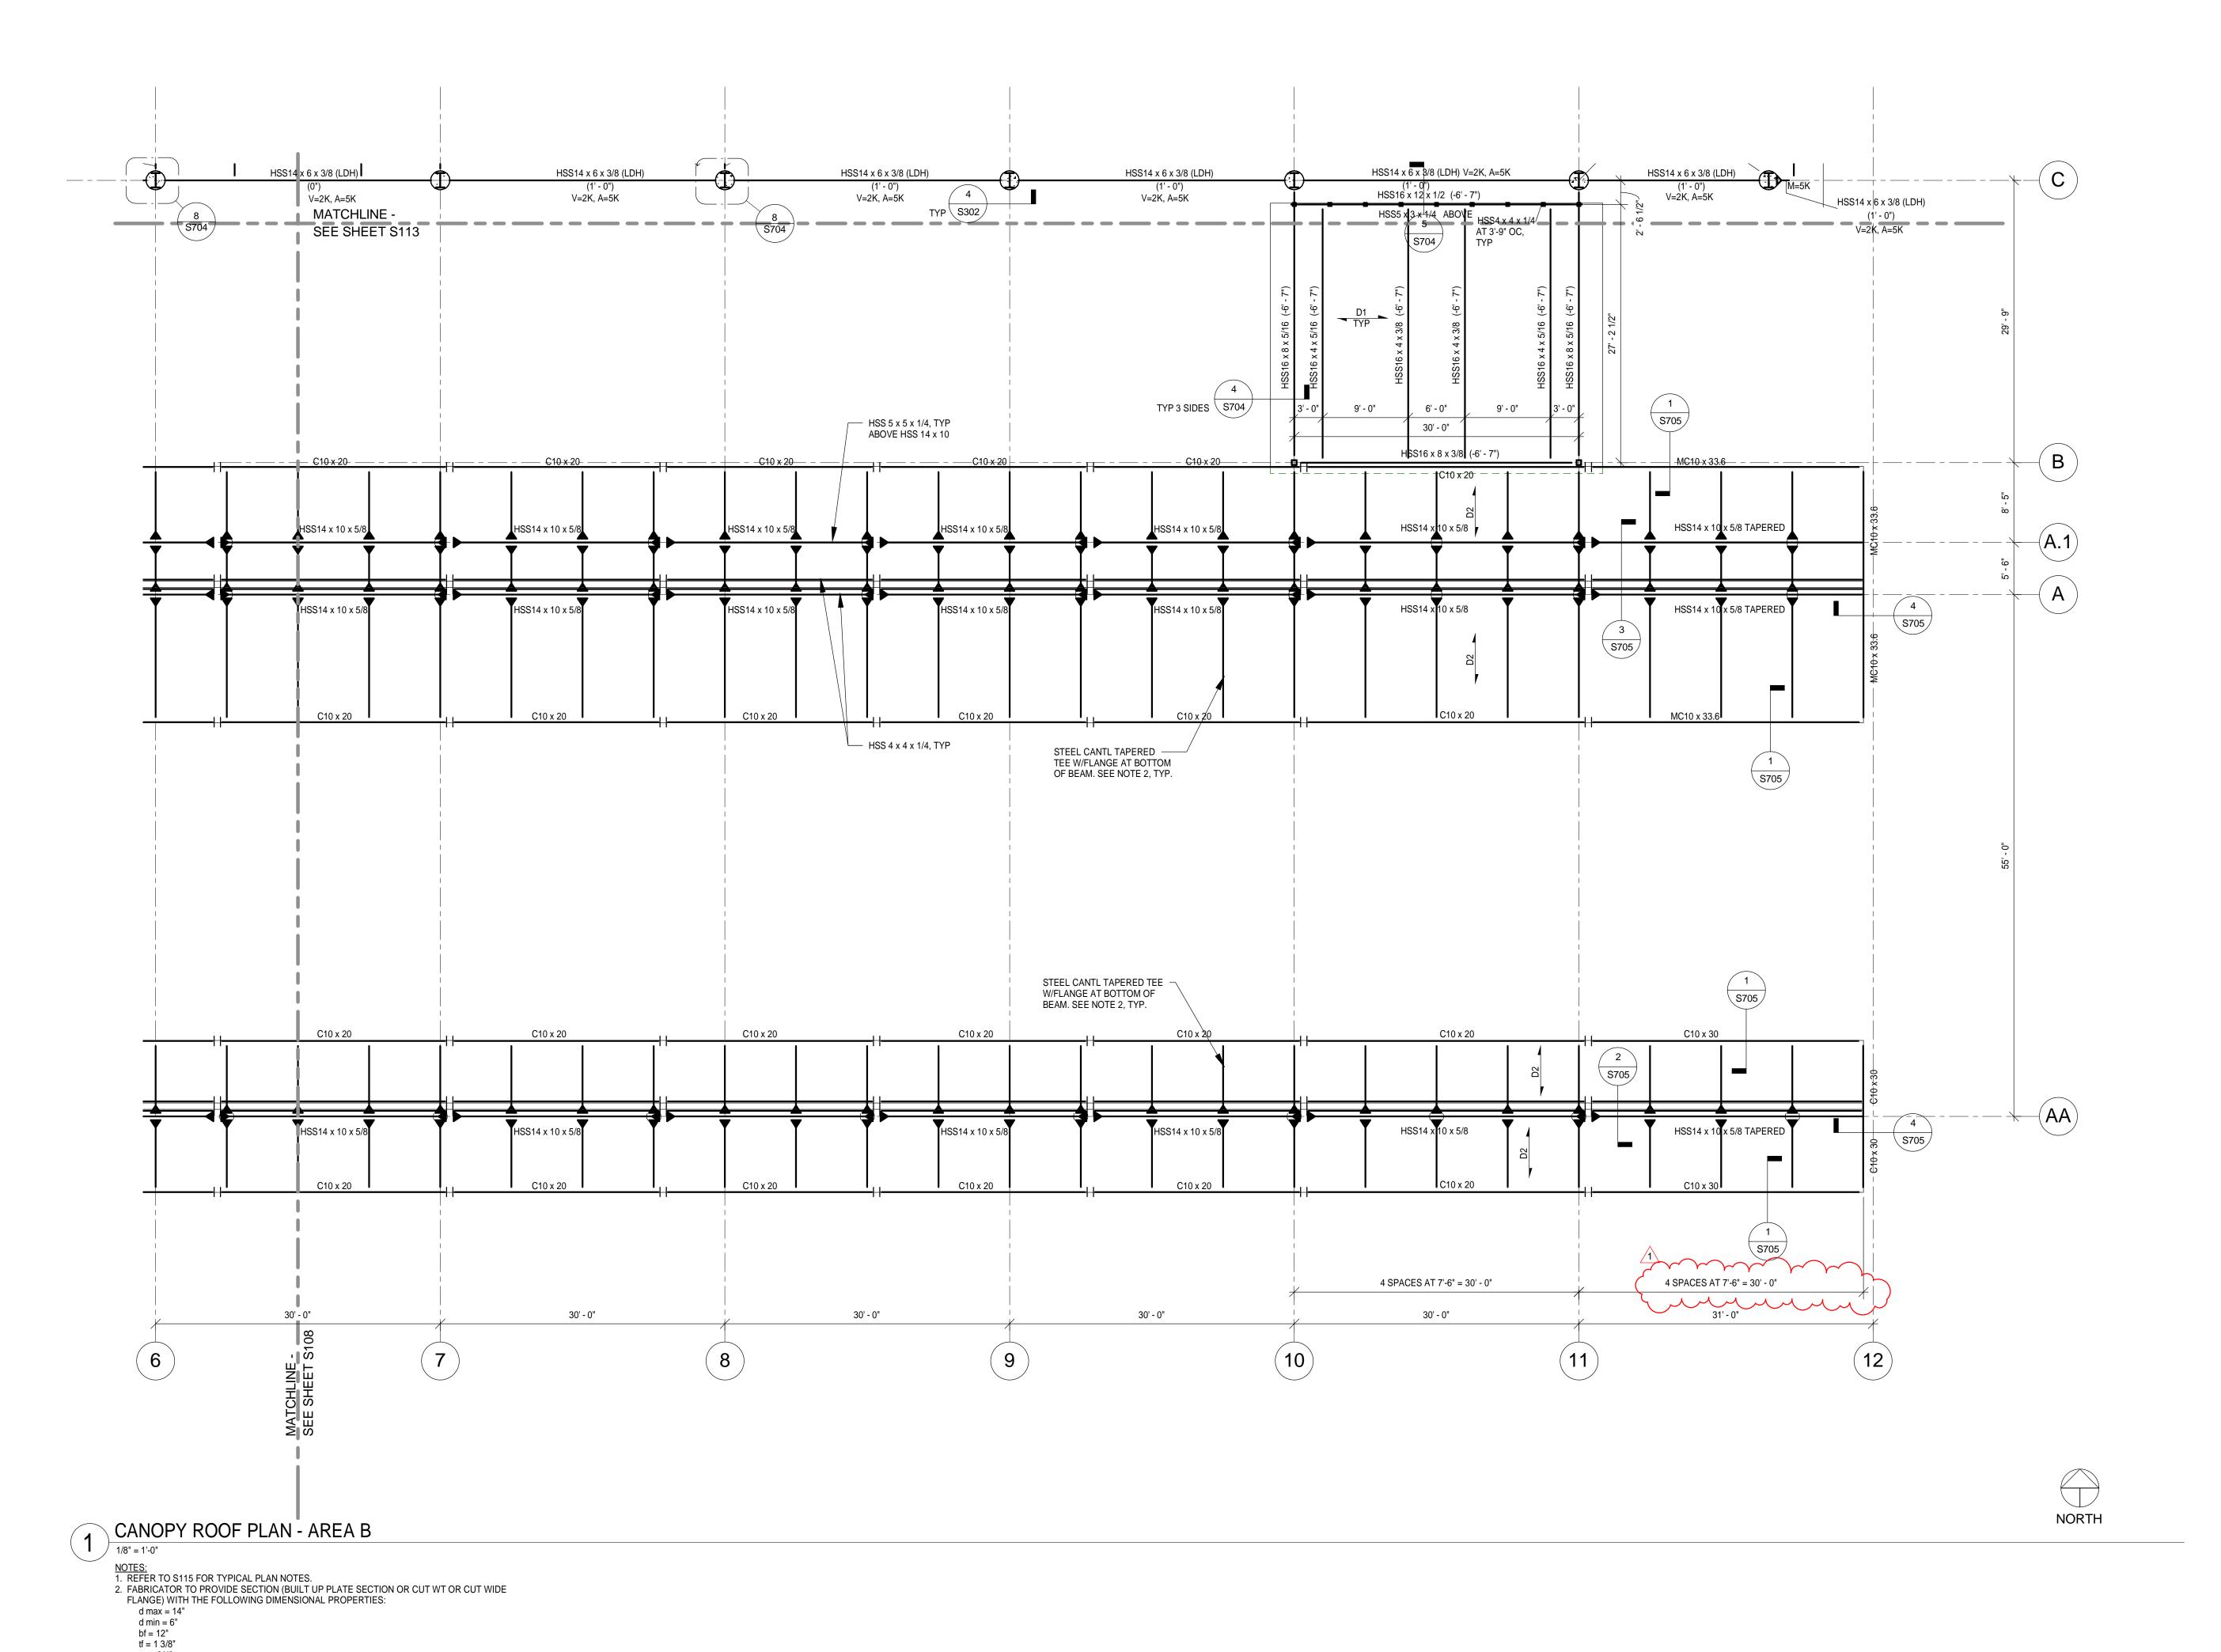
DRAWN BY: SJL **DESIGNED BY:** CWB

AEP PROJECT NUMBER

213-1882-091 C) 2009 REYNOLDS, SMITH AND HILLS INC

SHEET TITLE **CANOPY ROOF** FRAMING PLAN -**AREA A**

> SHEET NUMBER **S108**



tw = 3/4"

Fy = 50 ksi

ISSETT.

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DULUTH INTERNATIONAL AIRPORT DULUTH, MN

NEW TERMINAL DESIGN

CONSULTANTS

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Print Name:	Paul A. Johr
	11

Date: June 3, 2010 Reg. No.: 20379

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NO.	DESCRIPTION	DATE

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DRAWN BY:		SJL	
DESIGNED BY:		CWB	


AEP PROJECT NUMBER

213-1882-091

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CANOPY ROOF FRAMING PLAN -AREA B

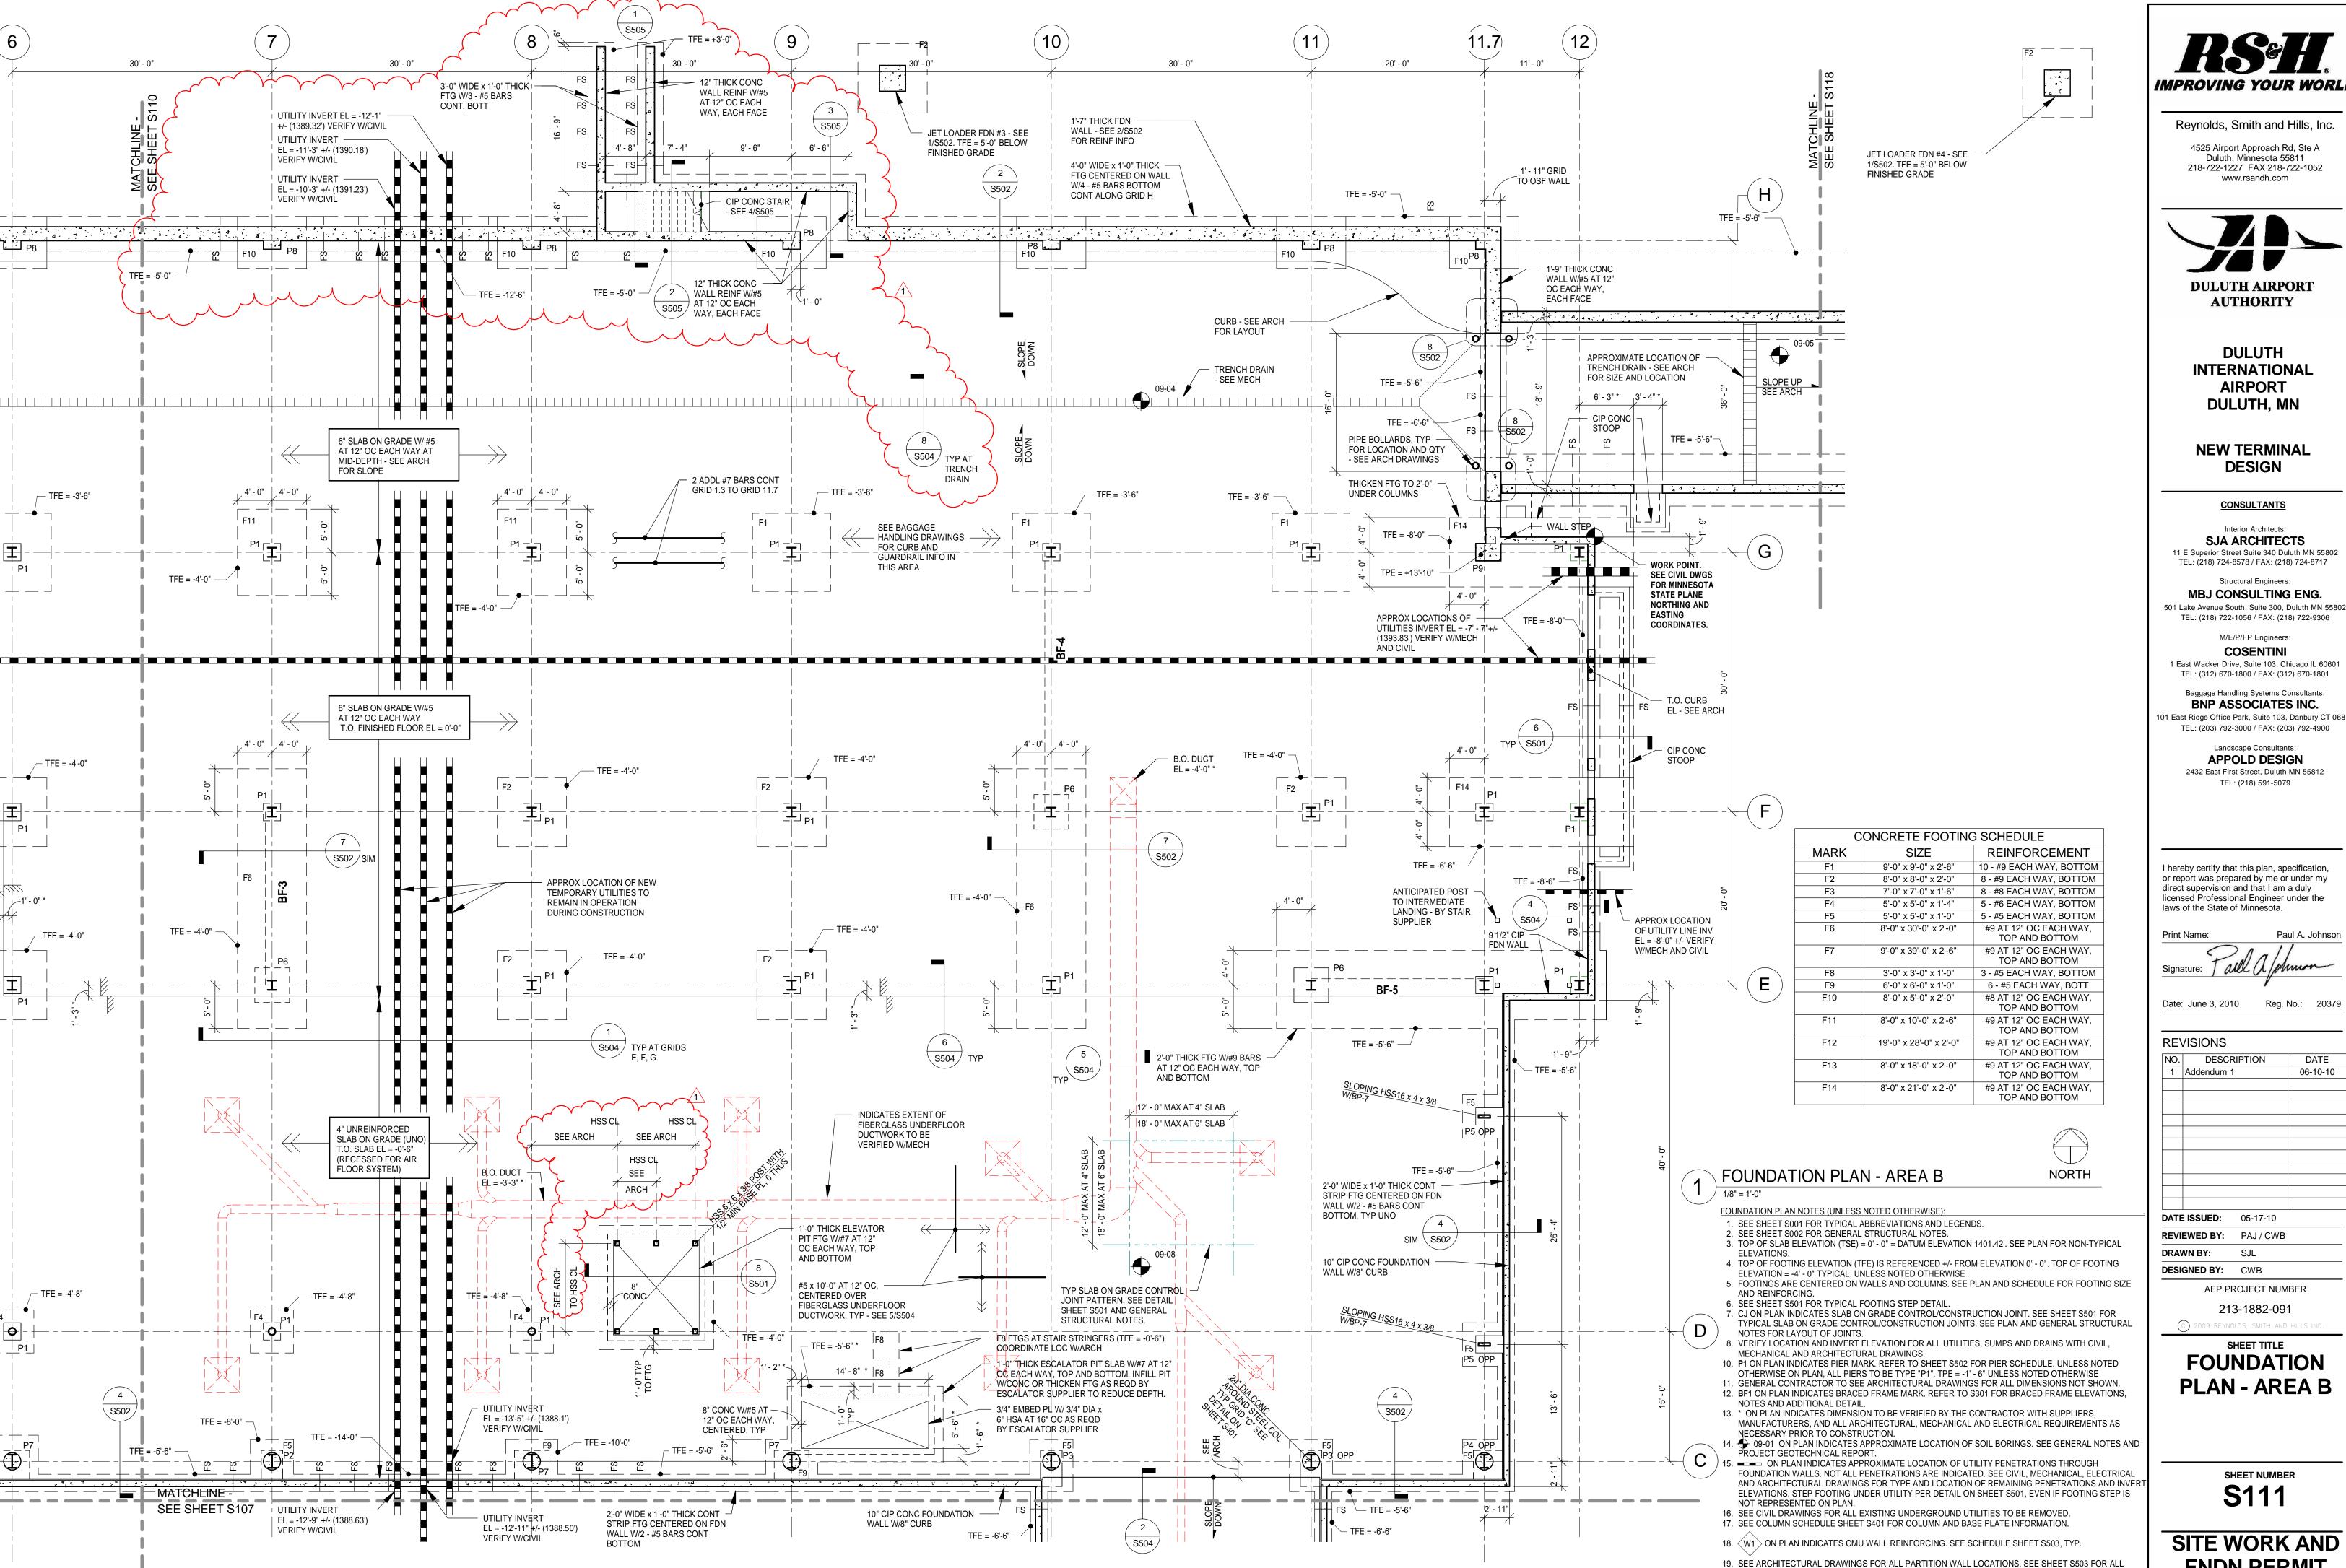SHEET NUMBER S109





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REVISIONS

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213-1882-091

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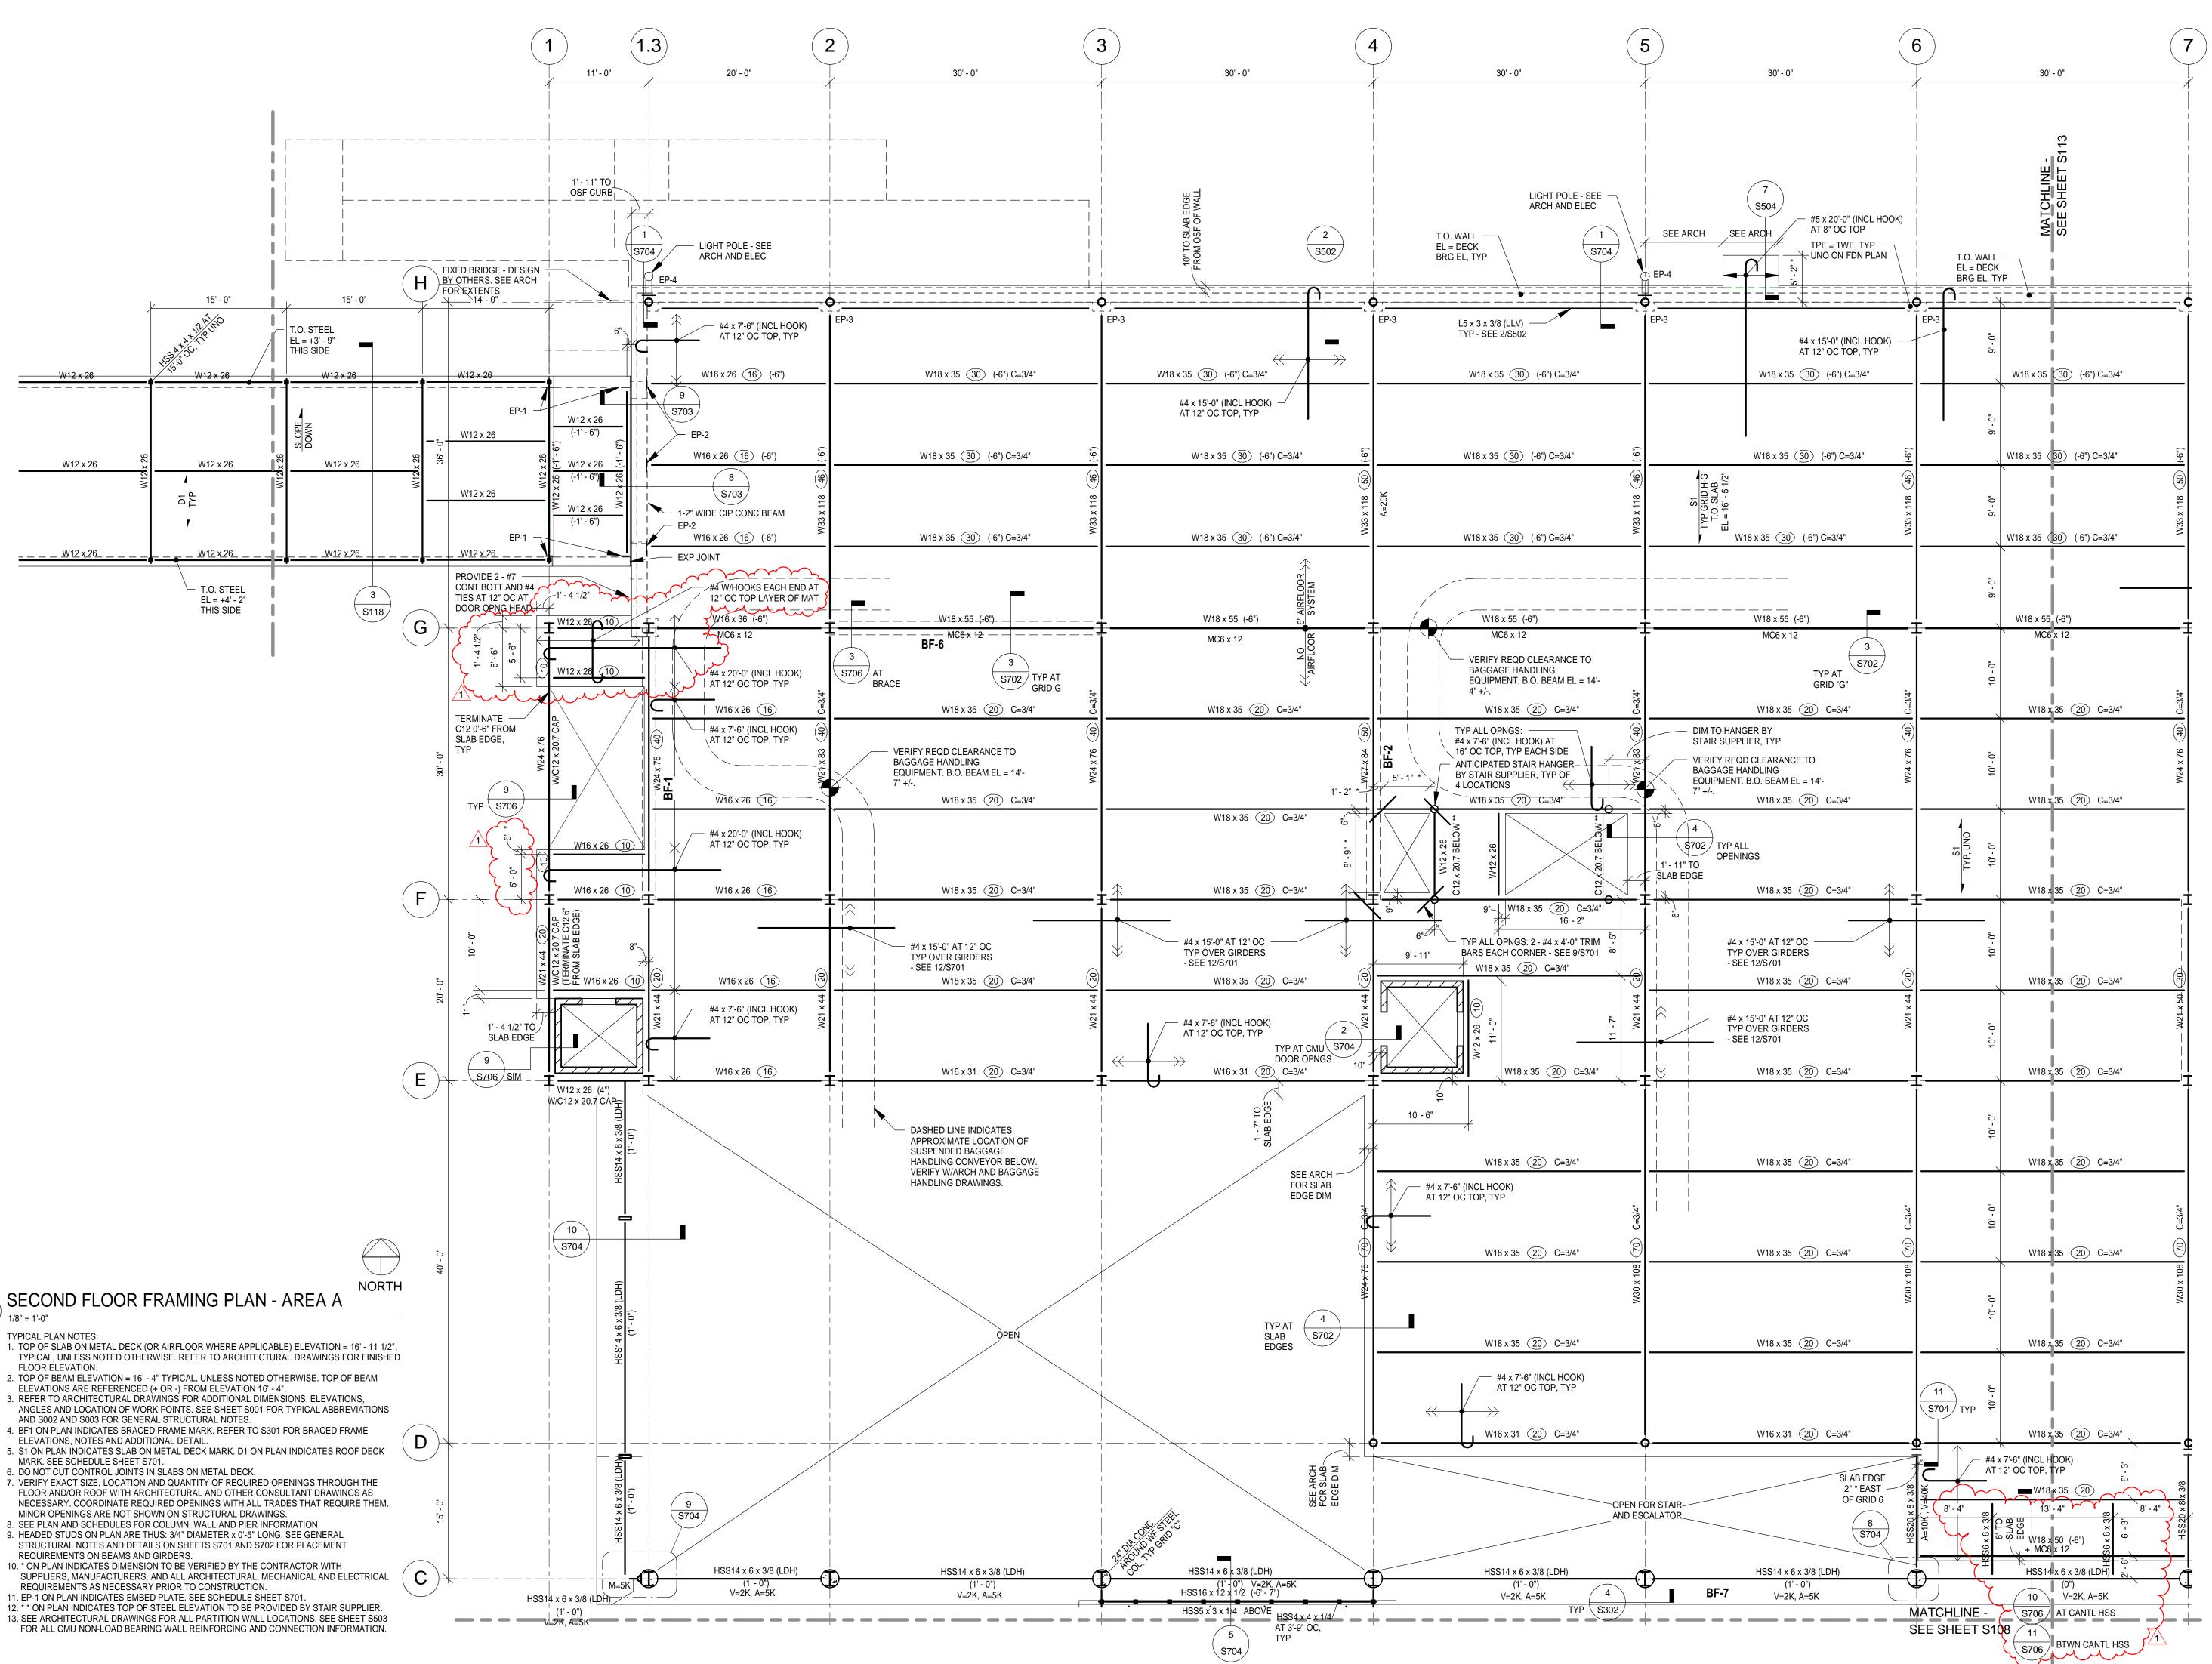
SHEET TITLE

FOUNDATION PLAN - AREA B

> **SHEET NUMBER S111**

SITE WORK AND **FNDN PERMIT**

CMU NON-LOAD BEARING WALL REINFORCING AND CONNECTION INFORMATION.





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DULUTH INTERNATIONAL AIRPORT DULUTH, MN

NEW TERMINAL DESIGN

CONSULTANTS

Interior Architects:

SJA ARCHITECTS

11 E Superior Street Suite 340 Duluth MN 55802
TEL: (218) 724-8578 / FAX: (218) 724-8717

Structural Engineers:

MBJ CONSULTING ENG.

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TEL: (218) 722-1056 / FAX: (218) 722-9306

M/E/P/FP Engineers:

COSENTINI

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TEL: (203) 792-3000 / FAX: (203) 792-4900

Landscape Consultants:

APPOLD DESIGN

2432 East First Street, Duluth MN 55812

TEL: (218) 591-5079

I hereby certify that this plan, specification, or report was prepared by me or under my direct supervision and that I am a duly licensed Professional Engineer under the

laws of the State of Minnesota.

Print Name: Paul A. Johnson

Date: June 3, 2010 Reg. No.: 20379

DATE

06-10-10

REVISIONS

NO. DESCRIPTION


1 Addendum 1

DATE ISSUED:	05-17-10	
REVIEWED BY:	PAJ / CWB	
DRAWN BY:	SJL	
DESIGNED BY:	CWB	
AEP PROJECT NUMBER		

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SECOND LEVEL FRAMING PLAN -AREA A

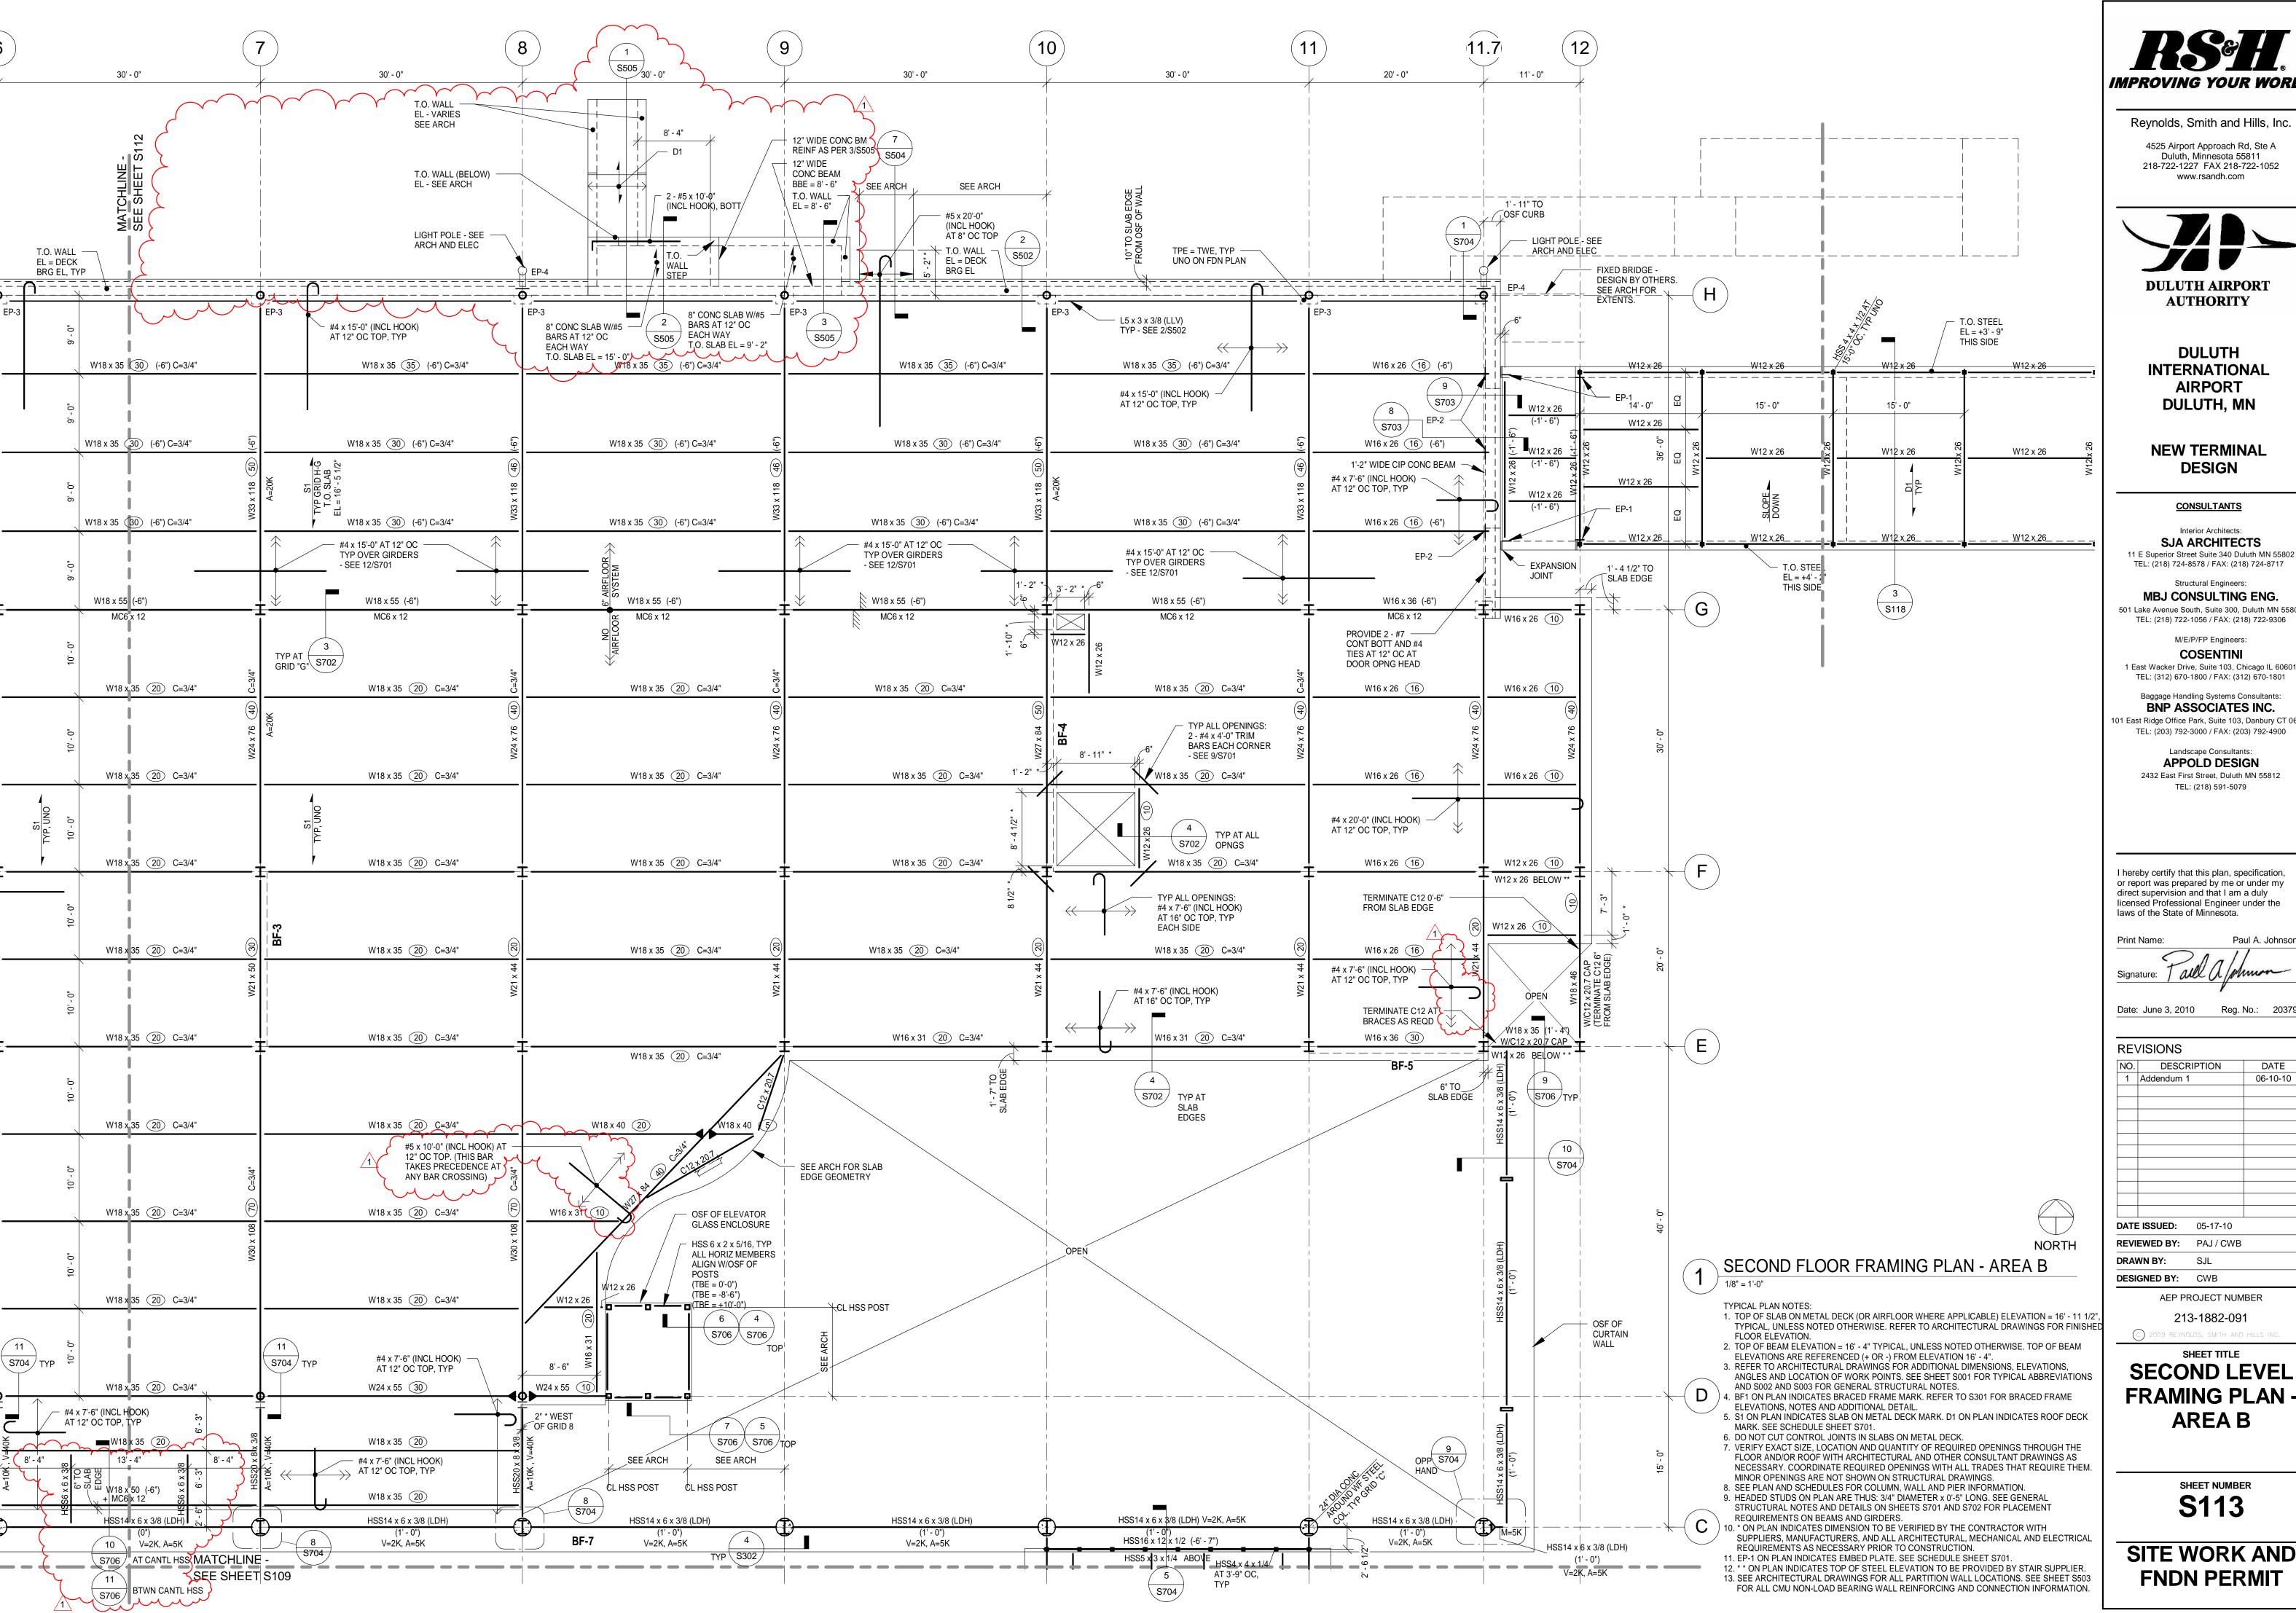SHEET NUMBER
\$112





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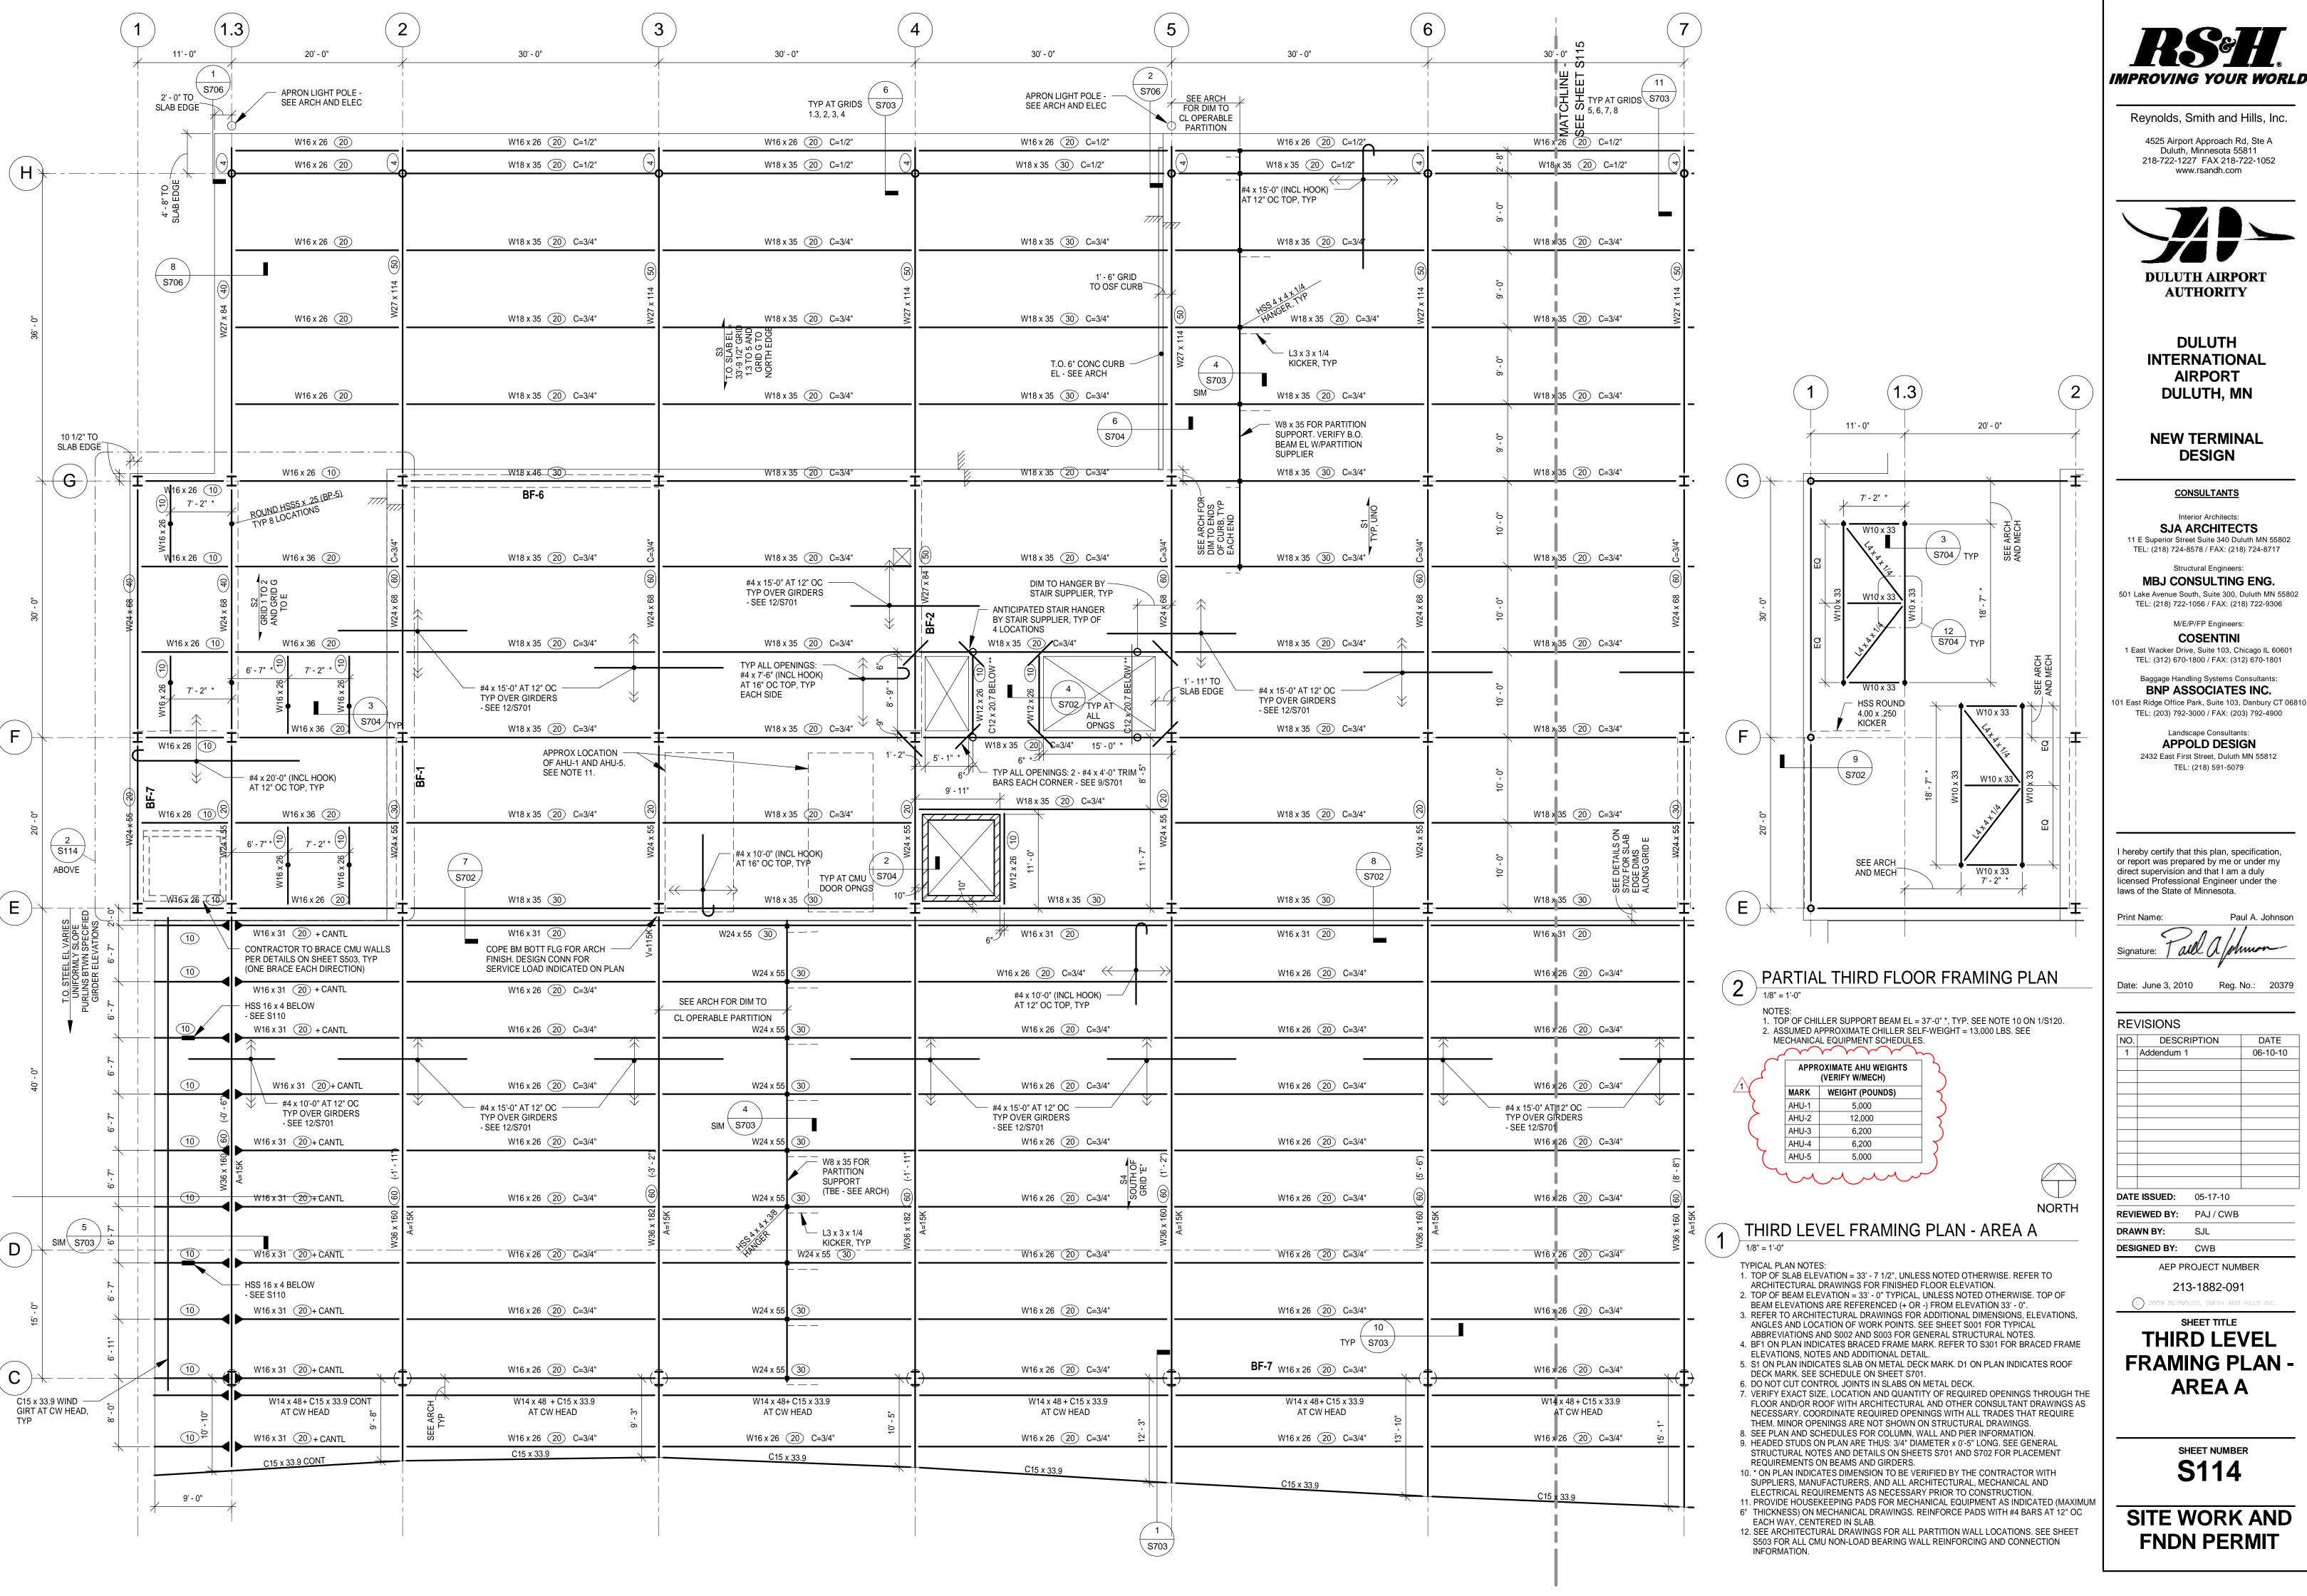
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NO.	DESCF	RIPTION	DATE
1	Addendum 1	1	06-10-10
DATE ISSUED:		05-17-10	
REVIEWED BY:		PAJ / CWB	
DRA	WN BY:	SJL	
DESIGNED BY:		CWB	

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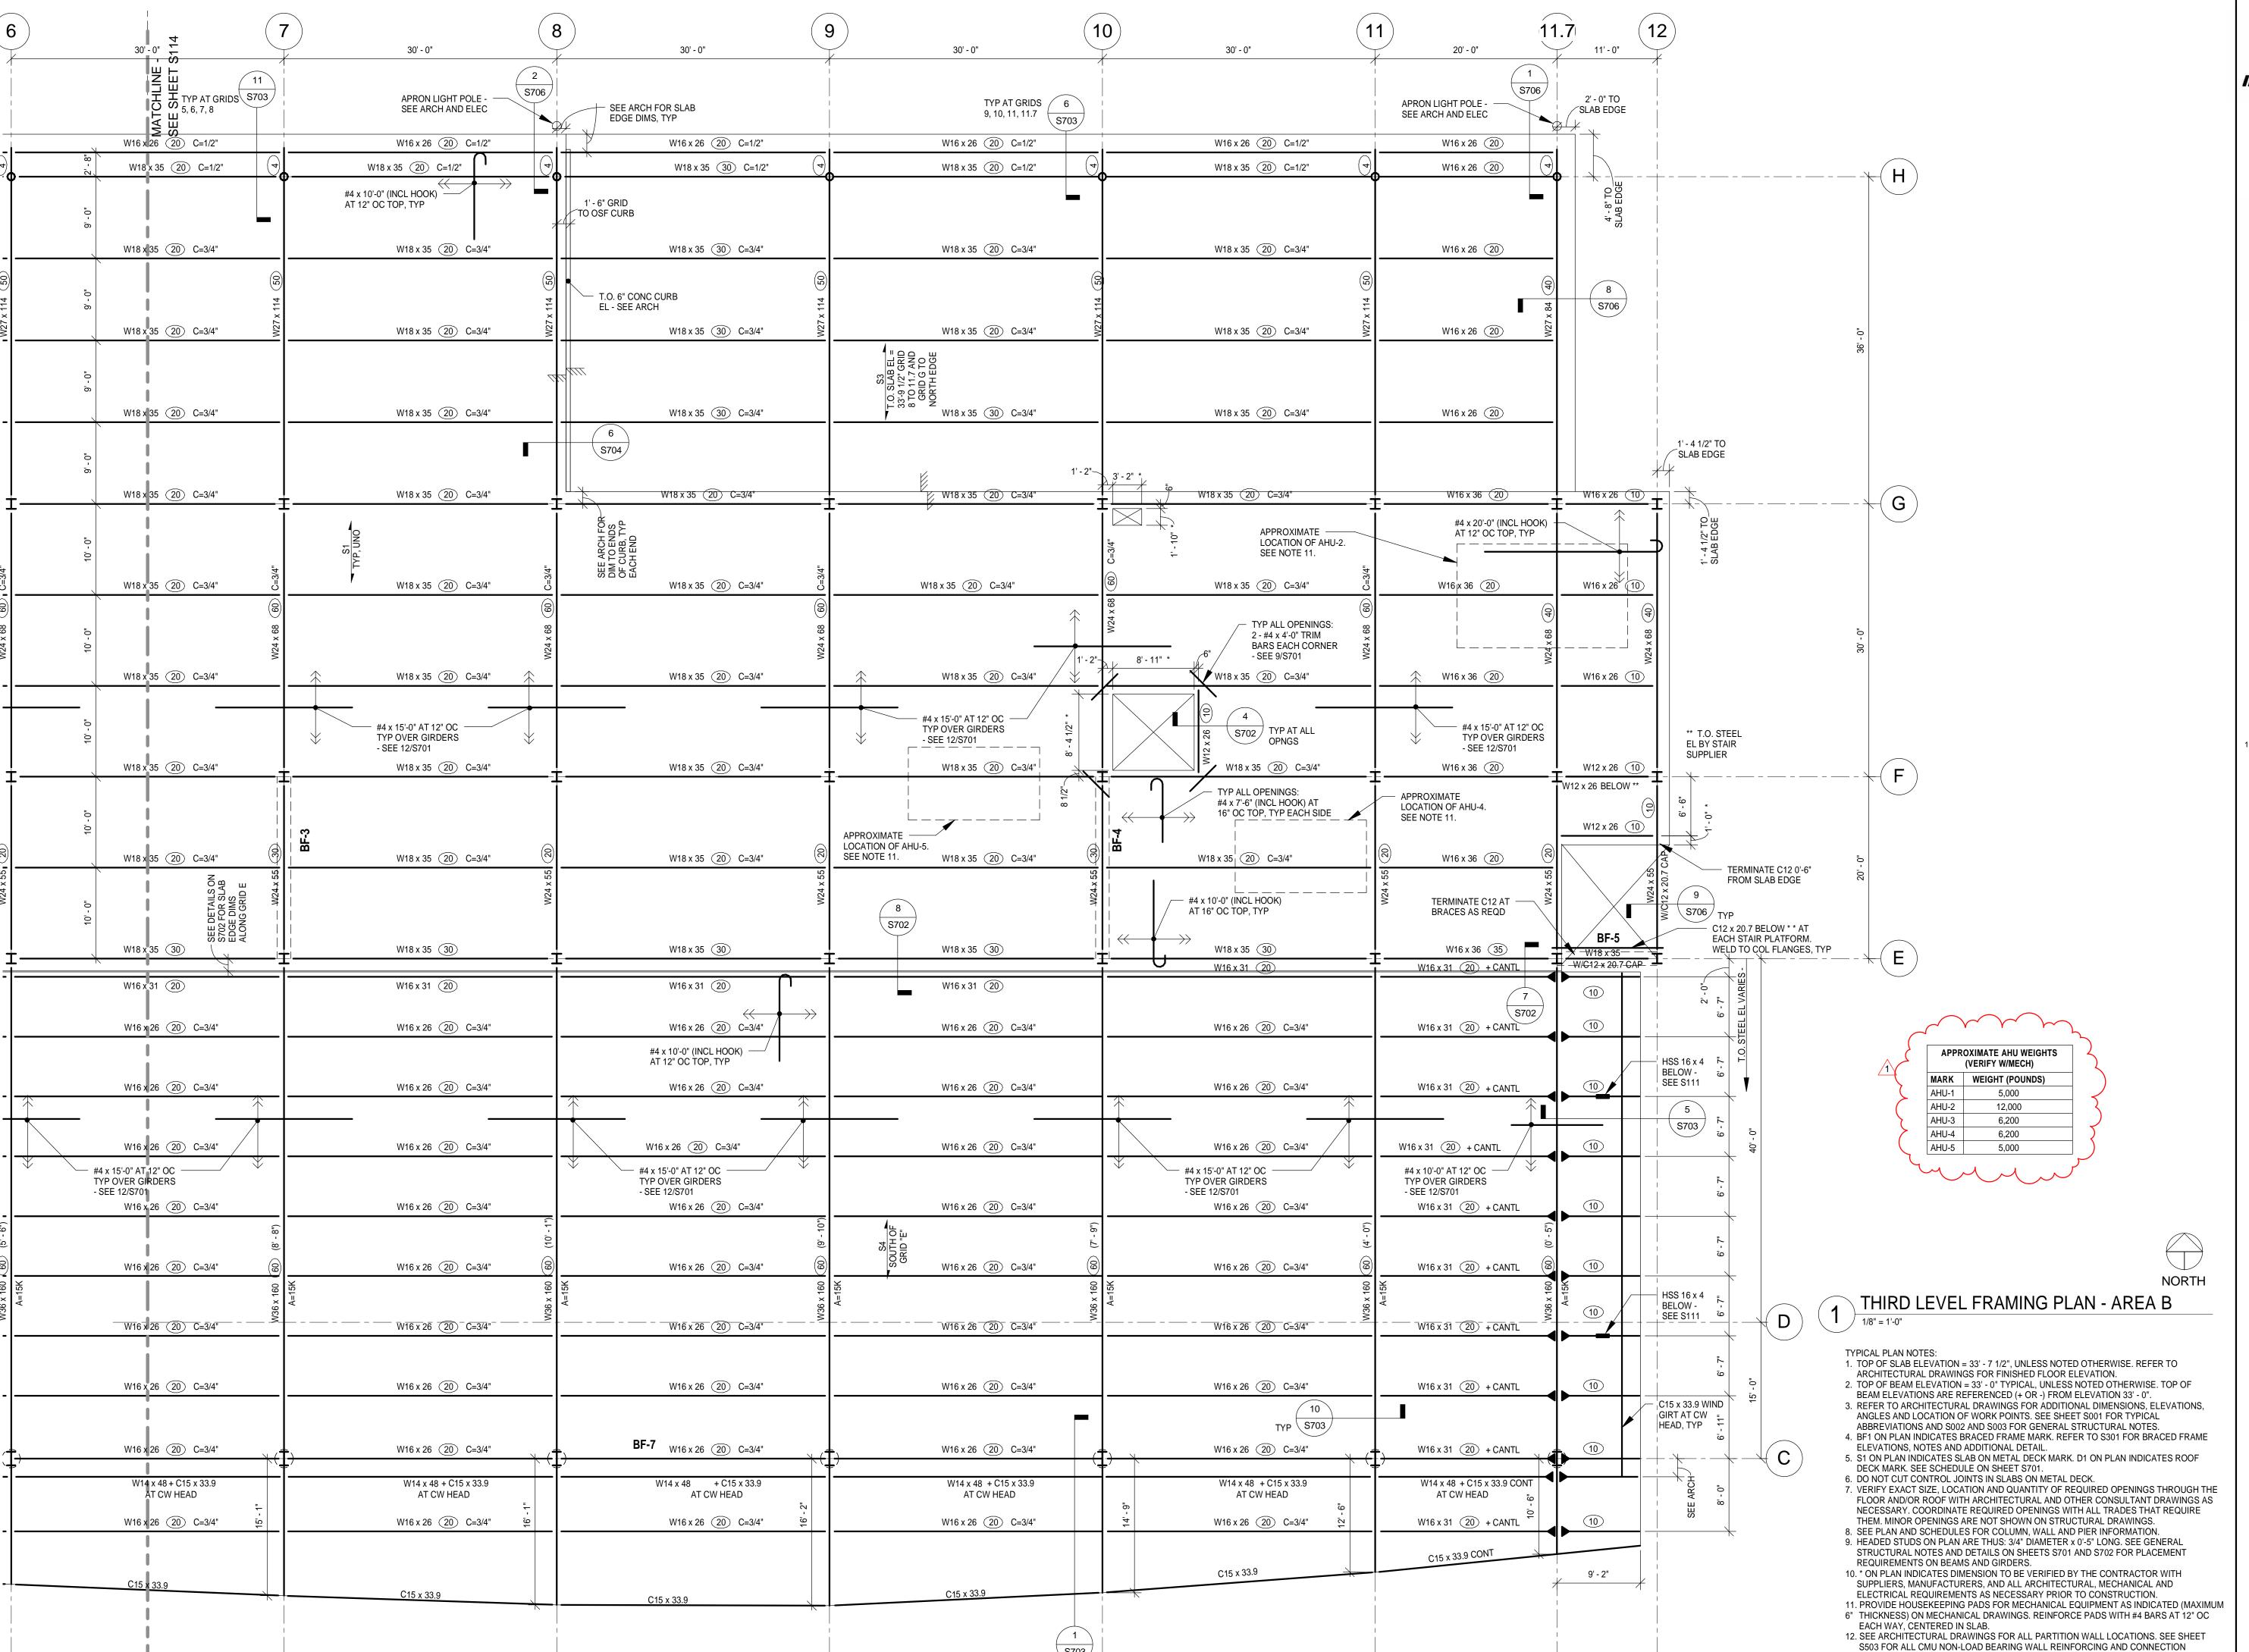
SHEET TITLE **SECOND LEVEL** FRAMING PLAN -**AREA B**

> SHEET NUMBER **S113**



Paul A. Johnson

REVISIONS			
NO.	DESCR	DATE	
1	Addendum 1		06-10-10
DATE ISSUED:		05-17-10	
REVIEWED BY:		PAJ / CWB	
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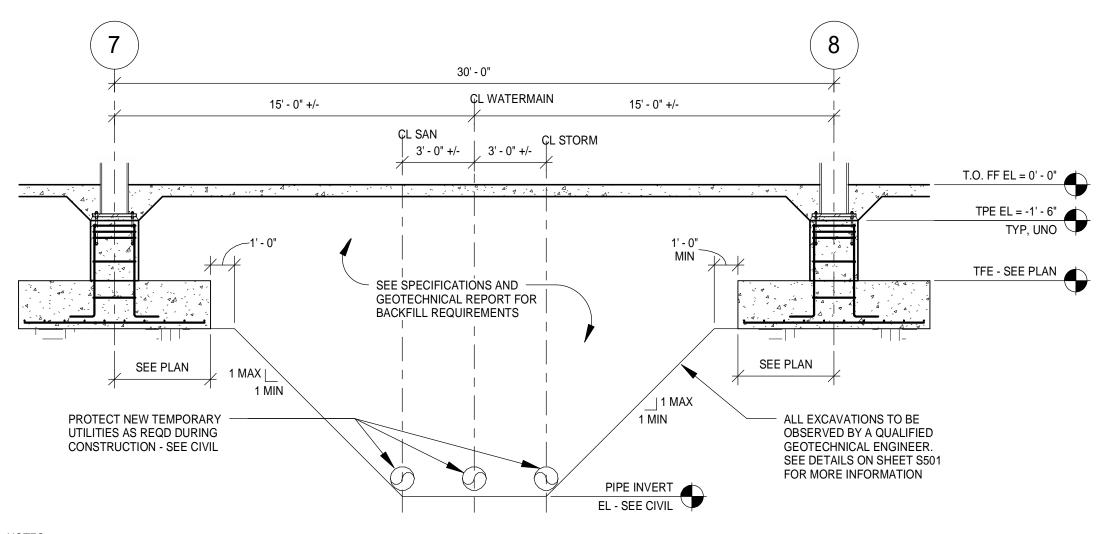
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THIRD LEVEL

FRAMING PLAN AREA B

SHEET NUMBER S115



#5 BAR AS INDICATED ON PLAN,

AIRFLOOR SYSTEM

CONCRETE SLAB

AIR DUCT - SEE MECH -

BEDDING MATL - —— DESIGN BY OTHERS. ALL SIDES OF DUCT

ON GRADE

CENTERED OVER FIBERGLASS DUCT

D

10' - 6" TYP

1. "H" AND "W" DIMENSIONS AND SPECIFICATIONS FOR BEDDING MATERIAL TO BE

VERIFIED WITH UNDERGROUND DUCT SUPPLIER PRIOR TO CONSTRUCTION.

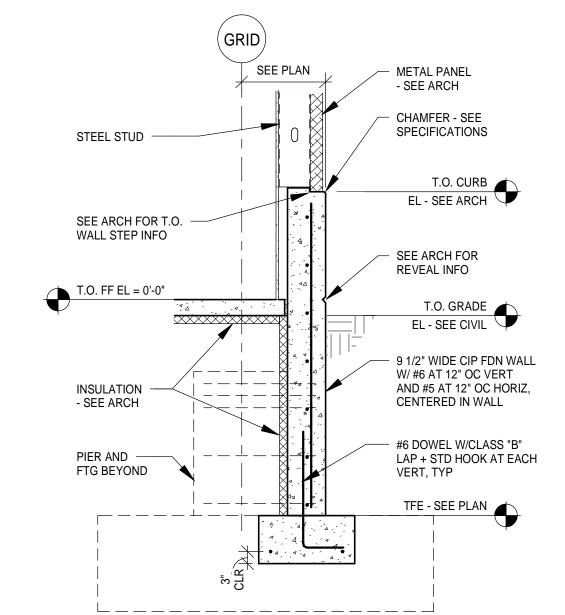
UNDERGROUND DUCTWORK DETAIL

NOTES:

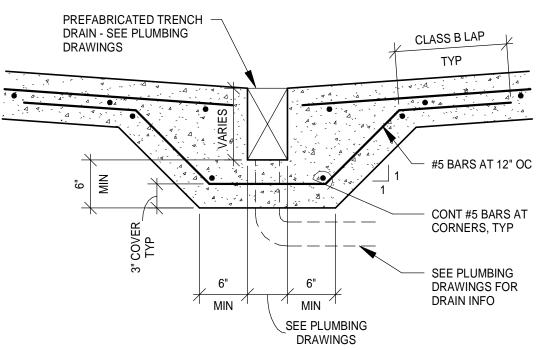
1. SEE GEOTECHNICAL REPORT FOR WATER TABLE ELEVATIONS. CONTRACTOR TO MAKE ADEQUATE PROVISIONS FOR DEWATERING AS REQUIRED.

PIPE INVERT LOCATION SHOWN SCHEMATICALLY REPRESENT LOCATIONS AT GRID E.
 CONTRACTOR TO NOTIFY A/E IMMEDIATELY IF ACTUAL FIELD CONDITIONS VARY FROM LOCATIONS/SLOPES INDICATED.

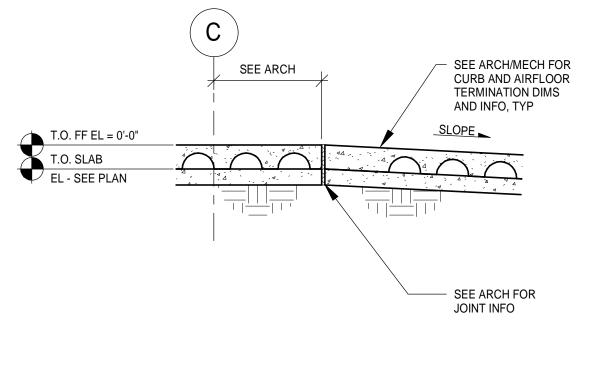
1 SECTION 1/4" = 1'-0"











2 SECTION
1/2" = 1'-0"

THICKEN SLAB ON GRADE

TO 6" AND REINF OVER

T.O. FF EL - SEE ARCH

COMPACTED EARTH OR

NATIVE SOIL

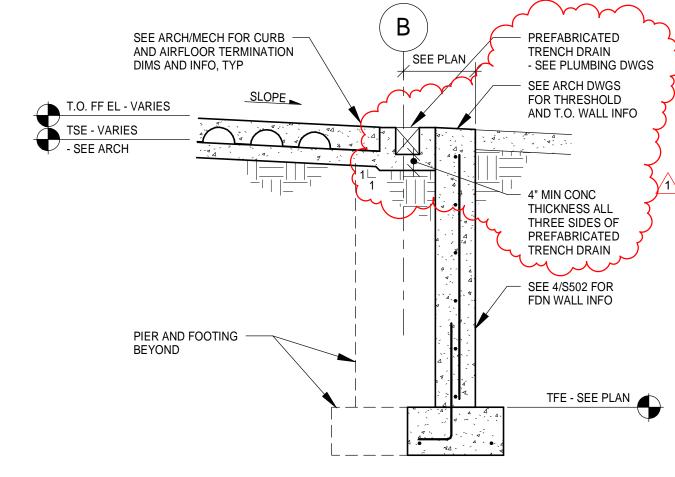
T.O. SLAB

EL - SEE PLAN


T.O. DUCT

EL - SEE MECH

DUCT, TYP




3 SECTION AT VESTIBULE DOOR

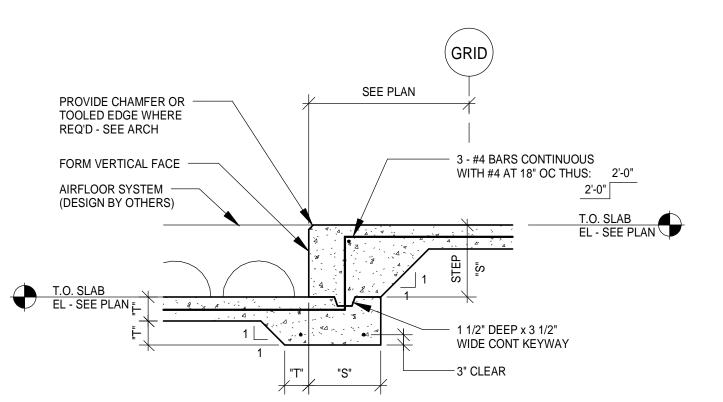

6 SLAB STEP DETAIL

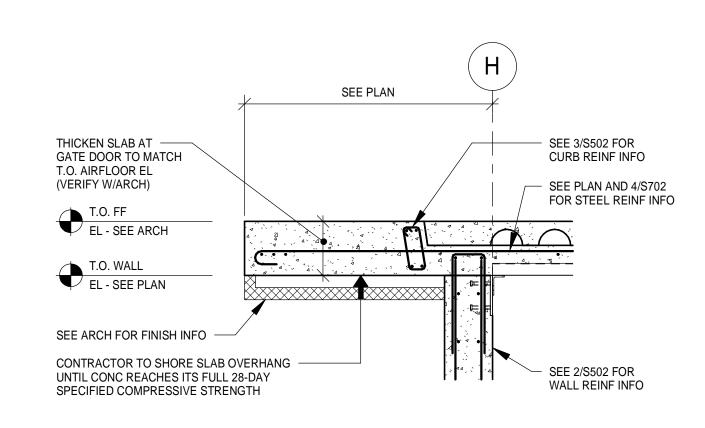3/4" = 1'-0"



7 SECTION AT GATE DOOR SLAB

1/2" = 1'-0"



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01	10//
Signature: T <i>all</i>	a phonon
	"

Date: June 3, 2010 Reg. No.: 20379

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DRAWN BY: SJL
DESIGNED BY: CWB

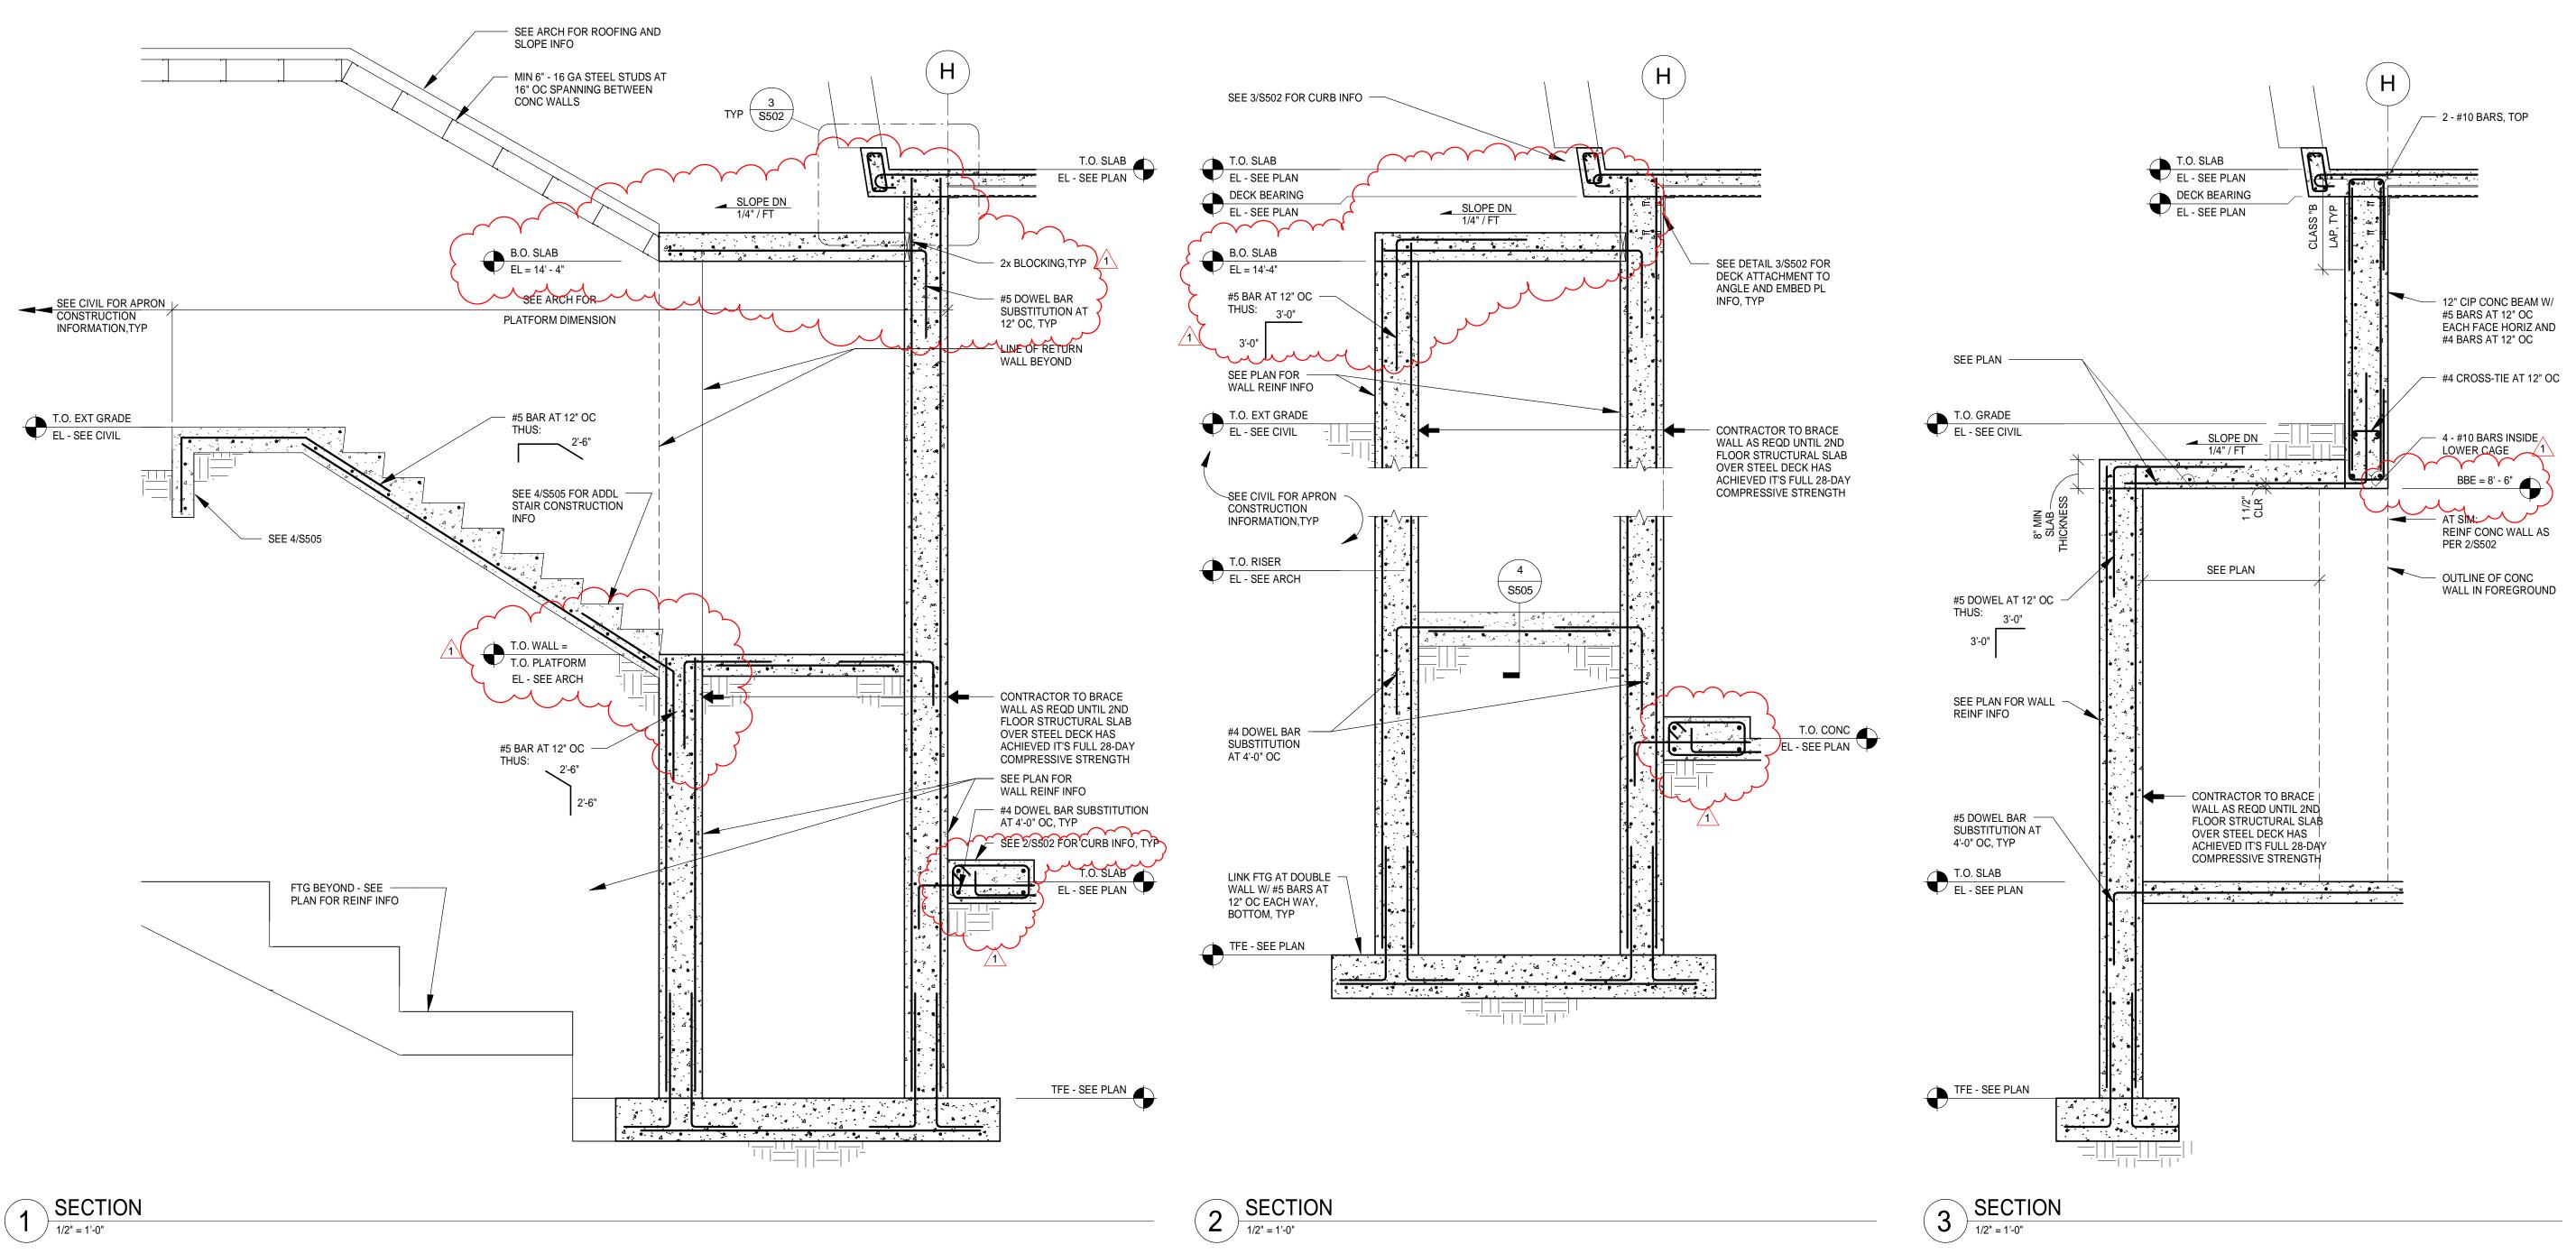
DATE ISSUED: 05-17-10

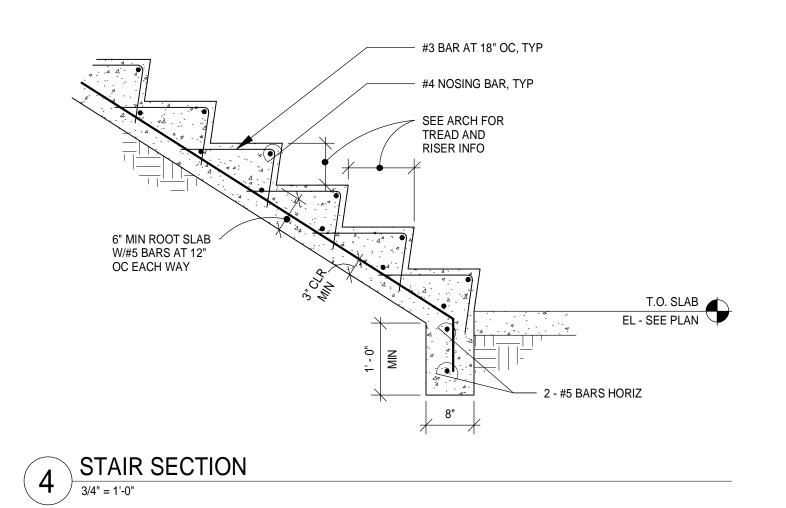
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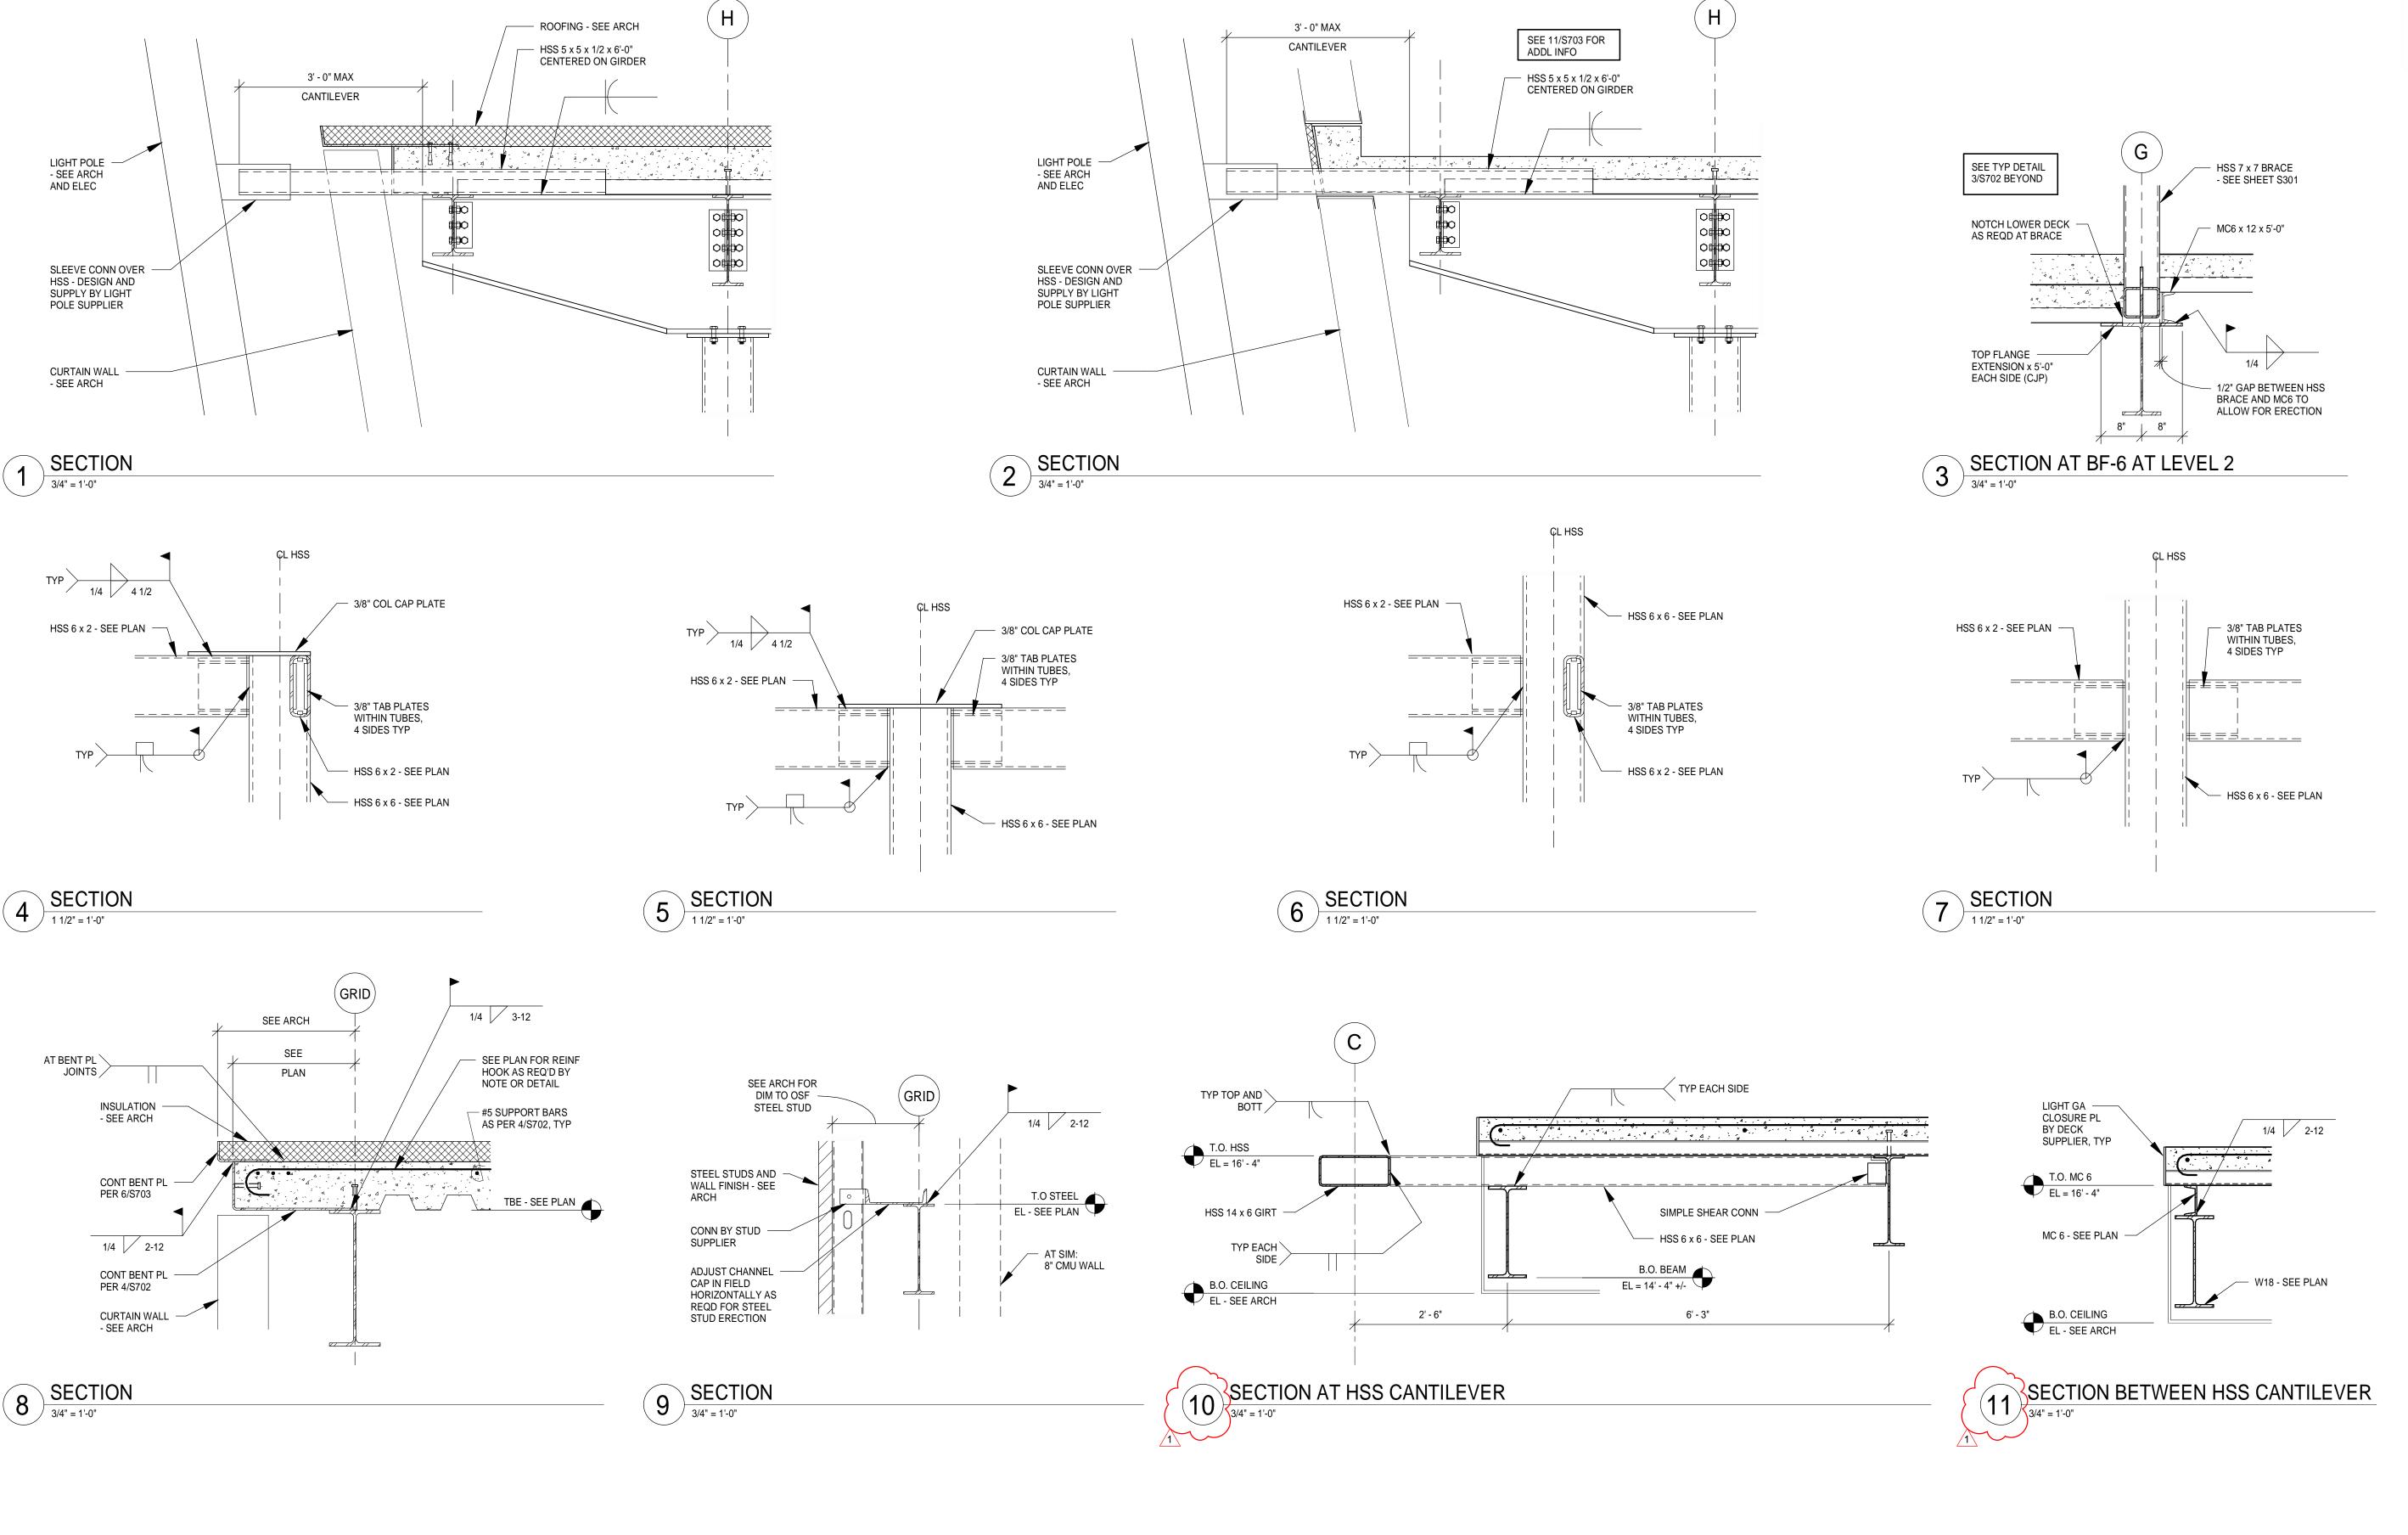
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SHEET TITLE

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