

provide the 2 hour fire rating

b. Clear opening at corridor near mailboxes modified.

Architect's Supplemental Instruction (ASI)

Dat	e:	November 11, 2021		ASI No.:	1				
Pro	ject:	The Burnham		LHB Project No.:	180039				
Owner:		New Burnham LLC		Architect:	LHB, Inc.				
Cor	ntractor:	Gardner Builders		Contract For:	General Construction	ı			
Ins	truction	ing work shall be provide is. The Contractor acknow Contract Time.							
Rea	ason:	⊠ Owner Request	☐ Unforeseen Con	ndition 🗵 Co	de □ Contract	tor / CM			
1.	a. Pla	e Sheet G0.00 in its entired an review response – Coo neet A4.07 added to the she	de references updated						
2.	a. Pla	e Sheet G0.01 in its entiret an review response – Egr gnage have been added to	ess travel/common tra	vel path, travel dista	nces, occupant load ca	ılculations, and exit			
3.	a. Pl	e Sheet G0.02 in its entire an review response - All k th red text.		eferences have beer	n modified and are either	er bubbled or indicated			
4.	a. Pla	eplace Sheet G0.03 in its entirety Plan review response - All known incorrect code references have been modified and are either bubbled or indicated with red text. Basement means of egress sizing calculation is provided in the code summary							
5.	a. Ne	leplace Sheet D1.10 in its entirety. New/revised demo notes have been added to several window openings Drawing reference modified							
6.	Replace Sheet D1.20 in its entirety. a. New/revised demo notes have been added to several window openings								
7.		e Sheet D1.40 in its entiret w/revised demo notes hav		al window openings					
8.		e Sheet A1.10 in its entiret an review response – An		-hour rating has bee	n added to the plan so	uth side of Stair A to			

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- 9. Replace Sheet A1.20 in its entirety.
 - a. Plan review response Wall type L2-1 has been added at the location between room 209 and the bedroom at unit 201
- 10. Replace Sheet A1.40 in its entirety.
 - a. Spiral stairs have been removed from the project at the 4th/5th floor 2-story units. 3' wide stairs have been added in their place.
 - b. Plan review response The east and south walls of Unit 402 have been corrected to show the continuity of the 1-hour rating
- 11. Replace Sheet A1.50 in its entirety.
 - a. Stair changes see note above at A1.40
- 12. Replace Sheet A1.70 in its entirety.
 - a. Floor material transitions at unit bathroom doors removed
- 13. Replace Sheet A1.71 in its entirety.
 - a. Floor material transitions at unit bathroom doors removed
 - b. Detail 1 Kitchen and kitchen wall location moved plan north to locate new structural column within wall.
- 14. Replace Sheet A1.72 in its entirety.
 - a. Stair changes see note above at A1.40
 - b. Kitchen types L and J have been modified to avoid conflict between refrigerator and fin tube radiation
- 15. Replace Sheet A1.73 in its entirety.
 - a. Stair changes see note above at A1.40
 - b. Detail 1A towel bar added to bath
 - c. Detail 3 additional information added to unit plan
- 16. Replace Sheet A1.82 in its entirety.
 - a. Detail 1 Note 'Open to above' removed from corridor area
- 17. Replace Sheet A2.01 in its entirety
 - a. 4th floor east elevation windows are now to be fixed type instead of casement type
- 18. Replace Sheet A2.10 in its entirety
 - a. Kitchen type M elevations have been added to sheet
 - b. Kitchen types L and J have been modified to avoid conflict between refrigerator and fin tube radiation
 - c. Kitchen type K has been removed from the project
 - d. Unit 406 now has a type L kitchen
 - e. Detail 21 Dimension string added
- 19. Replace Sheet A4.01 in its entirety.
 - a. **Plan review response** An existing wall at the 5th floor in section 8/A4.01was not shown correctly and has now been added to further indicate the sealed off shaft
- 20. Add sheet A4.07 in its entirety
 - a. Unit stair details are added to the project
- 21. Replace Sheet A4.30 in its entirety.
 - a. **Plan review response** Detail 7/A4.30 has been removed from the set. All other references to U wall types have been switched to V wall types.

22. Replace Sheet A5.00 in its entirety.

a. Plan review response – 1st and 4th floor existing corridor wall types have been added to the sheet and show compliance with IEBC 1203.7. Wall type M6 has been added to the wall types.

23. Replace Sheet A5.01 in its entirety

a. Plan review response - Existing floor/ceiling assemblies 7/A5.01 (basement ceiling) and 11/A5.01 (first floor ceiling) have been changed to 2-hour fire ratings due to this relationship with Stair A. MSBC Table 722.2.2.1 shows compliance that regardless of concrete type, these assemblies have well over a 2 hour fire-resistance rating. In regard to 5 and 9/A5.01 (4th floor ceiling), MSBC Table 722.2.2.1 shows compliance that as Siliceous concrete, the 4" of concrete in these assemblies achieves the 2 hour rating without consideration for the clay tile and steel formwork (which would only add to the fire resistive rating for the assemblies). Item code F/C-HT-13 in Table 3.4 of Resource A of the existing building code also provides support that these assemblies have a minimum of a 2 hour rating.

24. Replace Sheet A5.20 in its entirety

a. Plan review response - Code reference for door SA1A updated

25. Replace Sheet A5.30 in its entirety

- a. Note added to window types W1 and W3 to use fixed windows at 4th floor east elevation
- b. Note regarding WOCD fall protection removed from notes
- c. Interior window frames have been removed from the project as the 5th floor corridor has been deleted from the project

26. Replace Sheet A5.31 in its entirety

a. Window details have been modified related to the treatment of the bars (demo vs. retaining)

27. Replace Sheet A6.02 in its entirety

a. Details 1 and 5/A6.02 have been removed from the project

28. Replace Sheet A7.10 in its entirety.

a. Modification to the stair signs to indicate appropriate 'roof access' and basement level for both stairs have been made.

Attachments:

_	G0.	$\Lambda\Lambda$	
•	(- ()	1111	

G0.01

G0.02

G0.03

D1.10

D1.20

D1.40 A1.10

A1.20

A1.40

A1.50

A1.70

A1.71

A1.72

A1.73

A1.82

A2.01 A2.10

A4.01

A4.07

A4.30

A5.00

A5.01

A5.20

A5.30

A5.31

A6.02

A7.10

Issued By: Andy Madson, Architect

c: LHB File No. 180039

PROJECT RENDERING



HE BURNHAM - HISTORIC ST. LOUIS COUNTY JAIL

DULUTH, MN 55802



701 Washington Ave. N, Ste 200 | Minneapolis, MN 55401 | 612.338.2029

PROJECT TEAM

New Burnham, LLC 575 9th Street Southeast, Unit 215 Minneapolis, MN 55414

Minneapolis, MN 55401 612.827.7825

ARCHITECT & LANDSCAPE ARCHITECT

701 Washington Ave N, Suite 200 Minneapolis, MN 55401 612.338.2029

CIVIL ENGINEER


21 West Superior St., Suite 500

Mattson Macdonald Young, Inc. 901 North 3rd Street, Suite 100


MEP ENGINEER - DESIGN/BUILD

GENERAL CONTRACTOR Gardner Builders 2 West 1st Street, Suite 133

REGIONAL MAP

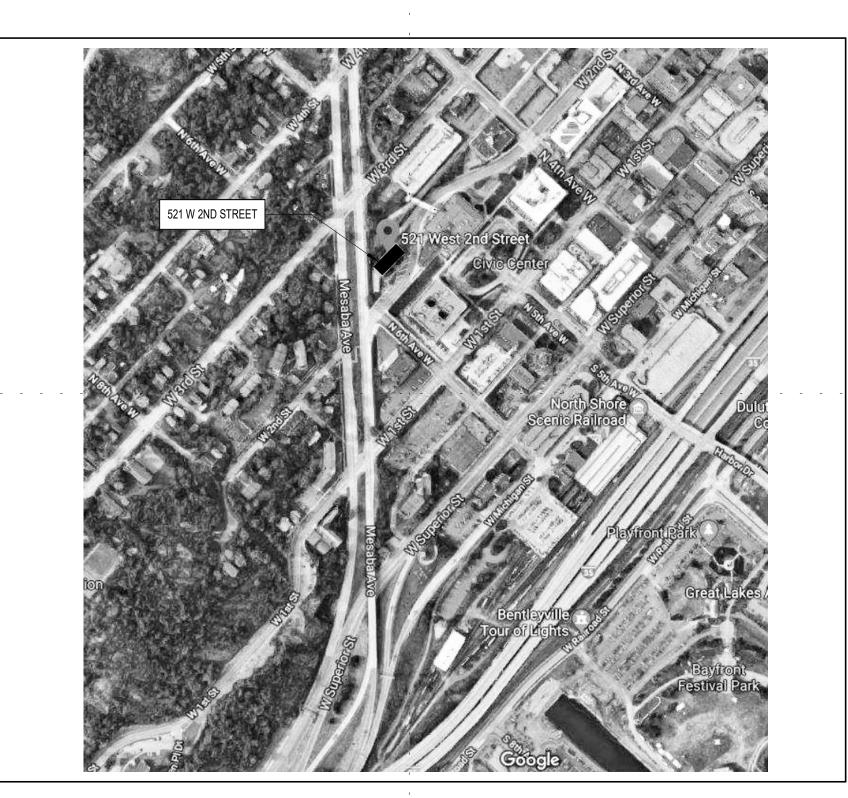

STATE MAP

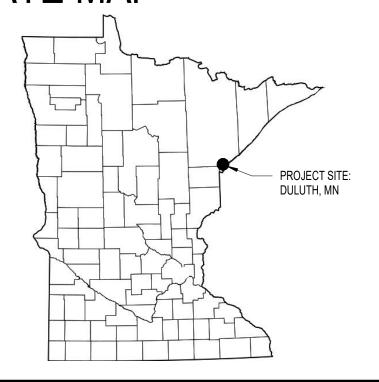

BUILDING DATA

FLOOR NAME	DESCRIPTION	AREA (GSF
BASEMENT	APARTMENTS, STORAGE & MECH. (4,090)	6,24
FIRST FLOOR	APARTMENTS & COMMON AREA	6,24
SECOND FLOOR	APARTMENTS	6,24
THIRD FLOOR	APARTMENTS	6,24
FOURTH FLOOR	APARTMENTS	6,24
FIFTH FL.	APARTMENTS (2,080*) & MOTH BALLED/MECH. (3,129)	5,20
TOTAL		36,44

LINIT TYPES AND DATA

ITEMIZED UNIT	DESCRIPTION			FLOOR				TOTAL		
TYPE	AREA (NET SF)	BR	BA	ACC	В	1	2	3	4	TYPE
EFF A	465	0	1	В			4	4		8
EFF A2	476	0	1	В		2				2
EFF B	423	0	1	В			1	1		2
EFF B2	388	0	1	В		1				1
EFF C	303	0	1	В		1				1
EFF D	389	0	1	В	1					1
1BR A	564	1	1	В*					3	3
1BR B	542	1	1	В*					1	1
1BR C	648	1	1	В			1	1		2
1BR D	585	1	1	В		1				1
1BR E	529	1	1	В			1	1	1	3
1BR F	694	1	2	B*		1				1
1BR G	617	1 1	1	B*		-	-	-	1	1
1BR+DEN A	616	1	1	Α		1				1
2BR B	807	2	1	В*					1	1
2BR C	709	2	1	В			1	1	1	3
TOTALS					1	7	8	8	8	32
TOTALS	709	2		В	1	7	- 60	- 35	-	32
TOTAL UNIT TYPE										TOTAI TYPE
EFF										15

NOTE: UNIT AREAS INCLUDE THE MECH. SHAFT AREA ONE FLOOR - THE FLOOR PROVIDED WITH ELEVATOR SEVICE SHALL BE THE PRIMARY

UNIT ACCESSIBILITY DATA Units are designed to the following Accessibility Standards: ACC. Type Accessibility Standard ICC/ANSI 117.1 - Type 'A' Accessible Unit ICC/ANSI 117.1 - Type 'B' Accessible Unit NUMBER OF ACCESSIBLE UNITS REQUIRED 1.5MN 1107.6.2.2.1 requires 2% of dwelling units be Type 'A' Accessible: 32 Units x 2% = 1

2 NUMBER OF ACCESSIBLE UNITS PROVIDED - Type 'A' Accessible Unit is provided.

SHEET INDEX

LANDSCAPE L100 LANDSCAPE PLAN L200 LANDSCAPE DETAILS C100 SITE REMOVALS & EROSION CONTROL PLA C200 SITE PLAN C300 GRADING PLAN C400 CONSTRUCTION DETAILS STRUCTURAL	N

ON DETAILS S0.00 STRUCTURAL TITLE SHEET S0.01 STRUCTURAL NOTES S0.02 SPECIAL INSPECTIONS & STRUCTURAL SITE PLAN

S3.31 FIFTH FLOOR FRAMING SECTIONS AND DETAILS S3.32 FIFTH FLOOR FRAMING SECTIONS AND DETAILS S3.33 FIFTH FLOOR FRAMING SECTIONS AND DETAILS S4.00 ROOF FRAMING SECTIONS AND DETAILS S5.00 STAIR A FRAMING PLANS AND SECTION

S5.01 STAIR A FRAMING SECTIONS AND DETAILS

S5.02 STAIR FRAMING SECTIONS AND DETAILS

D1.20 SECOND AND THIRD FLOOR DEMO PLANS

D2.00 EXTERIOR DEMOLITION ELEVATIONS D2.01 EXTERIOR DEMOLITION ELEVATIONS

S6.00 STRUCTURAL VISUALS DEMOLITION D1.00 BASEMENT DEMO PLAN

D1.10 FIRST FLOOR DEMO PLAN

D1.90 DEMOLITION DETAILS

ARCHITECTURAL

A1.60 ROOF PLAN

A1.70 UNIT PLANS A1.71 UNIT PLANS A1.72 UNIT PLANS A1.73 UNIT PLANS

A1.00 BASEMENT PLAN

A1.10 FIRST FLOOR PLAN

A1.40 FOURTH FLOOR PLAN A1.50 FIFTH FLOOR PLAN

D1.40 FOURTH FLOOR DEMO PLAN D1.50 FIFTH FLOOR DEMO PLAN

A0.10 ARCHITECTURAL SITE PLAN

A1.20 SECOND AND THIRD FLOOR PLANS

A1.90 NEW CONSTRUCTION DETAILS A2.00 BUILDING ELEVATIONS

A2.01 BUILDING ELEVATIONS

TYP TYPICAL

UNO UNLESS NOTED OTHERWISE

A1.61 ENLARGED COMMON AREA FLOOR PLANS

A1.80 REFLECTED CEILING PLANS - BASEMENT & FIRST FLOOR A1.81 REFLECTED CEILING PLANS - SECOND AND THIRD FLOOR

A1.82 REFLECTED CEILING PLANS - FOURTH AND FIFTH FLOOR

A2.21 INTERIOR ELEVATIONS - COMMON AREAS - EXISTING CONDITION PHOTOS

A2.24 INTERIOR ELEVATIONS - COMMON AREAS - EXISTING CONDITION PHOTOS

A2.10 INTERIOR ELEVATIONS - UNIT KITCHENS & BATHS

A2.20 INTERIOR ELEVATIONS - COMMON AREAS

A2.22 INTERIOR ELEVATIONS - COMMON AREAS

A2.23 INTERIOR ELEVATIONS - COMMON AREAS

1 BR + DEN

* MULTI STORY UNITS THAT ARE PROVIDED WITH EXTERNAL ELEVATOR SERVICE TO ONLY ENTRY TO THE UNIT, SHALL COMPLY WITH THE REQUIREMENTS FOR A TYPE B UNIT AND A TOILET FACILITY SHALL BE PROVIDED ON THAT FLOOR. (IBC 1107.7.2)

ABBREVIATIONS CLR CLEAR 'DIMENSION'

NIC 'WORK' NOT IN CONTRACT

New Burnham, LLC

575 9th Street Southeast, Unit 215 Minneapolis, MN 55414

ON FULL SIZE SH	
1/10/20	100% CONSTRUCTION DOCUME

NO	DATE	ISSUED FOR	
-			
-			
-			

ADDENDUM 1

I HEREBY CERTIFY that this plan, specification or report was prepared by me or under my direct supervision and that I am a duly Licensed Architect under the laws of the State of Minnesota.

7/12/2021

ANDREW MADSON Typed or Printed Name: /


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PROJECT NAME: The Burnham - Historic St. Louis County Jail

521 W. 2ND STREET Duluth, MN 55802

DRAWING TITLE: TITLE SHEET

DRAWN BY: Author CHECKED BY: Checker PROJ. NO: 180039

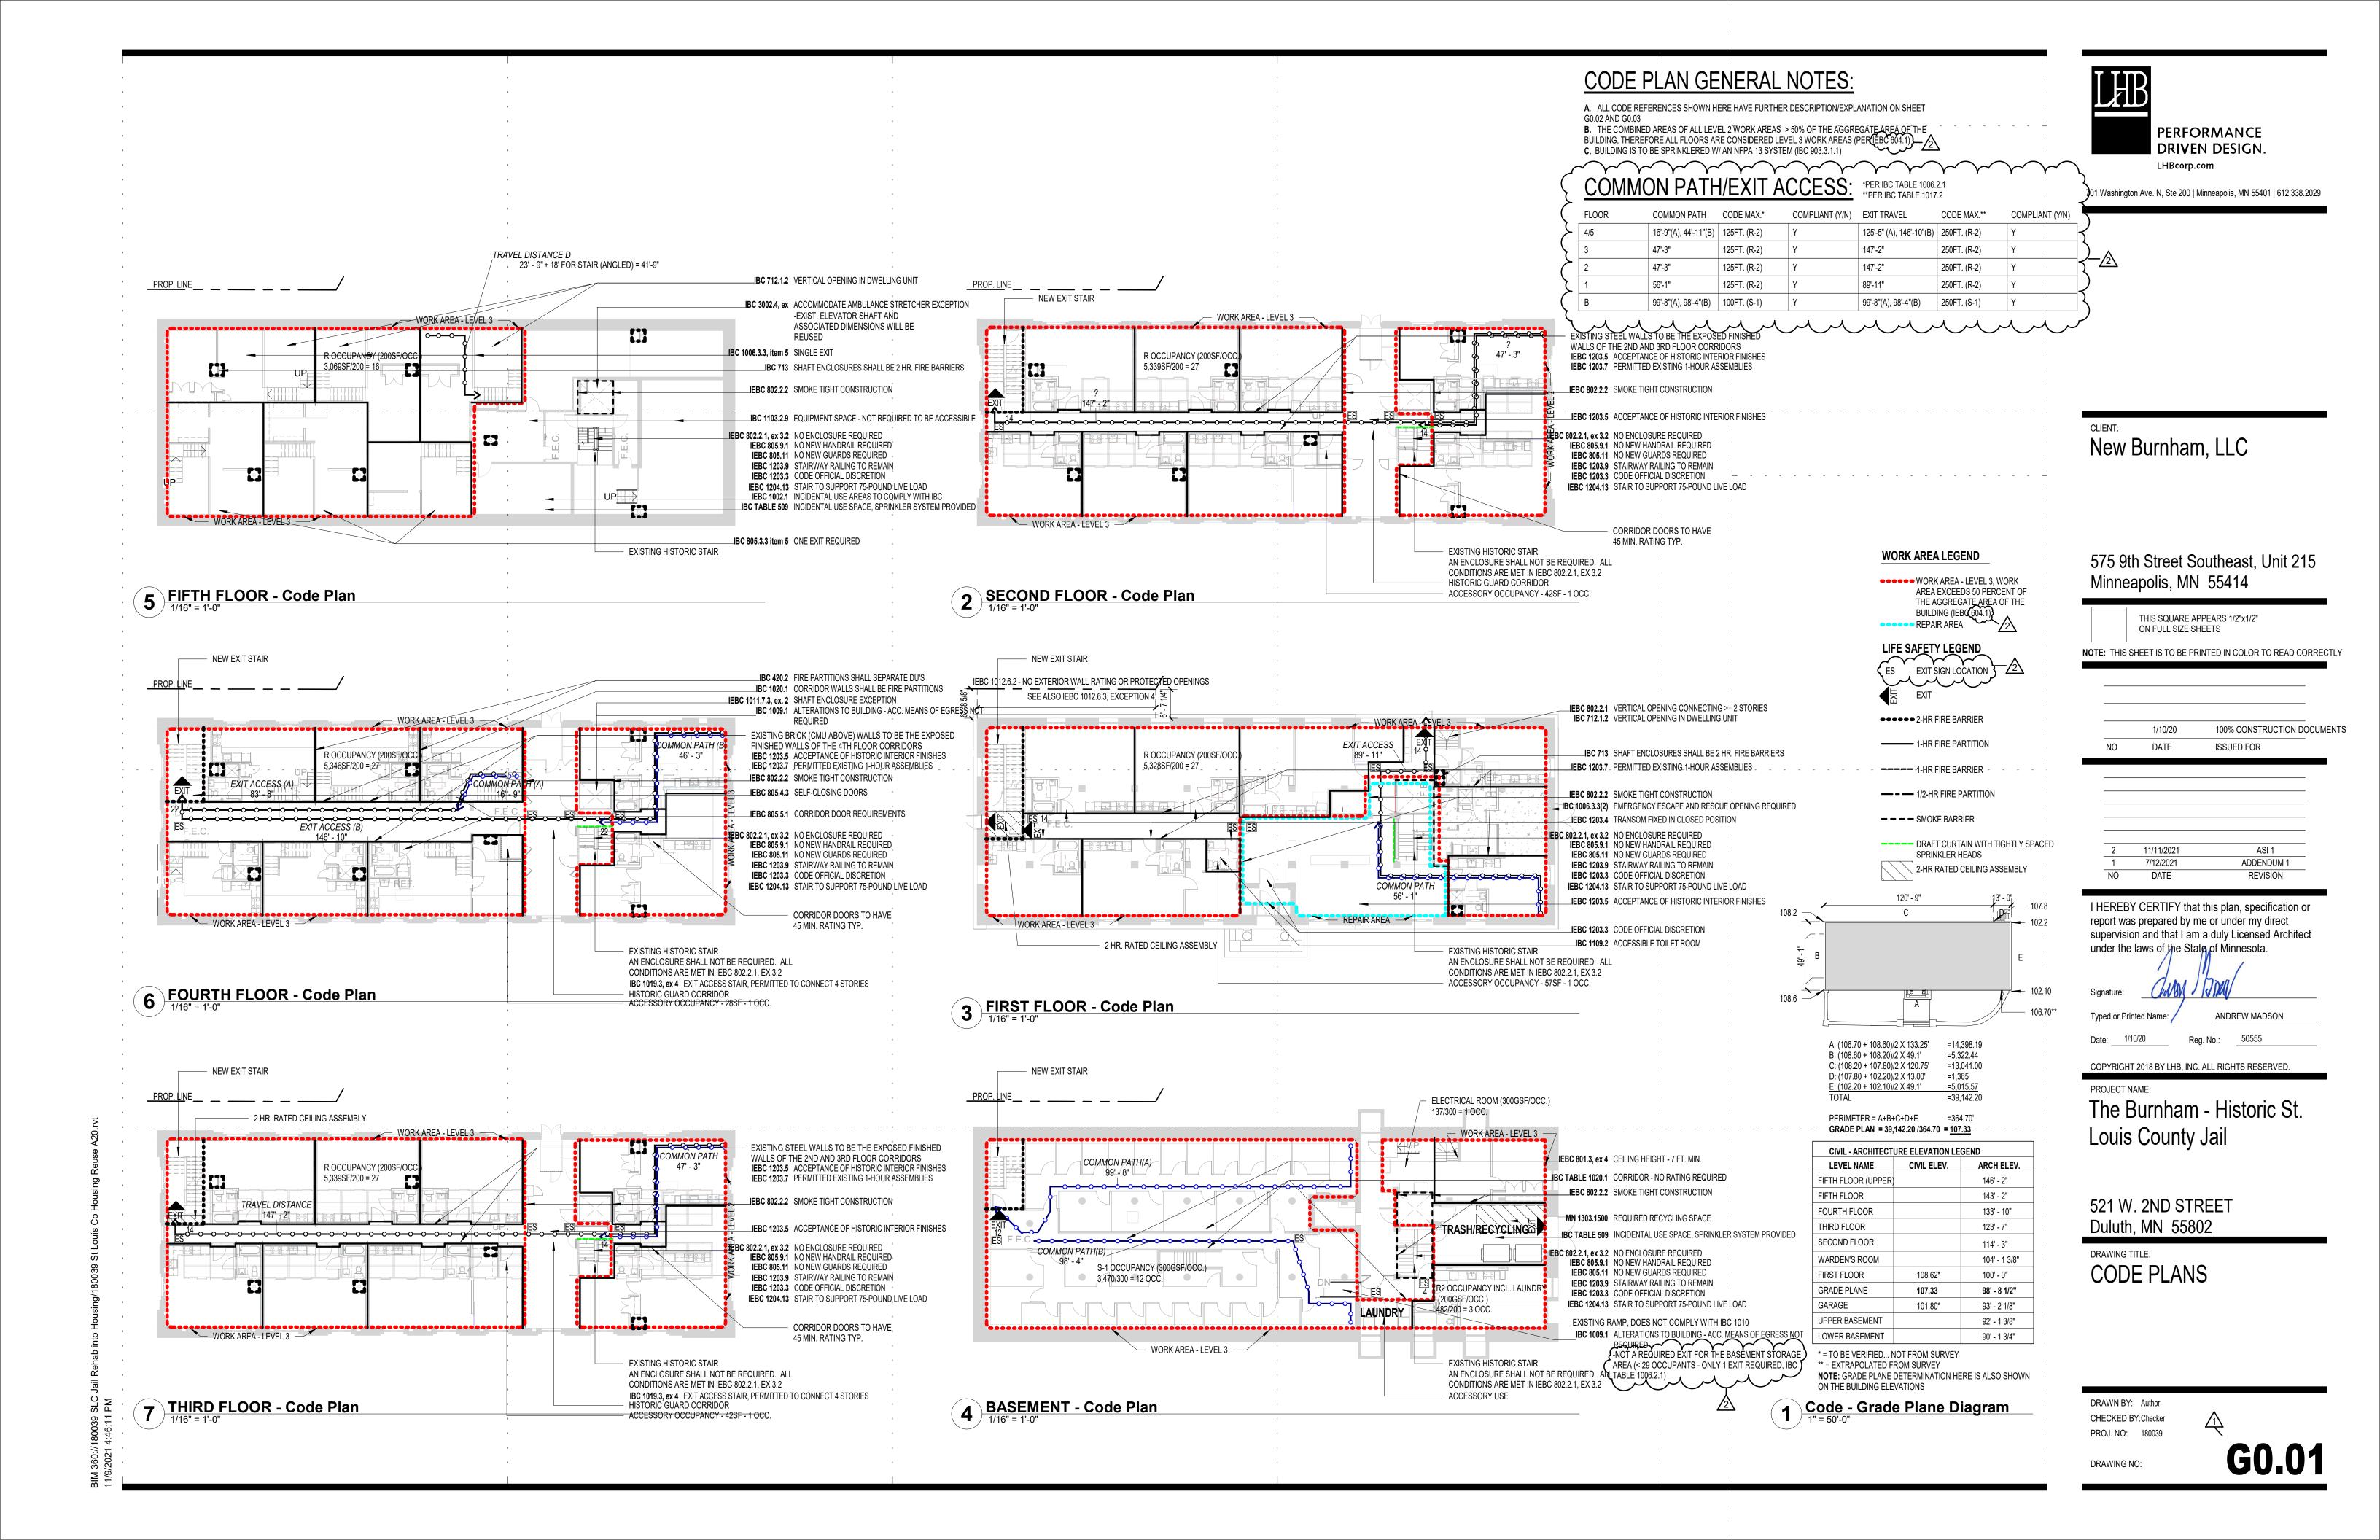

MN Conservation Code for Existing Buildings (referenced as the IEBC in the construction documents) ALL UNDERLINED TEXT IS PROJECT SPECIFIC COMMENTARY

Chapter 3: Provisions for all Compliance Methods

SECTION 301 ADMINISTRATION

301.1 General – The repair, alteration, change of occupancy, of all existing buildings shall comply with Section 301.2, 301.3 or 301.4 **301.2 Repairs** – Repairs shall comply with the requirements of Chapter 4

301.3 Alterations, additions or change of occupancy - The alterations, addition or change of occupancy of all existing buildings shall comply with one of the methods listed in Sections 301.3.1, 301.3.2, 301.3.3. Sections 301.3.1 through 301.3.3 shall not be applied in combination 301.3.2 Work area compliance method - This project will follow this method.... Must comply with the applicable requirements of Chapters

6 through 12 of this coded **SECTION 302 GENERAL PROVISIONS**

302.1 Applicability – The provisions of Section 302 apply to all alterations, repairs and change of occupancy regardless of compliance

302.3 Additional codes – This project must comply with other codes including the following:

Minnesota Energy Code (International Energy Conservation Code) Minnesota State Fire Code (International Fire Code)

Minnesota Mechanical Code (International Fuel Gas Code & International Mechanical Code)

Minnesota Plumbing Code (International Plumbing Code) MPCA minimum standards and criteria for individual sewage treatment systems (International Private Sewage Disposal Code)

302.3.1 Window Cleaning Anchors - Shall comply with the Minnesota Building Code Window Cleaning anchors are not provided on this project as we are not exposing the main structural components of the roof. We are tapping into the structural members for the installation of the rooftop mechanicals and installing skylights

302.4 Existing materials - Materials already in used in a building in compliance with requirements or approvals in effect at the time of their erection or installation shall be permitted to remain in use unless determined by the building official to be unsafe. 302.5 New and Replacement materials - Except as otherwise required or permitted by this code, materials permitted by the applicable code for new construction shall be used. Like materials shall be permitted for repairs and alterations, provided that unsafe conditions are not

SECTION 305 ACCESSIBILITY FOR EXISTING BUILDINGS General – Existing buildings or portions of existing buildings undergoing change of occupancy, alterations due to substantial improvements shall be made accessible to persons with disabilities as required by MN rules, Chapter 1341

Chapter 4: Repairs

401.1 Scope – Repairs to historic buildings need only comply with Chapter 12 Building has an area designated as a repair area at the

Chapter 6: Classification of Work

Section 601 General 601.1 Scope – The provisions of this chapter shall be used in conjunction with Chapters 7 through 12. The work performed on an existing

building shall be classified in accordance with this chapter **601.2 Work Area** – The work area shall be identified on the construction documents Section 603 Alteration – Level 2

603.1 Scope – Level 2 alterations include the reconfiguration of space, the addition or elimination of any door or window, the reconfiguration or extension of any system, or the installation of any additional equipment. 603.2 Application – Level 2 alterations shall comply with the provisions of Chapter 7 for Level 1 alterations as well as the provisions of

Section 604 Alteration – Level 3 604.1 Scope – Level 3 alterations apply where the work area exceeds 50 percent of the aggregate area of the building. Work area > 50%

for this project, therefore all alterations are considered level 3 604.2 Application - Level 3 alterations shall comply with the provisions of Chapters 7 and 8 for Level 1 and 2 alterations, respectively, as well as provisions of Chapter 9 Section 605 Change of Occupancy

605.1 Scope – <u>Building is changing occupancy type from I-3 condition 5 (Jail) to R-2 (Apartment House)</u>

605.2 Application - Changes of occupancy shall comply with the provisions of Chapter 10. Section 607 Historic Buildings

607.1 Scope – This building fits the definition of historic building

607.2 Application - Except as specifically provided for in Chapter 12, historic buildings shall comply with the applicable provisions of this code for the type of the work being performed

Chapter 7: Alterations – Level 1 - No level 1 alterations are being proposed on this project, but compliance with chapter 7 is required of Level 2 alterations per 801.2 Section 701 General

701.1 Scope - Level 1 alterations to historic buildings shall comply with this chapter, except as modified in Chapter 12. Section 702 Building-Elements and Materials

702.1 Interior Finishes - All newly installed interior wall and ceiling finishes shall comply with IBC Chapter 8. 702.2 interior Floor Finish – New interior floor finish, including new carpeting used as an interior floor finish material, shall comply with

702.3 Interior Trim – All newly installed interior trim materials shall comply Section 806 of the IBC 702.4 Window opening control devices on replacement windows – WOCDs shall be installed on replacement windows 702.5 Replacement window emergency escape and rescue openings - Window opening control devices shall be permitted for use on

windows required to provide emergency escape and rescue openings 702.6 Materials and Methods - All new work shall comply with the materials and methods requirements in the IBC, IECC, IMC, IPC, as applicable, that specify material standards, detail of installation and connection, joints, penetrations, and continuity of any element, component, or system in the building.

Chapter 8: Alterations - Level 2

Section 801 General 801.1 Scope - Level 2 alterations as described in IEBC Section 603 shall comply with the requirements of this chapter

801.2 Alteration Level 1 compliance – In addition to the requirements of this chapter, all work shall comply with the requirements of 801.3 Compliance – All new construction elements, components, systems, and spaces shall comply with the requirements of the IBC. Exceptions:

2. Newly installed electrical equipment shall comply with the requirements of Section 807. 4. The minimum ceiling height of the newly created habitable and occupiable spaces and corridors shall be 7 feet. Section 802 Building elements and materials

802.2.1 Existing vertical openings (referenced by 903.1) – All existing interior vertical openings connecting 2 or more floors shall be enclosed with approved assemblies having a fire-resistance rating of not less than 1 hour with approved opening protectives. Exception 1 - Where vertical enclosure is not required by the IBC or IFC The historic stair within the building will be considered an exit access stair and subject to the requirements of the IBC

RException 3.2 – The enclosure shall not be required where all of the following conditions are met **3.2.1** – low hazard occupancy and protected throughout by a sprinkler system

3.2.2 – the next to lowest level is a street floor

3.2.3 - Area is open and unobstructed 3.2.4 – exit capacity is sufficient to provide egress simultaneously for all occupants as if the building was a single floor Total stair width in inches (sprinklered): Total Occupant load/2 x 0.2* Total Occupant Load = from IBC Section 1004

Total other egress width in inches (sprinklered): Occupant load/2 x 0.15*

156/2 x 0.2" = 15.6" 3.2.5 - Each floor has at least one-half of its exit capacity provided by an exit leading directly out of that level The project meets all 5 of these conditions, but the east existing stair within the building is adhering to the more restrictive compliance of the exit access stair

802.2.2 Supplemental shaft and floor opening enclosure requirements – Where the work area on any floor exceeds 50 percent of that floor area, the enclosure requirements of Section 802.2 shall apply to vertical openings other than stairways throughout the floor. This building has other vertical openings including an elevator shaft and an existing dumbwaiter 802.2.3 Supplemental stairway enclosure requirements – Where the work area on any floor exceeds 50 percent of that floor area,

stairways that are part of the means of egress serving the work area shall, at a minimum, be enclosed with smoke-tight construction on the highest work area floor and all floors below. The stairway is open to the corridor on floors 1, 2, 3, and 4. The corridor walls act as the smoke tight construction enclosing the stair. The stair will also have a draft curtain installed in line with the top risers of the stair per the requirements for an exit 802.4 Interior finish - The interior finish of walls and ceilings in exits and corridors in any work area shall comply with the requirements of

the IBC Exception - Existing interior finish materials that do not comply with the interior finish requirements of the IBC shall be permitted to be treated with an approved fire retardant coating in accordance with the manufacturer's instruction to achieve the rating. **802.4.1 Supplemental interior finish requirements** – Where the work area on any floor exceeds 50 percent of the floor area, Section 802.4 shall also apply to the interior finish in exits and corridors serving the work area throughout the floor. **Section 803 Fire Protection**

803.1 Scope - The requirements of this section shall be limited to work areas in which Level 2 alterations are being performed, and where specified they shall apply throughout the floor on which the work areas are located or otherwise beyond the work area 803.1.1 Corridor ratings – Where an approved sprinkler system is installed throughout the story, the required fire-resistance rating for any corridor located on the story shall be permitted to be reduced in accordance with the IBC (IBC table1020.1). In order to be considered for a corridor rating reduction, such system shall provide coverage for the stairwell landings serving the floor and the intermediate landings immediately below. Project is declining this reduction of rating to not trigger enhanced sprinkling. Clearances within the existing historic staircase are tight.

803.2 Automatic sprinkler systems – NFPA 13 Sprinkler system shall be installed. 803.2.3 Windowless stories - Work located in a windowless story, as determined in accordance with the IBC, shall be sprinklered where the work area is required to be sprinklered under the provisions of the IBC for newly constructed buildings. 803.3 Standpipes - Shall be installed where the work area is located 50 feet above the lowest level of fire dept. access. The lowest access point on the project is the garage (elev. 93'-2 1/8") and the highest level of work area is the 5th floor (elev. 143'-2"). The elevation difference is 49'-11 7/8". The Duluth fire marshall has indicated that they want to have standpipes installed at both stairs on the project (existing and new)

803.4.3 Smoke alarms - dwelling units an any work area shall be provided with smoke alarms in accordance with the International Fire Section 805 Means of Egress 805.1 Scope – The requirements of this section shall be limited to work areas that include exits or corridors within the work area in which Level 2 alterations are being performed, and where specified they shall apply throughout the floor on which the work areas are located or otherwise

805.3 Number of exits – the number of exits shall be in accordance with Sections 805.3.1 through 805.3.3 805.3.1 Minimum number - Every story utilized for human occupancy on which there is a work area that includes exits or corridors shared by more than one tenant within the work area shall be provided with the minimum number of exits based on the occupancy and the occupant load in accordance with the IBC. In addition, the exits shall comply with Sections 805.3.1.1 and 805.3.1.2.

R805.4.3 Door closing – In any work area, all doors opening onto an exit passageway at grade or an exit stair shall be self-closing or automatic-closing by listed closing devices. Exceptions:

Where exit enclosure is not required by the IBC Means of egress within or serving only a tenant space that is entirely outside the work area 805.4.3.1 Supplemental requirements for door closing – Where the work area exceeds 50% of the floor area, doors shall comply with Section 805.4.3 throughout the exit stair from the work area to, and including, the level of exit discharge.

805.5 Openings in corridor walls – Openings in corridor walls in any work area shall comply with Sections 805.5.1 through 805.5.4 R805.5.1 Corridor doors – Corridor doors in the work area shall not be hollow core, or contain louvers. For R-2, they shall be at least 1 3/8" sold core wood and shall not have any glass panels, other than approved wired glass or other approved glazing material in metal frames. They shall be equipped with door closers. All replacement doors shall be 1 3/4" solid bonded wood core or approved equivalent, unless the existing frame will accommodate only a 1 3/8" door.

Exceptions: Corridor doors within a dwelling unit

If sprinkler system, doors required only to resist smoke, be tight fitting and no louvers

Door assemblies having a fire protection rating of not less than 20 minutes 805.5.2 Transoms - See sections 1203.4 and 1204.8

805.5.3 Other corridor openings - In any work area, any other sash, grille, or opening in a corridor and any window in a corridor not opening to the outside air shall be sealed with materials consistent with the corridor construction. 805.5.3.1 Supplemental requirements for other corridor opening -. Where the work area exceeds 50 percent of the floor area, Section 805.5.3 shall be applicable to all corridor windows, grills, sashes, and other opening on the floor.

Exception: Means of egress within or serving only a tenant space that is entirely outside the work area 805.5.4 Supplemental requirements for corridor openings – Where the work area on any floor exceeds 50 percent of the floor area, the requirements of Sections 805.5.1 through 805.5.3 shall apply throughout the floor.

805.7 Means-of-egress lighting - Means of egress lighting shall be in accordance with this section, as applicable 805.7.1 Artificial lighting required – In work areas, artificial lighting shall be per the IBC 805.7.2 Supplemental requirements for means-of-egress lighting – Where work area on a floor > 50 percent of the floor area, means of egress throughout the floor shall comply with Section 805.7.1

805.8 Exit Signs – Exit signs shall be in accordance with this section, as applicable. See also Section 1204.12 805.8.1 Work Areas - Means of egress in all work areas shall be provided with exit signs in accordance with the IBC 805.8.2 Supplemental requirements for exit signs - Where work area on a floor > 50 percent of the floor area, means of egress throughout the floor shall comply with Section 805.8.1

805.9 Handrails - The requirements of Sections 805.9.1 and 805.9.2 shall apply to handrails from the work area floor to, and including, the level of exit discharge R805.9.1 Minimum requirement - Handrail is existing on East Stair, no new handrails will be provided 805.11 Guards - The requirements of Sections 805.11.1 and 805.11.2 shall apply to guards from the work area floor to, and

evel of exit discharge but shall be confined to the egress path of any work area. R805.11.1 Minimum requirement – At East Stair, there are no open portions of stair or landing that is more than 30 inches above the floor or grade below Section 806 Structural

Section 807 Electrical

Section 808 Mechanica

Section 809 Plumbing

Section 810 Energy Conservation See ASHRAE 90.1 2016, 4.2.1.3, Exception a: This project is exempt from compliance with the energy code due to its historic designation.

Chapter 9: Alterations – Level 3 Section 901 General

901.1 Scope - Level 3 alterations as described in Section 604 shall comply with the requirements of this chapter. 901.2 Compliance - In addition to the provisions of this chapter, work shall comply with all of the requirements of Chapters 7 and 8. The requirements of Sections 802 through 805 shall apply within all work areas whether or not they include exits and corridors shared by more than one tenant and regardless of the occupant load Section 902 Special Use and Occupancy

902.2 Boiler and furnace equipment rooms – Boiler and furnace rooms within multi-dwelling facilities shall be enclosed by a 1 hr. fire

Exception 4 – Furnace rooms protected with automatic sprinkler protection

Section 903 Building Elements and Materials 903.1 Existing shafts and vertical openings – Existing stairways that are part of the means of egress shall be enclosed in accordance with Section 802.2.1 from the highest work area floor to, and including, the level of exit discharge and all floors below.

Section 905 Means of Egress 905.1 General - The means of egress shall comply with the requirements of Section 805 except as specifically required in Sections 905.2 905.2 Means-of-egress lighting - Means of egress from the highest work area floor to the floor of exit discharge shall be provided with

artificial lighting within the exit enclosure in accordance with the requirements of the IBC. 905.3 Exit signs - Means of egress from the highest work area floor to the floor of exit discharge shall be provided with exit signs in accordance with the requirements of the IBC.

Chapter 10: Change of Occupancy

Section 1001 General 1001.1 Scope – The provisions of this chapter shall apply where a change of occupancy occurs, as defined in Section 202 1002.1 Compliance with the building code –Incidental use areas must comply with the IBC Section 1003 Building Elements and Materials

1003.1 General - Building elements and materials in portions of building undergoing a change of occupancy classifications shall comply with Section 101 Section 1004 Fire Protection

1004.1 General – Fire protection requirements of Section 1011 shall apply where a building or portions thereof undergo a change of

1005.1 General – Means of egress in portions of buildings undergoing a change of occupancy classification shall comply with Section 1011 Section 1007 Electrical 1007.3 Service upgrade – Whe're the occupancy of an existing building or part of an existing building is change, electrical service shall be upgraded to meet the requirements of NFPA 70 for the new occupancy

of electrical outlets shall comply with NFPA 70 for the new occupancy 1008.1 Mechanical requirements - If the new occupancy is subject to different kitchen exhaust or mechanical ventilation requirements in accordance with the International Mechanical Code, the new occupancy shall comply with the intent of the respective International Mechanical Code

1007.4 Number of electrical outlets – Where the occupancy of an existing building or part of an existing building is changed, the number

Section 1009 Plumbina 1009.1 Increased demand - If the new occupancy is subject to increased plumbing fixture requirements in accordance with MN rules, Chapter 1305, or to increased water supply requirements in accordance with MN rules, Chapter 4714, the new occupancy shall comply with MN rules. Chapter 4714

Section 1010 Other requirements 1010.1 Light and ventilation - Light and ventilation shall comply with the requirements for the IBC for the new occupancy

Section 1011 Change of occupancy classification 1011.1.1 Compliance with Chapter 9 - The requirements of Chapter 9 shall be applicable throughout the building for the new occupancy classification based on the separation conditions set forth in Sections 1011.1.1.1 and 1011.1.1.2 1011.1.1.1 Change of occupancy classification without separation – <u>Building will not have any separations in the building.</u> Chapter 9 shall be applied throughout the building for an R-2 use and the requirements of this chapter

1011.1.2 Fire protection and interior finish – The provisions of Sections 1011.2 and 1011.3 for fire protection and interior finish shall apply to all buildings undergoing a change of occupancy classification 1011.1.3 Change of occupancy classification based on hazard category – Degree of hazard between different occupancy classifications shall be determined in accordance with the categories specified in Tables 1011.4, 1011.5, 1011.6. Such a determination shall be the

basis for the application of Sections 1011.4 through 1011.7 1011.2 Fire protection systems – Fire protection systems shall be provided in accordance with Sections 1011.2.1 and 1011.2.2

1011.2.1 Fire sprinkler system – Sprinkler system shall be installed throughout the area where the change of occupancy occurs. Building shall have an NFPA 13 system installed **I011.2.2 Fire alarm and detection system** – fire alarm and detection system to be provided based on the new occupancy in accordance with Chapter 9 of the IBC, such system shall be provided throughout the area where the change of occupancy occurs. Existing alarm notification appliances shall be automatically activated throughout the building. Where the building is not equipped with a fire alarm system, alarm notification appliances shall be provided throughout the area where the change of occupancy occurs and shall be automatically activated. 1011.3 Interior finish – In areas of the building undergoing the change of occupancy classification, the interior finish of walls and ceilings

shall comply with the requirements of the IBC for the new occupancy classification **1011.4 Means of egress, general** – Hazard category from table 1011.4: -3 = 2, R-2 = 3; relative hazard is lower than previous occupancy 1011.4.2 Means of egress for change of use to equal or lower hazard category – Existing elements of the means of egress shall comply with the requirements of Section 905 for the new occupancy classification. Newly constructed or configured means of egress shall comply

with IBC chapter 10. Stair @ NW will comply w/ IBC chapter 10 1011.4.3 Egress capacity - Egress capacity shall meet or exceed the occupant load as specified in the IBC for the new occupancy.

1011.4.4 Handrails – See Section 805.9 1011.4.5 Guards - See Section 805.11

1011.5 Heights and Areas – Hazard category from table 1011.5 I = 2, R-2 = 2; relative hazard is equal to previous occupancy

1011.5.2 Height and area for change to equal or lesser hazard category – When a change of occupancy classification is made to an equal or lesser hazard category as shown in Table 1011.5, the height and area of the existing building shall be deemed acceptable. 1011.6 Exterior wall fire-resistance ratings - Hazard categories in regard to fire-resistance ratings of exterior walls shall be in accordance with Table 1011.6 Condition of plaster walls at exterior are in bad shape typically. Most exterior wall locations will receive furred walls for new finish. surface and routing of electrical. All historic areas within the building will receive plaster repair at the exterior walls.

3, R = 3; relative hazárd is equal to previous occupancy 1011.6.2 Exterior wall rating for change of occupancy classification to an equal or lesser hazard category – When a change of occupancy classification is made to an equal or lesser hazard category as shown in Table 1011.6, existing exterior walls, including openings,

1011.6.3 Opening protectives – Per IBC Exception 4 – Exterior opening protectives are not required when the change of occupancy group is to an equal or lower hazard classification in accordance with Table 1011.6

1011.7 Enclosure of vertical shafts – Enclosure of vertical shafts shall be in accordance with Sections 1011.7.1 through 1011.7.4 1011.7.1 Minimum requirements – Vertical shafts shall be designed to meet the IBC requirements for atriums or the requirements of this section. Even though this project has a lesser relative hazard classification per Table 1011.4, project will adhere to the stricter path designated for occupancy classification that is made to a higher hazard category per 1011. 1011.7.2 Stairways – When a change of occupancy classification is made to a higher hazard category as shown in Table 1011.4. interior stairways shall be enclosed as required by the IBC (See IBC 1019.3, exception 4) 1011.7.3 Other vertical shafts – Interior vertical shafts other than stairways, including but not limited to elevator hoistways and

Exception 2 - Vertical openings, other than stairways, connecting less than six stories shall not be required to be enclosed if the entire building is provided with an approved automatic sprinkler system. Elevator connects less than six stories. NFPA 13 sprinkler will be installed. Shaft will be capped at the top of the equipment room above the 4th floor elevator shaft overrun.

service and utility shafts, shall be enclosed as required by the IBC when there is a change of use to a higher hazard category as specified in Table

Chapter 12: Historic Buildings Section 1202 Repairs

1202.1 General – Repairs to any portion of a historic building or structure shall be permitted with original or like materials and original

1202.2 Replacement – Replacement of existing or missing features using the original materials shall be permitted. Replacement glazing in nazardous location shall comply with the safety glazing requirements of Chapter 24 of the IBC

1203.2 General - Every historic building that does not conform to the construction requirements specified in this code for the occupancy or use and that constitutes a distinct fire hazard as defined herein shall be provided with an approved automatic fire-extinguishing system as determined appropriate by the code official. The fire-extinguishing system shall not be used as a substitute for or as an alternative to, the required number of exits from any facility. The building will have a NFPA 13 sprinkler system R1203.3 Means of egress - Existing door openings and corridor and stairway widths less than those specified elsewhere in this code may

be approved, provided that, in the opinion of the code official, there is sufficient width and height for a person to pass through the opening or traverse the means of egress. When approved by the code official, the front or main exit doors need not swing in the direction of the path of exit travel, provided that other approved means of egress having sufficient capacity to serve the total occupant load are provided. R1203.4 Transoms – Building will have a NFPA 13 sprinkler, therefore existing transoms in corridors and other fire resistance rated walls <u>may be maintained if fixed in closed position.</u> A sprinkler shall be installed on each side of the transom.

₹1203.5 Interior finishes – The existing finishes of walls and ceiling shall be accepted when it is demonstrated that they are the historic R1203.7 One-hour fire-resistant assemblies – Where 1-hour fire-resistance-rated construction is required by these provisions, it need not be provided, regardless of construction or occupancy, where the existing wall and ceiling finish is wood or metal lath and plaster. R1203.9 Stairway railings – Existing handrails and guards at all stairs shall be permitted to remain, provided they are not structurally

1203.12 Automatic fire-extinguishing systems – Every historical building that cannot be made to conform to the construction requirements specified in the IBC code for the occupancy or use and that constitutes a distinct fire hazard shall be deemed to be in compliance if provided with an approved automatic fire-extinguishing system.

Section 1204 Change of Occupancy 1204.1 General - Historic buildings undergoing a change of occupancy shall comply with the applicable provisions of Chapter 10, except as ' specifically permitted in this chapter. When chapter 10 requires compliance with specific requirements of Chapter 7, Chapter 8 or Chapter 9 and when those requirements are subject to the exceptions in Section 1202, the same exceptions shall apply to this section. 1204.12 Exit Signs - The code official may accept alternative exit sign locations where such signs would damage the historic character of

R1204.13 Exit stair live load – Existing historic stairways in buildings changed to a Group R-2 occupancy shall be accepted where it can be shown that the stairway can support a 75-pounds-per-square-foot live load.

* requires either a NFPA 13 (903.3.1.1) or a NFPA 13R (903.3.1.2) fire sprinkler system **requires an NFPA 13 (903.3.1.1) fire sprinkler system

PERFORMANCE DRIVEN DESIGN. LHBcorp.com

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New Burnham, LLC

575 9th Street Southeast, Unit 215 Minneapolis, MN 55414

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ASI 1 7/12/2021 ADDENDUM 1

I HEREBY CERTIFY that this plan, specification or report was prepared by me or under my direct supervision and that I am a duly Licensed Architect under the laws of the State of Minnesota

nature:	Charley	1 WINU
ed or Printe	ed Name:	ANDREW MAD

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PROJECT NAME:

The Burnham - Historic St Louis County Jail

521 W. 2ND STREET Duluth, MN 55802

DRAWING TITLE: **CODE REVIEW - IEBC**

DRAWN BY: Author CHECKED BY: PROJ. NO: 180039

```
MN Building Code (referenced as the IBC in the construction documents)
  ALL UNDERLINED TEXT IS PROJECT SPECIFIC COMMENTARY
  Codes and Standards Utilized:
         2020 Minnesota State Building Code (2018 International Building Code w/ MN amendments)
        2020 Minnesota Accessibility Code
        2020 Minnesota Energy Code (2018 International Energy Conservation Code (IECC) with MN amendments)
                       -Commercial Energy Code
        2020 Minnesota Fire Code
        2020 Minnesota Conservation Code for Existing Buildings (2018 International Existing Building Code w/ MN amendments)
  2020 Minnesota Provisions
  1303.1500 Recycling Space
         Apartment, office and storage area – 38,464 gsf x .0025 = 96SF
        Mechanical/Electrical rooms 2633 gsf x .001 = 2.6SF
         Total required recycling area = 98.6SF This area is shown on the code plan in the trash room
  1303.2400 Radon
        This building is exempt from the radon requirements as it is an existing structure
  Chapter 3: Occupancy Classification and Use – This building will have a change in use from I-3, condition 5 jail to R-2 apartment house
 302 Occupancy Classification and Use Designation
         303.1.2 Small assembly spaces - The following spaces shall not be classified as Assembly occupancies:
               -A room or space used for assembly purposes with an occupant load of less than 50 person and accessory to another occupancy
  shall be classified as a Group B occupancy or as part of that occupancy This project is identifying the lobby and guard corridors as accessory to the
  R-2 occupancy and classifying it as R-2 space
         310.3 - Group R-2 - Residential, Apartment House
        304 – Group B - Business Office (accessory to R-2 per 508.2)
                303.1.2 - Group B - a space used for assembly purposes with an occupant load of less than 50 person and accessory to another
  occupancy shall be classified as a Group B occupancy or as part of that occupancy
  Chapter 4: Special Detailed Requirements Based on Occupancy and Use

    420.2 Separation Walls-

        Fire partitions (see Section 708) shall separate dwelling units from other dwelling units as well as other occupancies within the building. All
        dwelling units are separated by 1 hour fire partitions.
  420.3 Horizontal Separation
         Horizontal assemblies (see Section 711) shall separate dwelling and sleeping units from other dwelling and sleeping units as well as other
        occupancies within the building. All dwelling units are separated by 1 hour horizontal assemblies
         Group R occupancies shall be equipped throughout with an automatic sprinkler system in accordance with Section 903.2.8 and 903.3.2.
         Note: The requirements of this section are exceeded by the use of a NFPA 13 system per 903.3.1.1
  420.5 Fire Alarm Systems and smoke alarms
        Fire alarm systems and smoke alarms shall be provided in group R-2 occupancies in accordance with Sections 907.2.6, 907.2.8, 907.2.9
  Chapter 5: General Building Heights and Areas
 Section 503 General Building Height and Area Limitations
        NOTE: Height and Area determined per IEBC 1011.5.2
  508.2 Accessory occupancies
         Laundry (006), Toilet (109) on first floor, Storage (110) on first floor, Electrical (209, 309), Storage (409), Janitor (410) are all considered
  accessory spaces. The lobby at first floor and guard corridors on 2<sup>nd</sup>, 3<sup>rd</sup> and 4<sup>th</sup> serve assembly purposes but are less than 50 occupants and less
         Allowable area = 10% of floor area (625 sf) or per table 506.2 (18,000 sf) whichever is less.
        Allowable height = In accordance to Section 504 for the main occupancy of the building
         No separation required between accessory occupancies and the main occupancy, exception 2 - R-2 dwelling units shall be separated from
  other dwelling units and from accessory occupancies contiguous to them in accordance with IBC 420 (1 hour fire partition)
  508.3 Non-separated occupancies – Not applicable
  509 Incidental Uses – Project has 2 incidental use spaces
         0 hour* - Rooms with boilers where equipment is over 15 psi & 10 horsepower shall have a smoke separation
        0 hour* – Waste collection rooms over 100 square feet shall have a smoke separation
  Chapter 6: Types of Construction
  Table 601 Fire-Resistance Rating Requirements for Building Elements
         Primary structural frame:
                                             2 hour (Criteria satisfied per IEBC 1011.6)
         Exterior bearing walls
                                             0 hour - or as required by other parts of the code, noted below
        Interior bearing walls
        Exterior non-bearing walls
                                             0 hour (Criteria satisfied per IEBC 1011.
         Interior non-bearing walls
                                             0 hour - or as required by other parts of the code, noted below
        Floor construction
                                             0 hour - or as required by other parts of the code, noted below
         Roof construction
                                              1 hour (Sections 420.2 & 708); fire partition
        Dwelling separation
         Horizontal separation
                                              1 hour (Sections 420.3 & 711)
```

Chapter 7: Fire-Resistance-Rated Construction

SECTION 705 EXTERIOR WALLS Table 705.8 Openings -

Elevator equipment room

Shafts & vertical exit er

Interior Exit stairways

Corridors

Trash rooms

Laundry rooms

Boiler rooms

Opening protectives are not required when the change of occupancy group is to an equal or lower hazard classification in accordance with

2 hour (connecting 4 stories - Section 1023.2); fire barrier

0 hour* with smoke separation if over 100 sf (Section 509)

0 hour* with smoke separation if over 100 sf (Section 509)

0 hour* with smoke separation if over 100 sf (Section 509)

2 hour if abutting hoistway it serves (Section 3005.4)

hour Declining 30 minute rating per (Table 1020.1- for sprinklered building) and IEBC 803.1.1

2 hour (connecting 4 stories

SECTION 707 FIRE BARRIERS 707.3.1 Shaft enclosures – 2 hour where connecting 4 stories or more (713.4)

707.3.2 Interior exit stairway – 2 hour (1023.1)

707.5 Continuity – Fire barriers shall extend from the top of the foundation or floor/ceiling assembly below to the underside of the floor or

roof sheathing, slab or deck above.

SECTION 708 FIRE PARTITIONS 708.3 Shall have a fire resistance rating of not less than 1 hour. Exception 1: Corridor walls are permitted to have a ½ hour* fire-resistance rating per Table 1020.1 Project is declining this reduction

of rating to not trigger enhanced sprinkling per IEBC 803.1. Exception 2: DU's in buildings of Types IIIB construction shall have fire-resistance ratings of not less than ½ hour in buildings equipped throughout with an NFPA 13 sprinkler system in accordance with 903.3.1.1

SECTION 711 FLOOR AND ROOF ASSEMBLIES

Shall have a fire resistance rating of not less than 1 hour. Almost all horizontal assemblies are existing on the project and are confirmed by use of table 722 to be 1 hour rated min.

SECTION 713 SHAFT ENCLOSURES 713.4 Fire-resistance rating - Shall have a fire resistance rating of not less than 2 hours (connecting 4 stories or more)

713.7 Openings - Protect per section 716 as required for fire barriers. Doors shall be self- or automatic-closing by smoke detection in

SECTION 716 OPENING PROTECTIVES

716.1.2 Glazing - Glazing used in fire door and fire window assemblies shall comply with this section in addition to the requirements of 716.1.2.2 Marking fire-rated glazing assemblies – Fire-rated glazing assemblies shall be marked in accordance with Tables 716.1(1), 716.1(2) and 716.1(3)

716.2.3 Fire Doors

Fire doors installed within a fire door assembly shall meet the fire rating indicated in Table 716.1(2)

716.2.6.6 Smoke-activated doors

Automatic closing doors installed in the following locations shall be permitted to have hold-open devices. Doors shall automatically close by the actuation of smoke detectors installed in accordance with Section 907.3 or by loss of power to the smoke detector or hold-open device. fire barriers (Section 707.6), fire partitions (Section 708.6) Shaft enclosures (Section 713.7)

Chapter 8: Interior Finishes Table 803.13, Group R-2, Sprinklered

Interior exit stairways Corridors Rooms & enclosed spaces

Chapter 9: Fire Protection and Life Safety Systems SECTION 903 AUTOMATIC SPRINKLER SYSTEMS

An automatic sprinkler system shall be provided throughout all stories per the requirements of Chapter 9 as required 903.2.8 Group R - Building area (work area) is larger than 4,500sf, requires an automatic sprinkler system. 903.3.1.1 NFPA 13 sprinkler system - to be provided as building is more than 4 stories in height

SECTION 905 STANDPIPE SYSTEMS See IEBC 803.3

SECTION 906 PORTABLE FIRE EXTINGUISHERS

906.1 - Shall be provided in occupancies and locations as required by the Minnesota State Fire Code Table 906.3(1) – Size and distribution 4 extinguishers required minimum (1 per 11,250 sf)

Chapter 10: Means of Egress **SECTION 1004 OCCUPANT LOAD**

Fourth floor = Third floor = Second floor = First floor = Basement = Total Occupant Load =

Maximum travel distance of 75'

SECTION 1005 MEANS OF EGRESS SIZING

1005.2 Minimum width based on component - shall be not less than that specified for such component elsewhere in this code 1005.3.1 Stairways - Total stair width in inches (sprinklered): Occupant load/2 x 0.3 NFPA 13 system installed but no emergency voice/alarm

Fourth floor (each stair) = (22 occupants x 0.3) = 6.6" Third floor (each stair) = $(14 \text{ occupants } \times 0.3) = 4.2$ " Second floor (each stair) = $(14 \text{ occupants } \times 0.3) = 4.2$ " First floor = $(14 \text{ occupants } \times 0.3) = 4.2$ " Basement (plan west stair) = $(12 \text{ occupants } \times 0.3) = 3.6$ " Basement (plan east stair) = $(4 \text{ occupants } \times 0.3) = 1.2$ "

1005.3.2 Other egress components - Total other egress width in inches (sprinklered): Occupant load/2 x 0.2* NFPA 13 system installed but no emergency voice/alarm communication system

Third floor = $(14 \text{ occupants } \times 0.2) = 2.8$ Second floor = $(14 \text{ occupants } \times 0.2) = 2.8$ First floor = $(14 \text{ occupants } \times 0.2) = 2.8$ Basement (plan west stair) = $(12 \text{ occupants } \times 0.2) = 2.4$ " Basement (plan east stair) = $(4 \text{ occupants } \times 0.2) = .8$ "

SECTION 1006 NUMBER OF EXITS AND EXIT ACCESS DOORWAYS

Table 1006.2.1 – Maximum common path of egress travel distance – 125'* (R-2)

1006.2.2.1 Boiler, incinerator and furnace rooms Two exits are required if the area of the room exceeds 500 sf and any fuel-fired equipment exceeds 400,000 Btus input capacity, NOTE: Mech. room is > 500sf, but every piece of equipment is < 400,000 Btus input capacity

Table 1006.3.3(1) Up to 4 dwelling units can be located on the basement, first, second or third floor with access to one exit.* The dwelling unit on the Warden's Office level only has access to 1 exit. This unit must be provided with emergency escape and rescue openings in accordance with Section 1030

SECTION 1007 EXIT AND EXIT ACCESS DOORWAY CONFIGURATION

1007.1.1 Two exits or exit access doorways - exception 2* the separation distance between exit doors or exit access doorways shall not be less than one-third of the length of maximum overall diagonal dimension of the area served

SECTION 1009 ACCESSIBLE MEANS OF EGRESS

1009.1 Accessible means of egress required - Exception 3 Accessible means of egress are not required in alterations to existing buildings NOTE: This is a five story building with an existing elevator that only rose to the 4th floor. The new elevator is proposed to only reach the fourth floor. No emergency power is required for the elevator to be an accessible means of egress since this project is a building alteration and the 5th floor is not an accessible floor as it is mothballed mechanical space (per IBC 1103.2.9). No generator will be provided on this project. 1009.8 Two-way communication - A two-way communication system shall be provided at the elevator landing on each accessible floor that is one or more stories above the story of exit discharge.

SECTION 1010 DOORS, GATES AND TURNSTILES

1010.1 Doors - Means of egress doors shall meet the requirements of Section 1010.

SECTION 1011 STAIRWAYS Applies to the new stair 1011.2 Width – 44" min. Exception 1 – 36" when serving an occupant load of less than 50

1011.3 Headroom – 80" 1011.5 Stair treads and risers – 4"-7" risers, 11" treads

1011.5.4 Dimensional uniformity – 3/8" variance max. between largest and smallest tread/riser

1011.12 Stairway to roof

In buildings four or more stories above grade plane, one stairway shall extend to the roof surface The east exit access stair extends to the

SECTION 1012 RAMPS

1014.2 Height – 34"-38"

1012.2 Slope - Ramps shall be a slope of 1:12 with no vertical rise exceeding 30" max. NOTE: Basement ramp exceeds this max. slope.

Accessible means of egress are not required in alterations to existing buildings (IBC 1009.1, ex 3)

SECTION 1014 HANDRAILS Applies to the new stair 1014.1 Where required - Handrails required for flights of stairs shall comply with section 1011.11, handrails required for ramps shall comply with section 1012.8

SECTION 1016 EXIT ACCESS

1016.2 Egress through intervening spaces – Item 2 Egress from a room or space can pass through adjoining or intervening rooms or areas if they are accessory to one another and provide a discernible path of egress travel to an exit

SECTION 1017 EXIT ACCESS TRAVEL DISTANCE

1017.3 Measurement – Exit access travel distance shall be measured from the most remote point of each room along the natural and unobstructed path of horizontal and vertical egress travel to the entrance to an exit. Interior exit stairways (excluded as part of the total path of travel)

Table 1017.2: R occupancy* = 250' max-

SECTION 1019 EXIT ACCESS STAIRWAYS AND RAMPS' 1019.3 Exit access stairways (included as part of the total path of travel) Floor openings between stories created by exit access stairways shall be

Exception 4 – In R2 occupancy, the exit access stairway are not required to be enclosed provided that the building is equipped throughout with an automatic sprinkler system in accordance with Section 903.3.1.1, the floor opening does not connect more than four stories, the area of the floor opening between stories does not exceed twice the horizontal projected area of the exit access stairway, and the opening is protected by a draft curtain and closely spaced sprinklers in accordance with NFPA 13.

SECTION 1020 CORRIDORS

Table 1020.1 Corridor Fire-Resistance Rating, R Occupancy = 1 hour/30 minute* if occupancy is > 10, 0 hours if occupancy is < 10; see also IEBC 803.1.1 S Occupancy = 1 hour/0minutes* if occupancy load is >=30. The basement corridor is not rated due to the small occupancy count.

Table 1020.2 Minimum Corridor Width = 44" min NOTE: 2nd and 3rd floor Corridors are 4' clear from steel cell wall to steel cell wall.

1020.6 Corridor continuity Fire-resistance-rated corridors shall be continuous from the point of entry to an exit and shall not be interrupted by intervening rooms Exception 1 – Foyers, lobbies or reception rooms less than 1,000 sf per floor aggregate area shall not be construed as intervening rooms if the rooms meet the requirements of this section

SECTION 1030 EMERGENCY ESCAPE AND RESCUE

1030.1 General – In addition to the means of egress required by this chapter, emergency escape and rescue openings shall be provided in Group R Exception 4 – Shall not be required where the building is equipped throughout with an approved automatic sprinkler system* and the means of egress system complies without utilizing the single exit provisions under Section 1006.3.3 Emergency escape and rescue openings are required for unit on Wardens Office Level (unit 112)

Chapter 11: Accessibility

The building and site shall be accessible to persons with physical disabilities per the 2020 Minnesota Accessibility Code

1103.2.9 Equipment Spaces - Spaces frequented only be service personnel for maintenance, repair or occasional monitoring of equipment are not required to comply with this chapter.

1103.2.16 Existing Buildings: Existing buildings shall comply with IEBC Section 305 as amended by MN Rules, part 1341.0030 as applicable

1107.6.2.2.1 Type A units: At least 2% of the dwelling units shall be type A units (per chptr 10 A117.1, Section 1003)

1107.6.2.2.2 Type B units: All non-type A units shall be type B units (per chptr 10 A117.1, Section 1004)

1109.5.1 Drinking fountains, minimum number: R-2 apartment house – no requirement – not required per table 2902.1

1109.9.1 Equity – Accessible facilities and spaces shall be provided with the same storage elements as provided in the similar nonaccessible facilities and spaces The basement tenant storage in the building is not accessible due to the slope of the ramp. The building does include accessible storage space on the fourth floor.

Chapter 12: Interior Environment 1206 Sound Transmission Assemblies separating dwelling units from each other, and from public or service areas, shall have a STC of 50 min (design) or 45 min (field

test) and an IIC of 50 min (design) or 45 min (field test)

1207.2 Minimum ceiling heights Occupiable space, habitable spaces and corridors shall have a ceiling height of not less than 7'-6". See also IEBC 801.3 exception 4.

The building shall be designed and constructed in accordance with the 2020 Minnesota Commercial Energy Code

Every dwelling unit shall have no fewer than one room that shall have not less than 120sf of net floor area.

Commercial building = For this code, all buildings that are not included in the definition of "residential buildings"

Residential building = For this code, includes detached one- and two-family dwellings and multiple single-family dwellings (townhouses) as well as Group R-2, R-3 and R-4 buildings three stories or less in height above grade plane.

C401.2.1 Application to existing buildings: This project will follow the ASHRAE 90.1 path

ASHRAE 90.1

4.2 Compliance

4.2.1.3 Alterations of Existing Buildings Exception a: This project is exempt from compliance with the energy code due to its historic designation.

Group R-2

Chapter 29: Plumbing Systems

Water closets – 1 per dwelling unit Lavatories – 1 per dwelling unit Bathtubs or showers – 1 per dwelling unit Drinking fountains - NA

Other – 1 kitchen sink per dwelling unit; 1 automatic clothes washer connection per dwelling unit

Water closets – 1 per 25 up to 50 Lavatories – 1 per 40 up to 80 Drinking fountains – 1 per 100 Service sink – 1 total

Water closets - 1 per dwelling unit and 1 public to serve B Lavatories – 1 per dwelling unit and 1 public to serve B Bathtubs or showers – 1 per dwelling unit Kitchen sink – 1 per dwelling unit Drinking fountain - None Service sink - Located in closet off guard corridor

Chapter 30: Elevators and Conveying Systems 3002.1 Hoistway enclosure protection - See IEBC 1011.7.3, ex. 2

3002.1.1 Opening Protectives Openings in hoistway enclosures shall be protected as required by IBC chapter 7, exception – The elevator car doors and the associated hoistway enclosure doors at the floor level designated for recall shall be permitted to remain open during a Phase I Emergency Recall Operation.

3002.4 Elevator car to accommodate ambulance stretcher Required for buildings that are four or more stories above grade plane Exception: Minimum inside car dimensions shall not be less than 48" x 48". The project will reuse the existing hoistway and a custom elevator will be sized to fit.

3002.6 Prohibited doors Smoke control doors shall be: on 'hold open' device that is activated for closure by fire or smoke sensing devices and readily openable from the car side without a key, tool, special knowledge or effort when closed.

3005.4 Machine rooms Elevator machine rooms shall be enclosed with fire barriers. The fire-resistance-rating shall not be less than the required rating of the

hoistway enclosure. -2 hours Chapter 34: Existing Structures – Not adopted by MN. See 2020 MN Conservation Code for Existing Buildings

* requires either a NFPA 13R or a NFPA 13 fire sprinkler system (903.3.1.1 or 903.3.1.2) **requires an NFPA 13 fire sprinkler system (903.3.1.1)



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New Burnham, LLC

575 9th Street Southeast. Unit 215 Minneapolis, MN 55414

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supervision and that I am a duly Licensed Arch
under the laws of the State of Minnesota.
// //
d.A. //Dau/

report was prepared by me or under my direct

ANDREW MADSO Typed or Printed Name:

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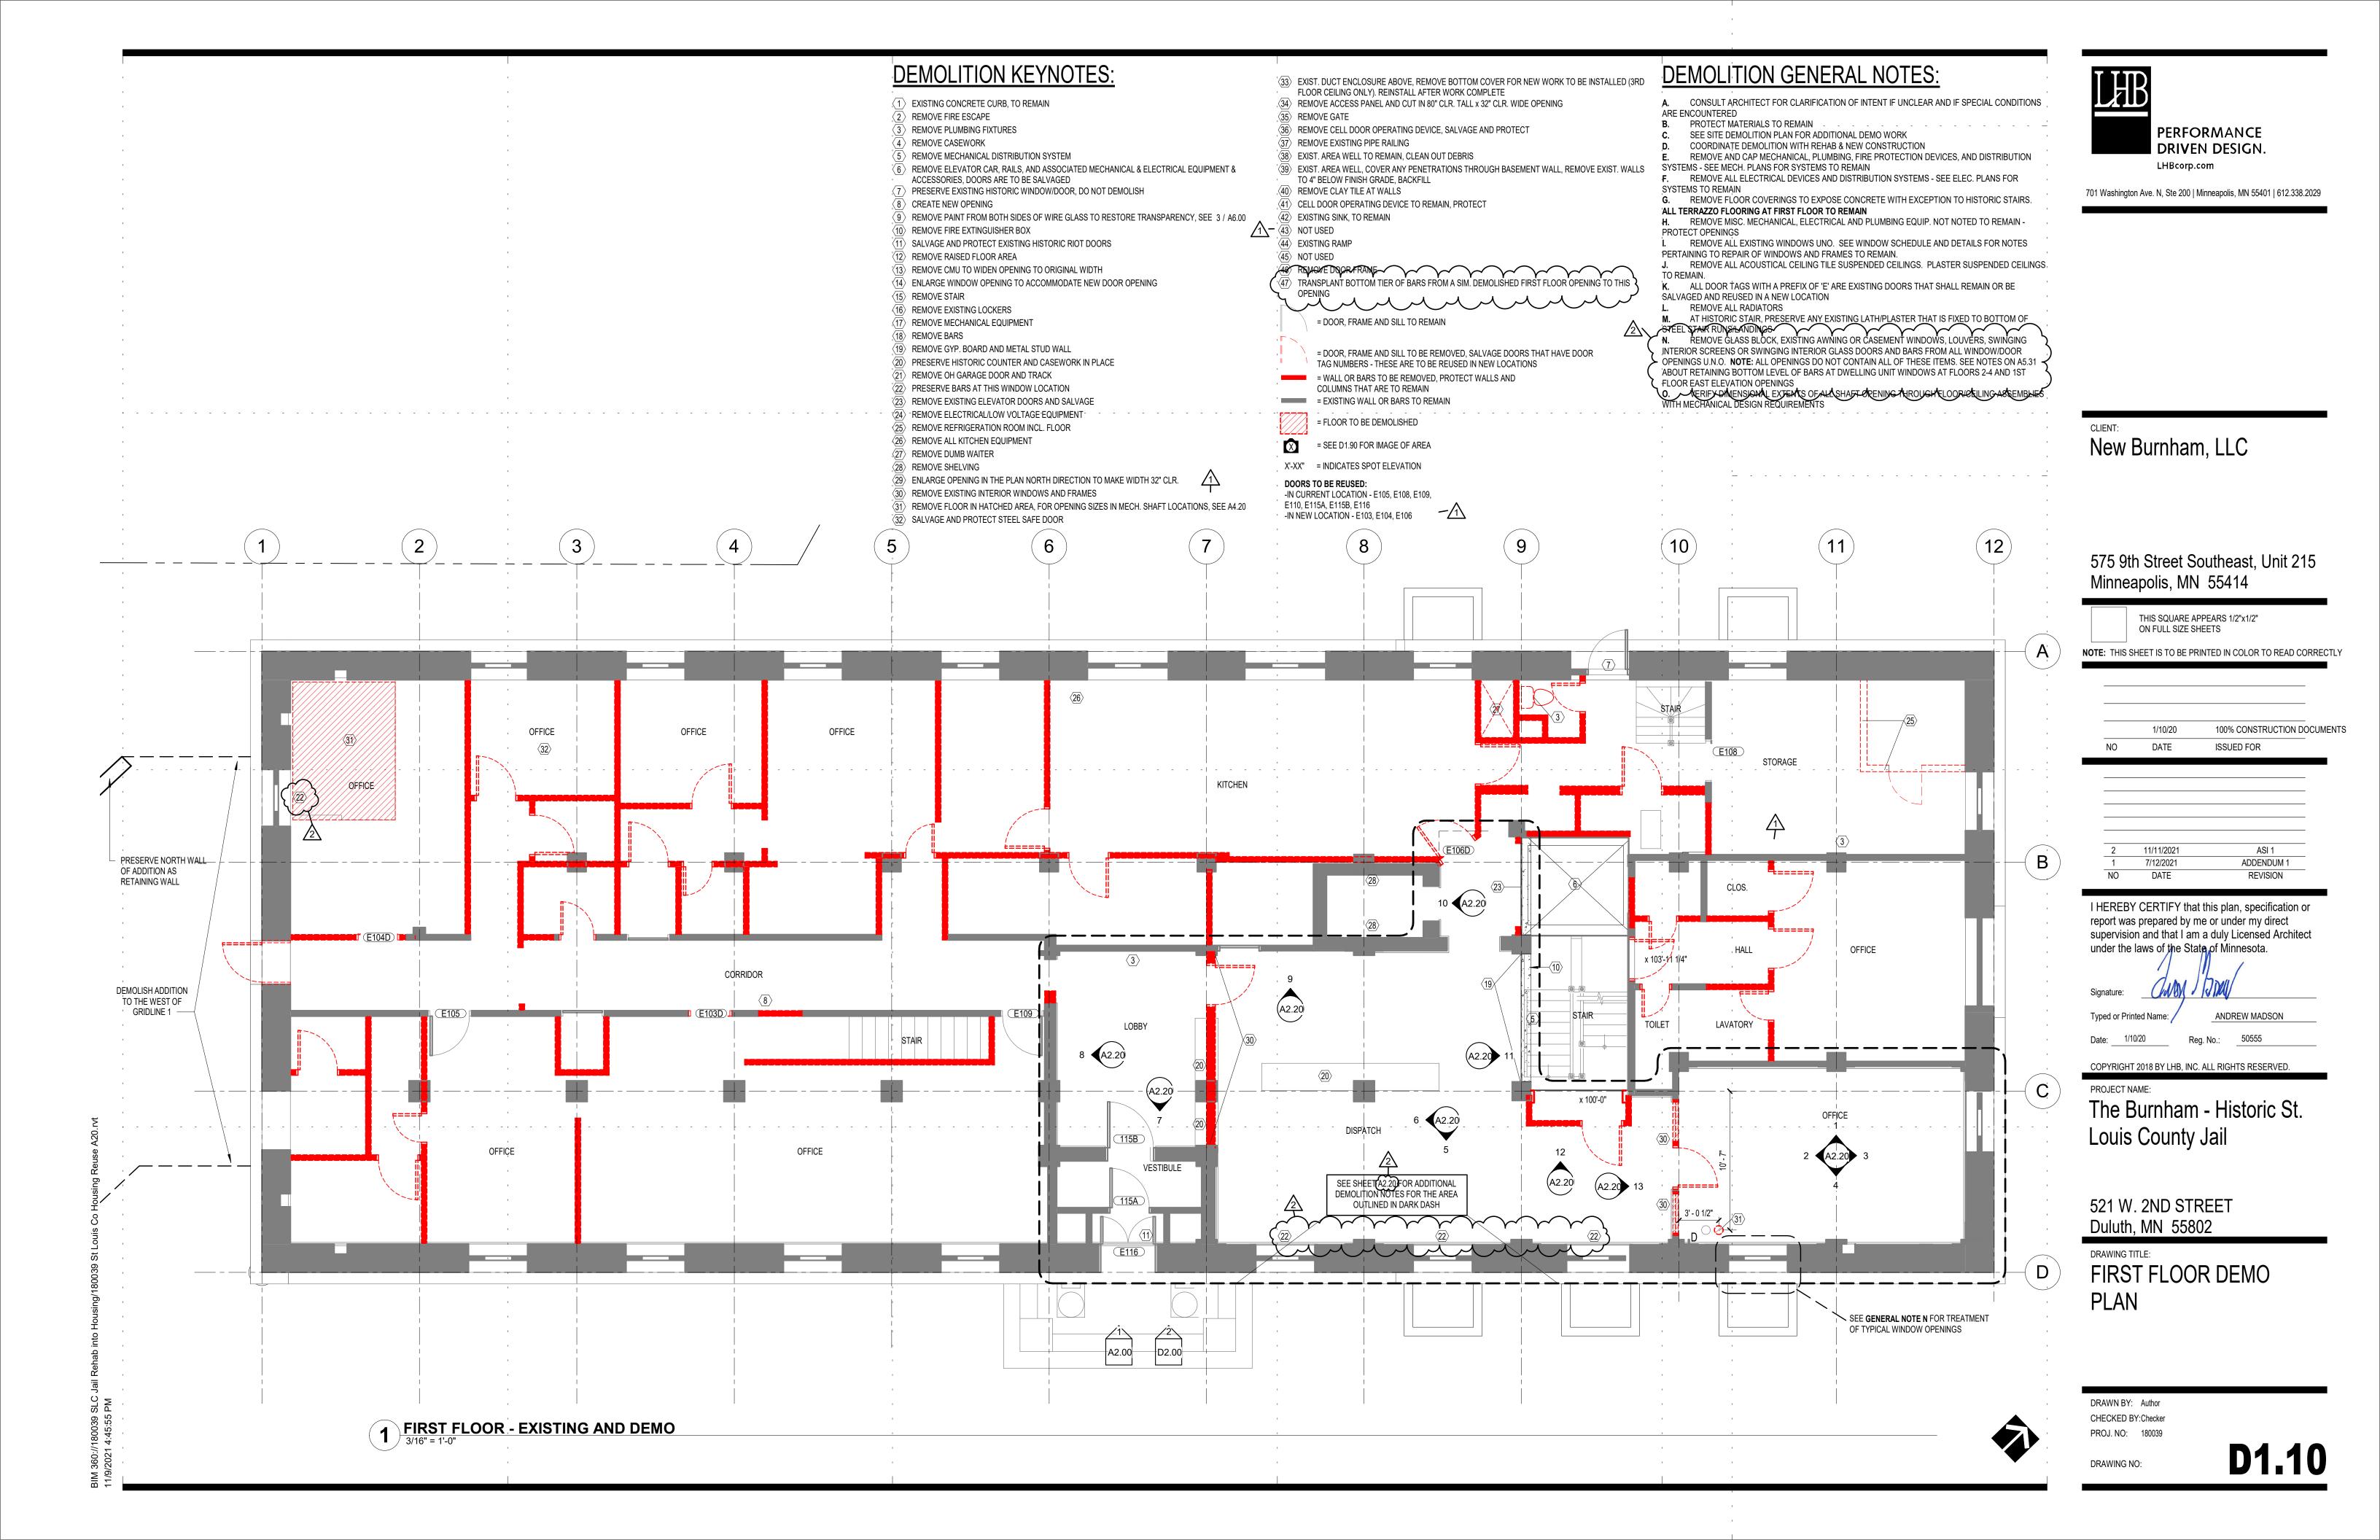
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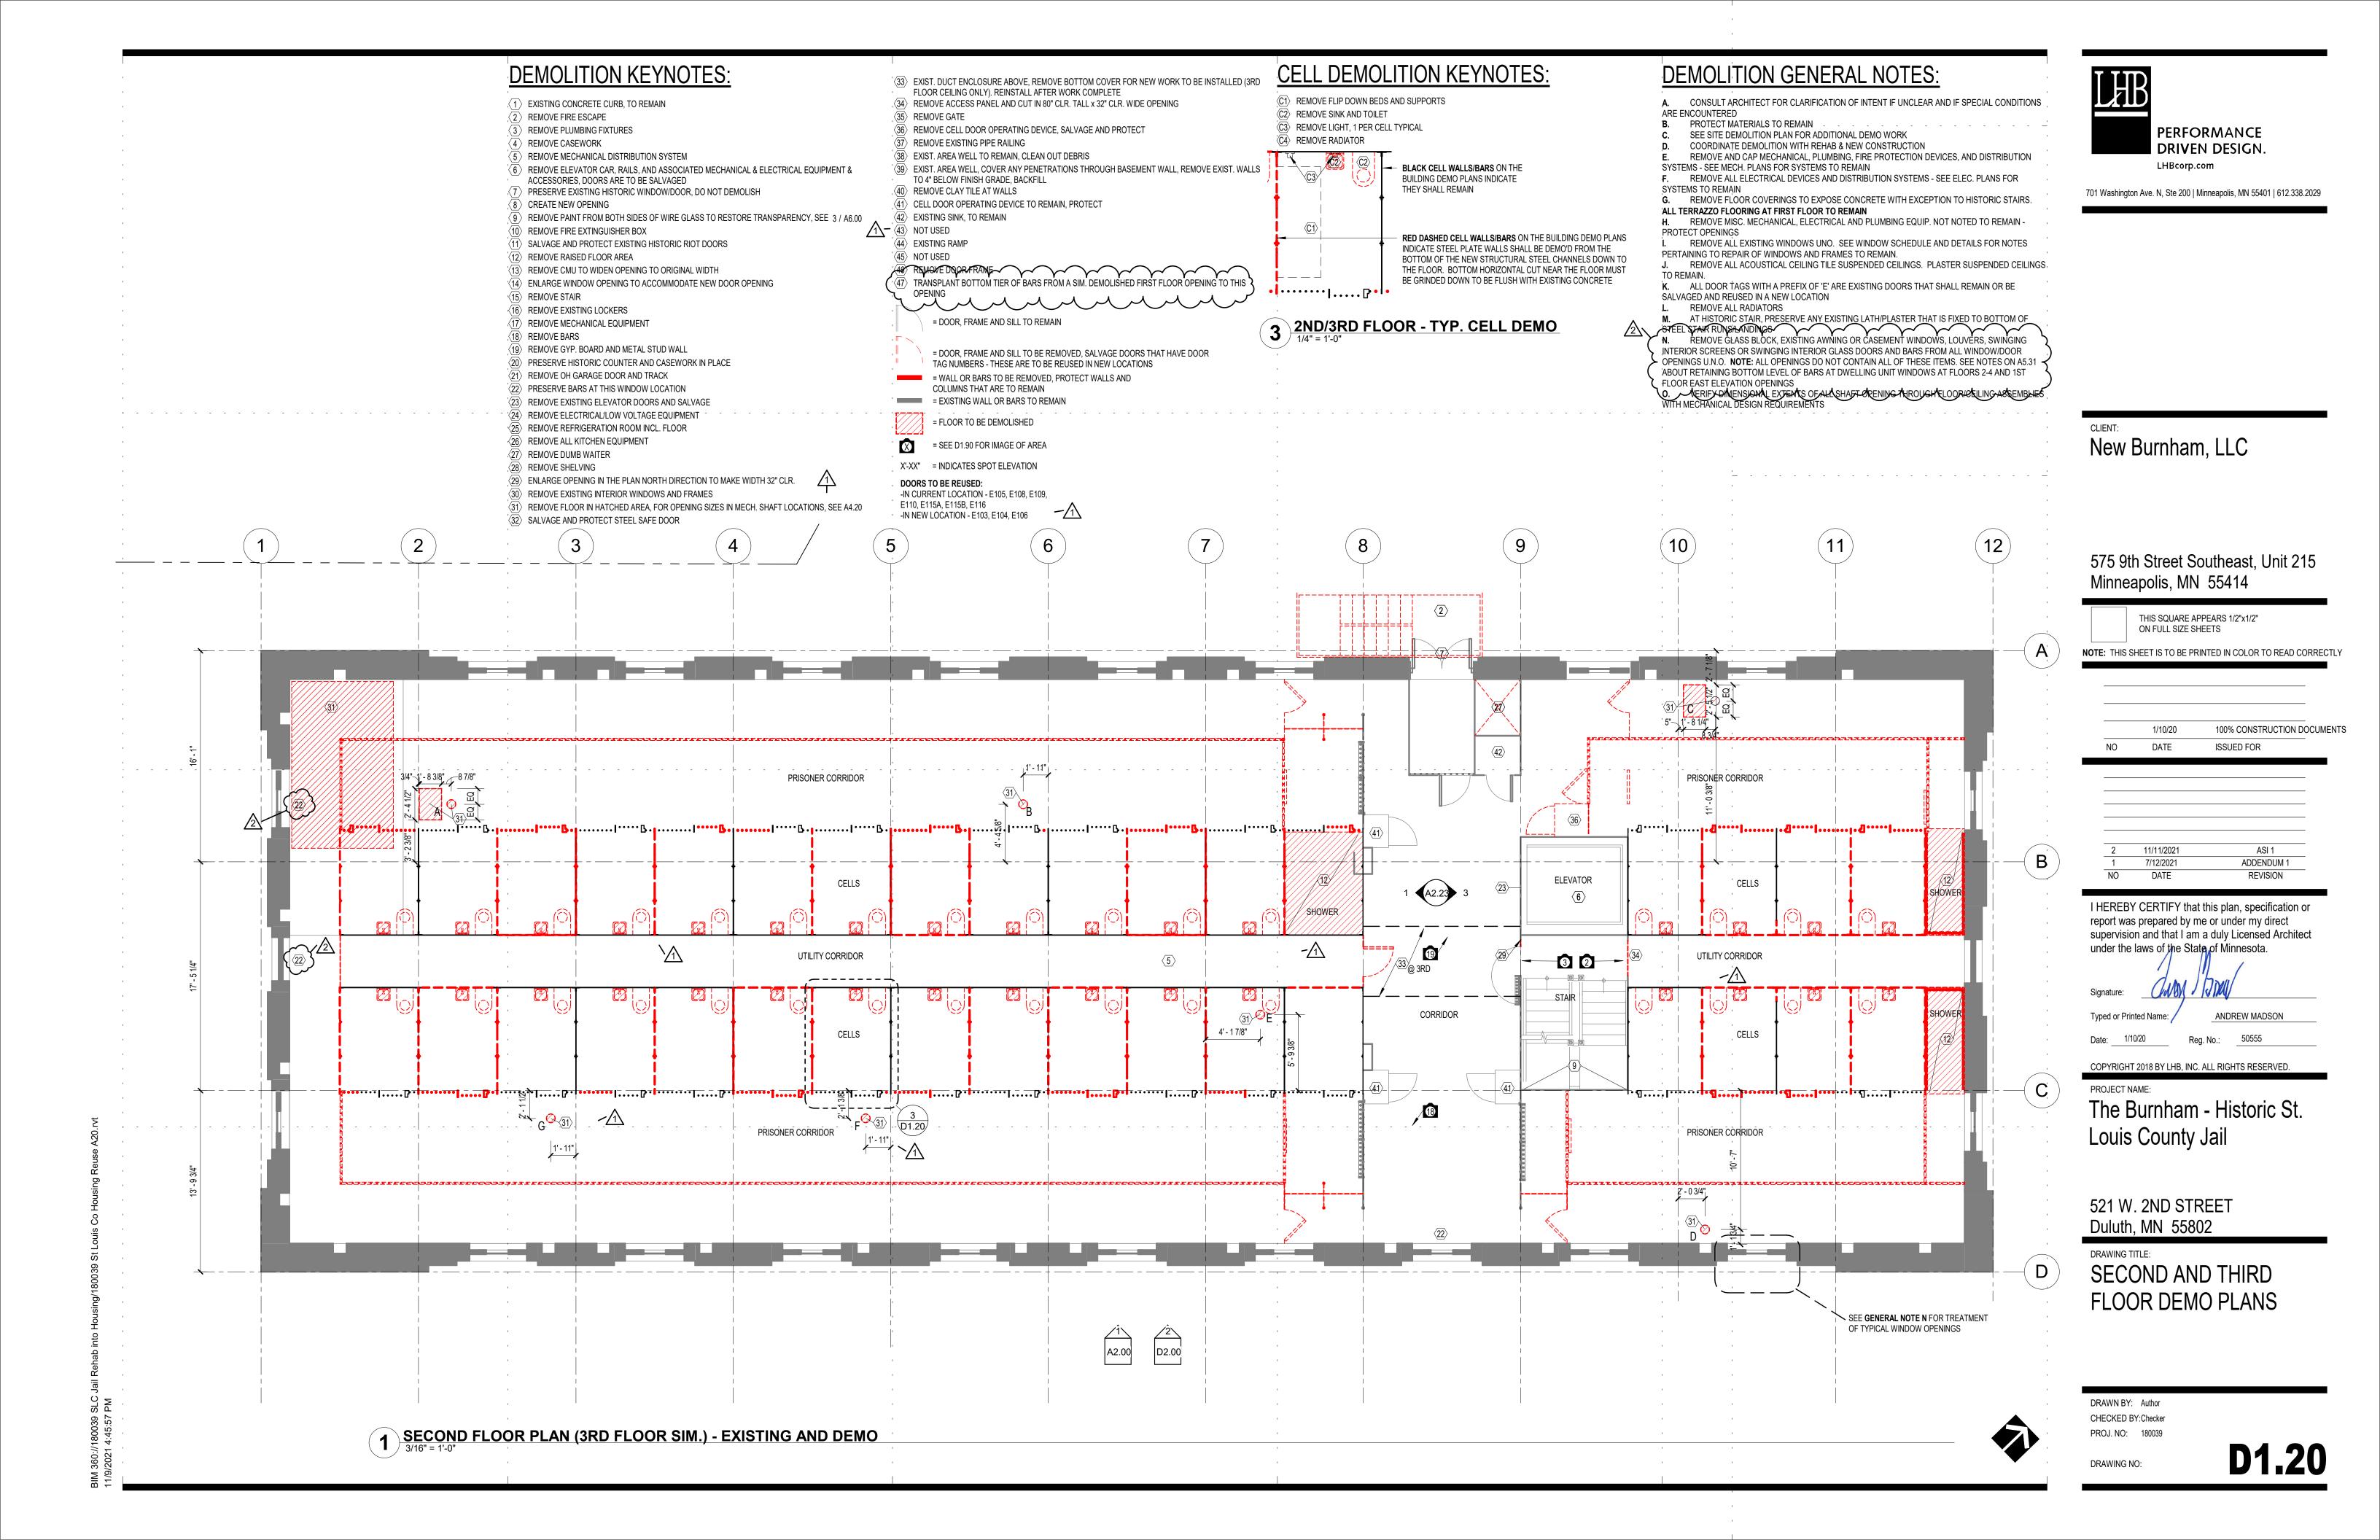
The Burnham - Historic St. Louis County Jail


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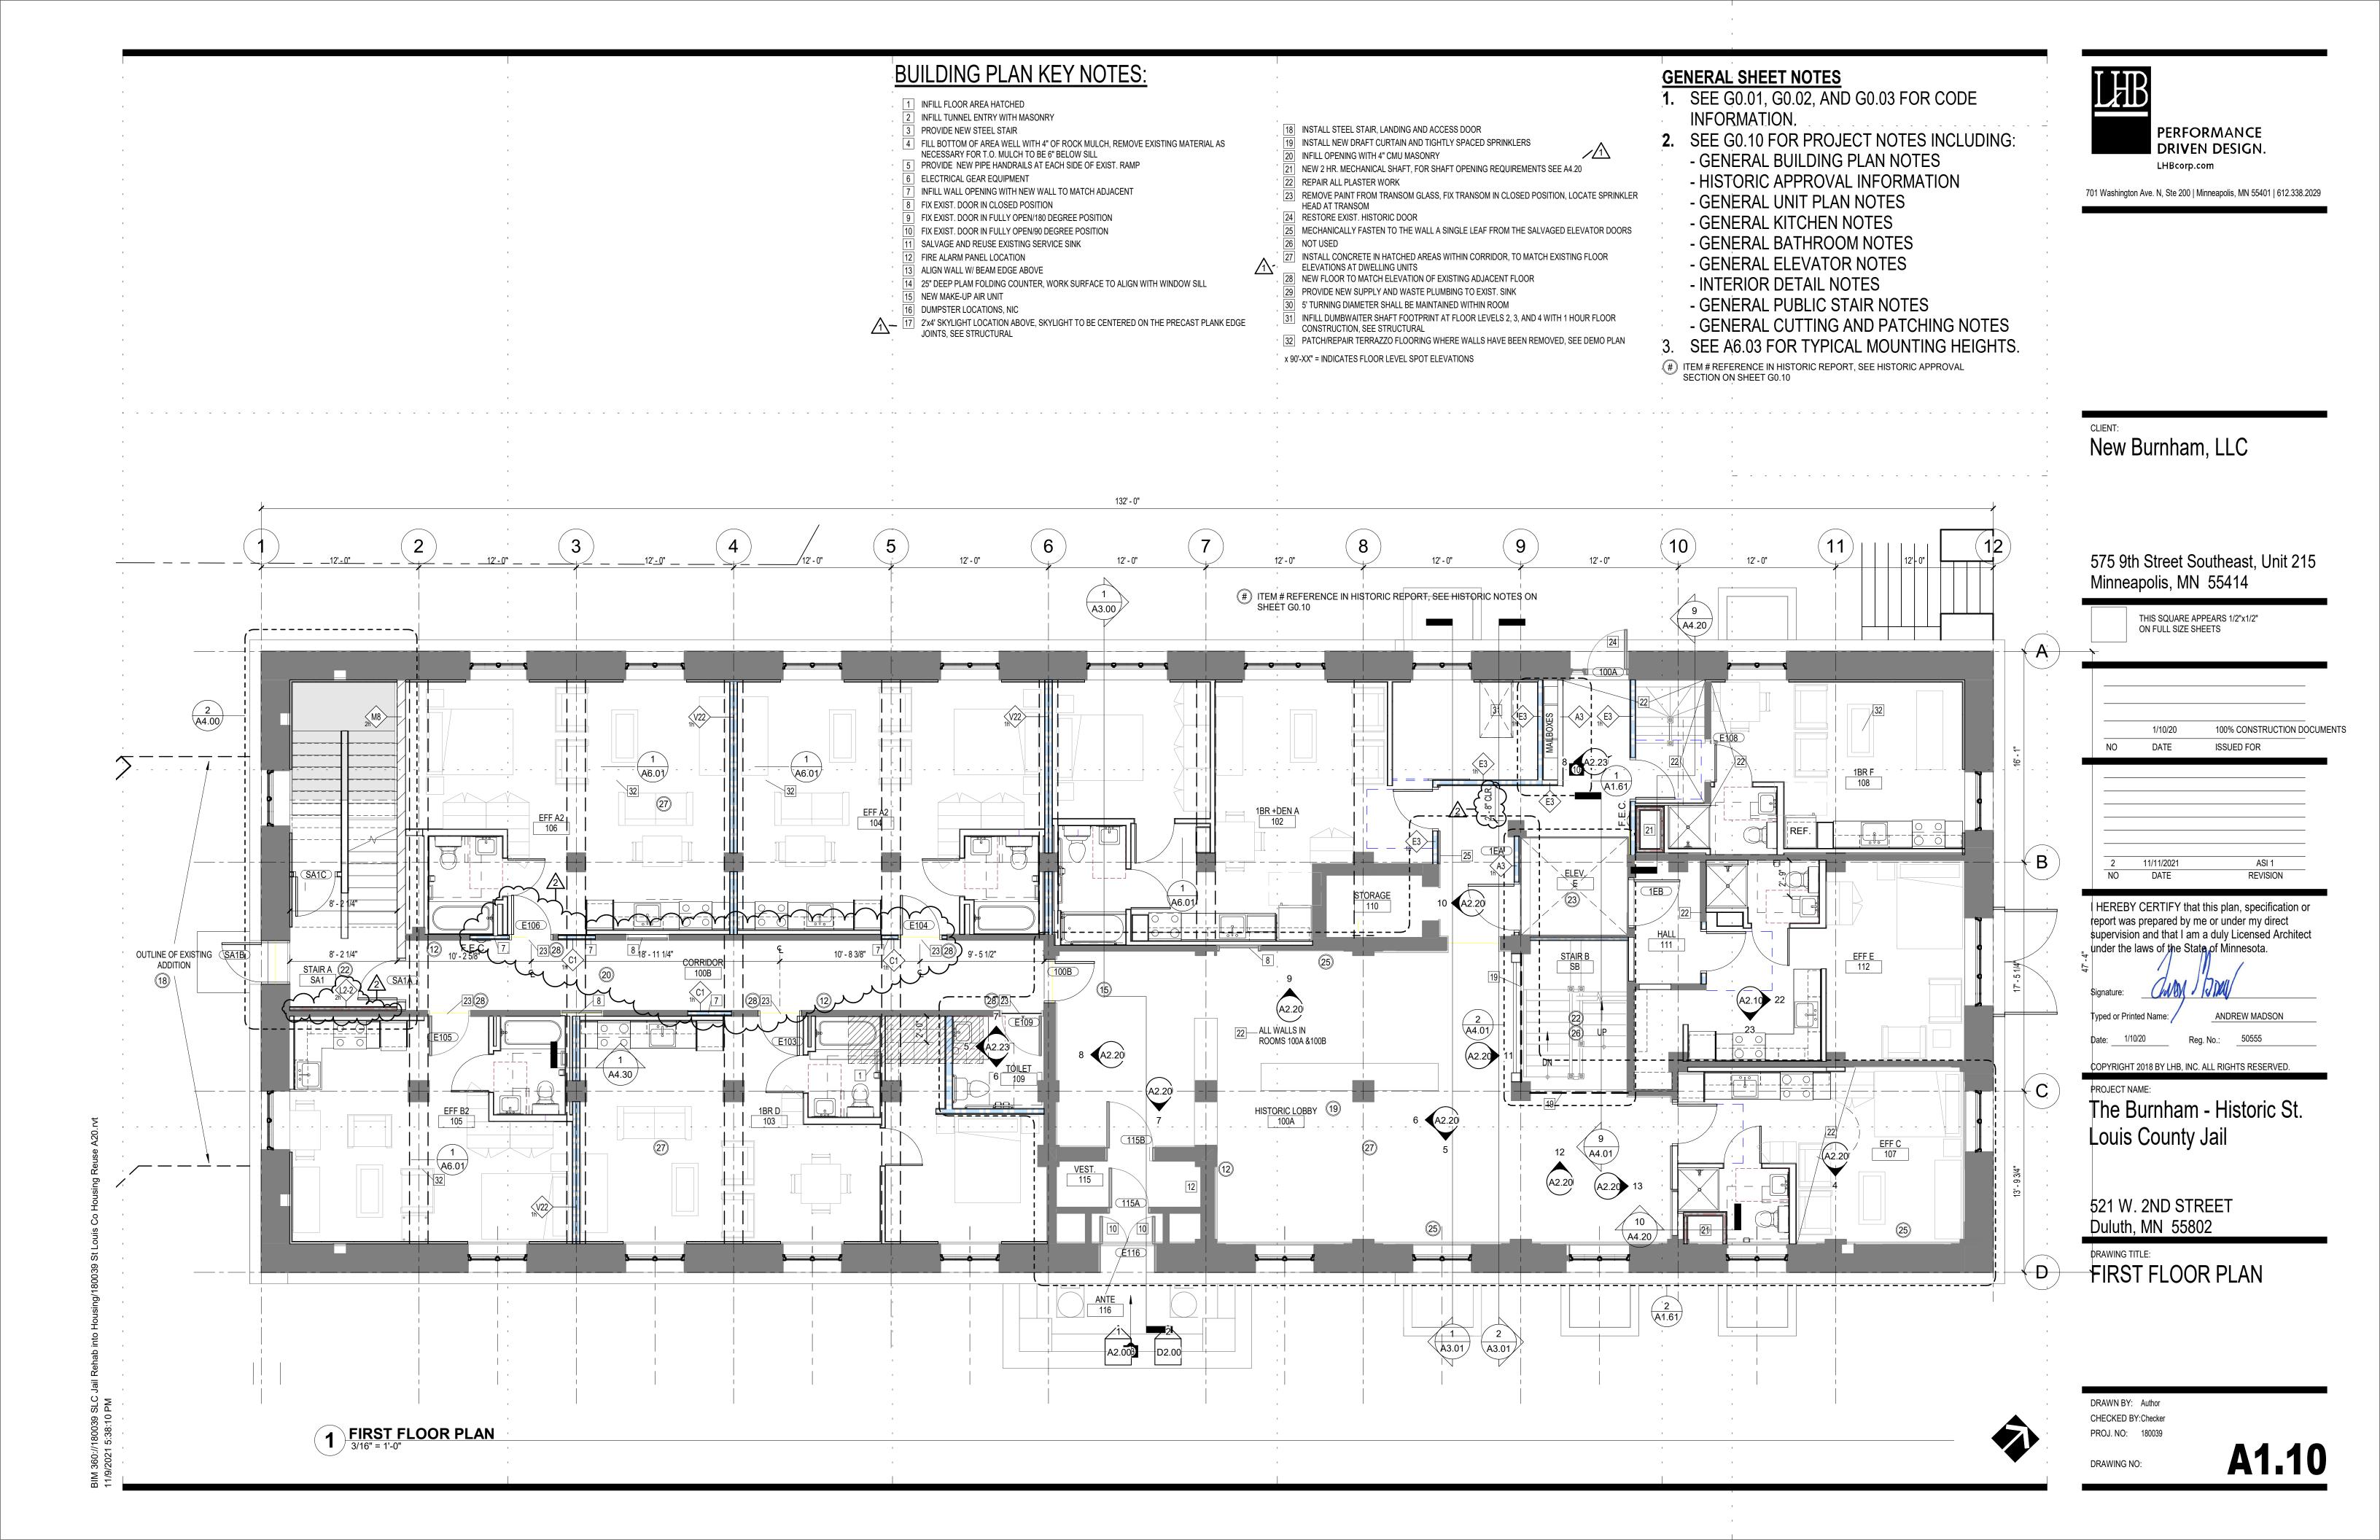
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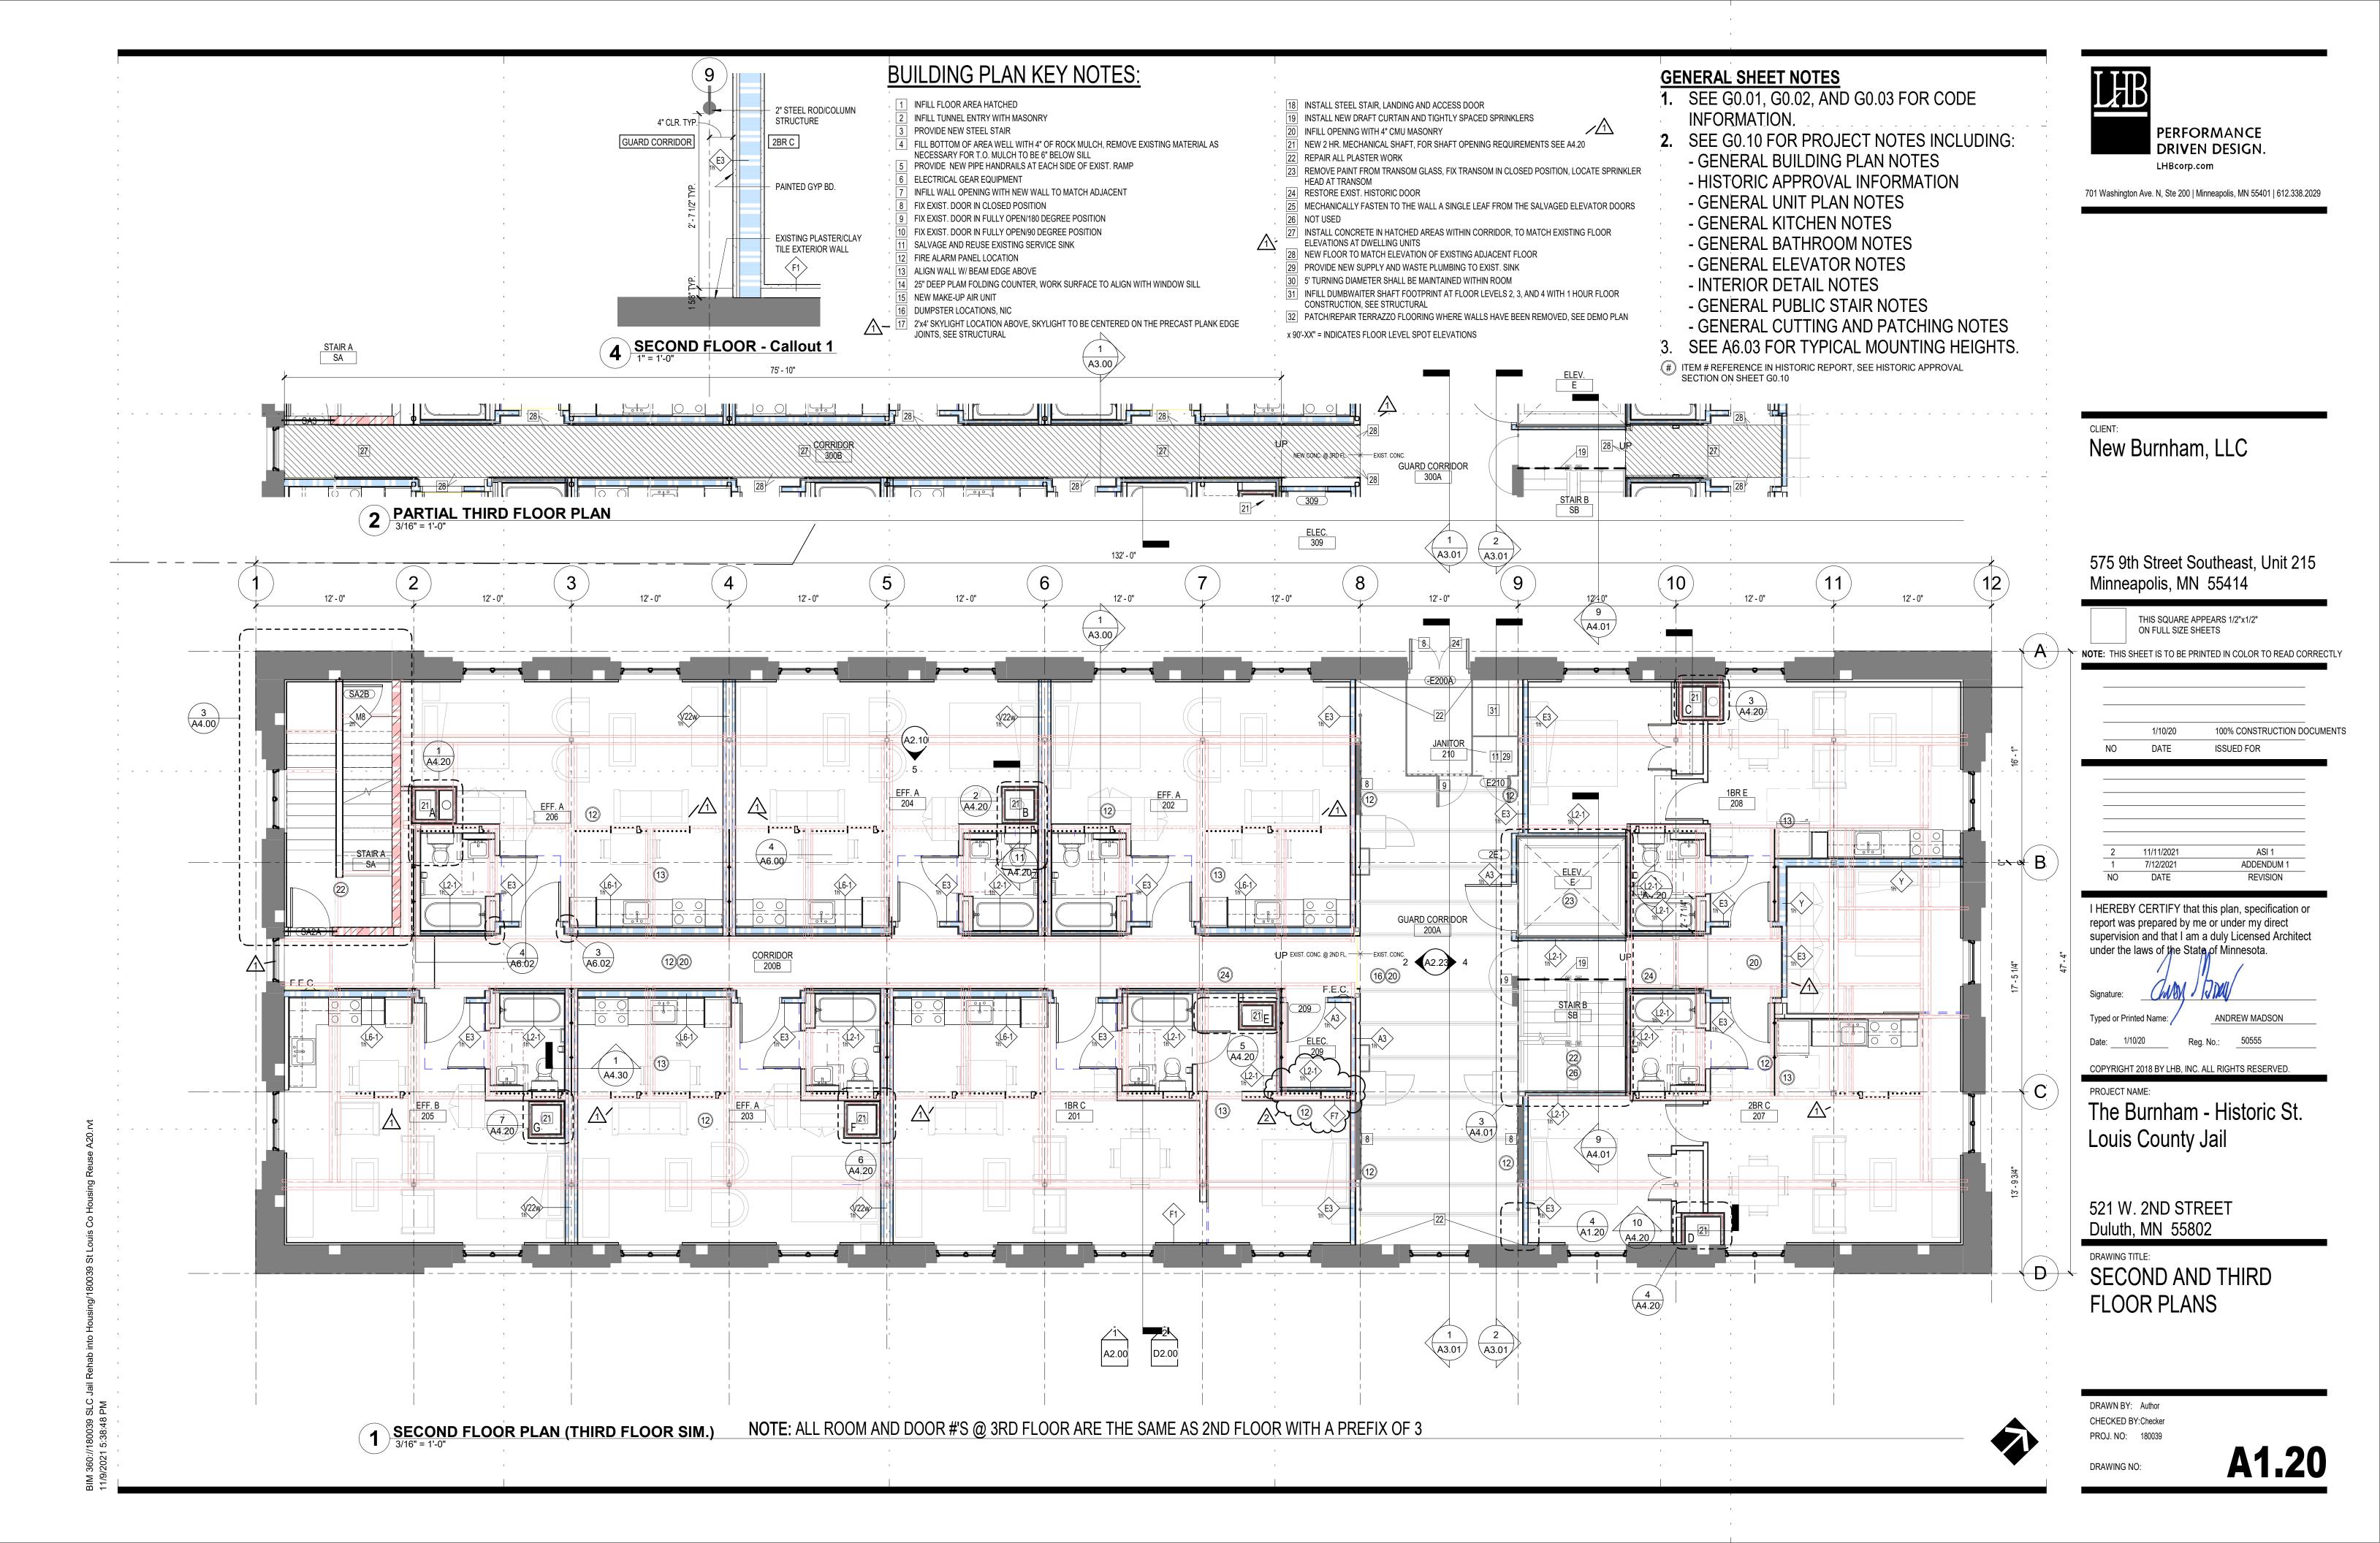
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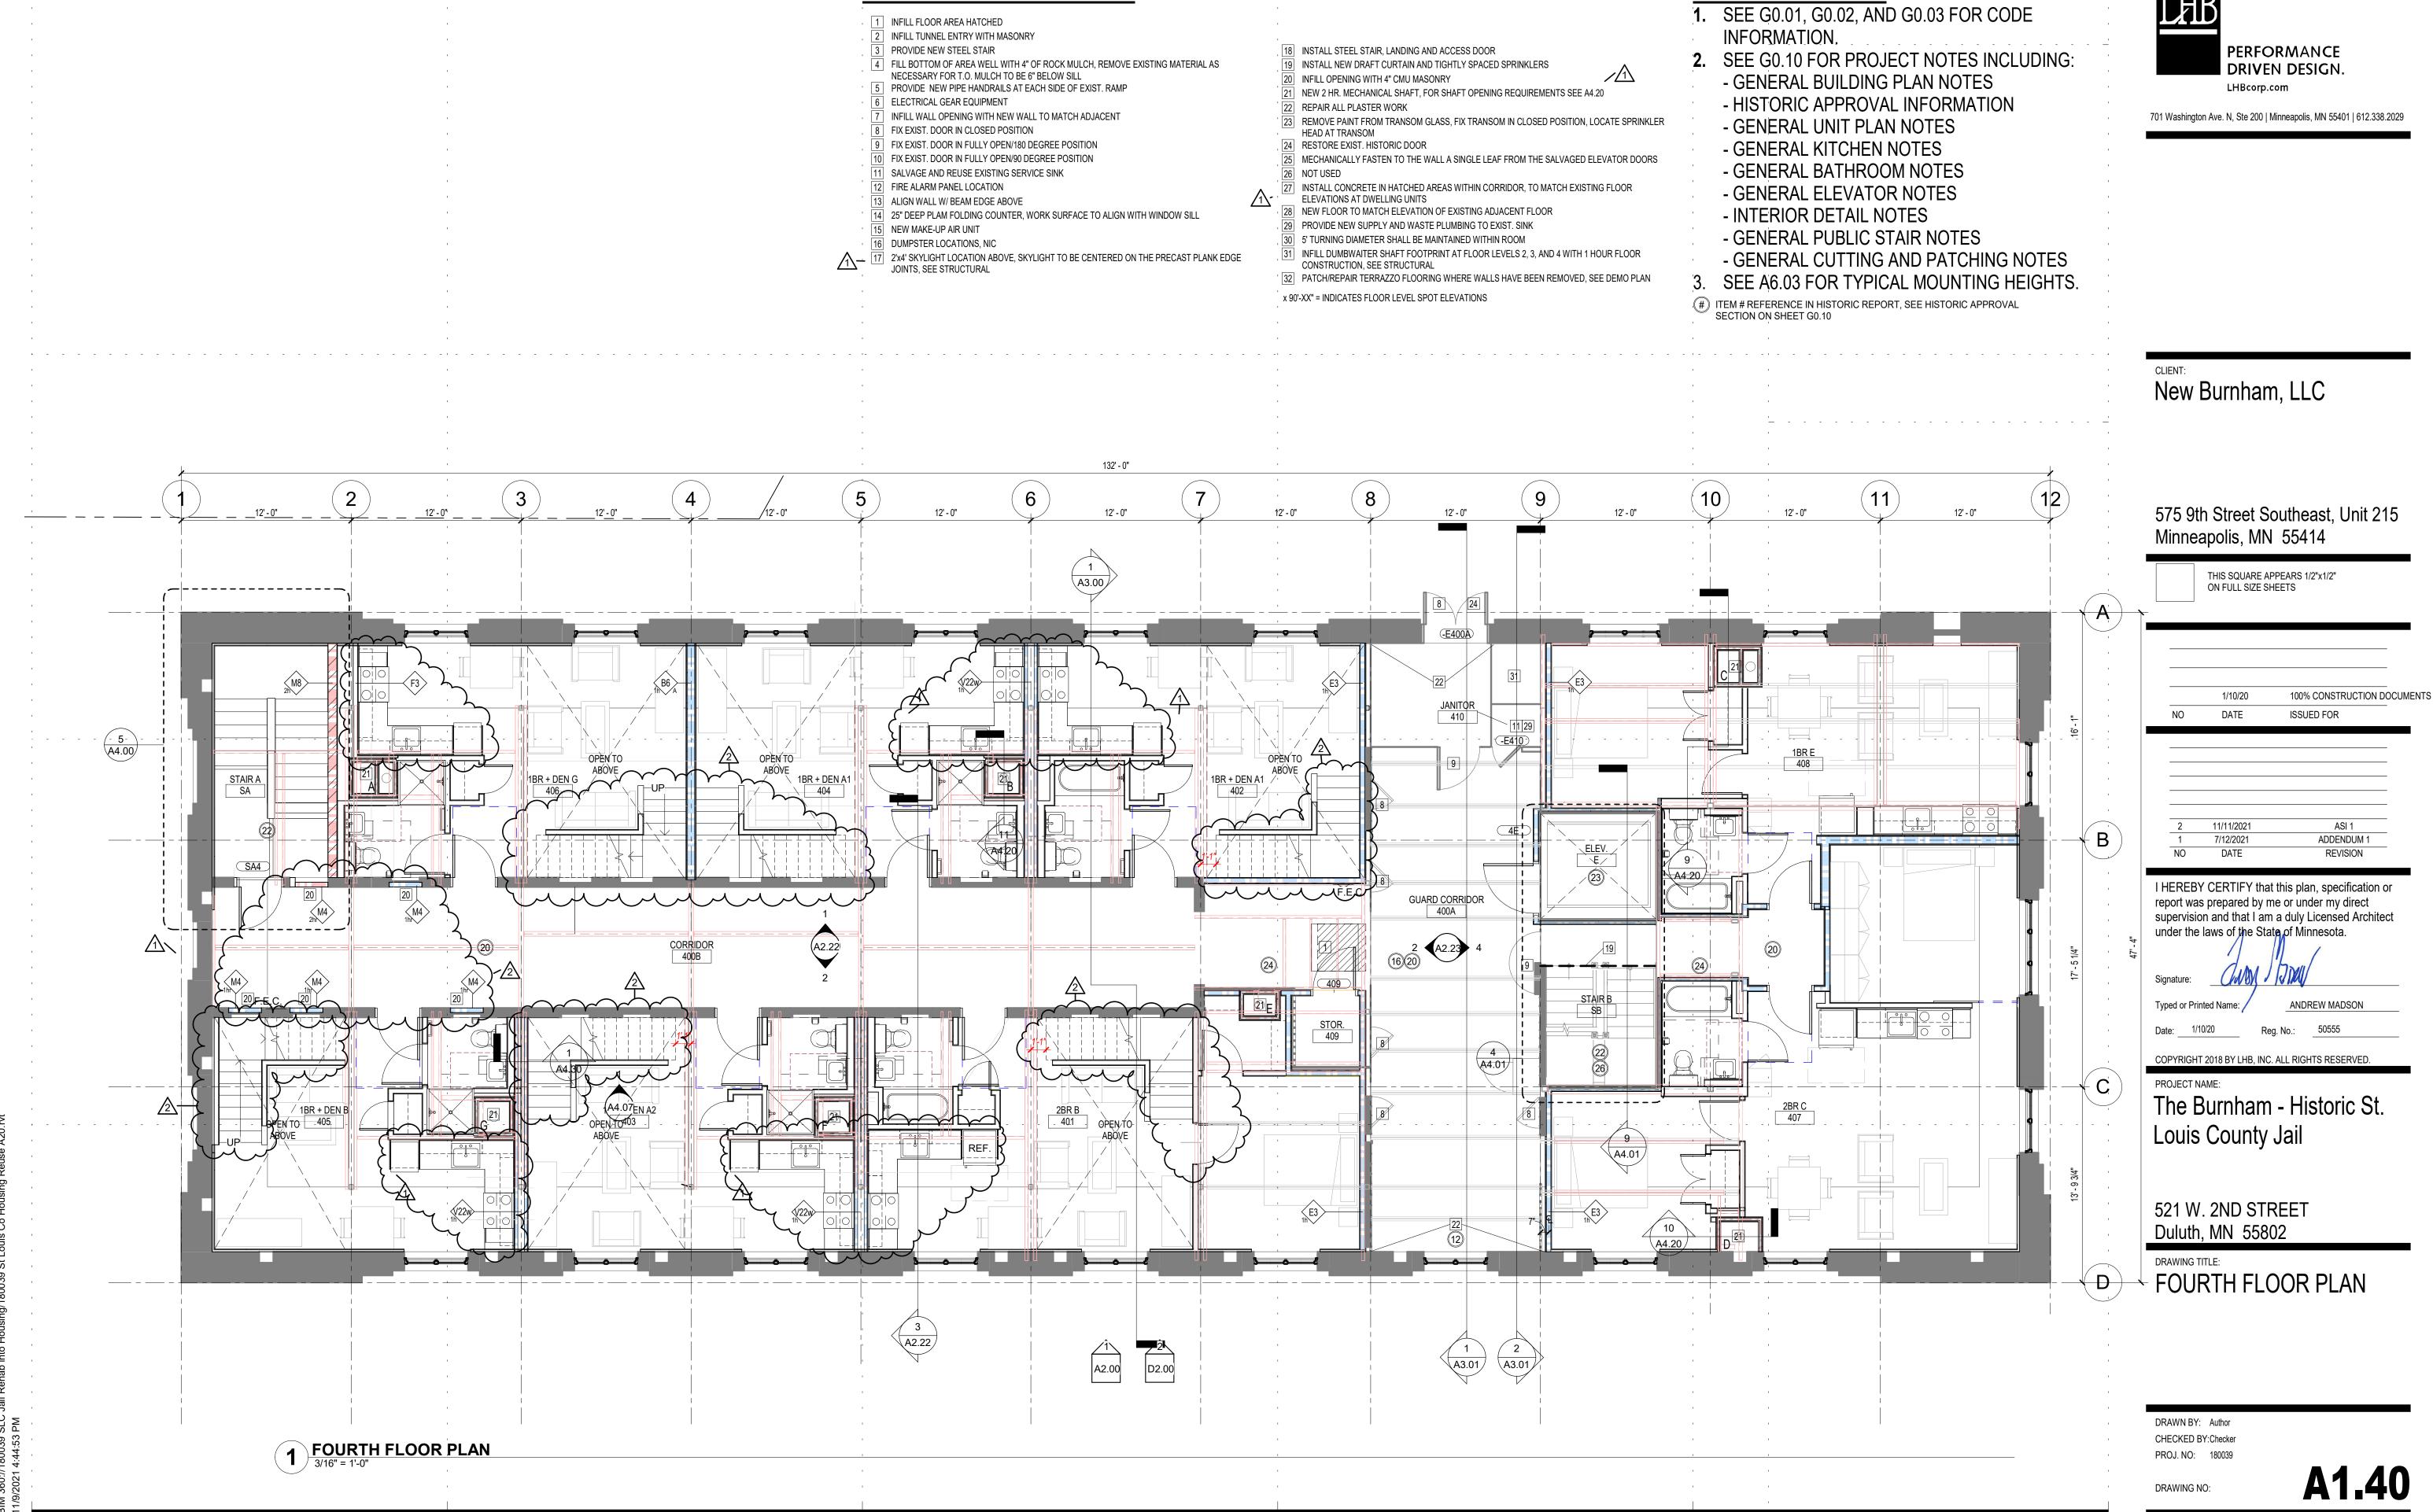











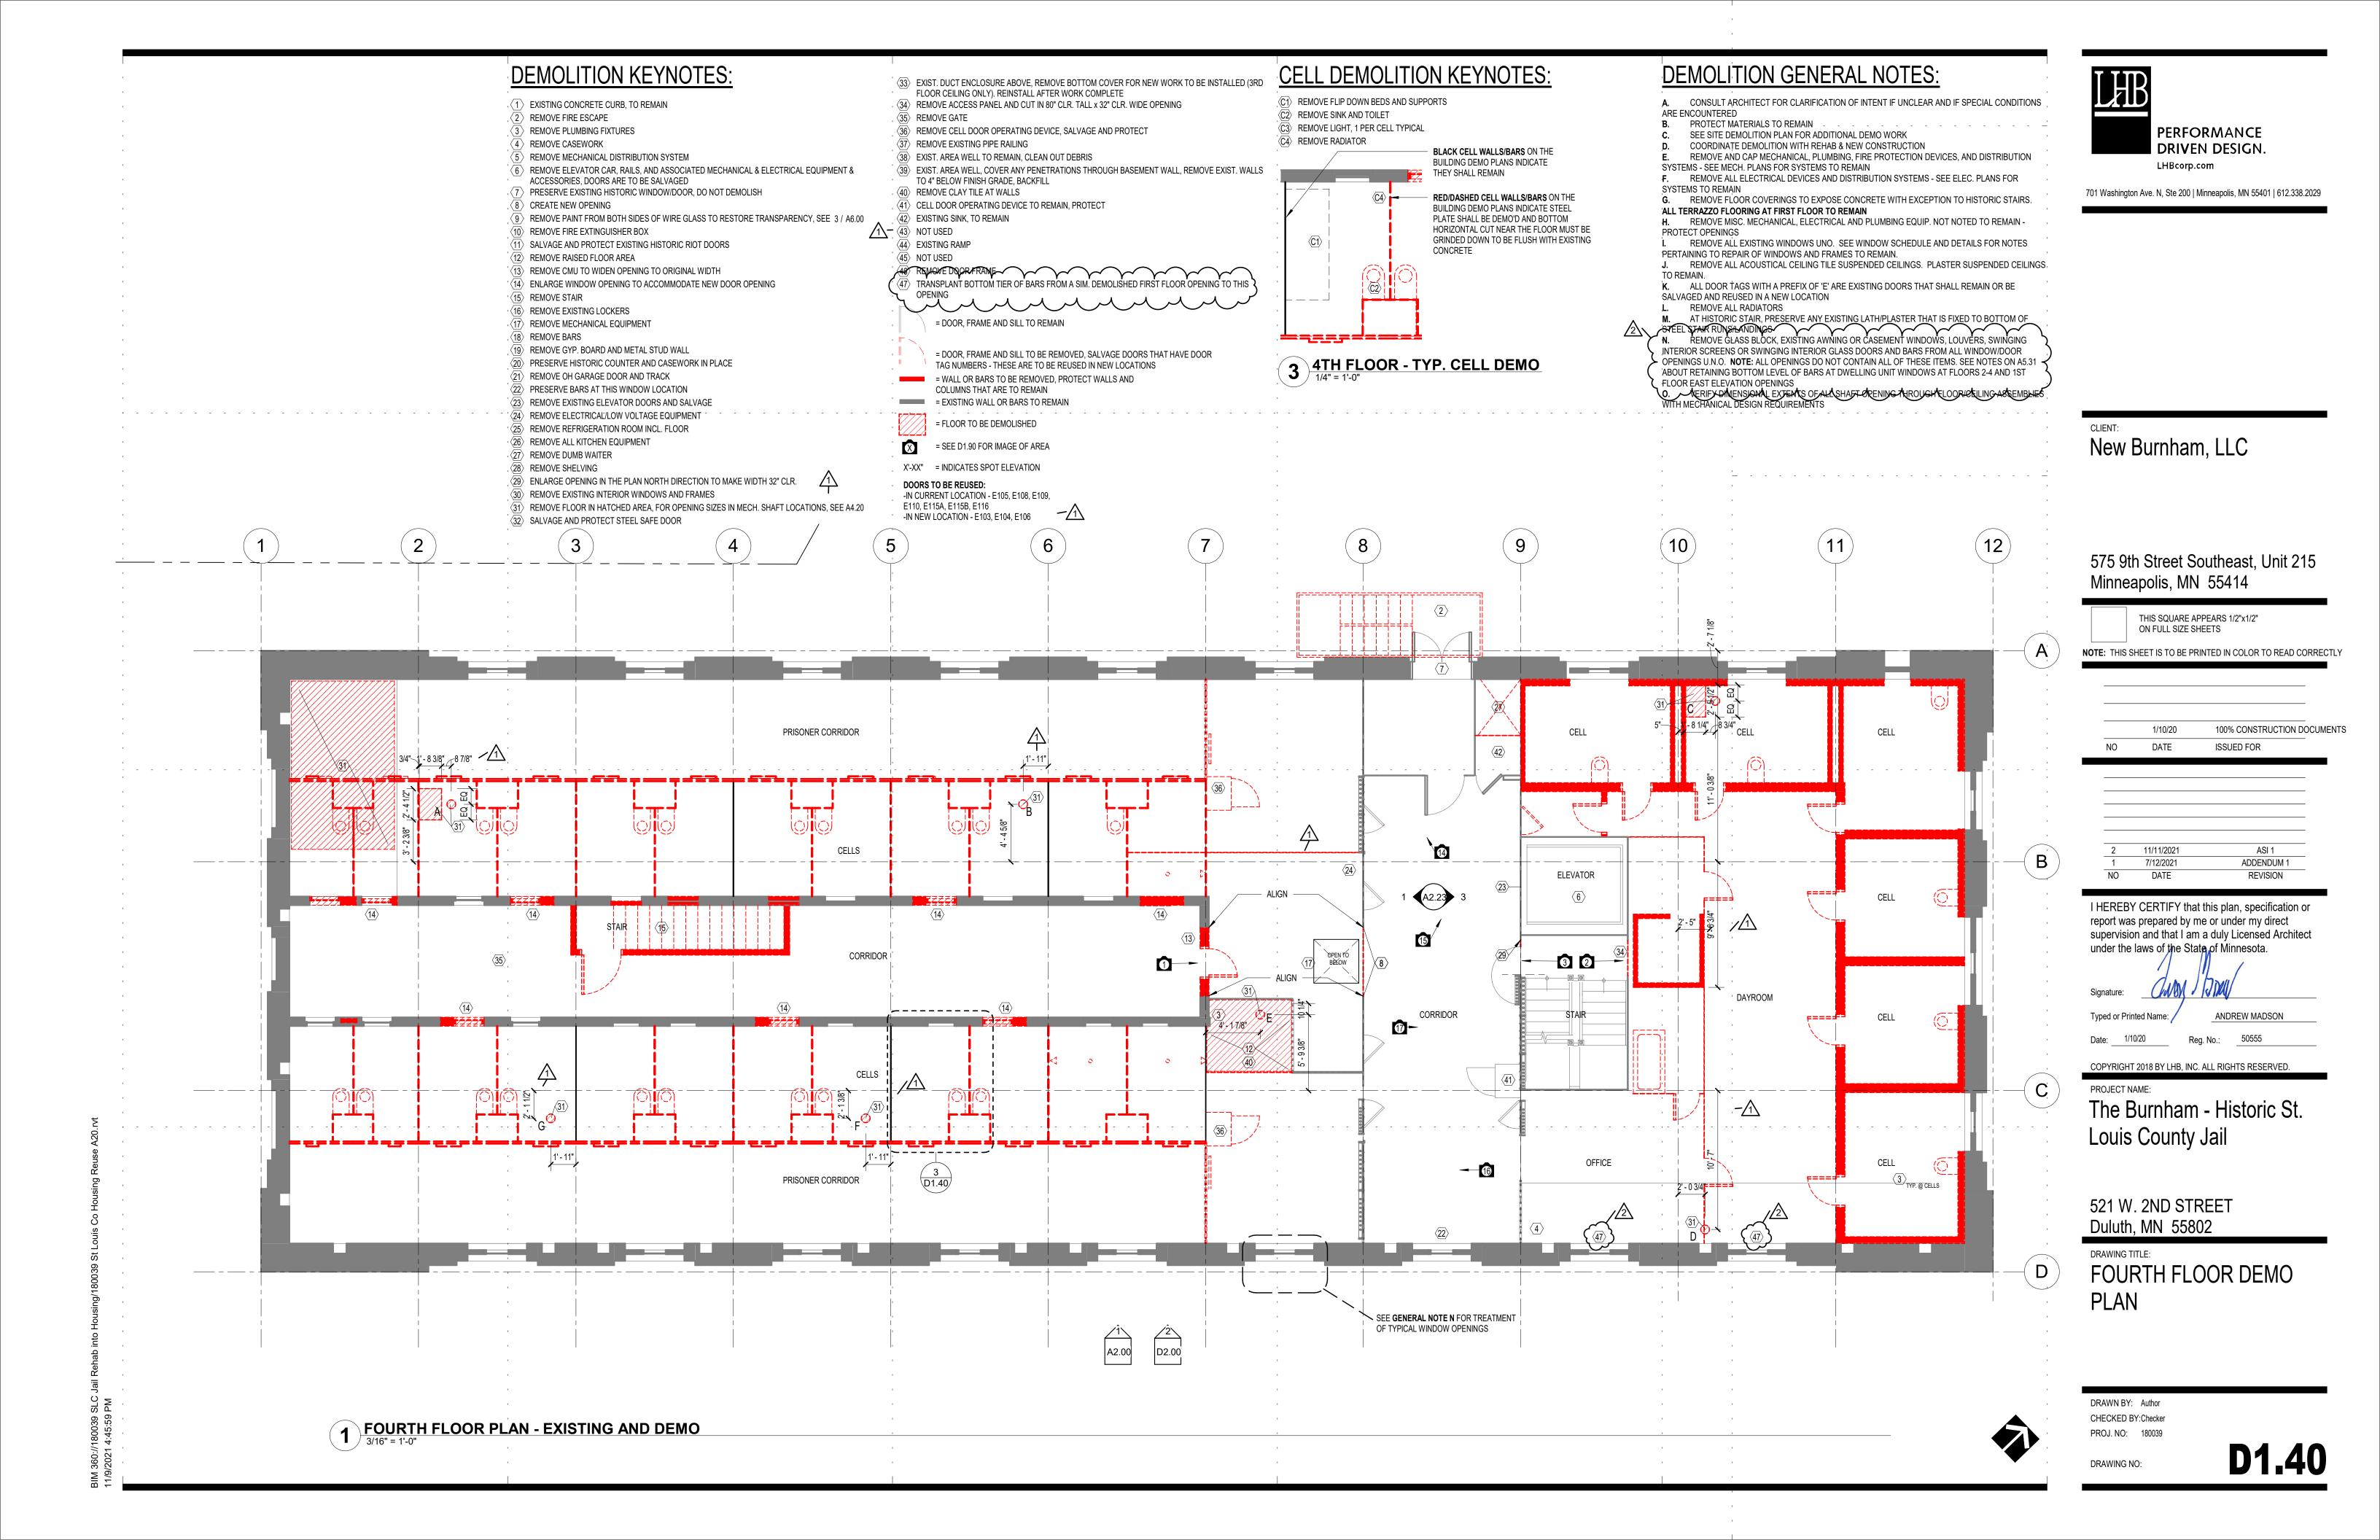


BUILDING PLAN KEY NOTES:

GENERAL SHEET NOTES

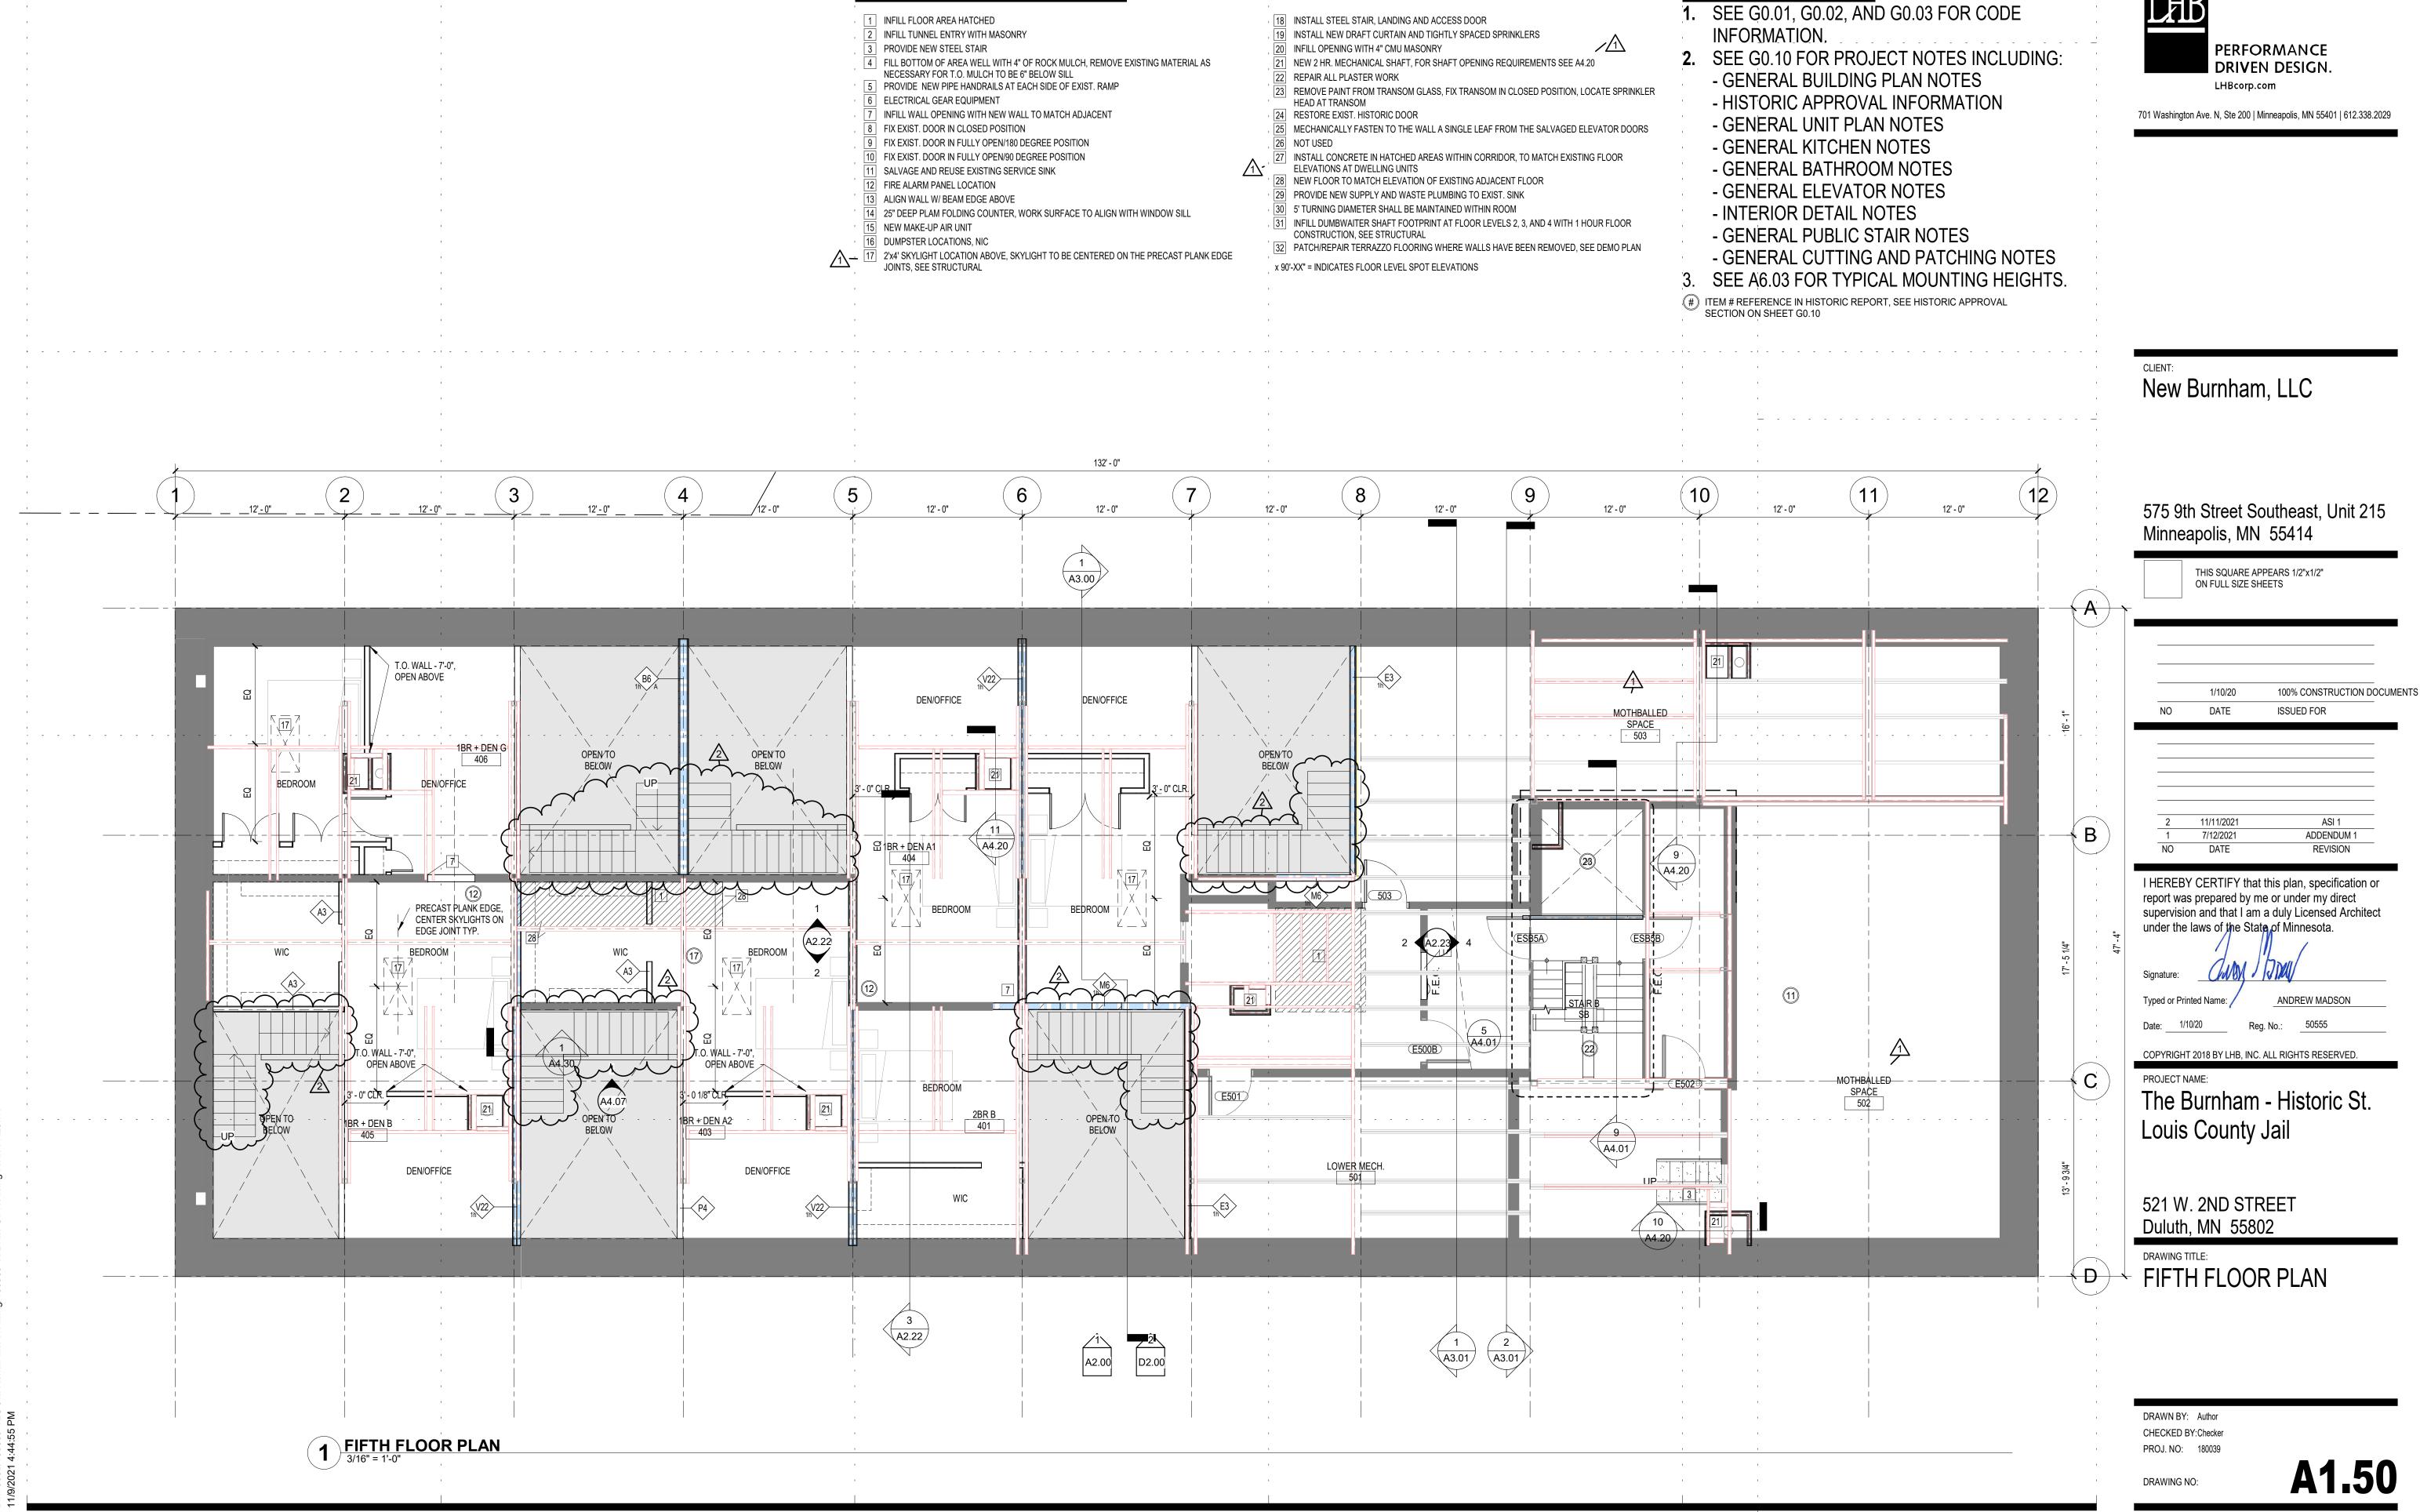

BUILDING PLAN KEY NOTES:

GENERAL SHEET NOTES

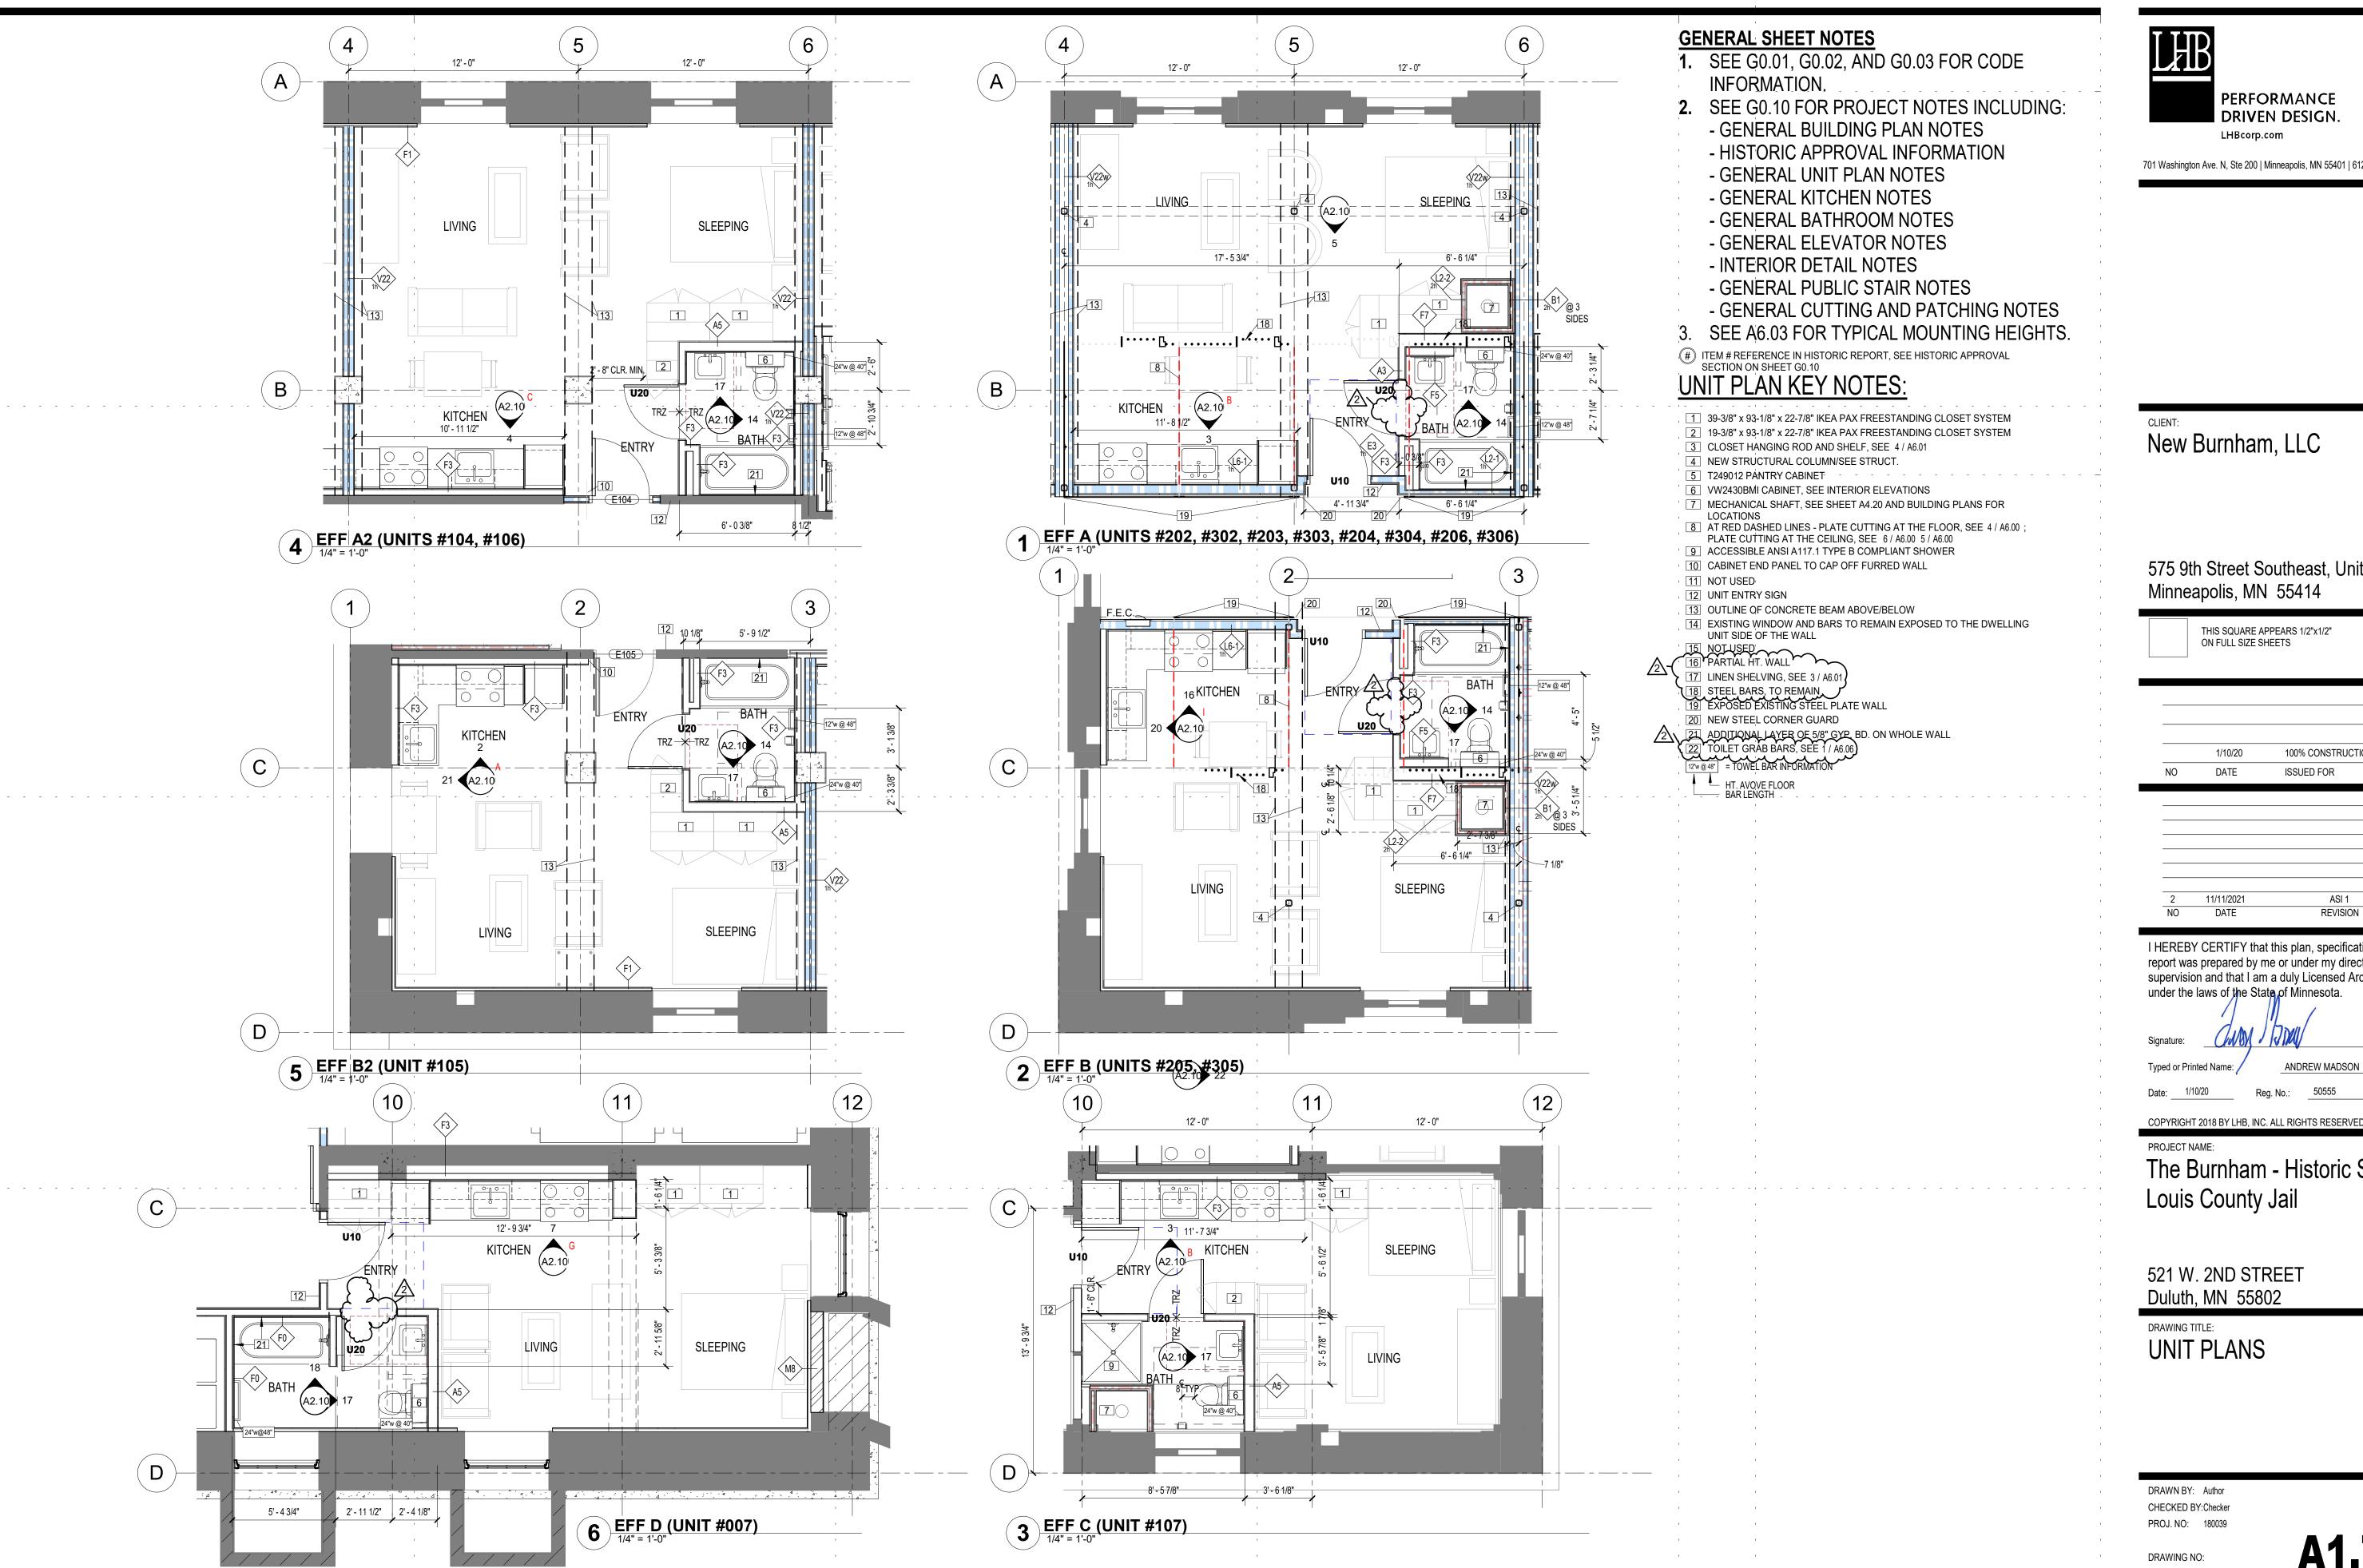

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New Burnham, LLC

575 9th Street Southeast, Unit 215 Minneapolis, MN 55414

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ON FULL SIZE SHEETS

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NO	DATE	ISSUED FOR

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11/11/2021

Typed or Printed Name:

ANDREW MADSON

PROJECT NAME:

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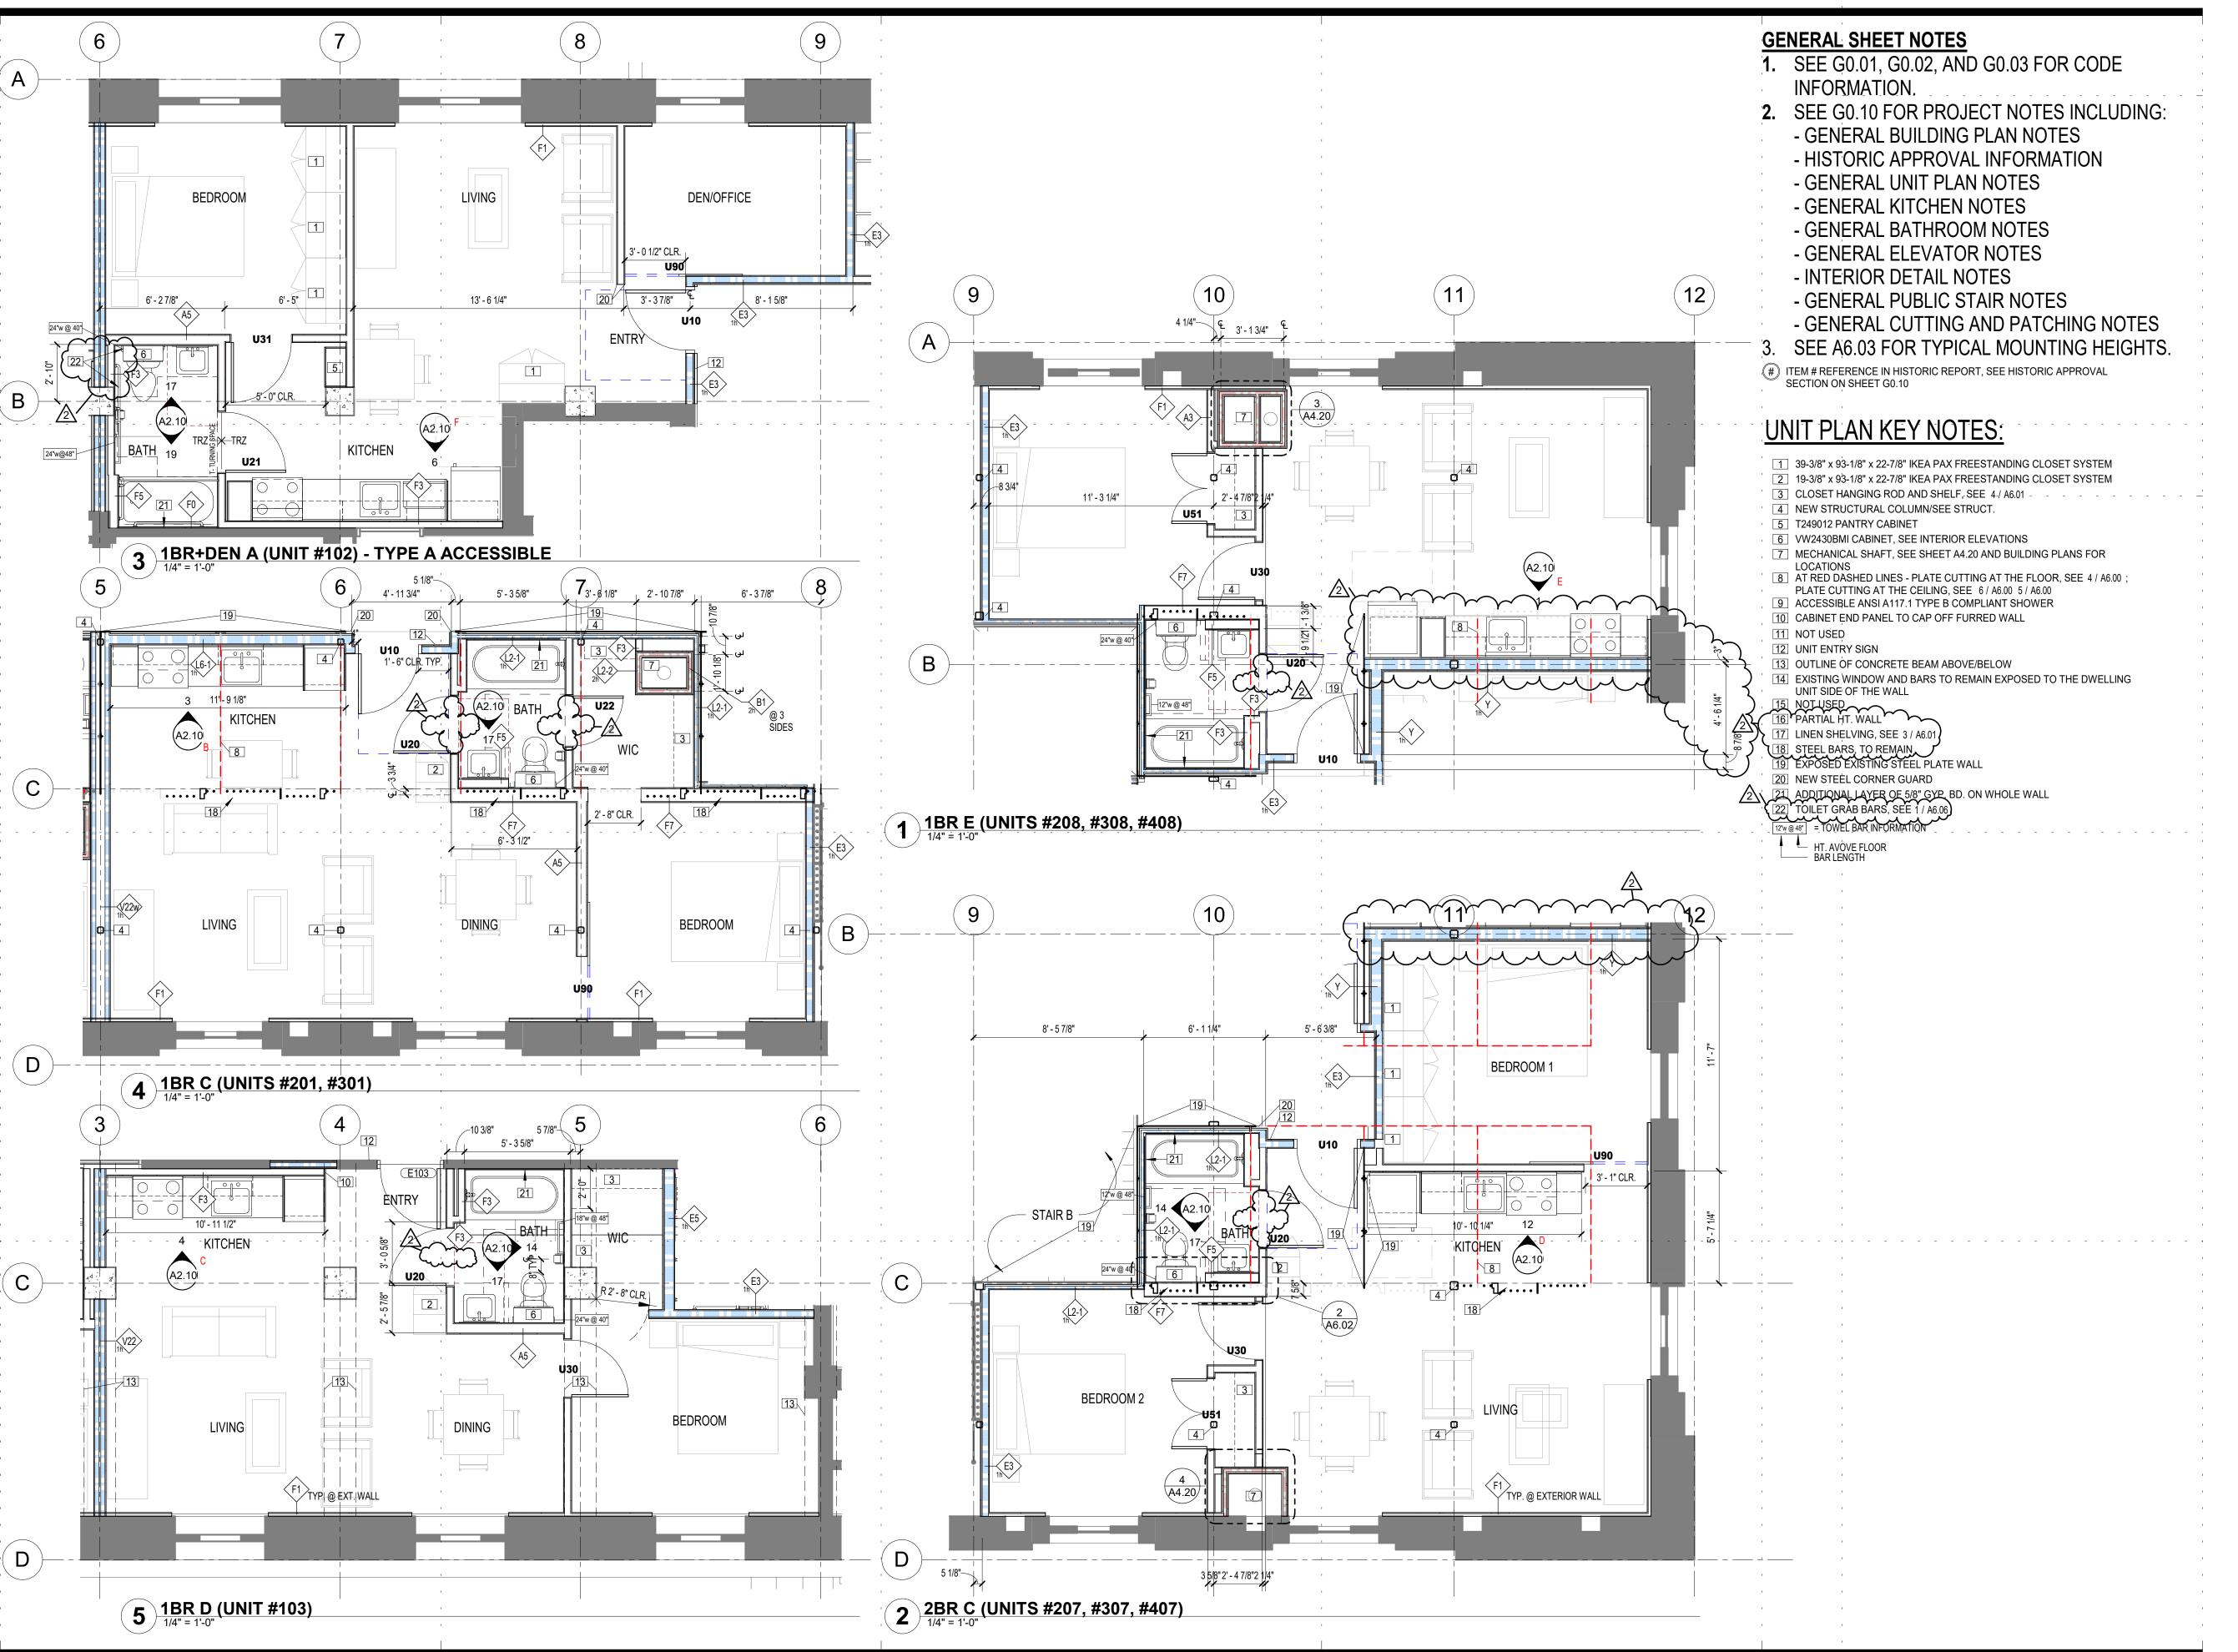
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DRAWING TITLE: **UNIT PLANS**

DRAWN BY: Author CHECKED BY:Checker PROJ. NO: 180039

DRAWING NO:

A1.70





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NO	DATE	REVISION

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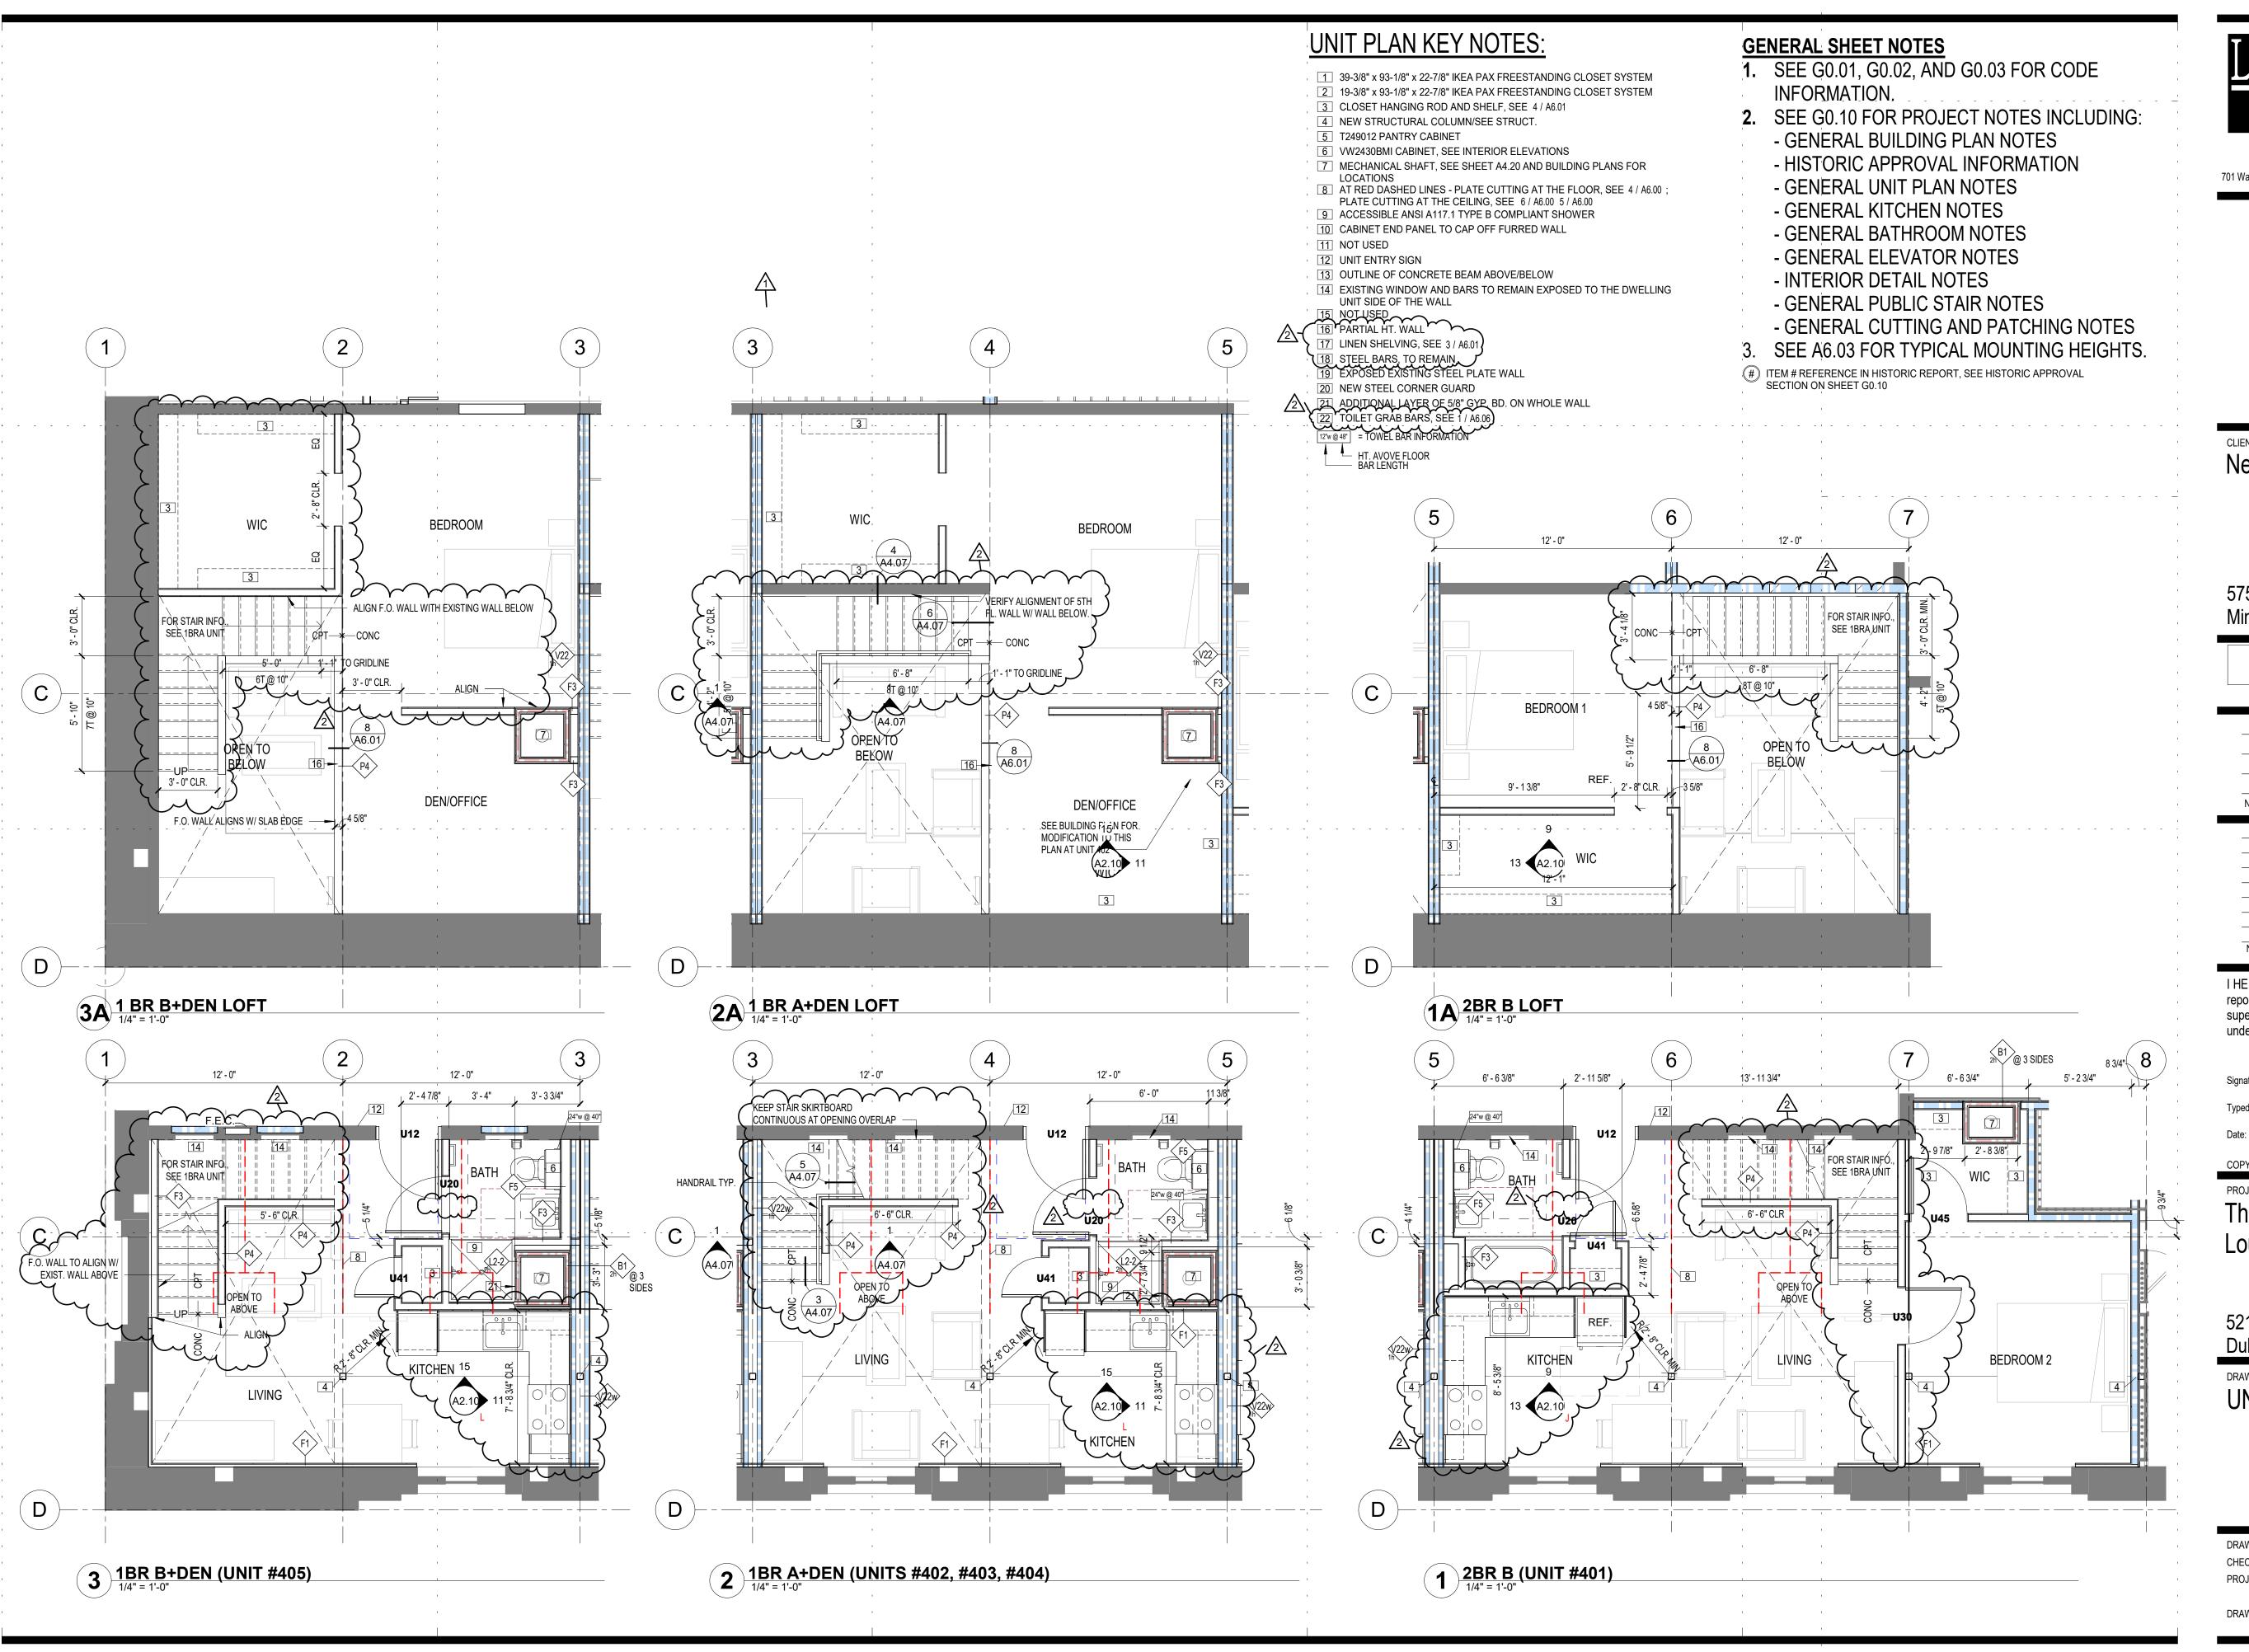
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DRAWING TITLE: **UNIT PLANS**

DRAWN BY: Author CHECKED BY:Checker PROJ. NO: 180039





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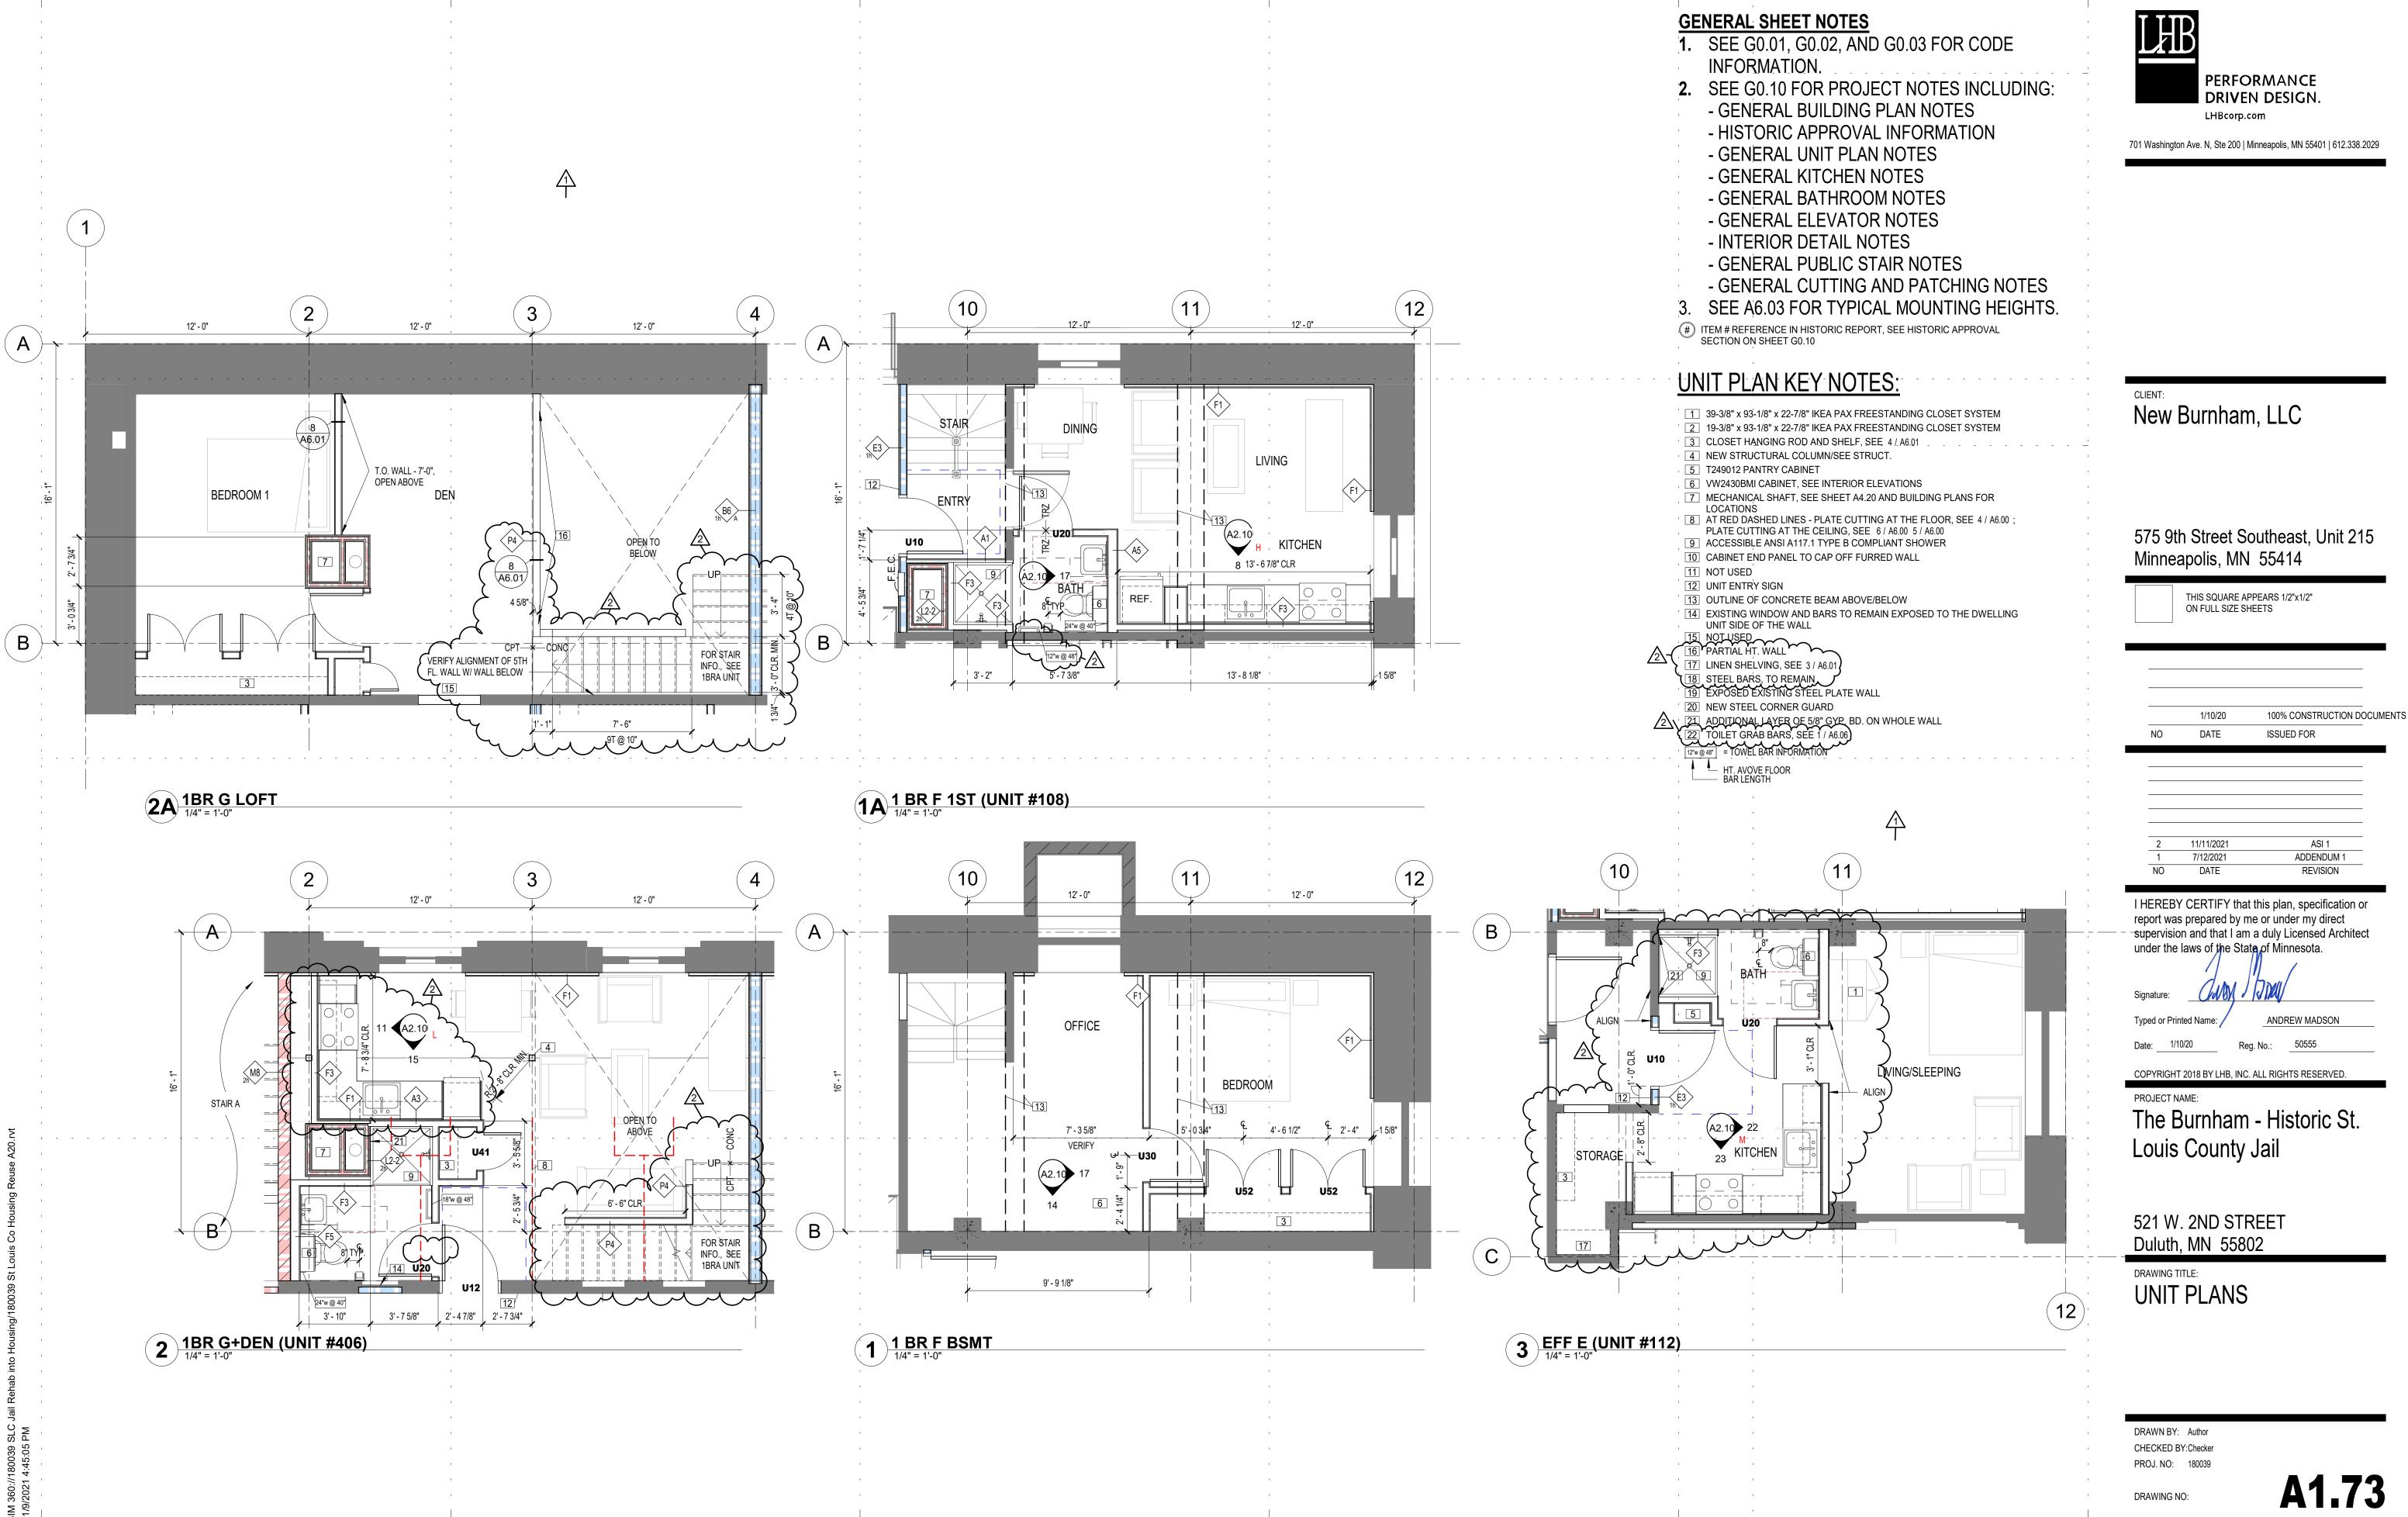
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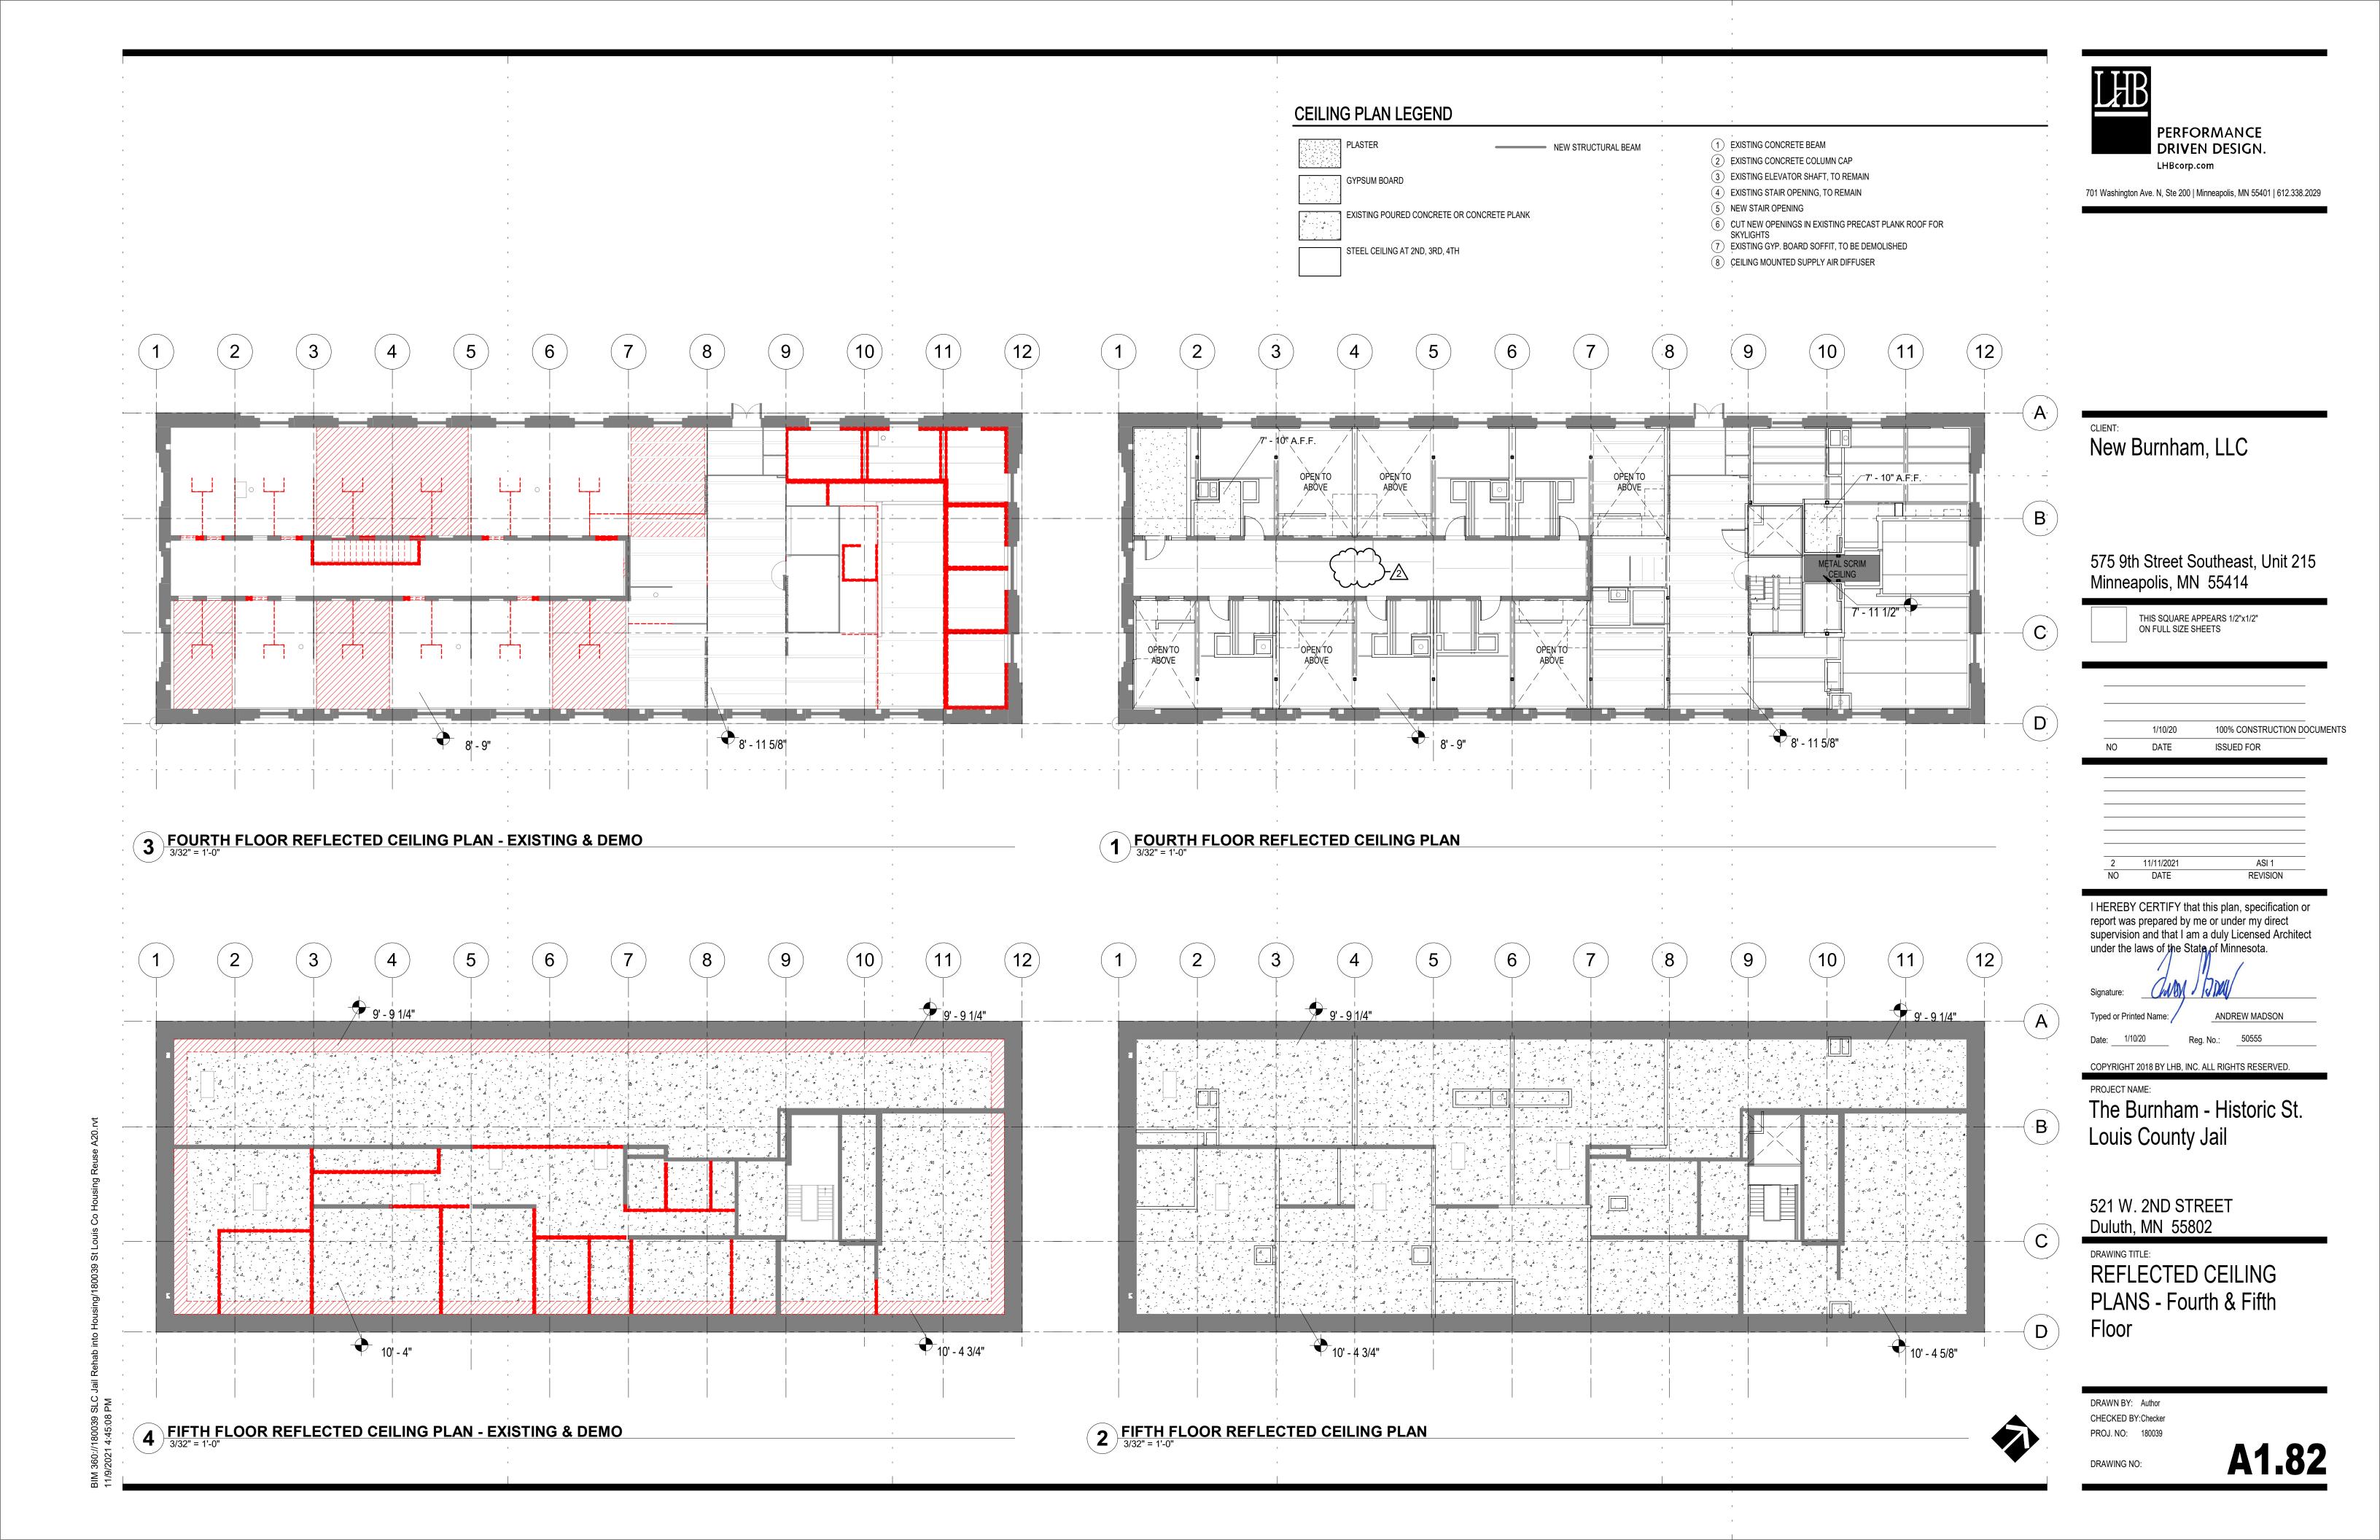
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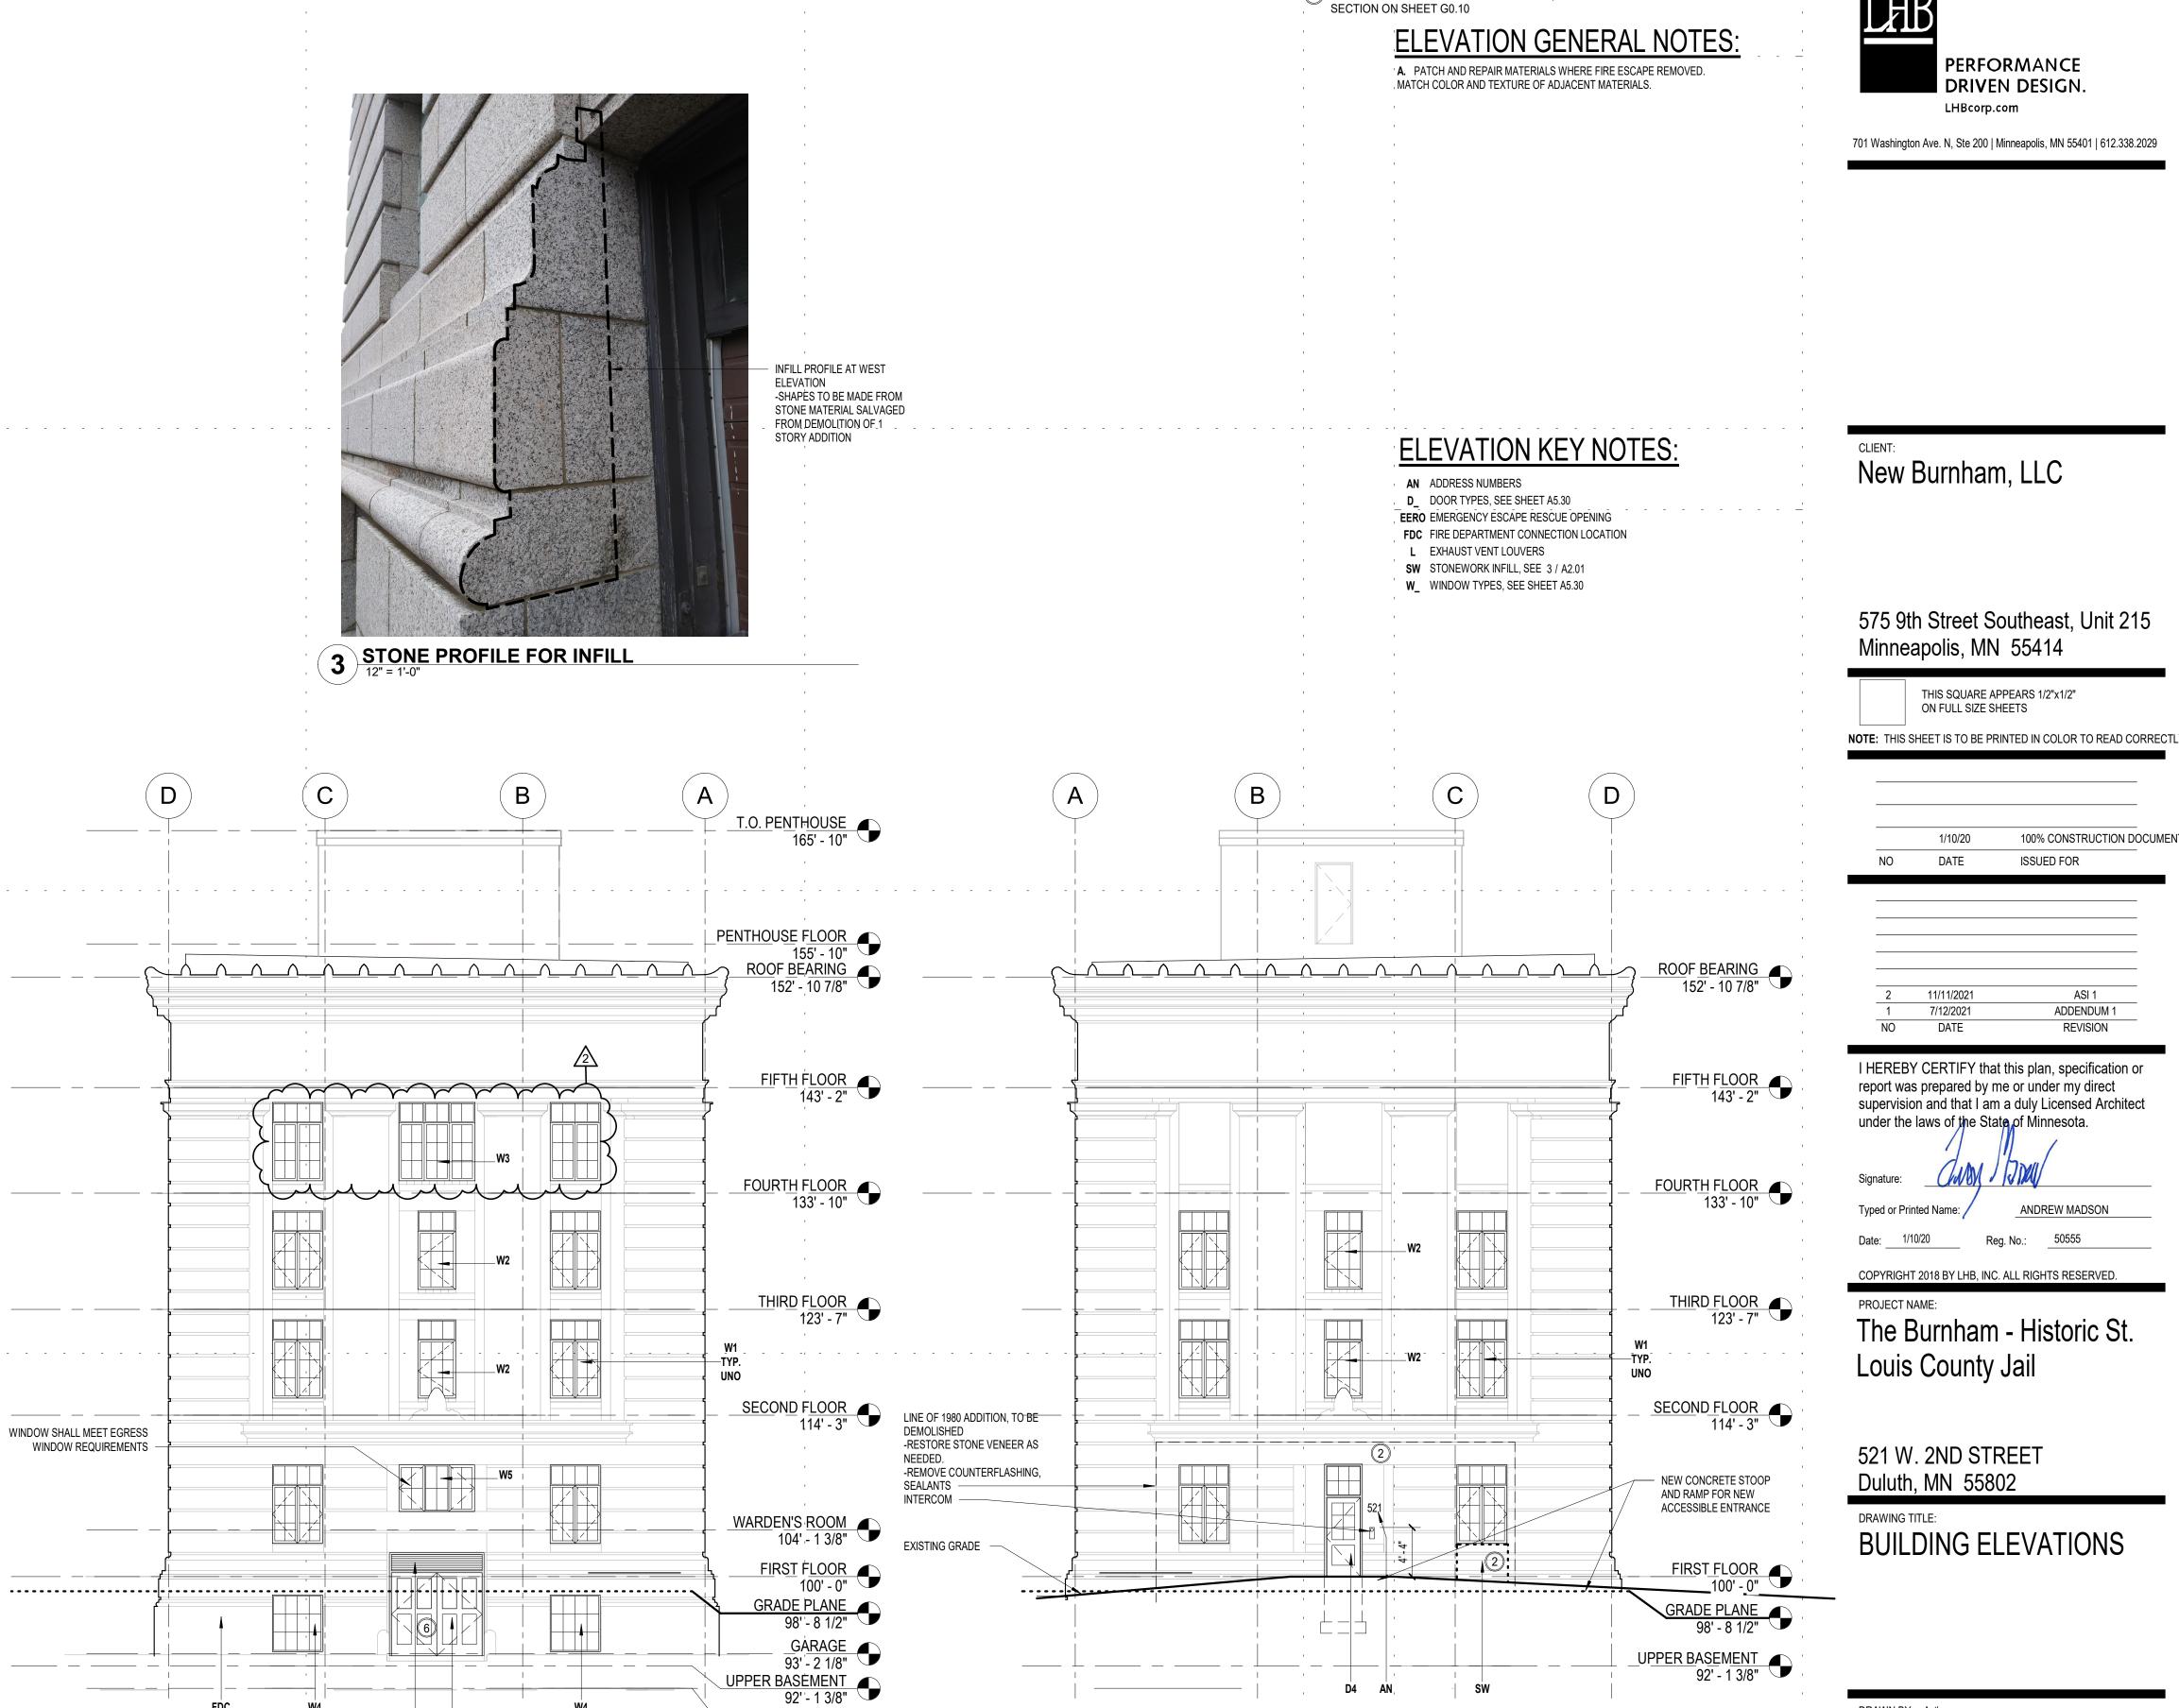
DRAWN BY: Author CHECKED BY:Checker PROJ. NO: 180039

DRAWING NO:

A1.72







1 WEST ELEVATION
1/8" = 1'-0"

LOWER BASEMENT 90' - 1 3/4"

2 EAST ELEVATION
1/8" = 1'-0"

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(#) ITEM # REFERENCE IN HISTORIC REPORT, SEE HISTORIC APPROVAL

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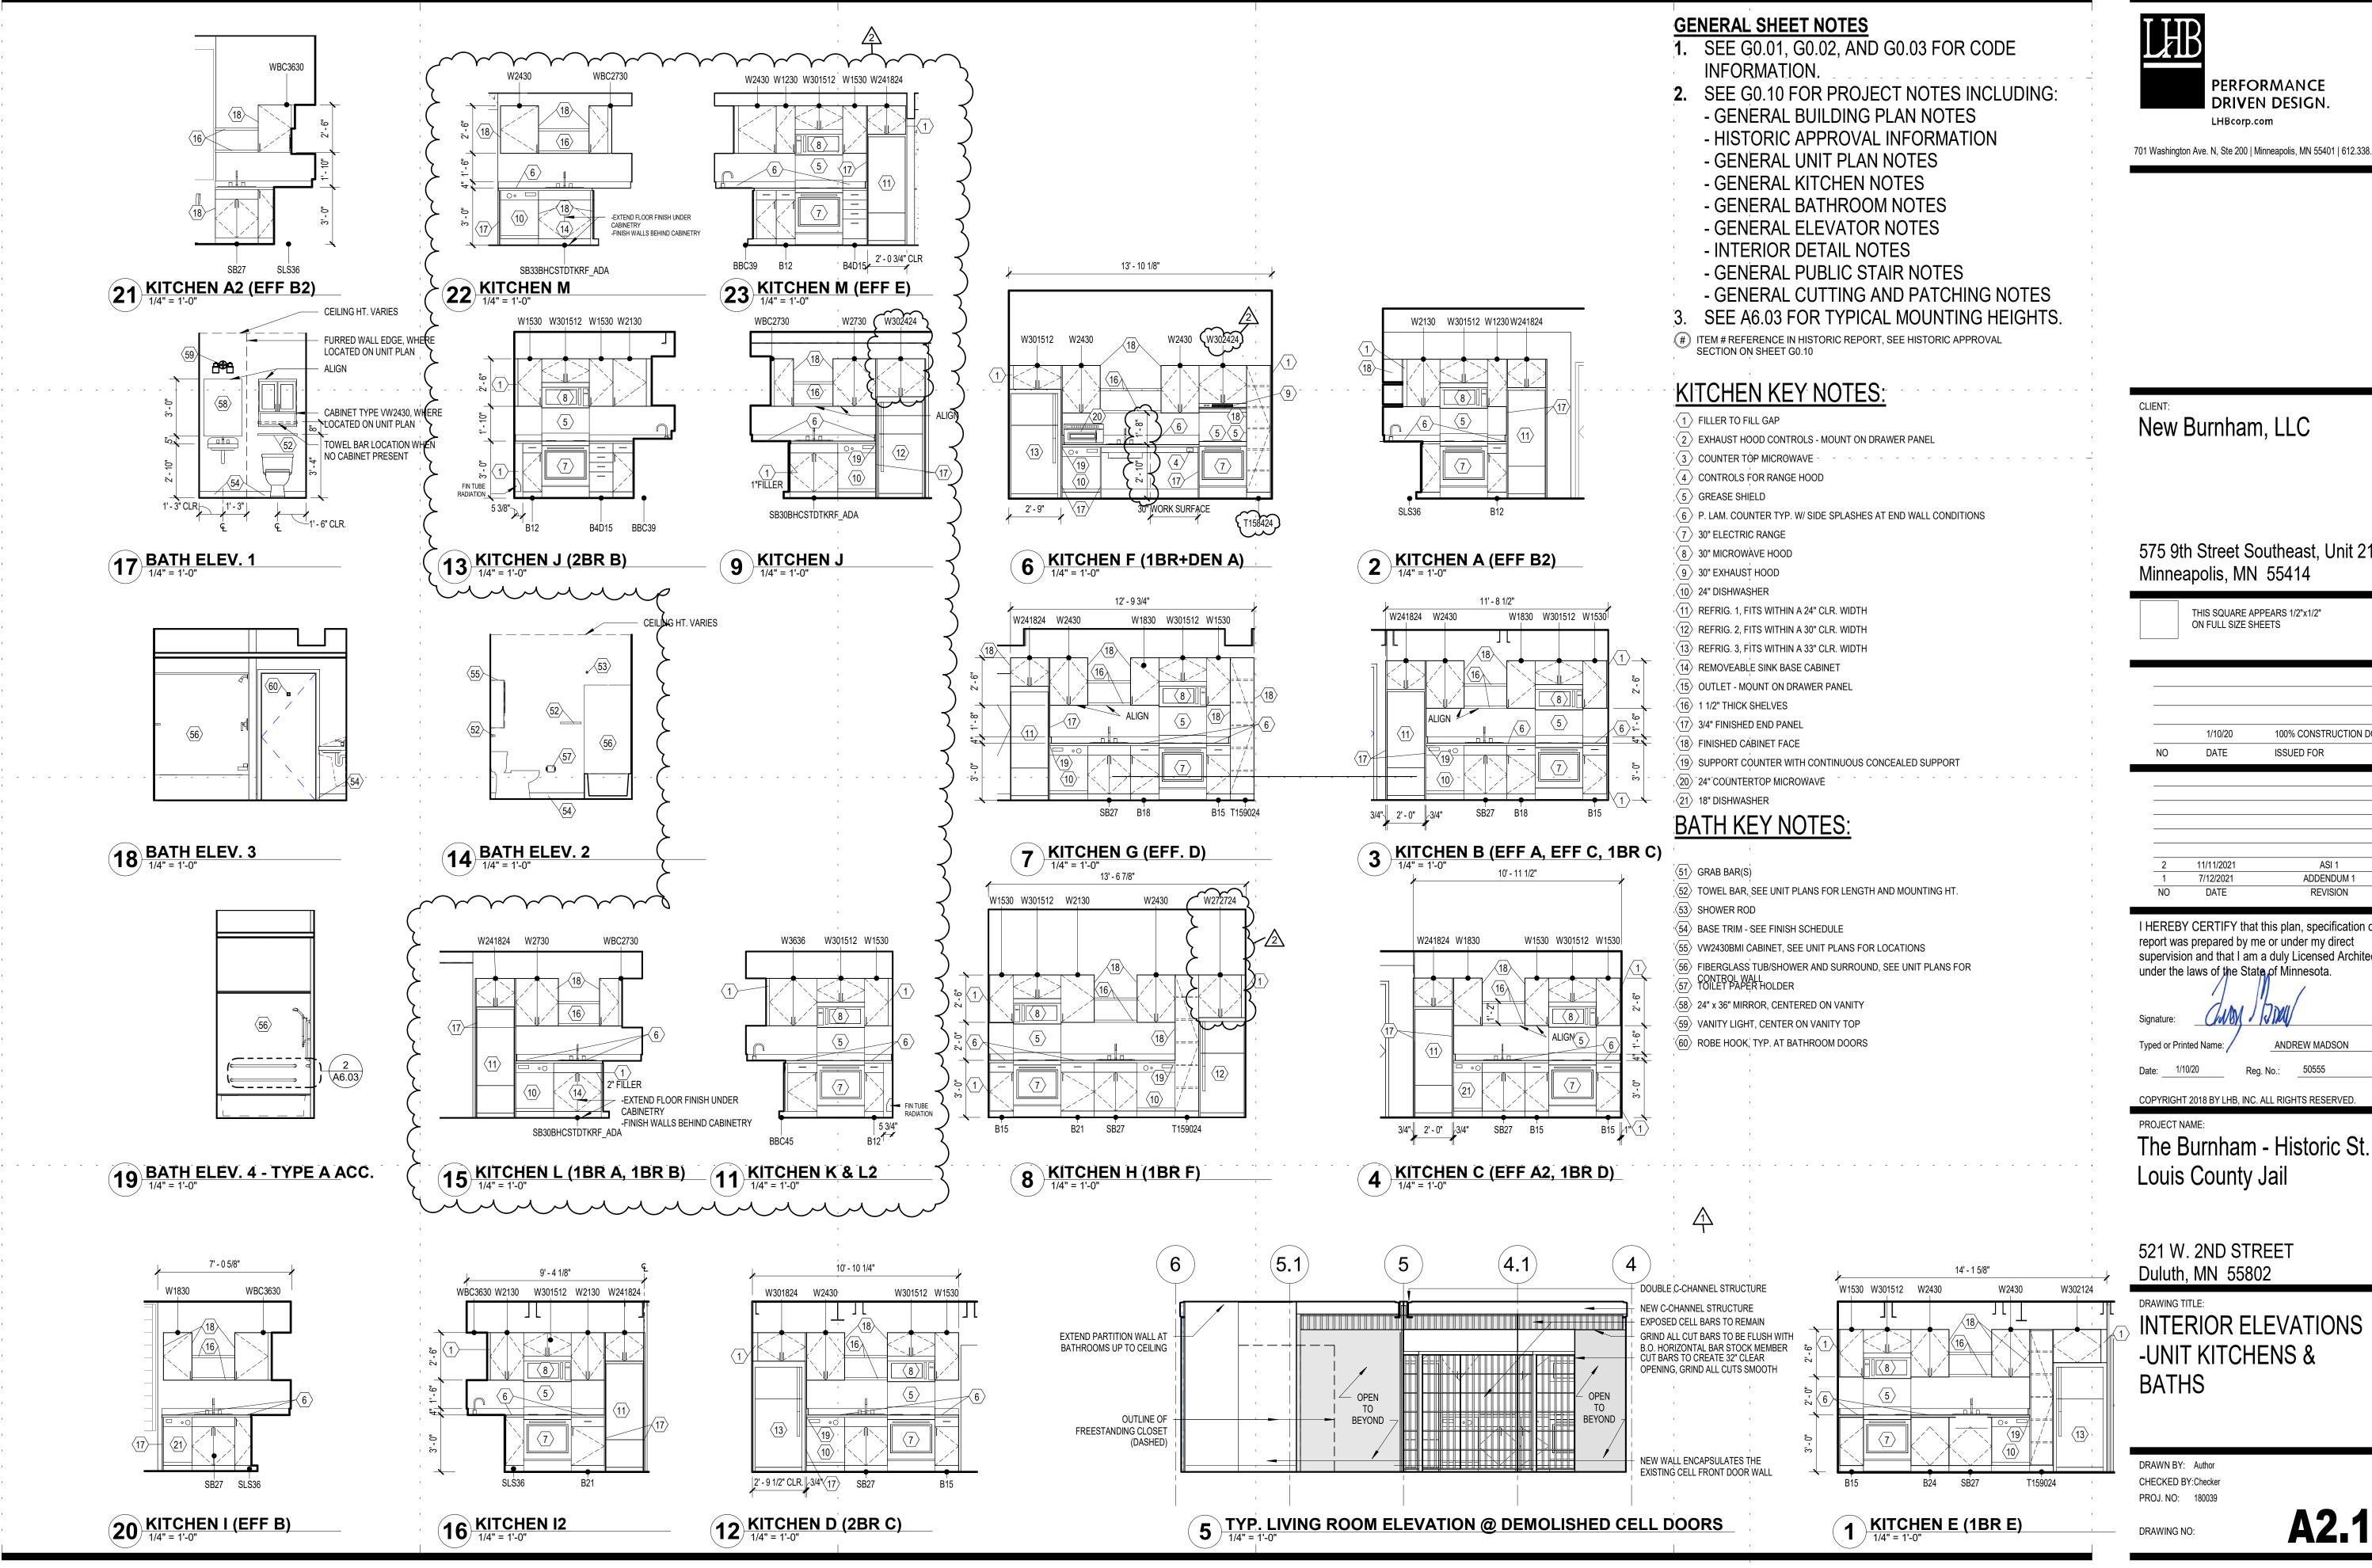
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DRAWING TITLE: **BUILDING ELEVATIONS**

DRAWN BY: Author CHECKED BY:Checker PROJ. NO: 180039

DRAWING NO:

A2.01



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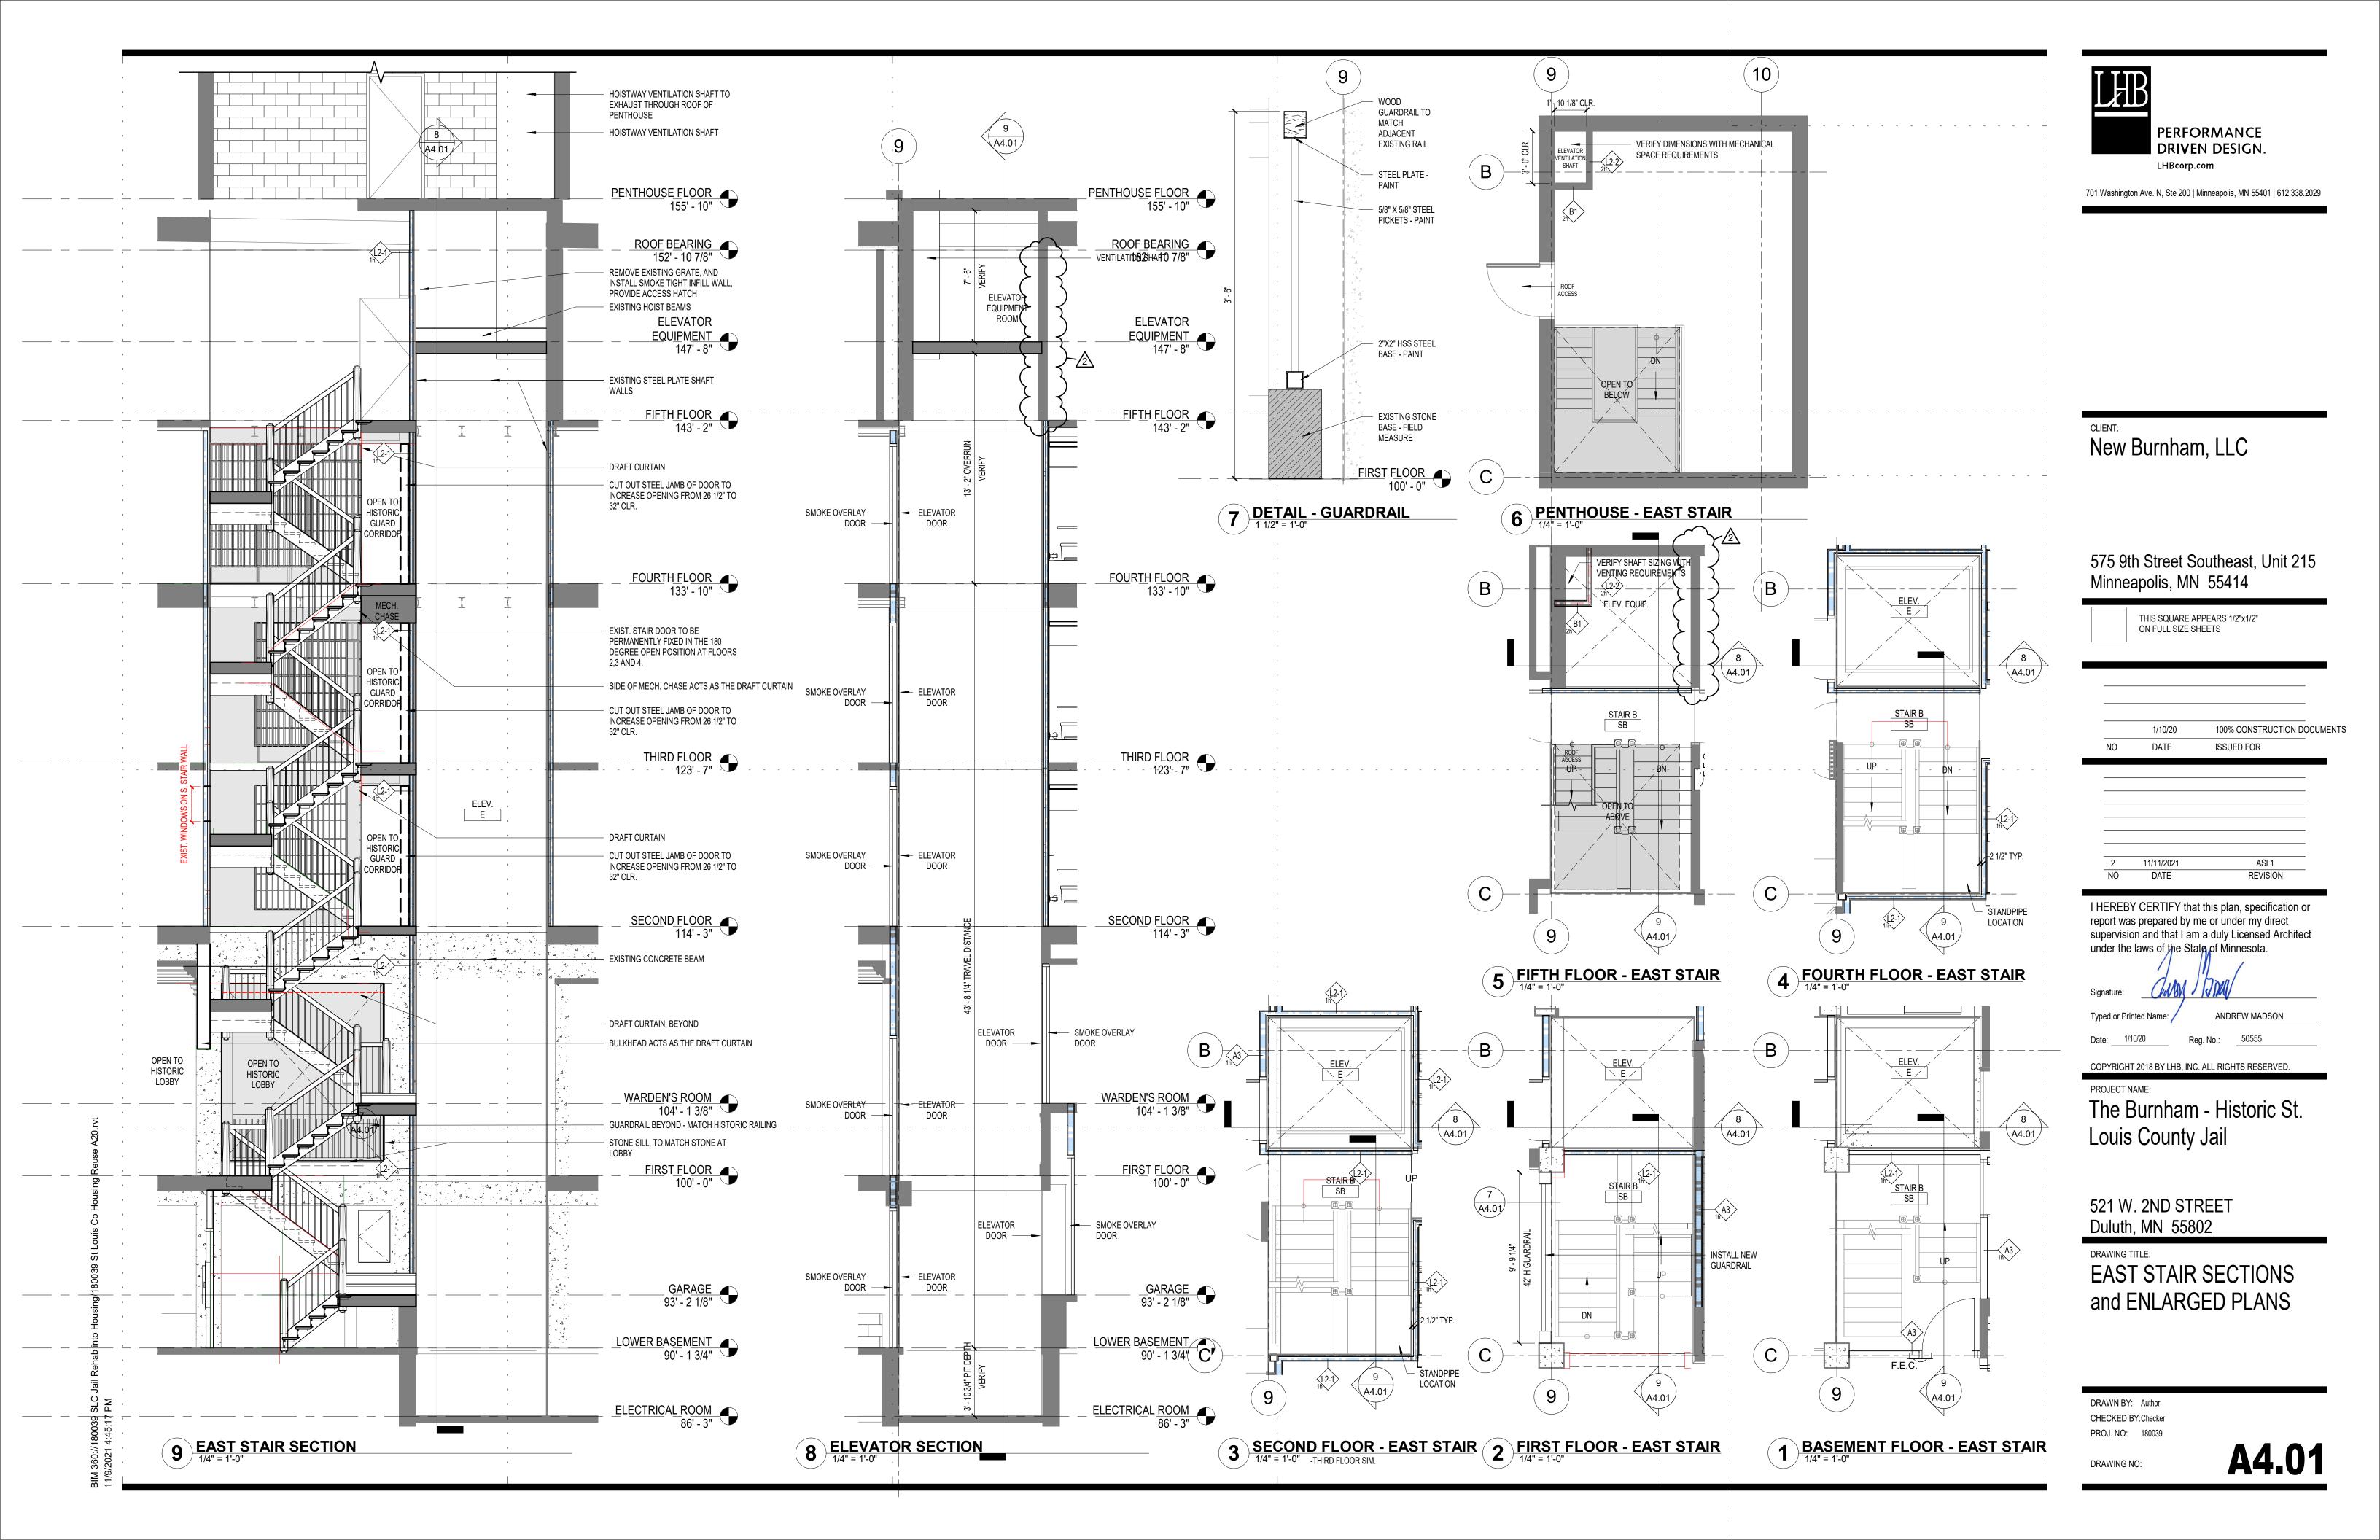
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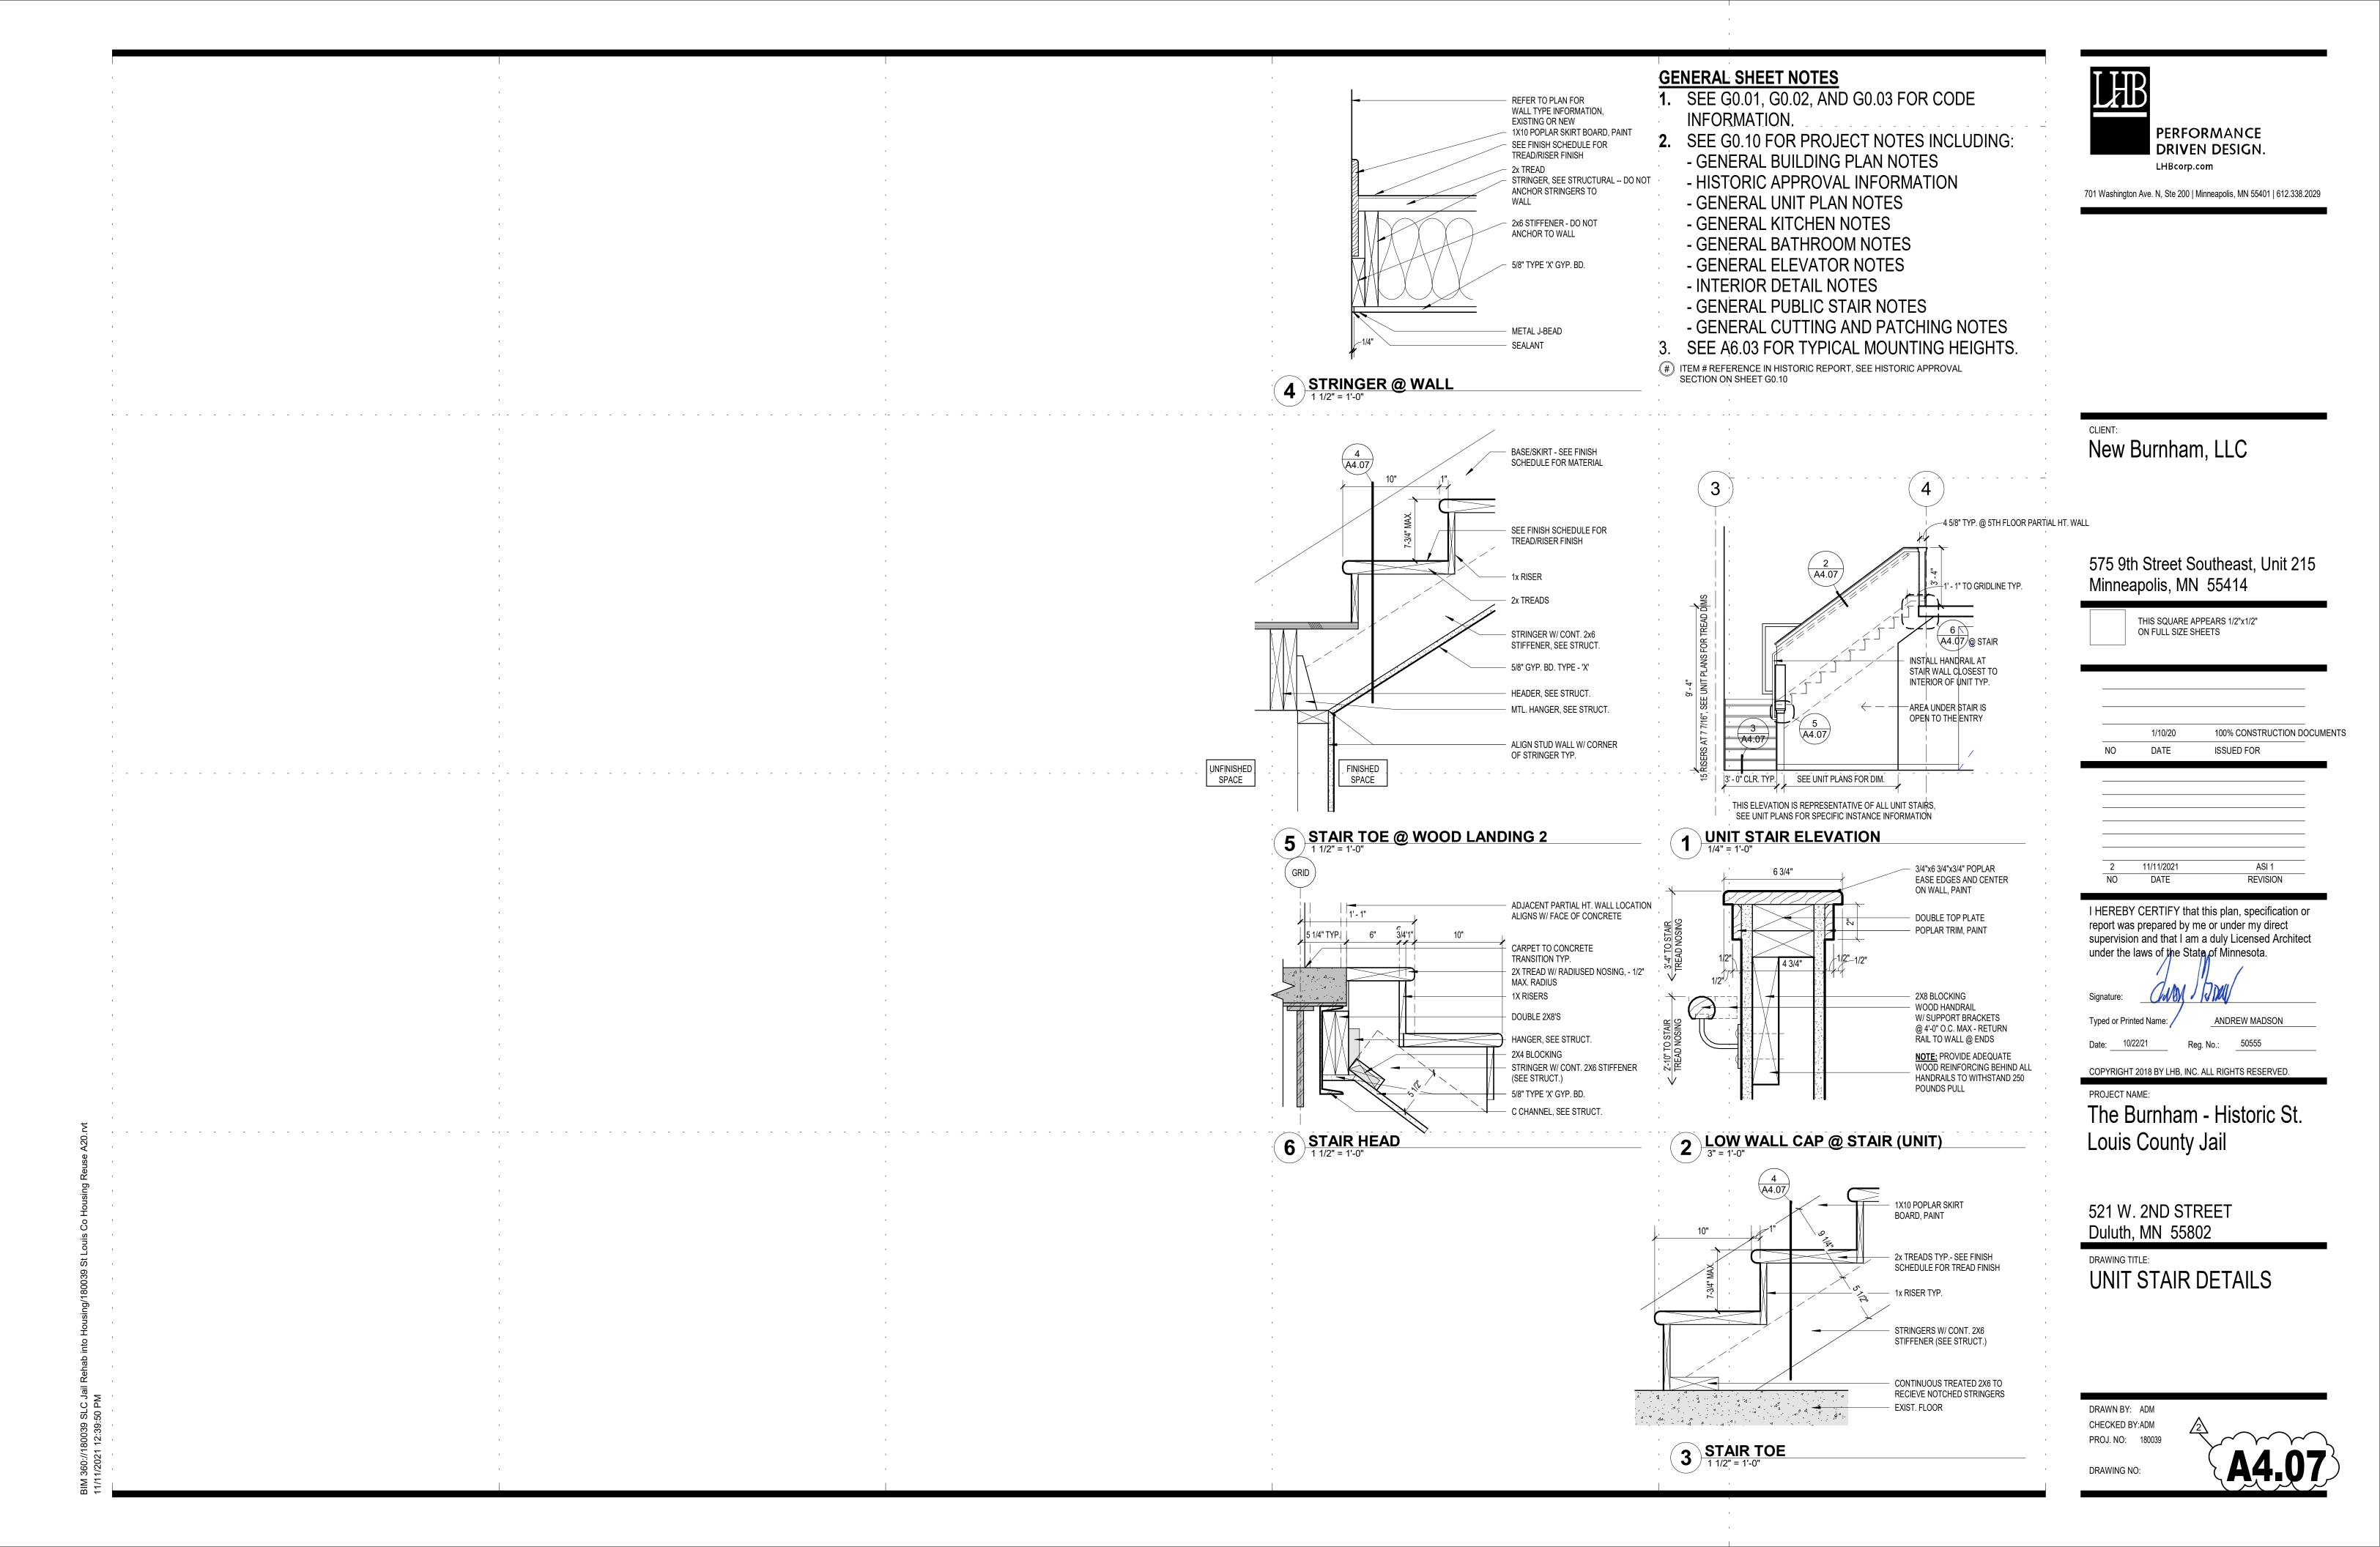
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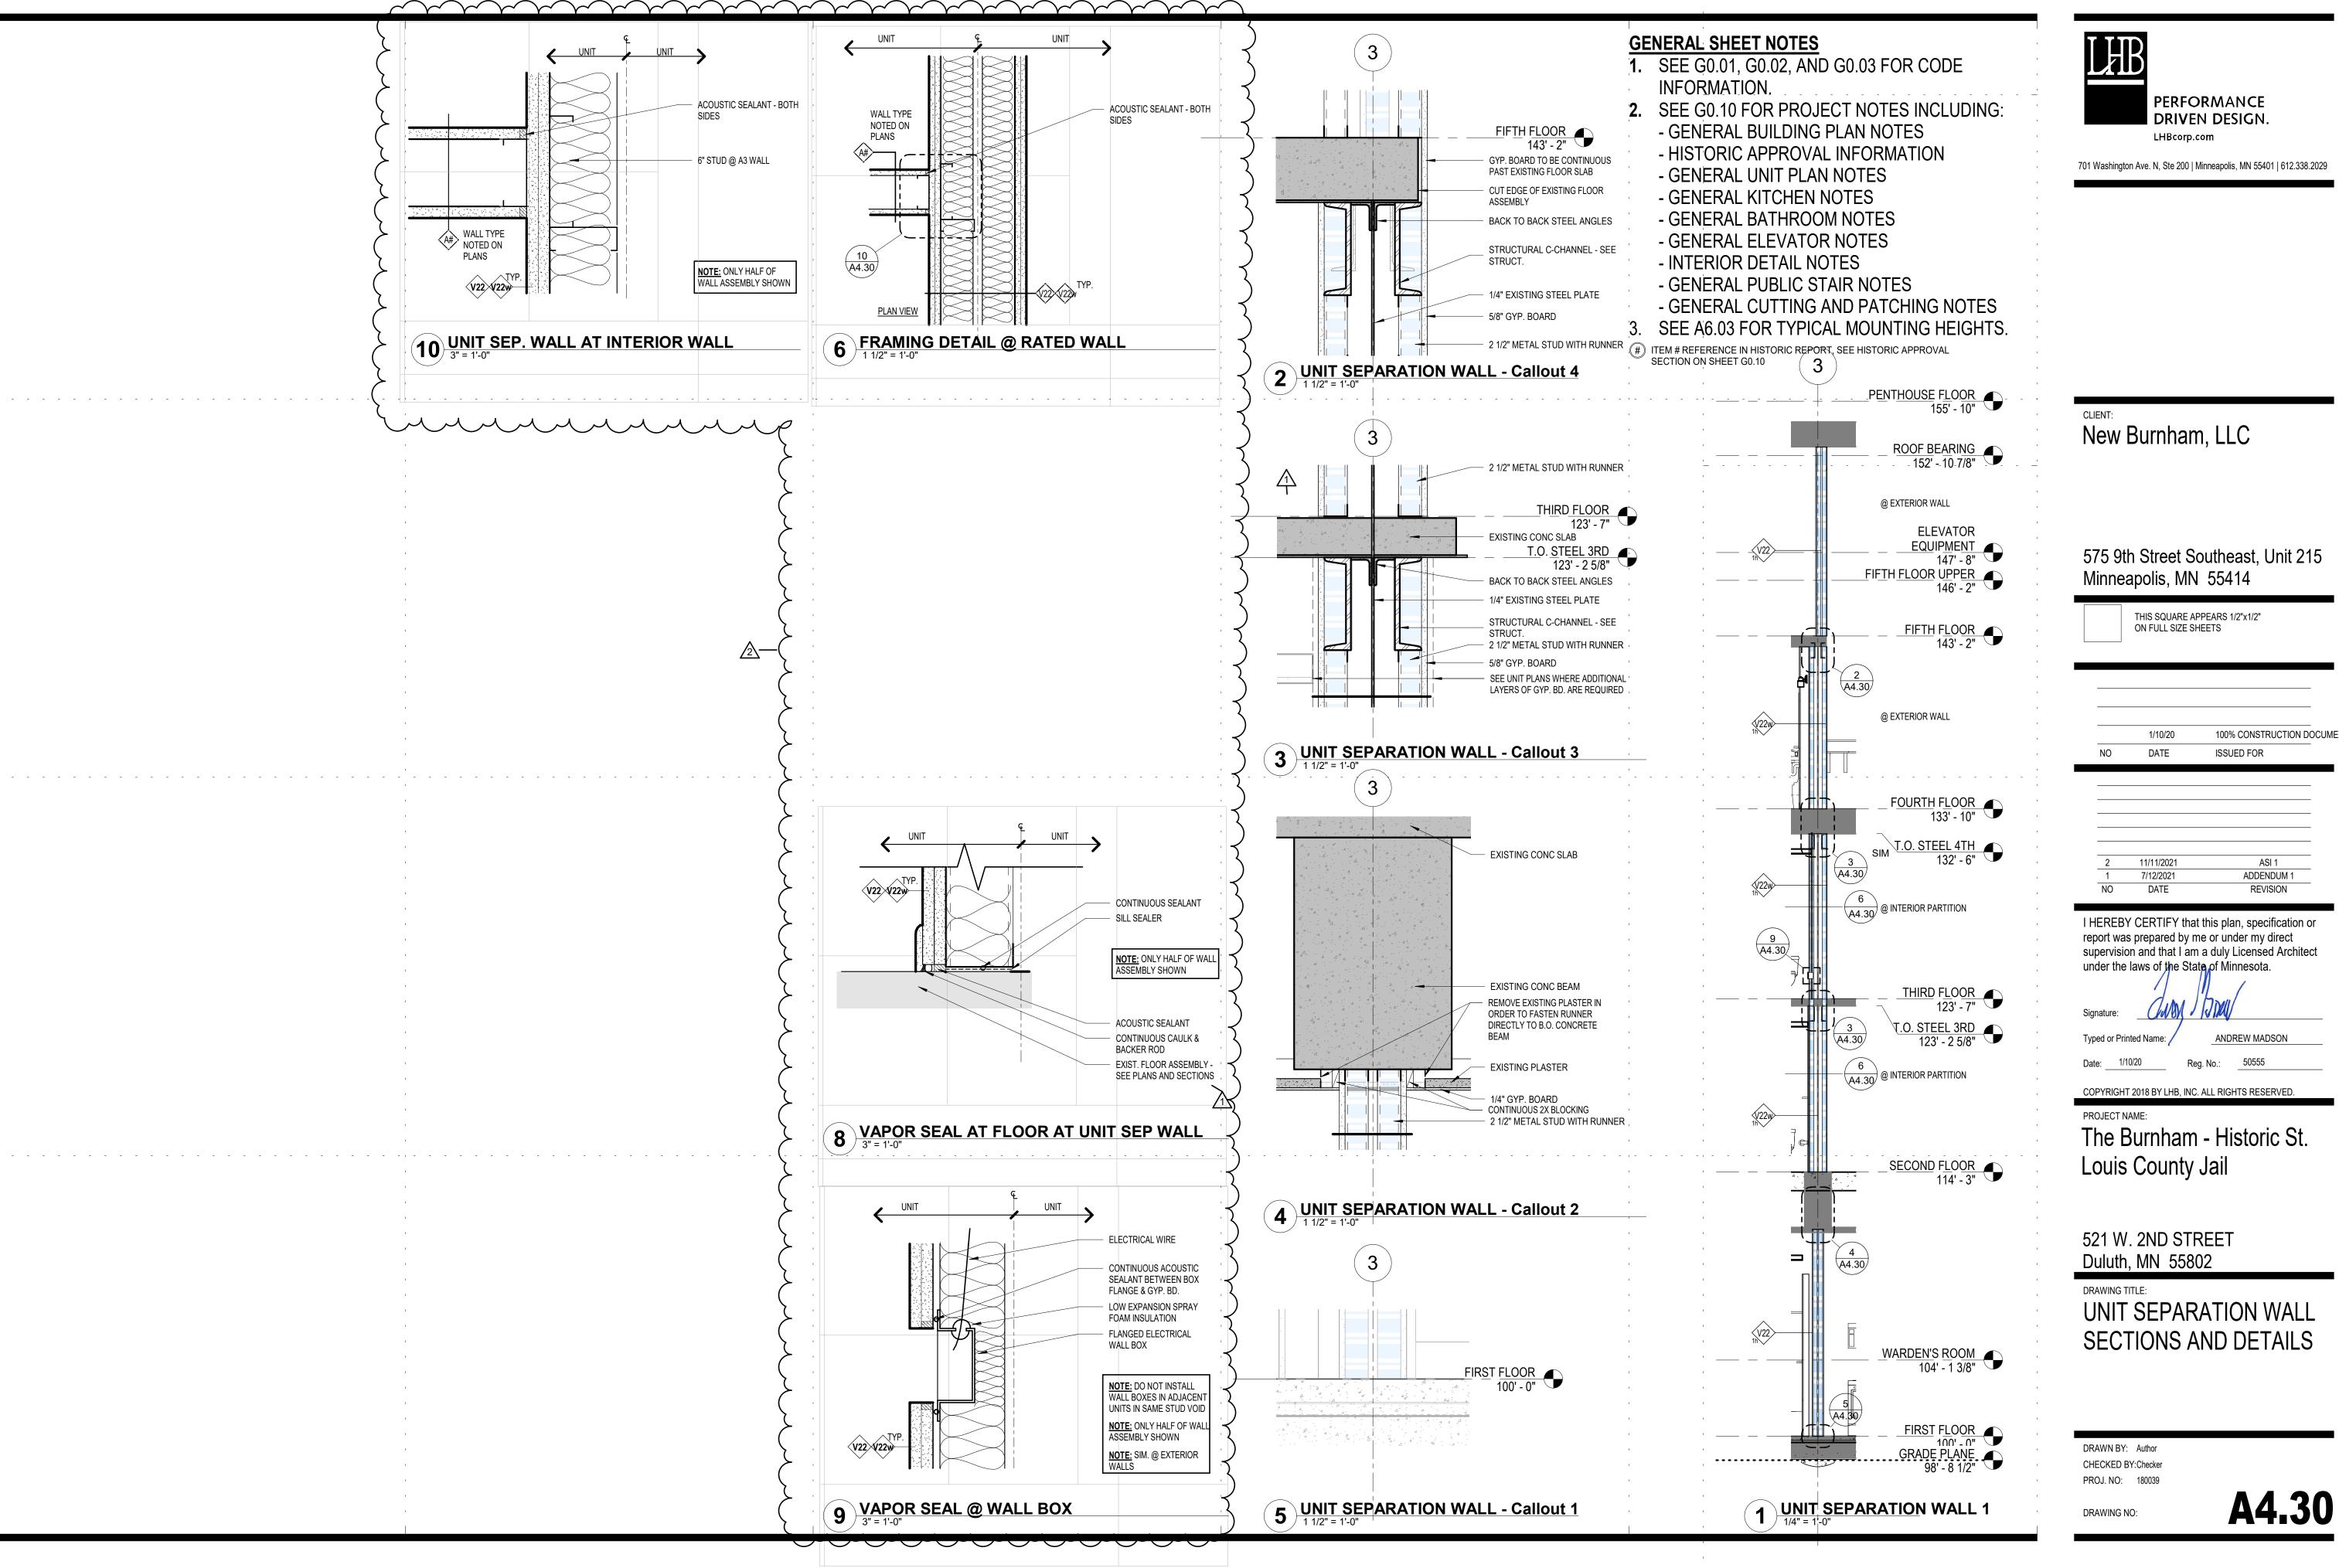
ANDREW MADSON

INTERIOR ELEVATIONS


A2.10







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7/12/2021

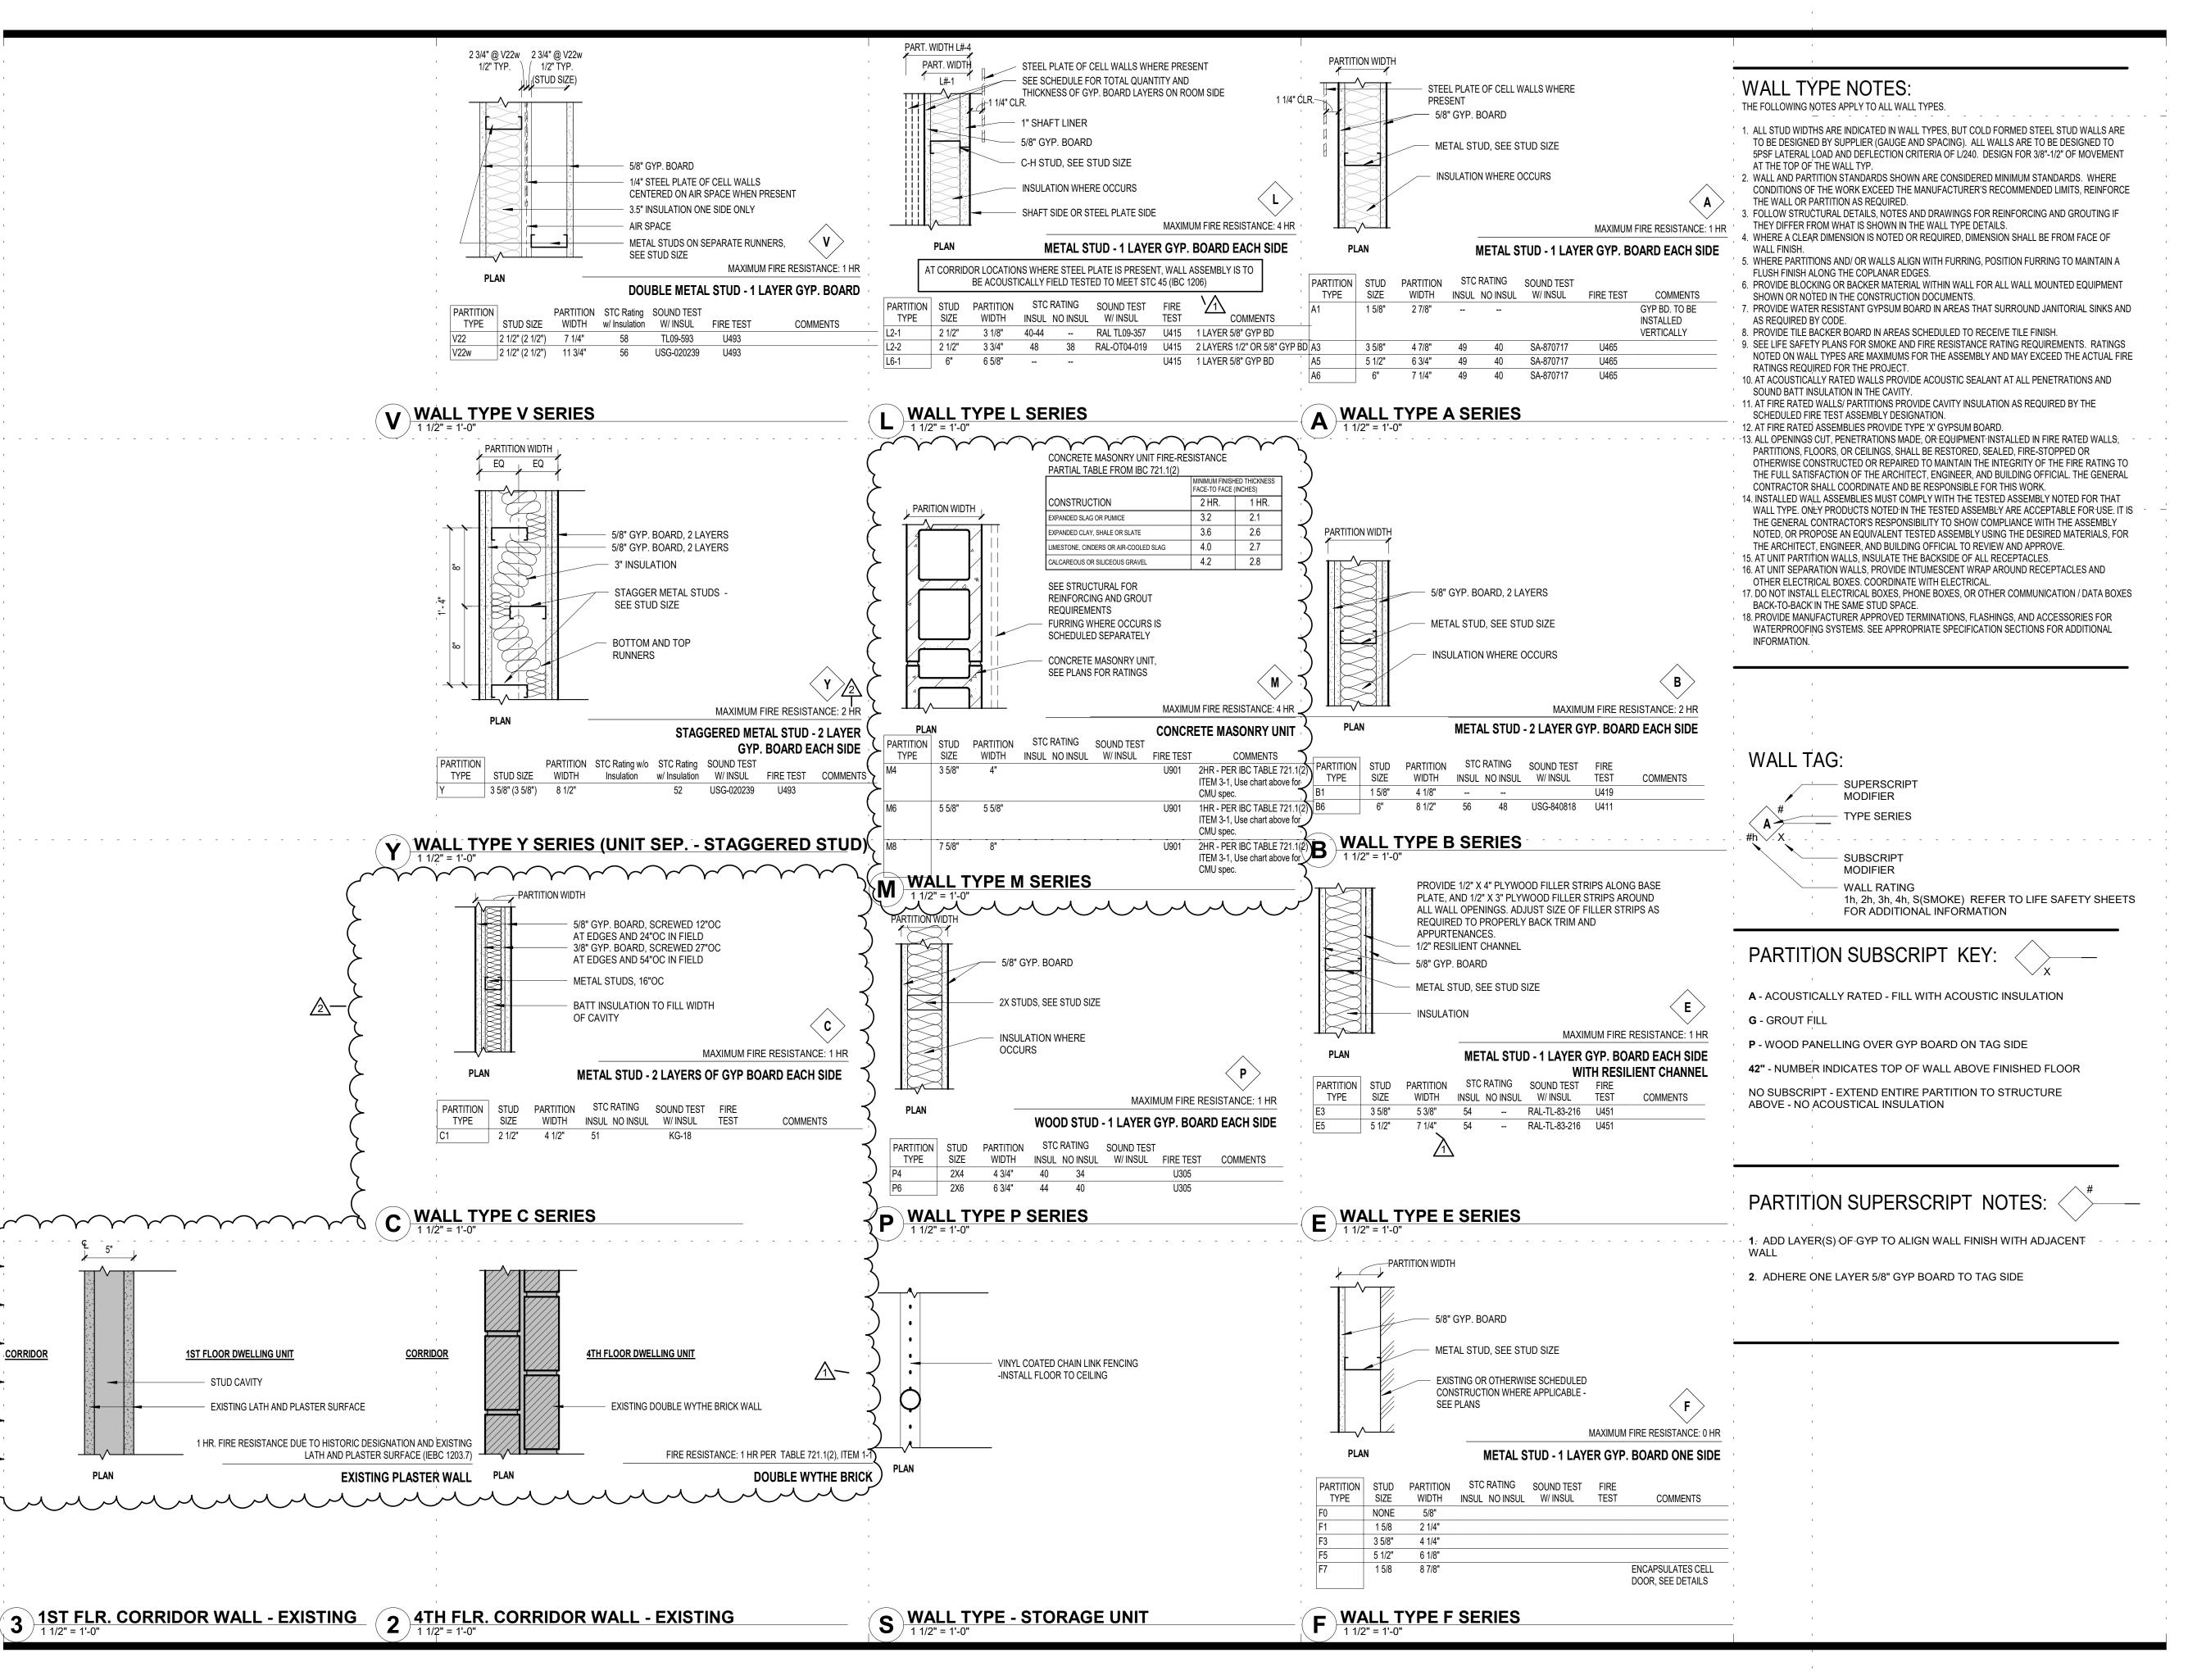Signature: __(

Typed or Printed Name: /

ne: ANDREW MADSON

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ADDENDUM 1

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PROJECT NAME:


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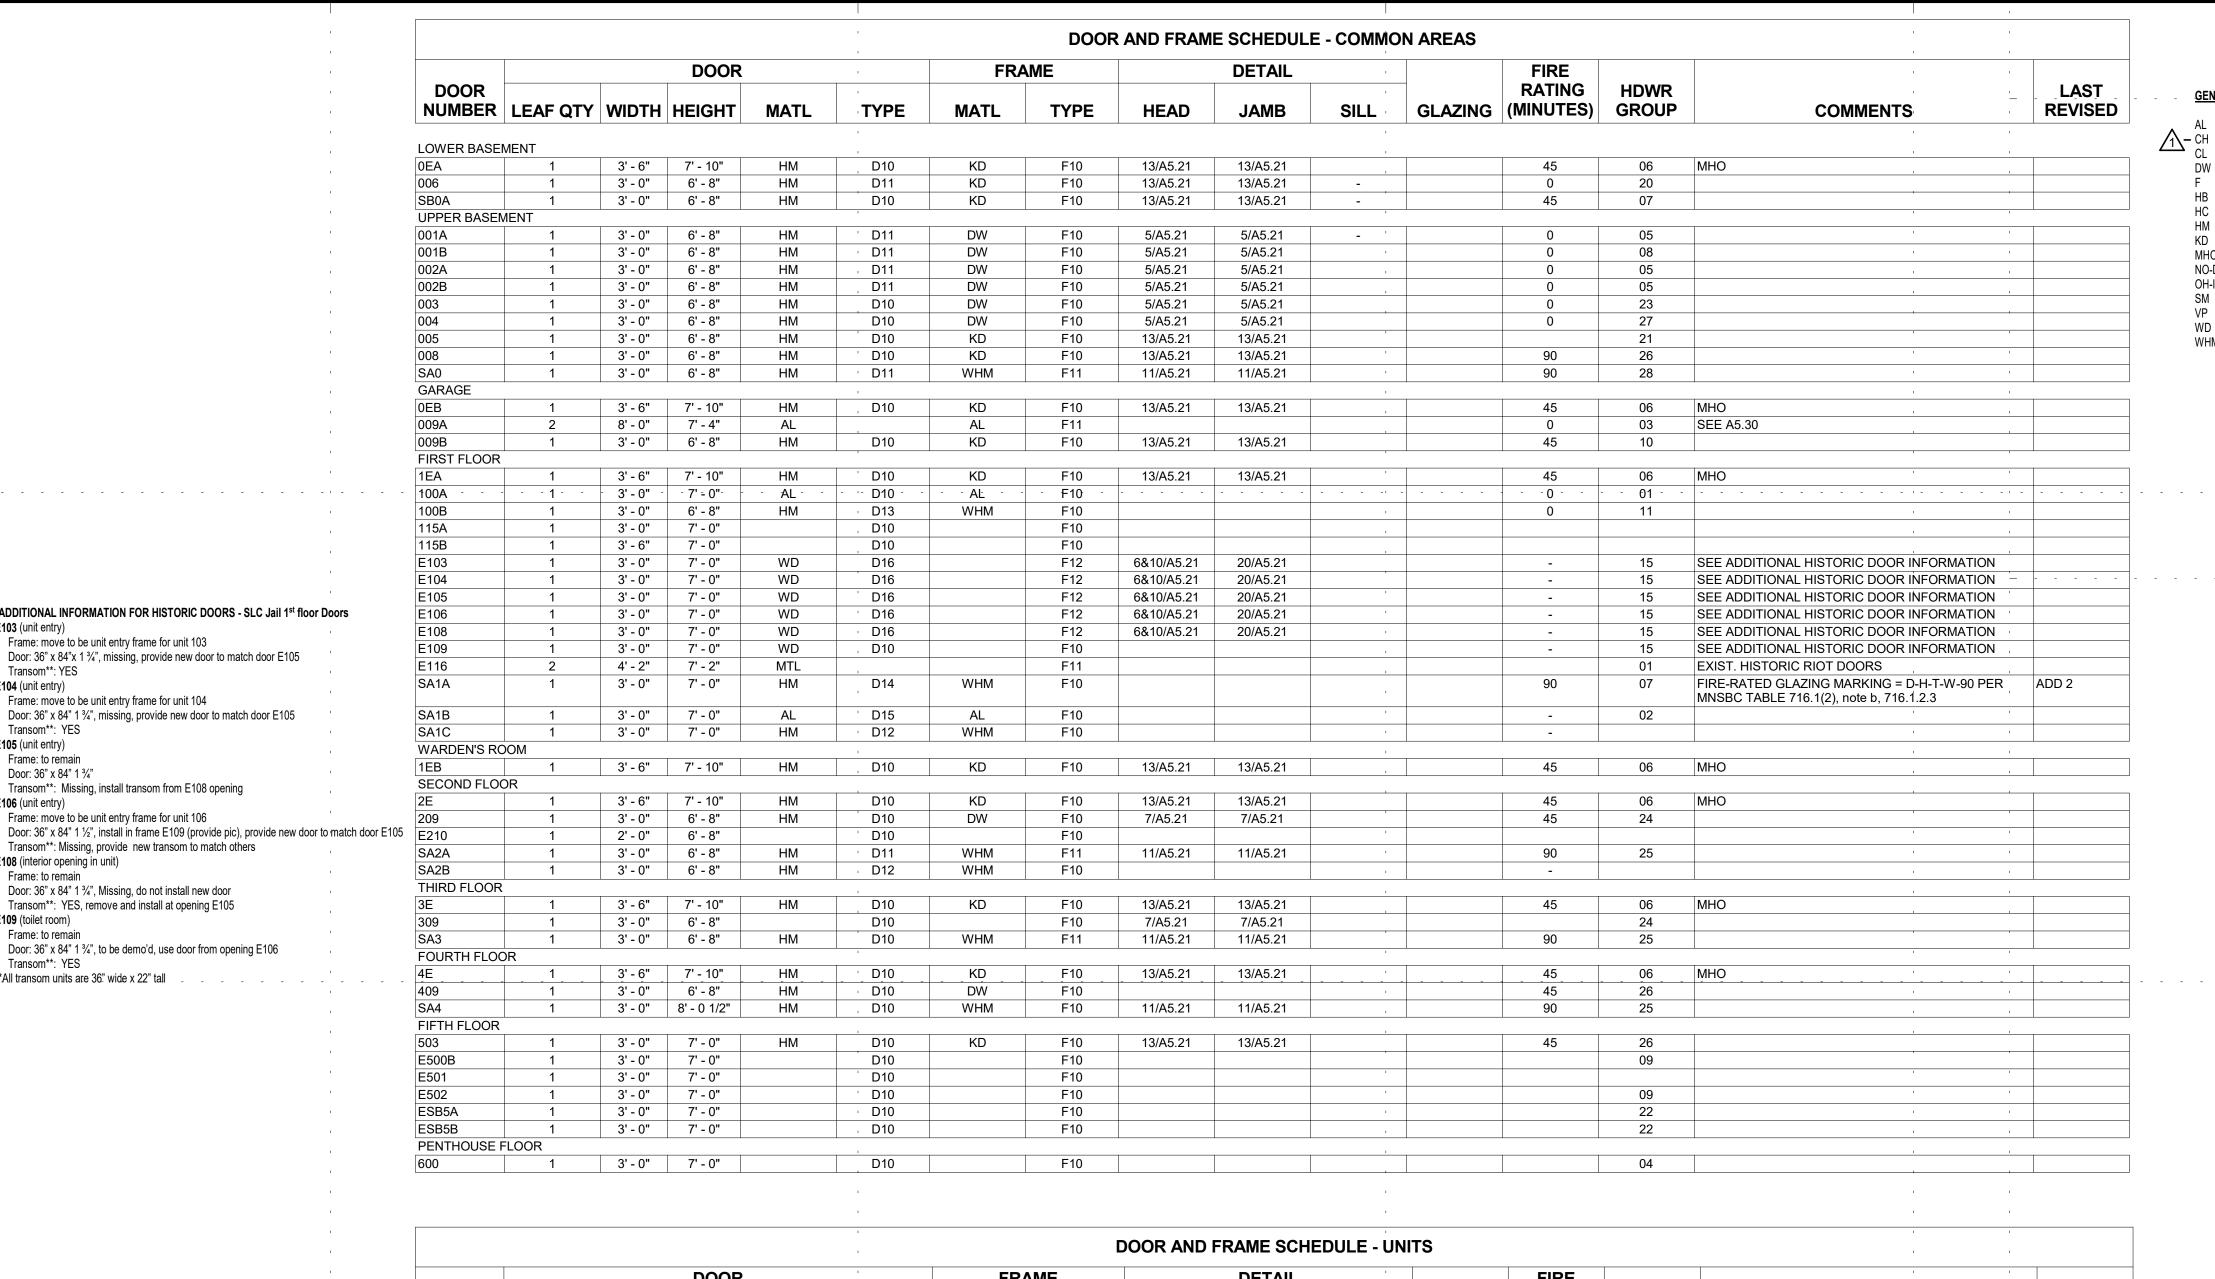
DRAWING TITLE:
WALL TYPES

DRAWN BY: ADM
CHECKED BY:Checker
PROJ. NO: 180039


DRAWING NO: A5.0



100% CONSTRUCTION DOCUMENTS

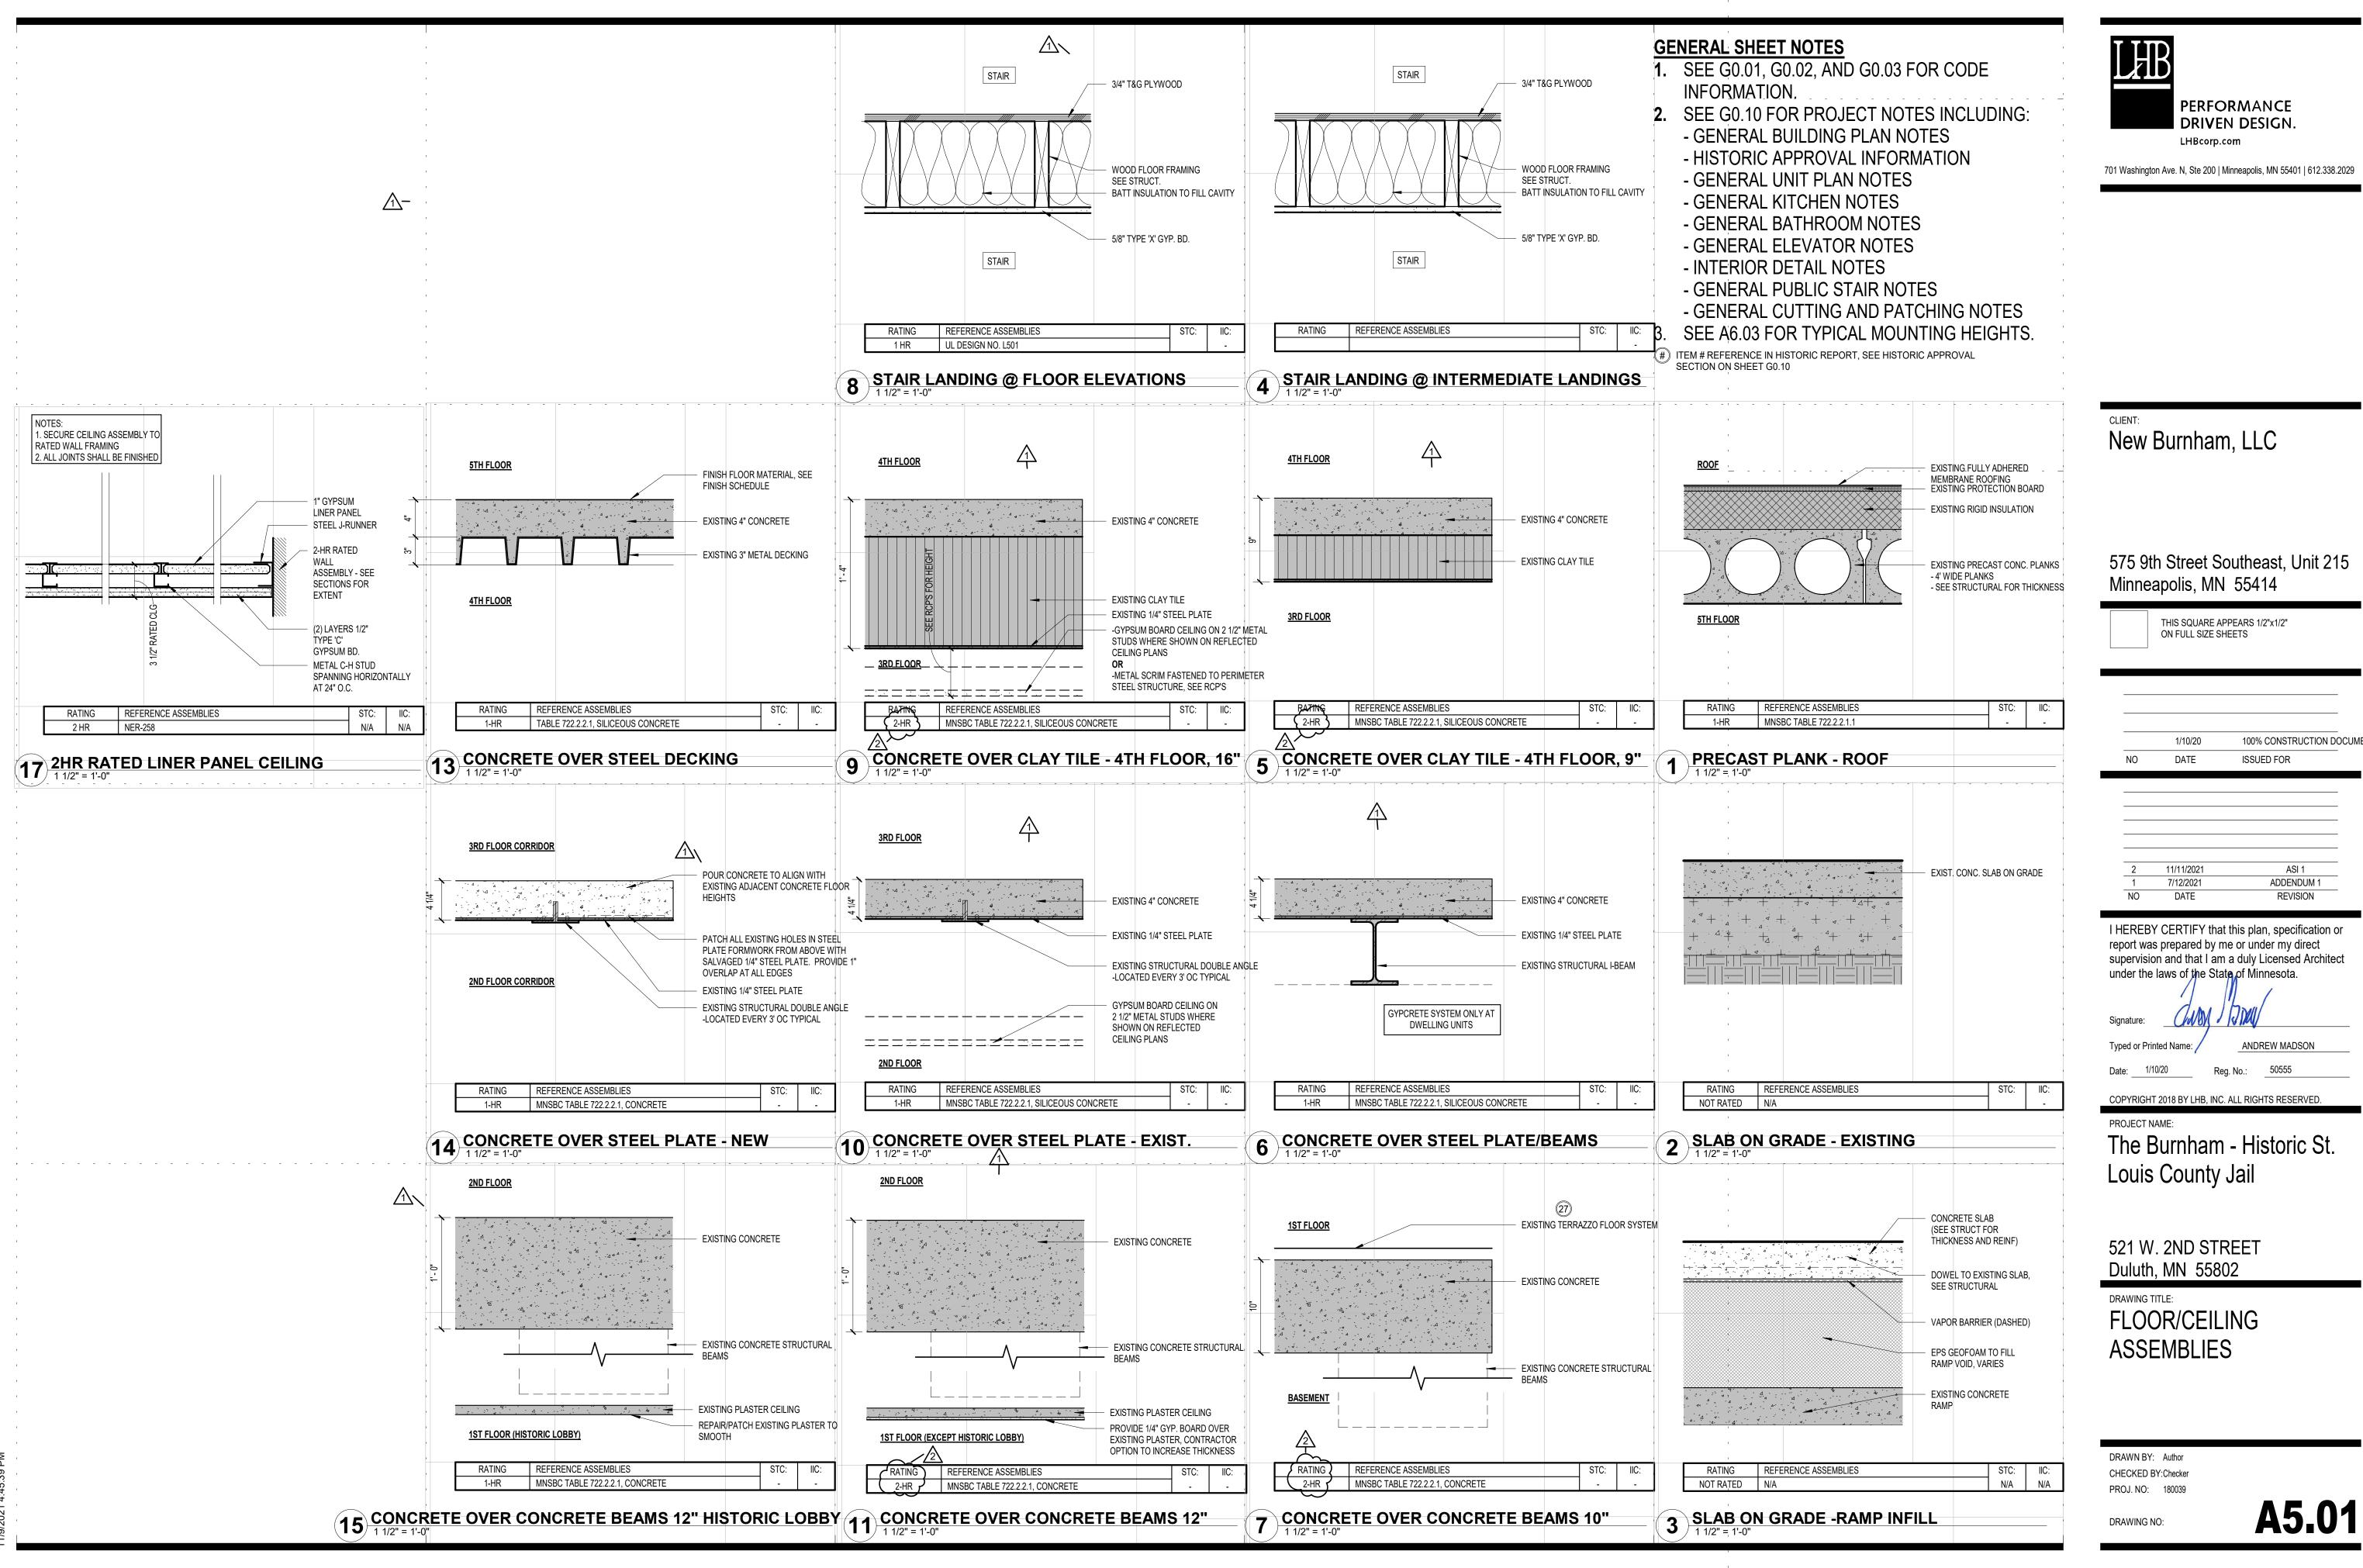

					1			DOOR AND F	RAME SCH	EDULE - UNI	TS			1	
			DOOR		1	FRA	ME		DETAIL	1	FIRE				
ID Type Mark	LEAF QTY	WIDTH	HEIGHT	MATL	TYPE	MATL	TYPE	HEAD	JAMB	SILL	GLAZING (MINUTES)	HDWR GROUP	COMMENTS		LAST REVISED
U01	1	3' - 0"	6' - 8"	СН	D-10	-	-		1/A5.21, 4/A5.21	- '		-	TENANTS TO PROVIDE LOCKS	,	ADD 1
U10	1	3' - 0"	7' - 0"	НВ	, D-10	DW	F-10	7/A5.21	7/A5.21	14/15.21	45	15	ı		
U12	1	3' - 0"	8' - 2"	HB	D-10	WHM	F-10	11/A5.21	11/A5.21	- ,	45	15		. /	ADD 1
U20	1	2' - 10"	6' - 8"	HC	D-10	DW	F-10	5/A5.21	5/A5.21			16			
U21	1	3' - 0"	6' - 8"	HC	D-10	DW	F-10	5/A5.21	5/A5.21	- '		16	•		
U22	1	2' - 6"	6' - 8"	HC	D-10	DW	F-10	5/A5.21	5/A5.21	- '		16	ı		
U30 ⁻	1	2' - 10"	⁻ 6' - 8" ⁻	- HC	- '- D-10	DM	- F-10 -	⁻ 5/A5.21 ⁻	⁻ 5/A5.21 ⁻			16			
U31	1	3' - 0"	6' - 8"	HC	D-10	DW	F-10	5/A5.21	5/A5.21	- '		16	,		
U41	1	2' - 0"	6' - 8"	HC	D-10	DW	F-10	5/A5.21	5/A5.21	- ,		17	T. Control of the con		
U43	1	2' - 6"	6' - 8"	HC	D-10	DW	F-10	5/A5.21	5/A5.21	- ,		17	1		
U44	1	2' - 8"	6' - 8"	HC	D-10	DW	F-10	5/A5.21	5/A5.21			17			
U45	1	2' - 10"	6' - 8"	HC	D-10	DW	F-10	5/A5.21	5/A5.21	-		17			
U51	2	3' - 6"	6' - 8"	HC	D-10	DW	F-10	5/A5.21	5/A5.21	- '		14			
U52	2	4' - 0"	6' - 8"	HC	D-10	DW	F-10	5/A5.21	5/A5.21	- '		14	ı		
U90	1	3' - 2"	6' - 8"	HB	D-09	-	-	17/A5.21	18/A5.21	- '		13	1		

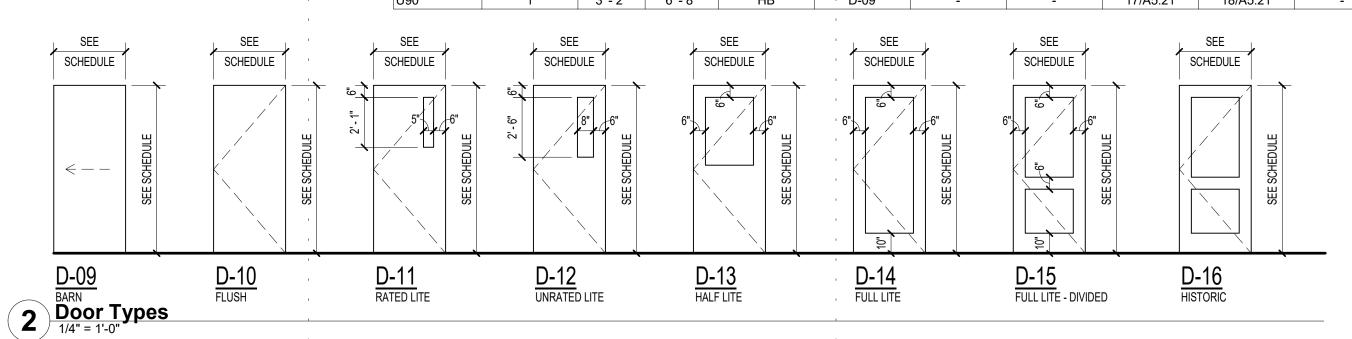

SCHEDULE SCHEDULE SEE SCHEDULE <u>F-10</u> <u>F-11</u> <u>F-12</u> HISTORIC 1 Frame Types
1/4" = 1'-0"

PERFORMANCE DRIVEN DESIGN. LHBcorp.com

GENERAL DOOR SCHEDULE ABBREVIATIONS:

Drywall (3 piece frame w/ snap-on trim)

Knock Down (3 piece frame w/ integral trim)

Chainlink

FOB Access

Hard Board

Hollow Metal

NO-DO

WD

OH-INS

Hollow Core (Door)

Magnetic Hold Open

Overhead Insulated (Door)

Welded Hollow Metal (Frame)

No Door Operator

Smoke Gasketing

View Panel

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DRAWING TITLE: DOOR SCHEDULE and FRAME TYPES

DRAWN BY: Author CHECKED BY:Checker PROJ. NO: 180039

DRAWING NO:

A5.20

*ADDITIONAL INFORMATION FOR HISTORIC DOORS - SLC Jail 1st floor Doors

Door: 36" x 84"x 1 3/4", missing, provide new door to match door E105

Door: 36" x 84" 1 3/4", missing, provide new door to match door E105

Frame: move to be unit entry frame for unit 103

Frame: move to be unit entry frame for unit 104

Transom**: Missing, install transom from E108 opening

Transom**: Missing, provide new transom to match others

Door: 36" x 84" 1 3/4", Missing, do not install new door

Transom**: YES, remove and install at opening E105

Door: 36" x 84" 1 3/4", to be demo'd, use door from opening E106

Frame: move to be unit entry frame for unit 106

E103 (unit entry)

E104 (unit entry)

Transom**: YES

Transom**: YES

Frame: to remain

Door: 36" x 84" 1 3/4"

E108 (interior opening in unit)

Frame: to remain

E109 (toilet room)


_ _ _ _ **All transom units are 36" wide x 22" tall

Frame: to remain

Transom**: YES

E105 (unit entry)


E106 (unit entry)

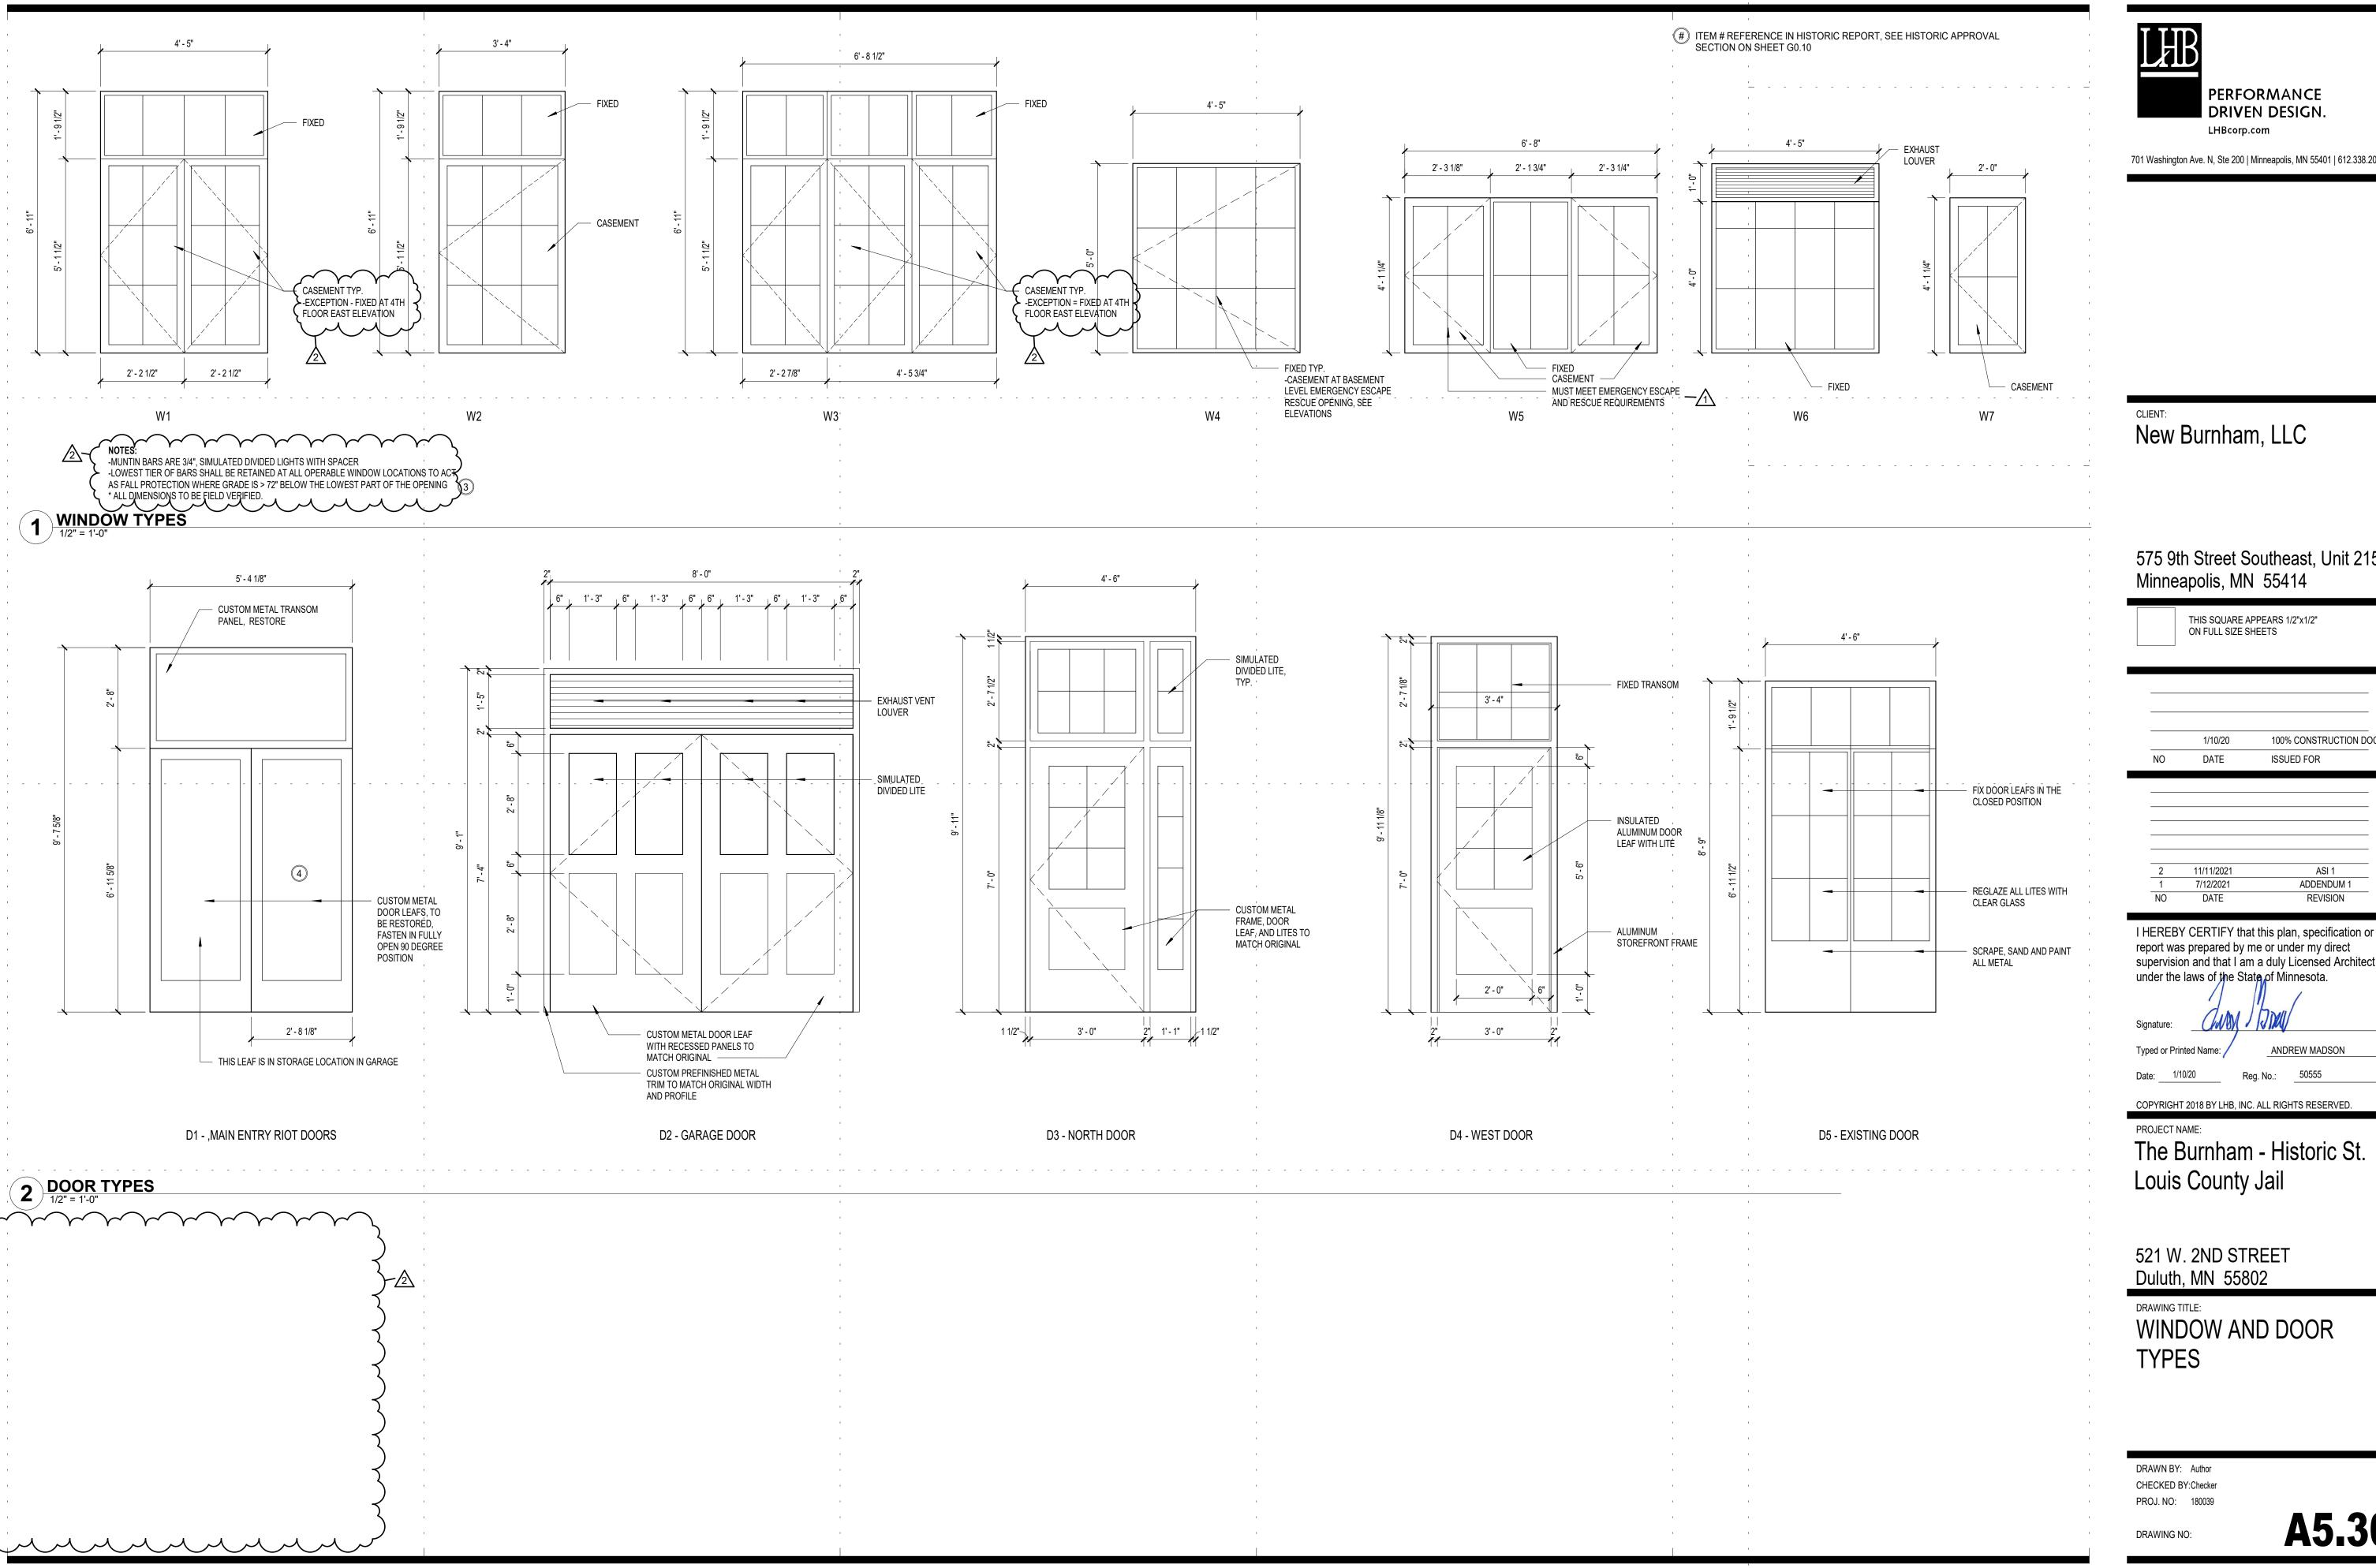

575 9th Street Southeast, Unit 215


1/10/20 100% CONSTRUCTION DOCUM NO DATE ISSUED FOR			
		1/10/20	100% CONSTRUCTION DOCUM
	NO		

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ANDREW MADSON
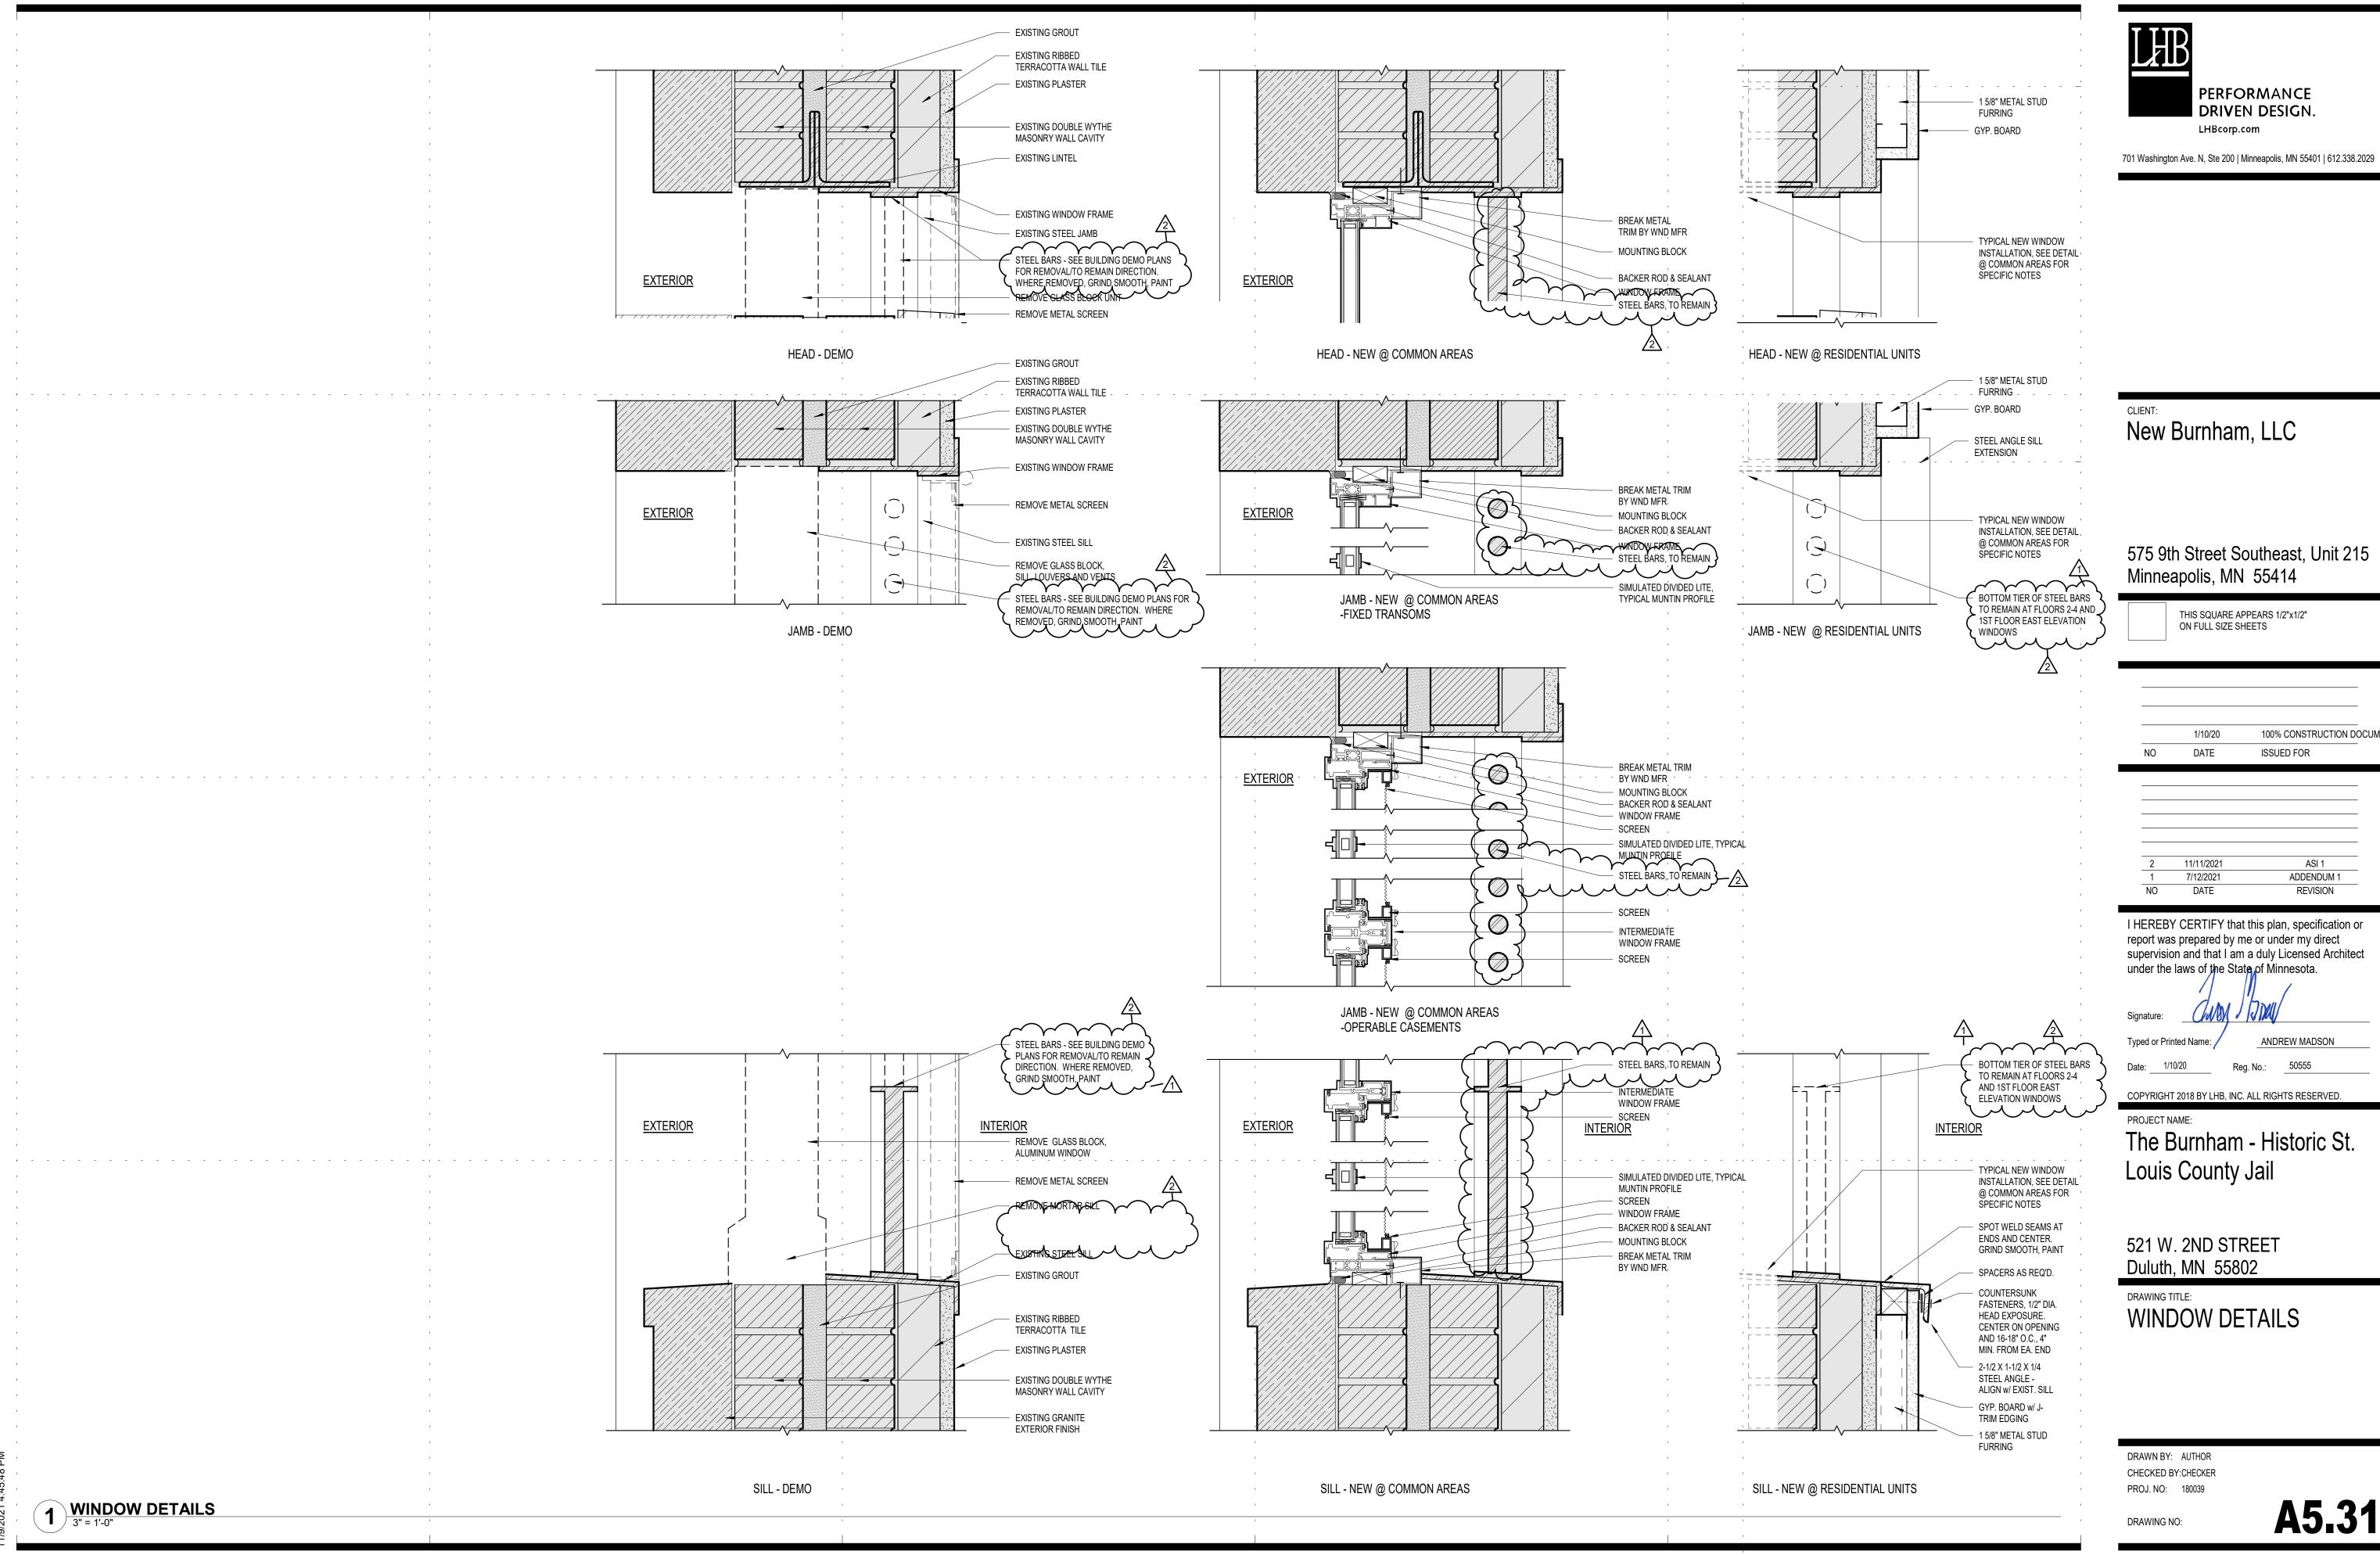
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DRAWING TITLE: INTERIOR DETAILS

DRAWN BY: Author CHECKED BY:Checker

STAIR B ROOF ACCESS

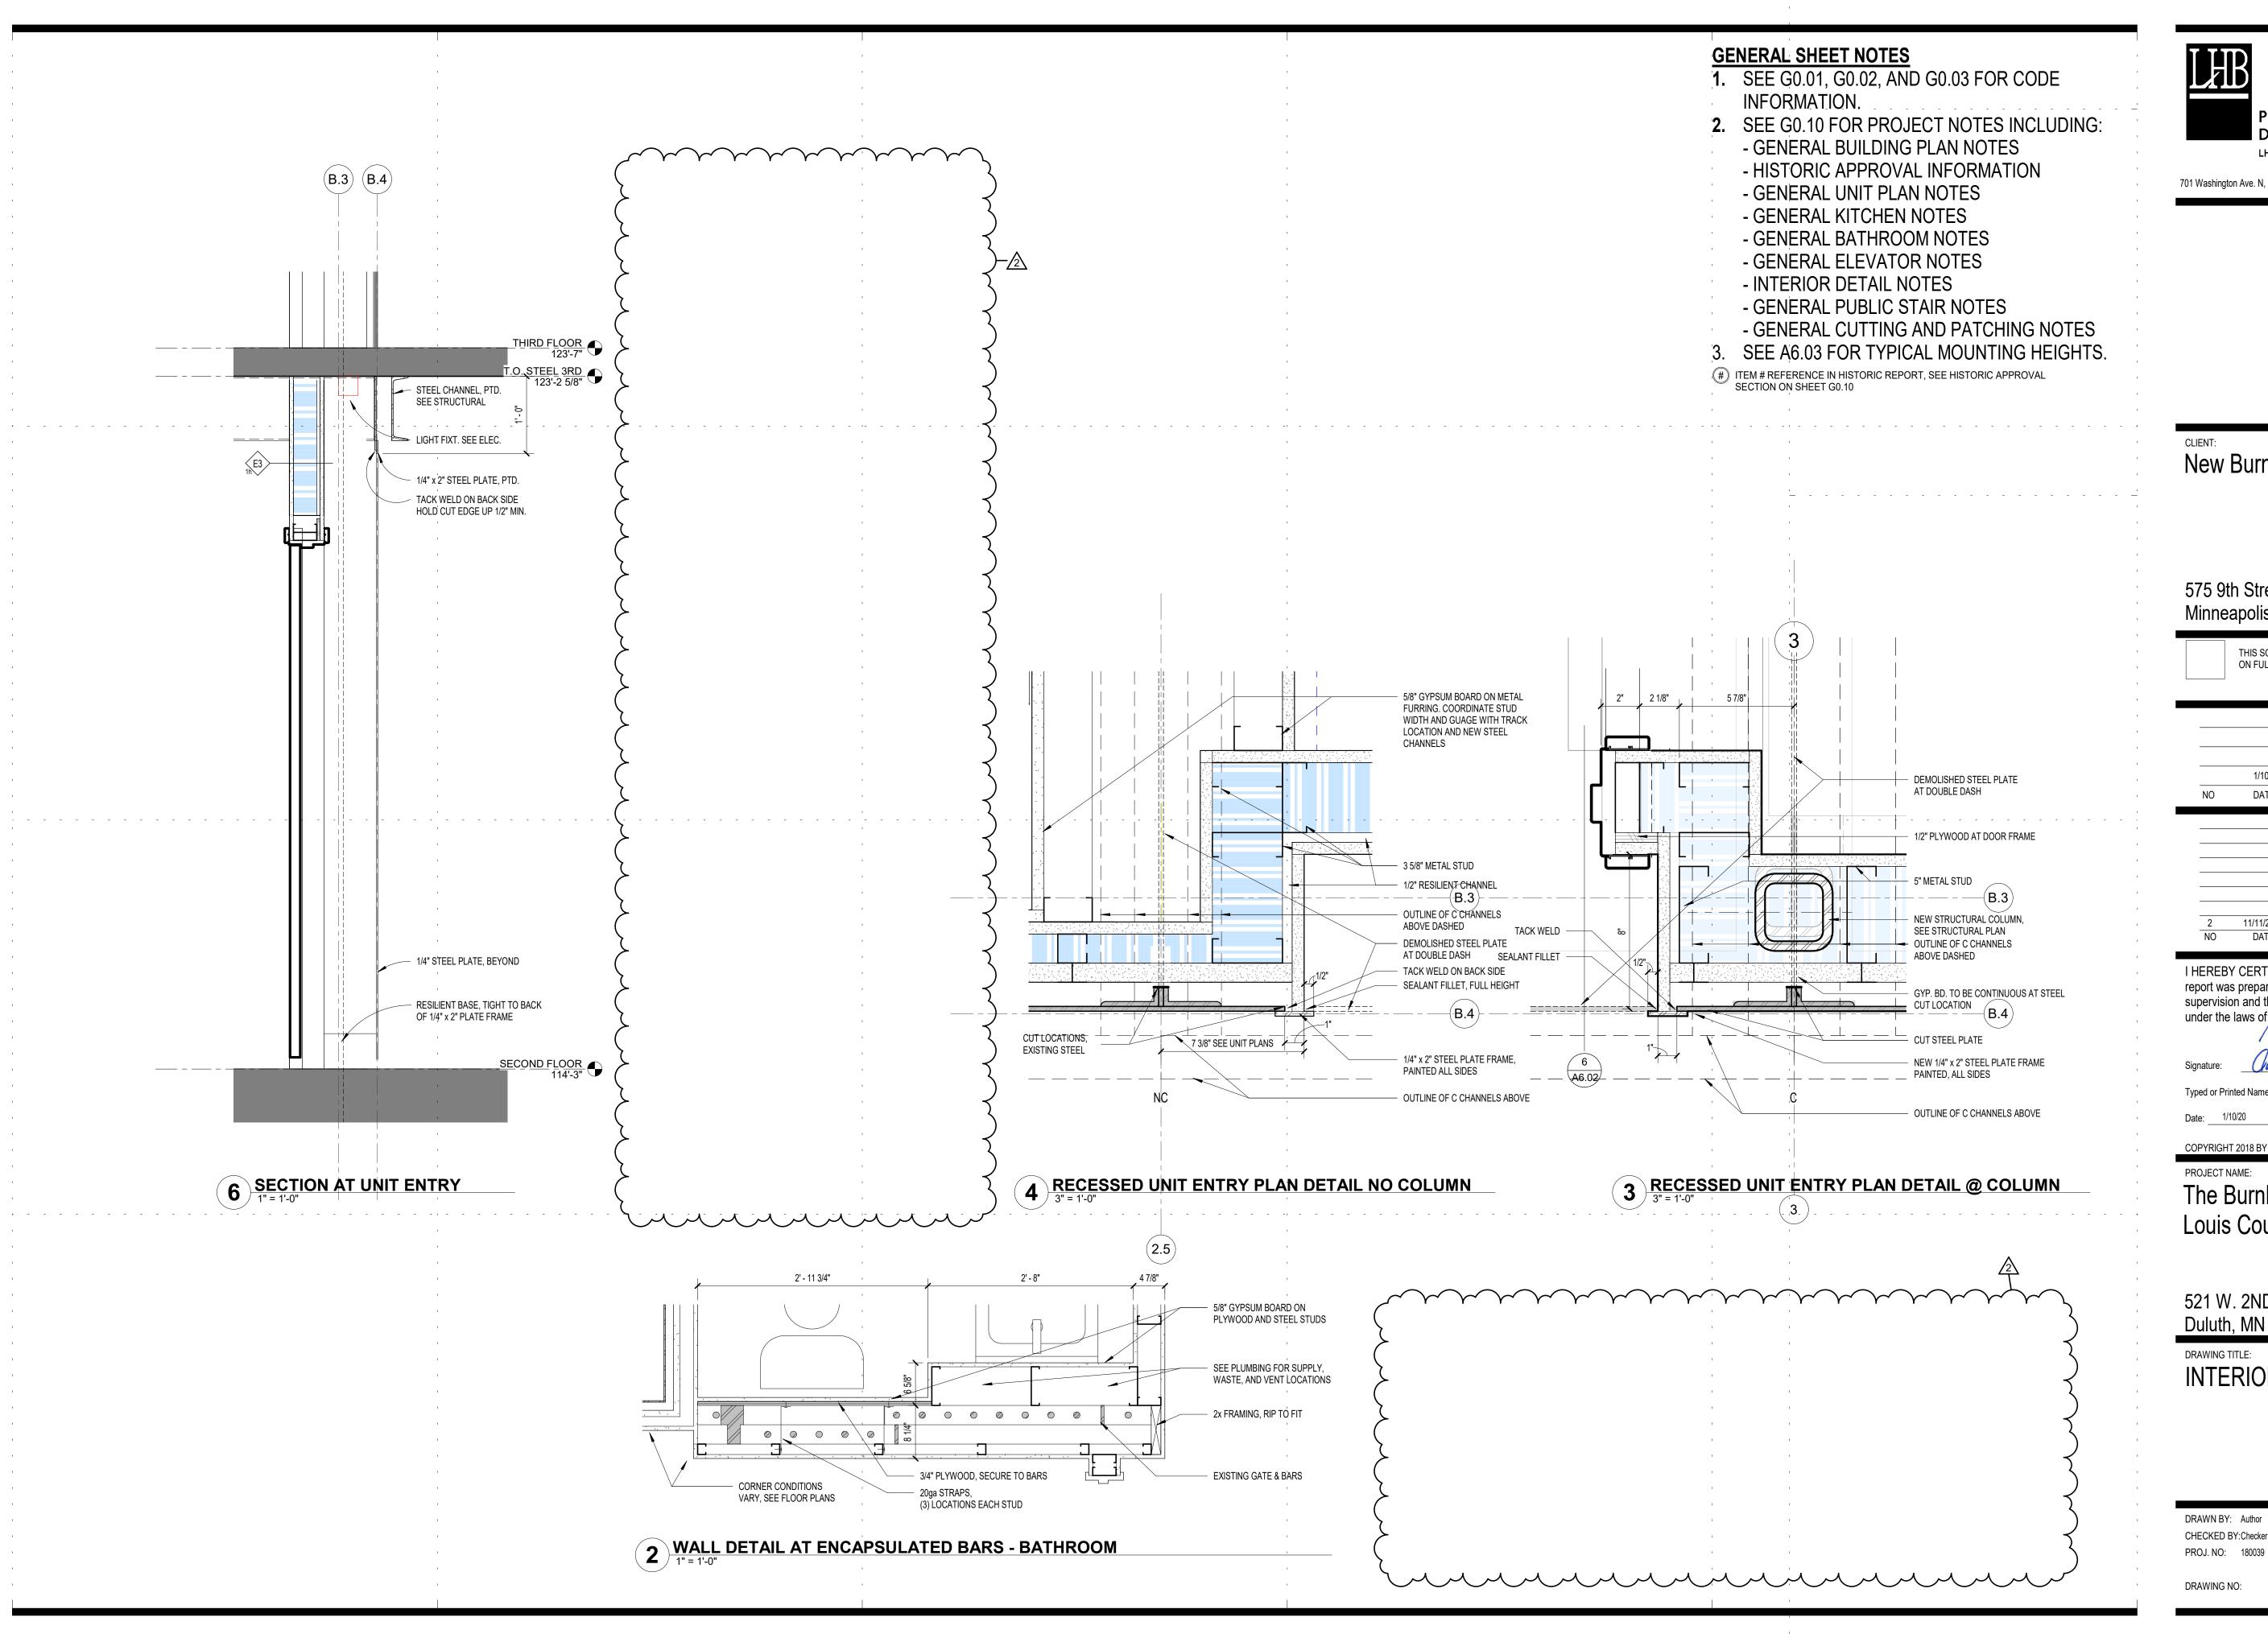B THROUGH 5 DOWN TO LEVEL 1 FOR EXIT DISCHARGE

STAIR A NO ROOF **ACCESS**

DOWN TO LEVEL 1

FOR EXIT DISCHARGE

B THROUGH 4 DOWN TO LEVEL 1 FOR EXIT DISCHARGE Li D.173 S....T. 3.3

STAIR B ROOF ACCESS

B THROUGH 5 DOWN TO LEVEL 1 FOR EXIT DISCHARGE

STAIR B

ROOF

STAIR A NO ROOF **ACCESS B THROUGH 4**

ACCESS B THROUGH 5 THIS LEVEL FOR EXIT DISCHARGE

THIS LEVEL FOR EXIT DISCHARGE

> **STAIR B** ROOF **ACCESS**

EXIT DISCHARGE 2. 0.273 page 3.23

LEVEL STAIR B

NOTE: STAIR B IS NOT AN 'EXIT STAIR', OMIT 'EXIT'

EXIT

ALIGN NUMBER RIGHT WITH TEXT LEVEL .060 NG ACRYLIC SUB SURFACE PAINTED COLOR TO BE SELECTED BY ARCHITECT TEXT 1" CG TRIUMVIRATE BOLD NUMBER 2" CG TRIUMVIRATE BOLD PROFILE COLOR TO BE SELECTED BY ARCHITECT TEXT POSITION AS SHOWN SYMBOL 4" CENTER / CENTER BRAILLE: 1/2" / UP 3/8" RASTERS STÀIR A MOUNTING: 4611 VHB CENTER BOTTOM TEXT ALIGN TEXT LEFT WITH BOTTOM TEXT

NOTE: SEE SPECIFICATION FOR ADDITIONAL INFORMATION ON SIGNS

FIRST SURFACE 220-10 WHITE VINYL

TEXT 1 1/2" CG TRIUMVIRATE BOLD PROFILE COLOR TO BE SELECTED BY ARCHITECT

MOUNTING:

BRAILLE: 1/2" / up 3/8"

MOUNTING:

.060 NG ACRYLIC

MOUNTING:

SUB SURFACE PRINTED WHITE VINYL FLOOD

.060 NG ACRYLIC SUB SURFACE PAINTED COLOR TO BE SELECTED BY ARCHITECT

CENTER / UP 1 1/4"

CENTER / UP 1/2"

MOUNTING: 4611 VHB

PICTOGRAM CENTER / UP 3 1/2"

PROFILE COLOR TO BE SELECTED BY ARCHITECT

SIGN TYPE ST1

2 SIGN TYPE ST2 3" = 1'-0"

In Case Of Fire

Elevators Are

Out Of Service

Use Exit

RESTROOM

3 SIGN TYPE ST3

PERFORMANCE

DRIVEN DESIGN.

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Sheet Reissued Addendum No 2 April 11, 2013

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DRAWING TITLE: SIGNAGE

DRAWN BY: Author CHECKED BY:Checker PROJ. NO: 180039

A7.10

in in serious between **SIGN TYPE ST6** STAIR B **ROOF ACCESS**

MECHANICAL

MANAGEMENT

FIRE ALARM CONTROL PANEL

OFFICE

STAIR A

NO ROOF

ACCESS

B THROUGH 4

DOWN TO LEVEL 1

FOR EXIT DISCHARGE

Li Darra Saurt, Sas

FIRE PROTECTION EQUIPMENT

B THROUGH 5 DOWN TO LEVEL 1

.060 NG ACRYLIC 1/4" ROUNDED CORNERS

IF COPY OF LONGER THAN 9" CONDENSE TO FIT

SUB SURFACE PAINTED

IF TWO LINES ILS 50%

BRAILLE: 1/2" / up 3/8"

MOUNTING:

4611 VHB

FOR EXIT DISCHARGE

> STAIR B ROOF **ACCESS**

B THROUGH 5 DOWN TO LEVEL 1 FOR EXIT DISCHARGE

STAIR A

B THROUGH 4 UP TO LEVEL 1 FOR EXIT DISCHARGE 2. 2.273 hante 3.3

B THROUGH 5 UP TO LEVEL 1 FOR

SUB SURFACE VINYL SIGNAGE 3/8" RADIUS CORNERS STANDARD LAYOUT .080" NON-GLARE AF ACRYLIC SUB SURFACE PAINTED COLOR TO BE SELECTED BY ARCHITECT 1 1/2" & 5" TEXT - SUB-VINYL COPY

HELVETICA BOLD TYPESTYLE 1" FLOOR DISCHARGE INFORMATION HELVETICA MEDIUM TYPESTYLE COPY COLOR TO BE SELECTED BY ARCHITECT

1/2" / up 3/8"

L. D.L. D.L. D.L. D.L.

NO ROOF ACCESS

6 SIGN TYPE ST8

L. Darra Americana

5 SIGN TYPE ST5