



Purchasing Division
Finance Department
Room 120
411 West First Street
Duluth, Minnesota 55802

218-730-5340
purchasing@duluthmn.gov

Addendum 2
Solicitation 20-99380
Keene Creek Park Improvements

This addendum serves to notify all bidders of the following changes to the solicitation documents:

1. Contractors shall substitute three White Pine trees for three Alleghany Serviceberry trees.
2. Updates have been made to the existing utility information.
3. The bid form in the BidExpress solicitation has been updated to reflect changes per this addendum.
4. A revised planset is attached with changes per this addendum.

Please acknowledge receipt of this Addendum by checking the acknowledgment box within the www.bidexpress.com solicitation.

Posted: **July 2, 2020**

PLOT DATE: Jul 02, 2020 - 1:24pm
FILE NAME: K:\a-Duluth_City\16893000\04_Production\01_Sheets\16893000 - Keene Creek - Title Sheet.dwg

LEGEND

EXISTING

	MAJOR CONTOUR (5')
	MINOR CONTOUR (1')
	EXISTING TRAIL
	CENTERLINE
	EXISTING STORM SEWER
	CREEK

PROPOSED

	PROPOSED CONTOUR - MAJOR (5')
	PROPOSED CONTOUR - MINOR (1')
	FILTER LOG TYPE COMPOST
	STORM SEWER
	RIP RAP/ ROCK ARMORING
	ROCK STABILIZED ENTRANCE
	SEEDING

EXISTING UTILITY LOCATIONS

THE CONTRACTOR SHALL VERIFY ALL EXISTING UNDERGROUND UTILITY LOCATIONS AND ELEVATIONS PRIOR TO CONSTRUCTION. ALL INPLACE UTILITIES MAY NOT BE SHOWN ON THIS PLAN & THOSE THAT ARE SHOWN, MAY NOT BE SHOWN IN THE EXACT LOCATIONS.

THE SUBSURFACE UTILITY INFORMATION IN THIS PLAN IS UTILITY QUALITY LEVEL "D". THIS QUALITY LEVEL WAS DETERMINED ACCORDING TO THE GUIDELINES OF C/ASCE 38-02, ENTITLED "STANDARD GUIDELINES FOR THE COLLECTION AND DEPICTION OF EXISTING SUBSURFACE UTILITY DATA.



GOPHER STATE ONE CALL

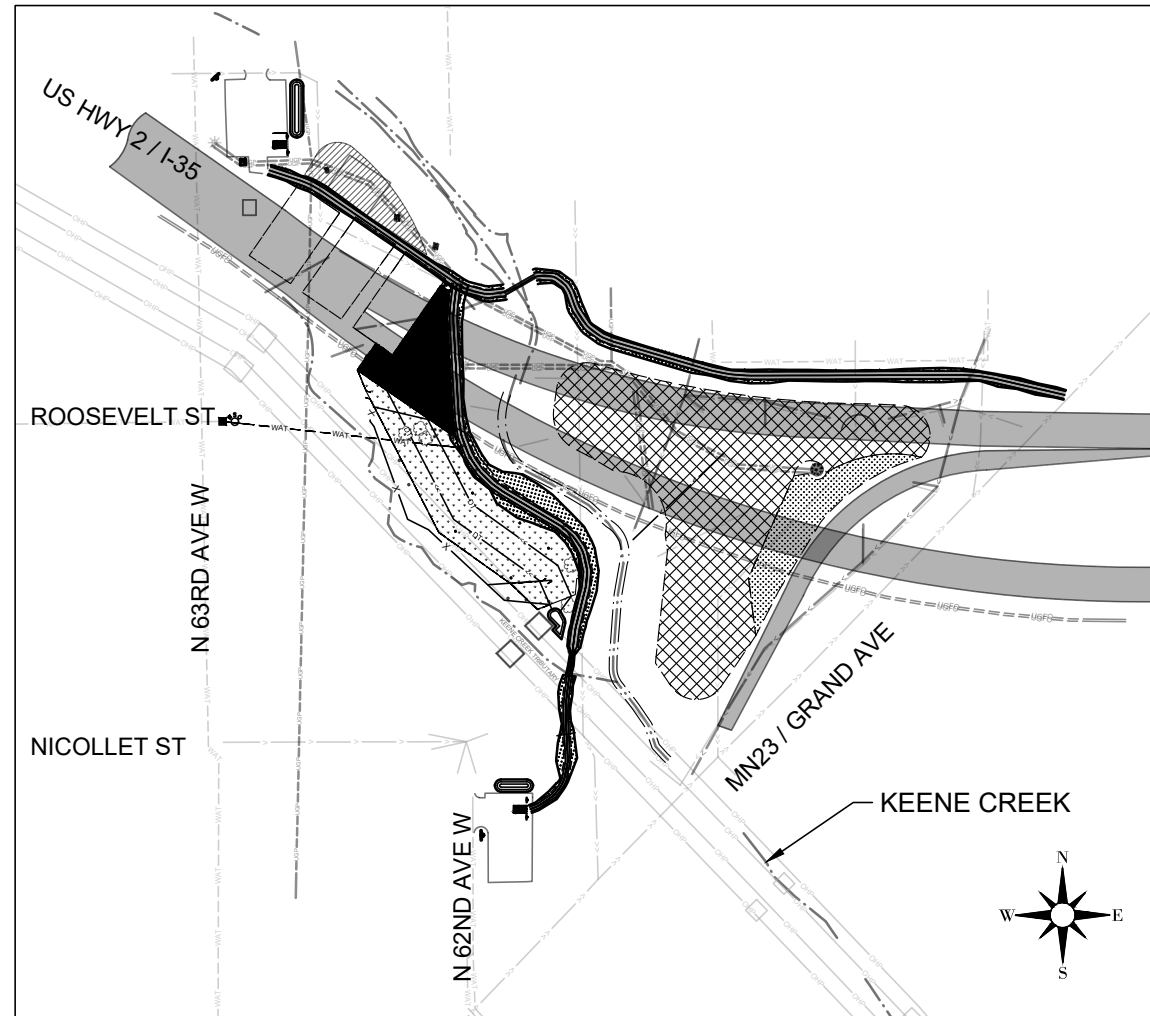
651.454.0002
800.252.1166
811
1.866.640.3637 (EMERGENCY LOCATES ONLY)
<http://www.gopherstateonecall.org/submit>

CONSTRUCTION PLANS FOR: KEENE CREEK PARK UPDATES

CITY OF DULUTH

CONSTRUCTION PLANS FOR DOG PARK UPDATES, TRAIL PAVING, TOILET SCREEN AND DRINKING FOUNTAIN INSTALLATION AND CLEANING UP DEBRIS

LOCATION MAP



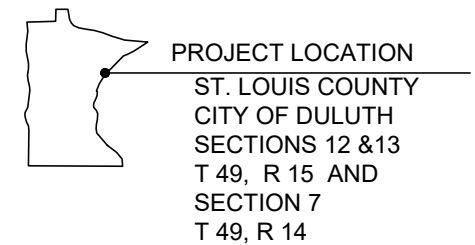
SPECIFICATION REFERENCES

1. THE 2019 CITY OF DULUTH, MINNESOTA CONSTRUCTION STANDARDS SHALL APPLY.
2. THE MINNESOTA DEPARTMENT OF NATURAL RESOURCES "TRAIL PLANNING, DESIGN, AND DEVELOPMENT GUIDELINES" SHALL APPLY.
3. THE 2018 MNDOT STANDARD SPECIFICATIONS FOR CONSTRUCTION SHALL APPLY.

SHEET INDEX

Sheet Number	Sheet Title
001	TITLE SHEET
002	STATEMENT OF ESTIMATED QUANTIITES
003	PATHWAY TYPICAL SECTIONS
004-013	DETAILS
014-015	SWPPP
016	SWPPP 1 OF 2
017	EXISTING CONDITIONS
018-019	PLAN & PROFILE - CROSS CITY TRAIL
020-021	PLAN & PROFILE - DOG PARK PATH
022	STATION 0+00 - 6+00
023	DOG PARK LAYOUT
024	EROSION CONTROL

THIS PLAN SET CONTAINS 24 SHEETS



CONTRACTOR TO NOTIFY 911 PERSONNEL
PRIOR TO ALL ROAD CLOSURES.

I HEREBY CERTIFY THAT THIS PLAN WAS PREPARED BY ME OR UNDER MY DIRECT SUPERVISION AND THAT I AM A DULY LICENSED ENGINEER UNDER THE LAWS OF THE STATE OF MINNESOTA.

WILL D. DEROCHE
DATE 06/18/20 LIC. NO. 54757

ALL CONTRACTORS AND SUBCONTRACTORS
SHALL VERIFY ALL DIMENSIONS BY
MEASUREMENT AT THE BUILDING AND/OR SITE

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TITLE SHEET

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CHECKED	WDD	PRINTED NAME: WILL D. DEROCHE LIC. NO.: 54757



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PROJ. NO.
16893.000
DRAWING NO.
001

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STATEMENT OF ESTIMATED QUANTITIES							
ITEM NO	NOTE NO	SPEC NO	DESCRIPTION	UNIT	BASE BID	CROSS CITY TRAIL - ALT #1	DOG PARK EXPANSION - ALT # 2
1		2012.602	TRAFFIC CONTROL SPECIAL	EACH	1		
2		2021.501	MOBILIZATION	LUMP SUM	0.75	0.25	
3		2104.503	REMOVE PIPE CULVERT	LIN FT	60		
4		2104.503	SAWING BITUMINOUS PAVEMENT (FULL DEPTH)	LIN FT	40		
5	1,5	2104.503	SALVAGE FENCE - 5' CHAINLINK	LIN FT	841		
z	11	2104.503	REMOVE WOOD RETAINING WALL	LIN FT	150		
7	2	2104.504	REMOVE BITUMINOUS PAVEMENT	SQ YD	1862		
8		2104.601	REMOVE MISCELLANEOUS DEBRIS	LUMP SUM	1		
9	3	2104.602	RELOCATE BENCH	EACH	7		
10	4	2105.507	COMMON EXCAVATION	CU YD	468	658	
11		2105.507	COMMON BORROW (CV)	CU YD	179	126	
12		2211.507	AGGREGATE BASE (CV) CLASS 5	CU YD	143	296	
13		2360.509	TYPE SP 9.5 WEAR CRS MIX (3,C)	TON	181	228	
14		2501.502	18" CS PIPE ARPON	EACH	4		
15		2501.503	18" CP PIPE CULVERT (SMOOTH)	LIN FT	24		
16		2502.503	4" PERF TP PIPE DRAIN	LIN FT	920		150
17	7	2504.602	WATER SERVICE TAP & HOOKUP	EACH	1		
18		2504.603	WATER SERVICE (3/4" - DIRECTIONAL DRILLED)	LIN FT	310		25
19		2504.607	SAND COVER (LV)	CU YD	89		139
20		2511.507	RANDOM RIPRAP CLASS II	CU YD			
21		2540.602	DRINKING FOUNTAIN	EACH	1		
22	15	2557.502	PEDESTRIAN GATE	EACH			1
23		2557.502	VEHICULAR GATE-DOUBLE - 12' WIDTH	EACH	2		1
24	8	2557.603	ENCLOSURE SCREEN - PORT A POTTY	LUMP SUM			
25	9	2557.603	INSTALL CHAIN LINK FENCE - (SALVAGED 5')	LIN FT	858		
26	10	2557.603	CHAIN LINK ENCLOSURE 5'	LIN FT	14		
27	10	2557.603	CHAIN LINK ENCLOSURE 6' (DOG PARK EXPANSION)	LIN FT	155		79
28		2564.618	METAL INFORMATIONAL SIGN TYPE C	EACH	4		4
29		2571.524	CONIFEROUS TREE 6" HT B&B	TREE	3		
30		2571.524	DECIDUOUS TREE 6' HT BR	TREE	7		
31	6	2571.524	TRANSPLANT TREE (SPADE SIZE 60")	TREE	7		
32		2573.503	SEDIMENT CONTROL LOG TYPE COMPOST	LIN FT	1350	200	
33		2574.507	FILTER TOPSOIL BORROW (LV)	CU YD	45		
34		2575.505	SEEDING	ACRE	0.8	0.1	
35	14	2575.508	SEED MIXTURE 25-151	LB	100	12.0	
36	14	2575.508	SEED WETLAND MIX 33-361	LB	1.0		
37	12	2582.503	4" SOLID LINE PAINT - LATEX	LIN FT	100.0		
38	12	2582.518	PAVT MSSG PAINT - LATEX	SQ FT	446.0		
39		2757.604	ROLLED EROSION PREVENTION CATEGORY 25	SQ YD	1489	1356	

CONSTRUCTION NOTES:

1. SALVAGE FENCING PAY ITEM TO INCLUDE ALL LABOR, MATERIALS AND EQUIPMENT NECESSARY TO SALVAGE EXISTING CHAINLINK FENCING AND POSTS FOR RE-USE ONSITE. CONTRACTOR SHALL BE RESPONSIBLE FOR PROTECTING SALVAGED MATERIALS AHEAD OF RE-INSTALLATION.
2. BITUMINOUS REMOVALS ADJACENT TO REMAINING BITUMINOUS SHALL BE SAW CUT JUST PRIOR TO PATCHING TO MAINTAIN A CLEAN PATCH JOINT.
3. RELOCATE BENCH PAY ITEM SHALL INCLUDE ALL MATERIALS, LABOR AND EQUIPMENT NECESSARY TO SALVAGE AND REINSTALL BENCH ASSEMBLY WITHIN THE NEW FENCED BOUNDARY. THE BENCH ASSEMBLY INCLUDES THE BENCH, FRAME, FOUNDATION AND NEW CONCRETE PAD. OLD CONCRETE PAD SHALL BE REMOVED AND PROPERLY DISPOSED OF.
4. COMMON EXCAVATION SHALL INCLUDE ALL MATERIALS, LABOR AND EQUIPMENT NECESSARY TO CUT AND COMPACT THE SUBGRADE IN GRADED AREAS. THIS INCLUDES SITE GRADING AND TRAIL SUBGRADE PREPARATION. EXCAVATED MATERIAL MAY BE STOCKPILED ONSITE IN DESIGNATED LOCATIONS, SEEDED AND BLANKETED. MATERIAL WILL BE USED BY OTHERS FOR PREPARATION OF THE BIKE SKILLS AREA.
5. TO THE MAXIMUM EXTENT PRACTICAL, CONTRACTOR TO STAGE WORK TO MAINTAIN A FENCED ENCLOSURE FOR DOG PARK USERS.
6. CONTRACTOR SHALL RELOCATE DESIGNATED TREES AHEAD OF FENCE SALVAGING OPERATION. RELOCATED TREES TO BE PROTECTED AND REINSTALLED WITHIN THE NEW FENCED BOUNDARY.
7. WATER SERVICE TAP AND HOOKUP PAY ITEM SHALL INCLUDE ALL MATERIALS, LABOR AND EQUIPMENT TO PROVIDE A NEW WATER SERVICE, CURB STOP AND HOOKUP FOR A SINGLE DRINKING FOUNTAIN IN THE PARK. THE PAY ITEM SHALL ALL LABOR, MATERIALS AND EQUIPMENT NECESSARY TO BACKFILL AND REBUILD THE ROADWAY SECTION SHALL BE CONSIDERED INCIDENTAL TO THE WATER SERVICE TAP AND HOOKUP PAY ITEM.
8. ENCLOSURE SCREEN - PORT A POTTY PAY ITEM SHALL INCLUDE ALL LABOR, MATERIALS AND EQUIPMENT NECESSARY TO FURNISH AND INSTALL AN ENCLOSURE PER SHEETS 008 - 011 (OR APPROVED EQUAL). CONTRACTOR TO PROVIDE SHOP DRAWINGS TO ENGINEER FOR APPROVAL PRIOR TO ORDERING MATERIALS.
9. INSTALL CHAIN LINK FENCE PAY ITEM SHALL INCLUDE ALL LABOR, MATERIALS AND EQUIPMENT NECESSARY TO INSTALL THE SALVAGED CHAINLINK FENCE. REPLACEMENT POSTS NECESSARY FOR REPLACEMENT OF CONCRETED OR DAMAGED POSTS SHALL BE CONSIDERED INCIDENTAL TO THE PAY ITEM.
10. CHAINLINK FENCE PAY ITEM SHALL INCLUDE ALL LABOR, MATERIALS AND EQUIPMENT NECESSARY TO FURNISH AND INSTALL NEW CHAINLINK FENCE. NEW FENCING SHALL MATCH THE COLOR, HEIGHT AND GAUGE OF EXISTING FENCE.
11. REMOVE WOOD RETAINING WALL PAY ITEM SHALL INCLUDE ALL LABOR, MATERIALS AND EQUIPMENT NECESSARY TO EXCAVATE WOODEN STRUCTURE, PROPERLY DISPOSE OF MATERIALS AND REGRADE SLOPE TO BE 1:5 OR LESS. ALL DISTURBED AREAS TO BE SEEDED AND BLANKETED. SEED AND BLANKET MATERIAL IS PAID FOR AS A SEPARATE BID ITEM.
12. PAINT TO BE MNDOT APPROVED WHITE LATEX. SEE MNDOT LIST OF APPROVED PRODUCTS FOR PAVEMENT MARKING MATERIALS.
13. TRAFFIC CONTROL PAY ITEM SHALL INCLUDE ALL LABOR, MATERIALS AND EQUIPMENT NECESSARY TO BARRICADE WORK SITES AND ACCESS POINTS TO WARN AND DISCOURAGE PUBLIC USAGE DURING PERIODS OF ACTIVE WORK.
14. SEED MIX 25-151 USES 120 LBS/ACRE AND SEED WETLAND MIX 33-361 USED 35 LBS/ACRE.
15. INSTALL 36" WIDE PEDESTRIAN GATE IN EXISTING SPORTS COURT FENCE LINE.

ALL CONTRACTORS AND SUBCONTRACTORS SHALL VERIFY ALL DIMENSIONS BY MEASUREMENT AT THE BUILDING AND/OR SITE

01" = 1'

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002

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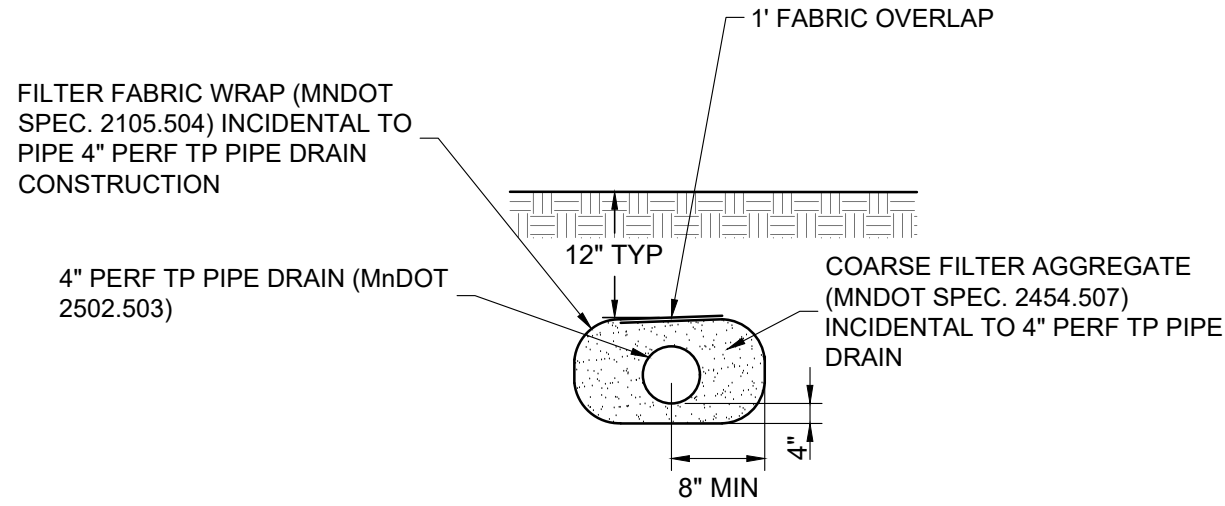
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STATEMENT OF ESTIMATED QUANTIITES

PLOT DATE: Jul 02, 2020 - 1:25pm
FILE NAME: K:\a-MDuluth_City\16893000\04_Production\01_Sheets\16893000 - Keene Creek - Details.dwg



1 4" PERF TP PIPE DRAIN
003 NOT TO SCALE

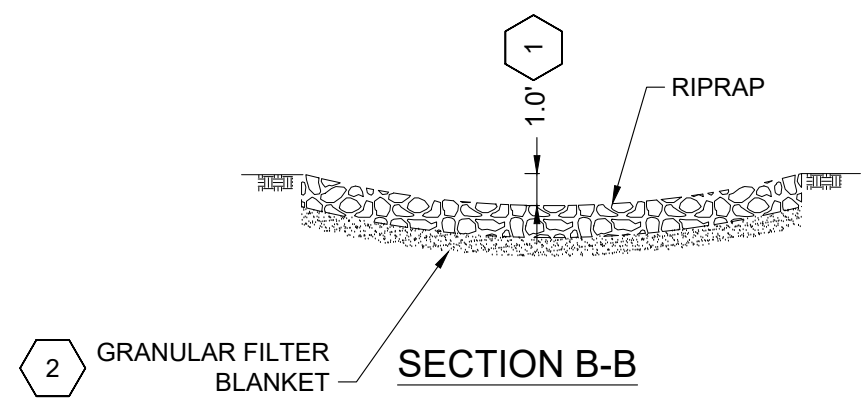
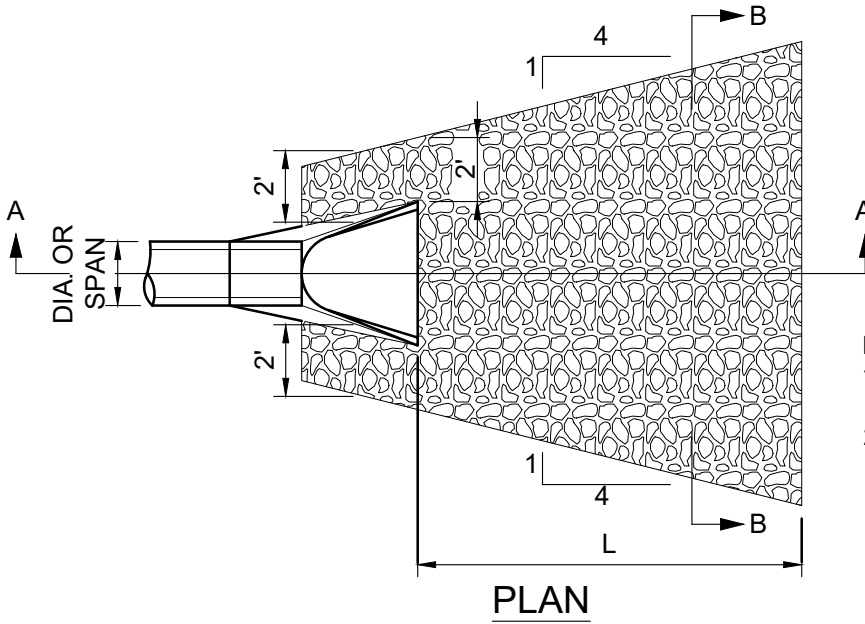
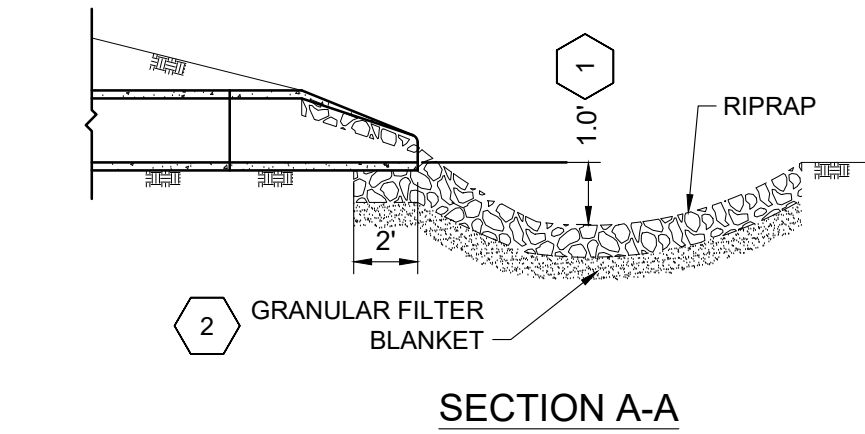


TABLE OF QUANTITIES
RIPRAP AT RCP OUTLETS

DIA. OF ROUND PIPE (IN.)	L (FT.)	CLASS II $d_{50} = 6"$	
		12" DEPTH RIPRAP (CU. YDS.)	6" DEPTH GRANULAR FILTER (CU. YDS.)
18	10	3.9	2.0



- NOTES:
- PIPE SIZES LARGER THAN THOSE SHOWN REQUIRE A SPECIAL DESIGN
 - REQUIREMENTS FOR RIPRAP SIZE AND THICKNESS AND GRANULAR FILTER BLANKET WILL BE DESIGNED WITH THE PLANS



KEY NOTES:

- FOR PIPES GREATER THAN OR EQUAL TO 30", USE 1.5'
- THE CONTRACTOR, AT HIS OPTION, MAY SUBSTITUTE A GEOTEXTILE FABRIC, SPEC. 3733, FOR THE GRANULAR FILTER BLANKET UNLESS OTHERWISE SPECIFIED IN THE PLANS. THE FABRIC SHOULD COVER THE AREA OF THE RIPRAP AND EXTEND UNDER THE APRON 3FT.

3 RIPRAP AT PIPE CULVERT OUTLETS
003 NOT TO SCALE

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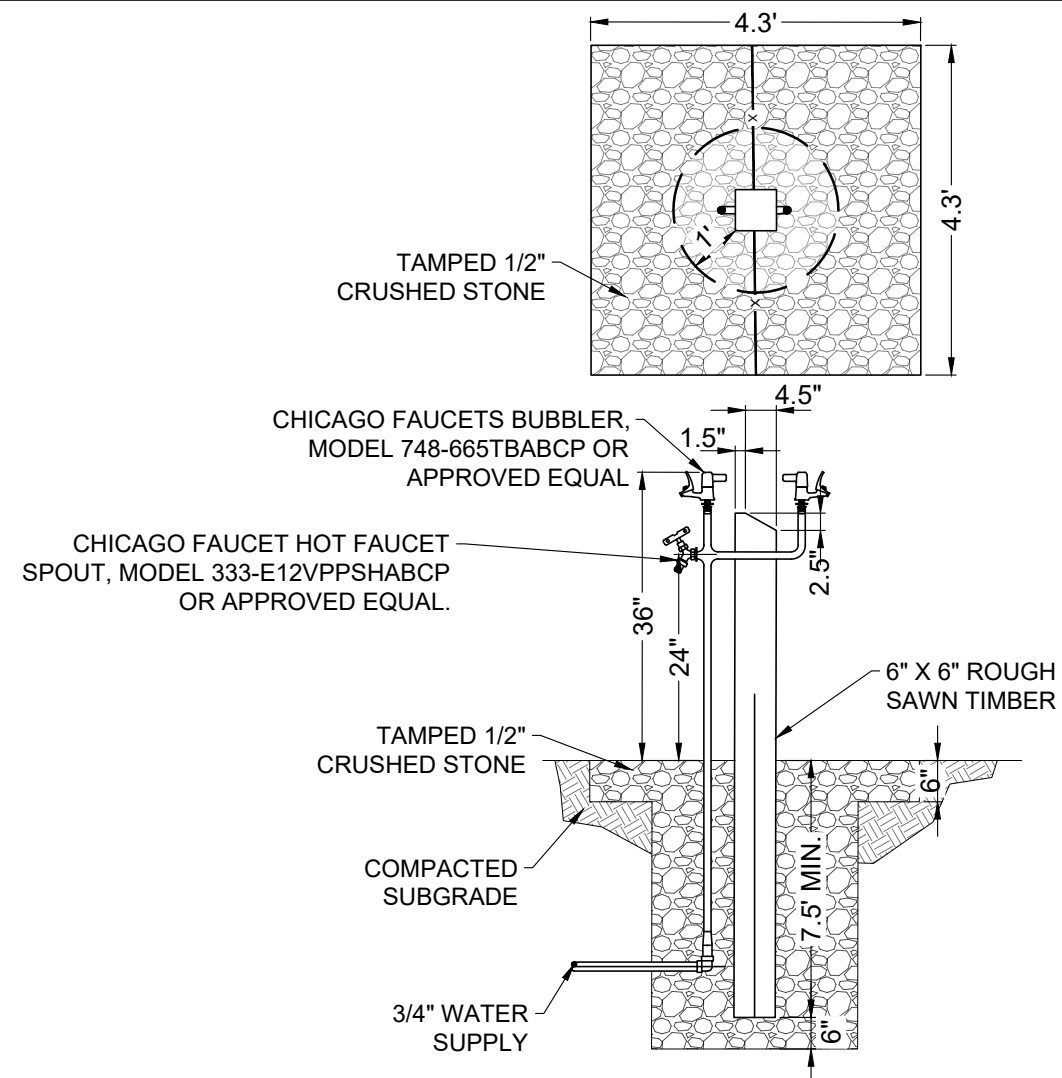
SIGNATURE: *Will D. Derocher* DATE: 06/18/20
PRINTED NAME: WILL D. DEROCHE UC. NO.: 54757



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TYPICAL SECTION FOR MAINTENANCE PATH

PROJ. NO.	16893.000
DRAWING NO.	003



CONSTRUCTION NOTES:

1. WATER FLOW. THE SPOUT SHALL PROVIDE A FLOW OF WATER 4 INCHES (100 MM) HIGH MINIMUM AND SHALL BE LOCATED 5 INCHES (125 MM) MAXIMUM FROM THE FRONT OF THE UNIT. THE ANGLE OF THE WATER STREAM SHALL BE MEASURED HORIZONTALLY RELATIVE TO THE FRONT FACE OF THE UNIT. WHERE SPOUTS ARE LOCATED LESS THAN 3 INCHES (75 MM) OF THE FRONT OF THE UNIT, THE ANGLE OF THE WATER STREAM SHALL BE 30 DEGREES MAXIMUM. WHERE SPOUTS ARE LOCATED BETWEEN 3 INCHES (75 MM) AND 5 INCHES (125 MM) MAXIMUM FROM THE FRONT OF THE UNIT, THE ANGLE OF THE WATER STREAM SHALL BE 15 DEGREES MAXIMUM
2. BUBBLERS, FAUCET, AGGREGATE AND SUPPORT SHALL BE CONSIDERED INCIDENTAL TO THE DRINKING FOUNTAIN PAY ITEM.
3. BUBBLERS AND FAUCET SHALL AUTOMATICALLY SHUT OFF
4. DRINKING FOUNTAIN TO BE INSTALLED ON THE DOG PARK FENCE LINE.
5. SINGLE BUBBLER TO BE INSTALLED FACING THE PATHWAY.
6. BUBBLER AND FAUCET TO BE INSTALLED FACING INWARD TO THE DOG PARK.

004 NO SCALE

0 1

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WATER SERVICE DETAILS

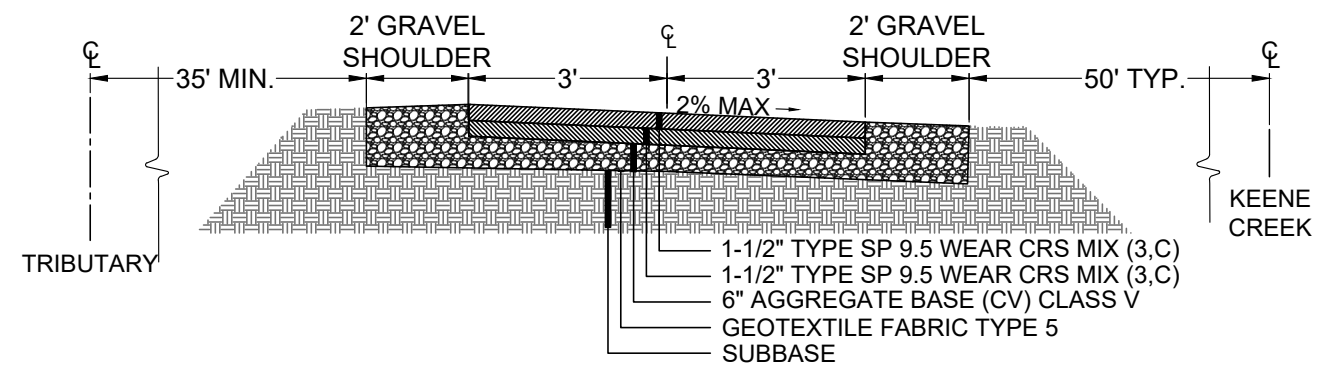
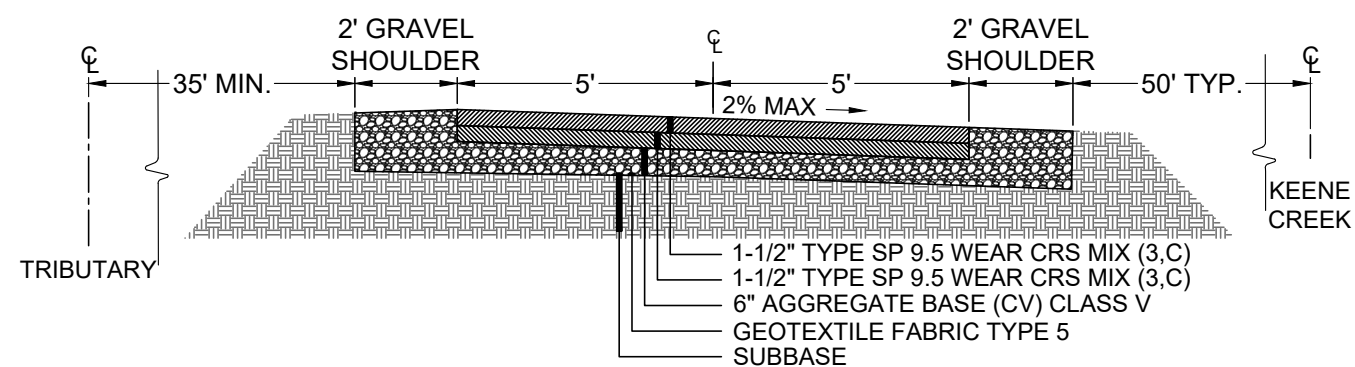
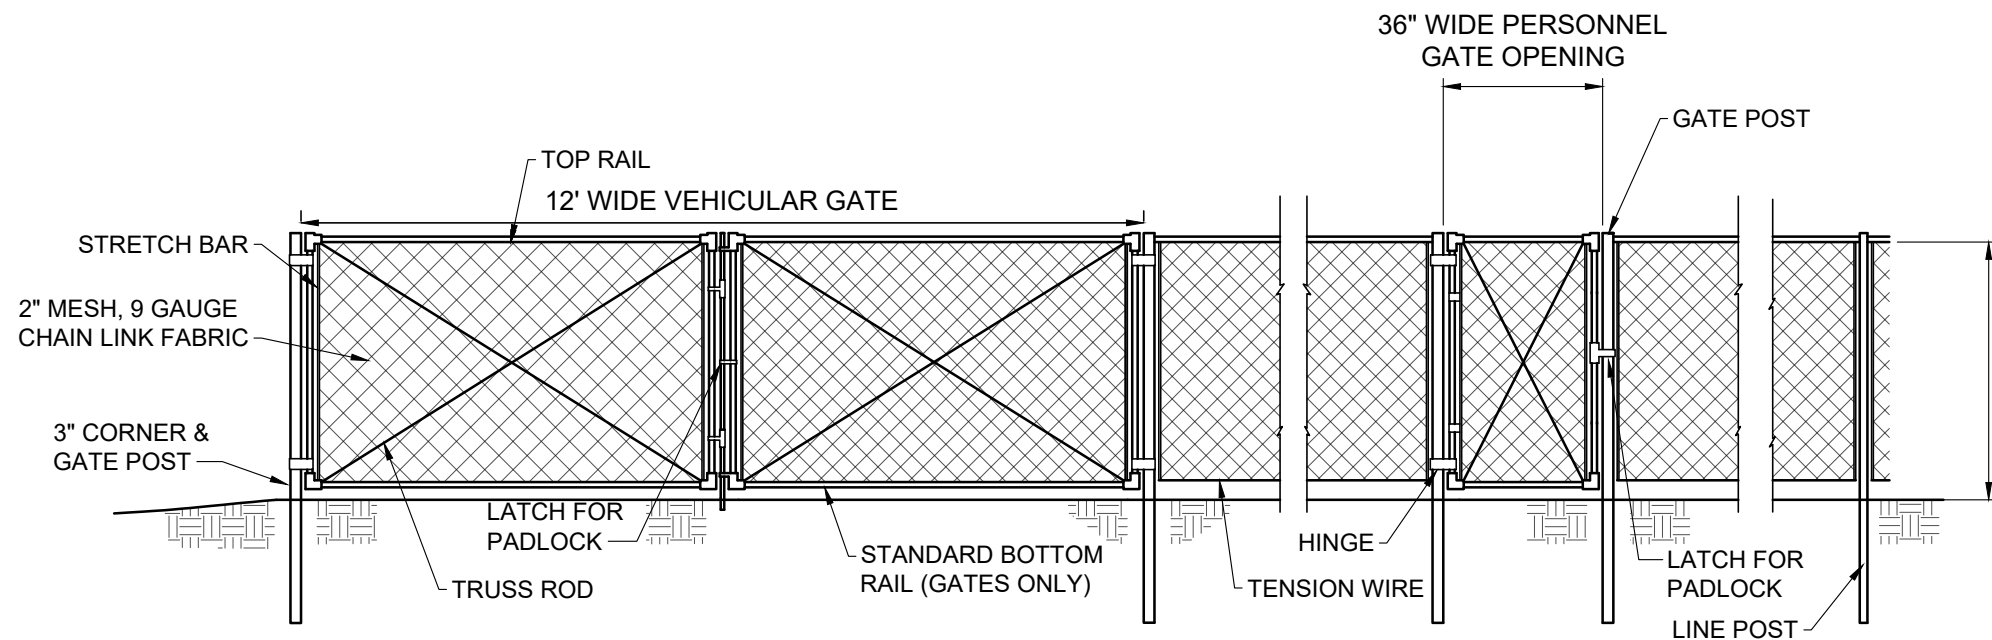
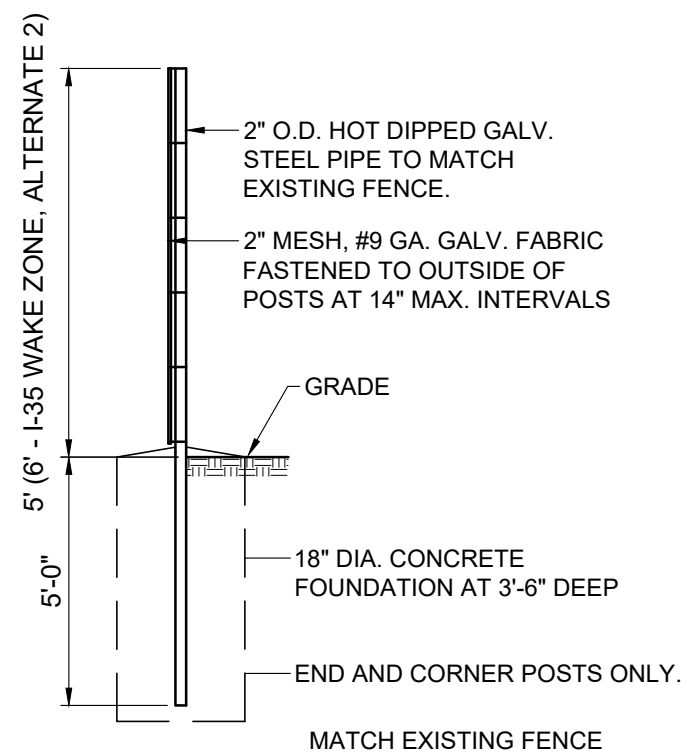
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####	####	####	####	CHECKED	WDD	PRINTED NAME: #### LIC. NO.: ####	
NO.	DATE	BY	DESCRIPTION OF REVISIONS				



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TRAIL TYPICAL SECTIONS AND CHAIN LINK FENCE DETAILS

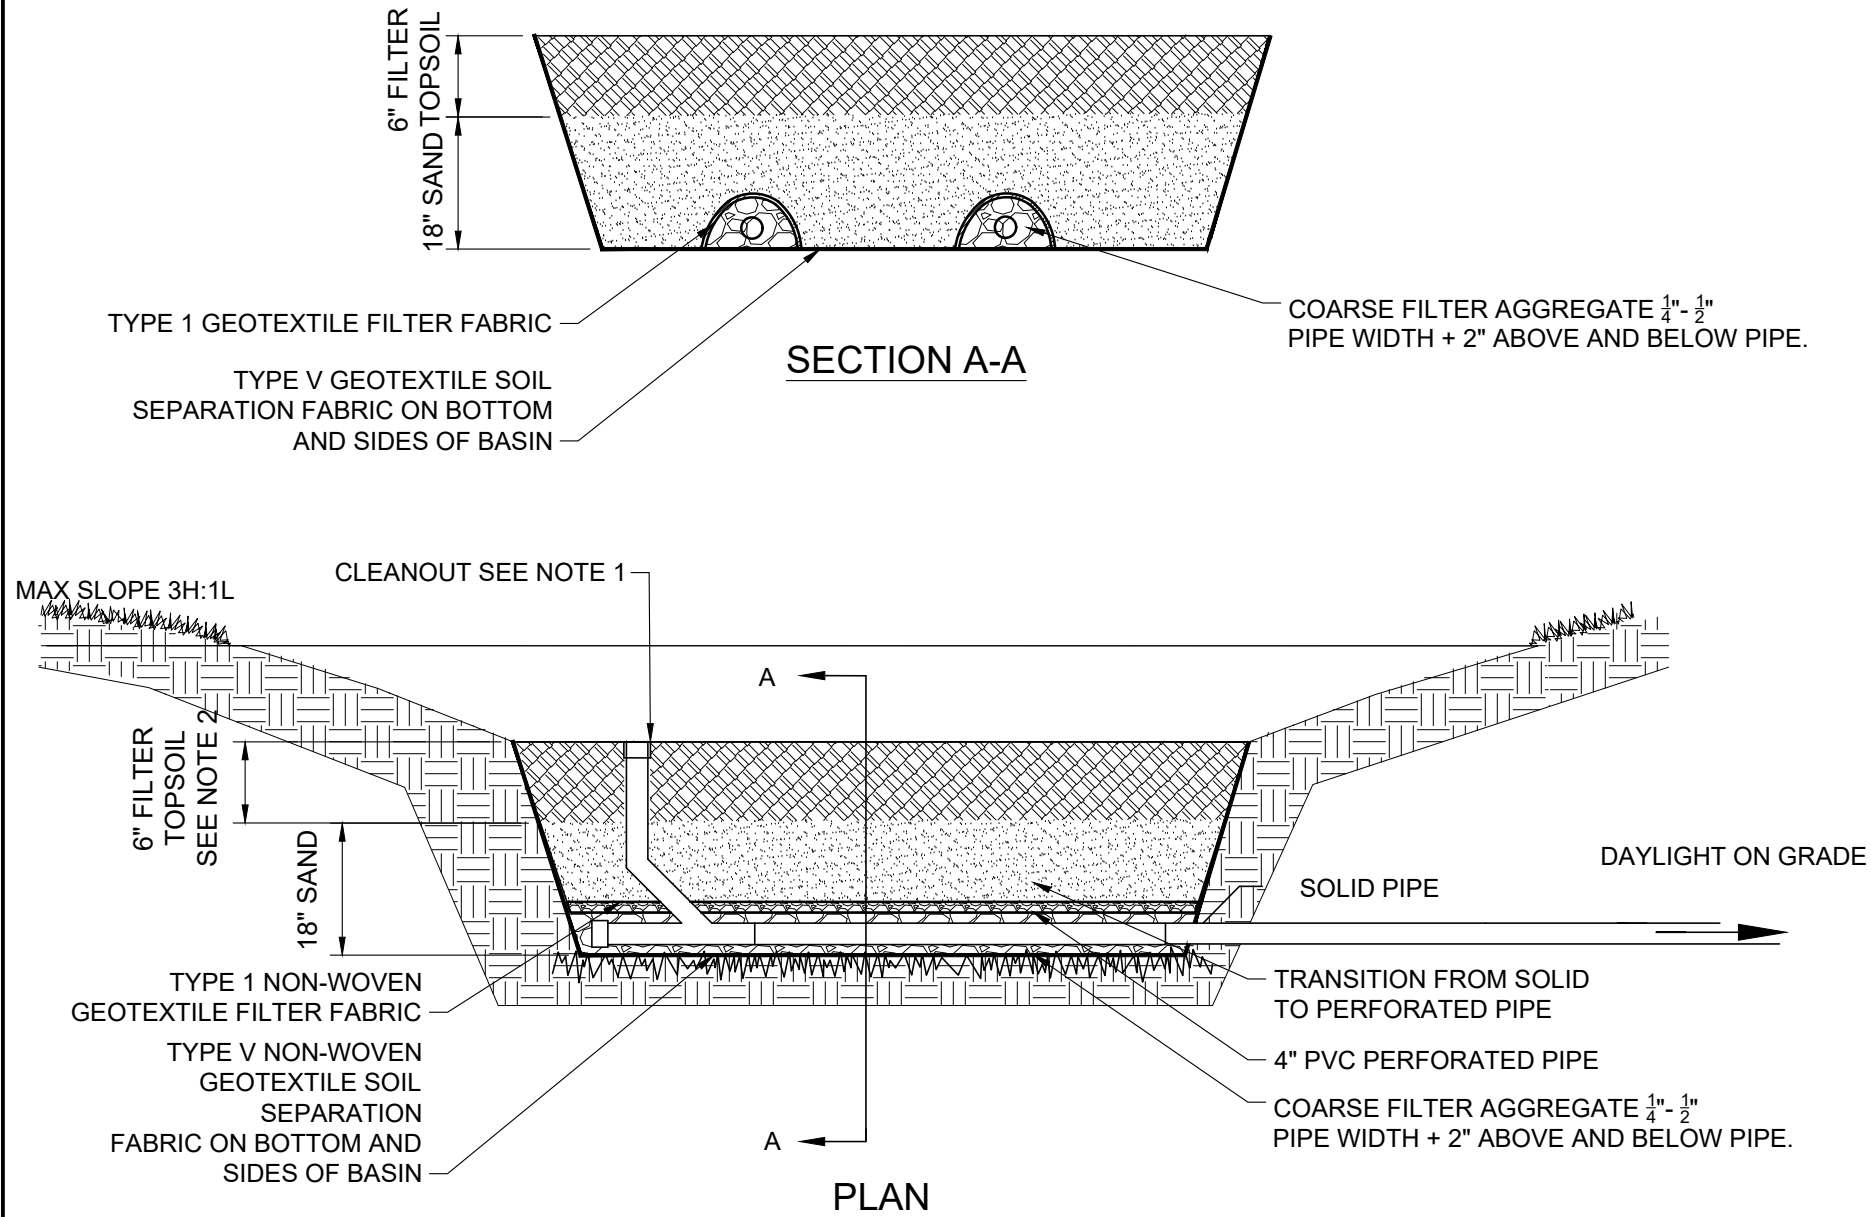
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1 STORMWATER BASIN DETAIL
006 NOT TO SCALE

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STORMWATER BASIN DETAIL		PROJ. NO. ###	DRAWING NO. 006

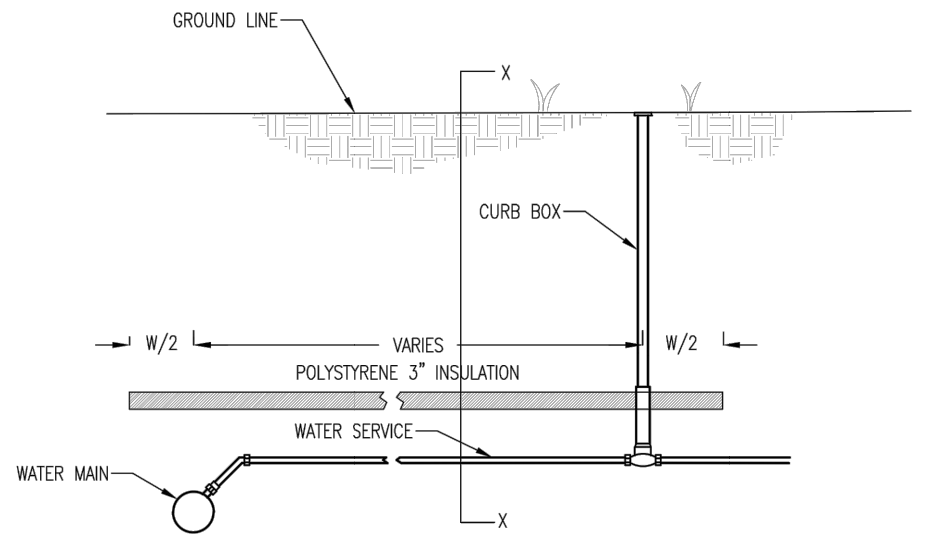
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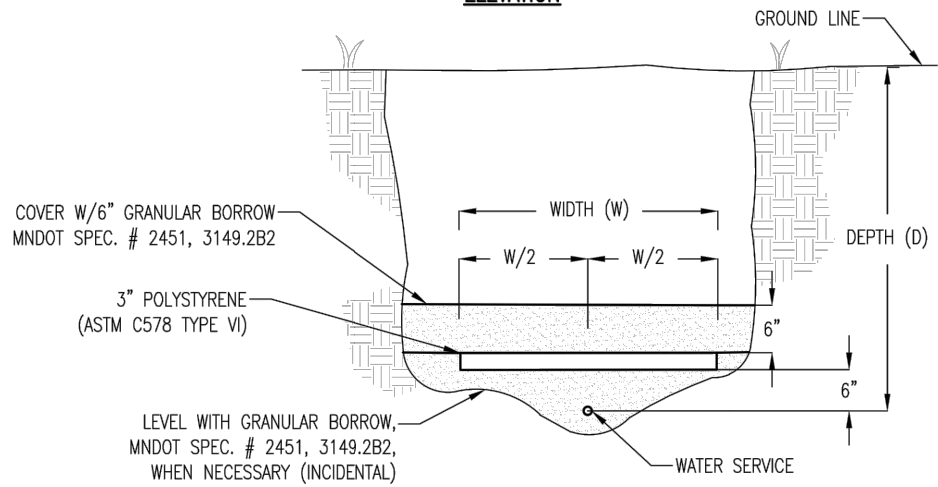
SIGNATURE: *[Signature]* DATE: ####
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ELEVATION



SECTION X-X

- NOTES:
1. LAYERING OF 2 OR 3 SHEETS TO ARRIVE AT 3" IS REQUIRED WITH JOINTS OFFSET A MINIMUM OF 6".
 2. POLYSTYRENE SHALL BE AS SPECIFIED IN THE CITY OF DULUTH PUBLIC WORKS AND UTILITIES STANDARD CONSTRUCTION SPECIFICATIONS.
 3. INSULATION SHALL ONLY BE USED WHERE APPROVED BY THE ENGINEER.

DEPTH (D)	WIDTH (W)
7' OR MORE	NONE
5.2' TO 6.9'	4'-0"
4.3' TO 5.1'	6'-0"
3.0' TO 4.2'	8'-0"

WATER SERVICE INSULATION

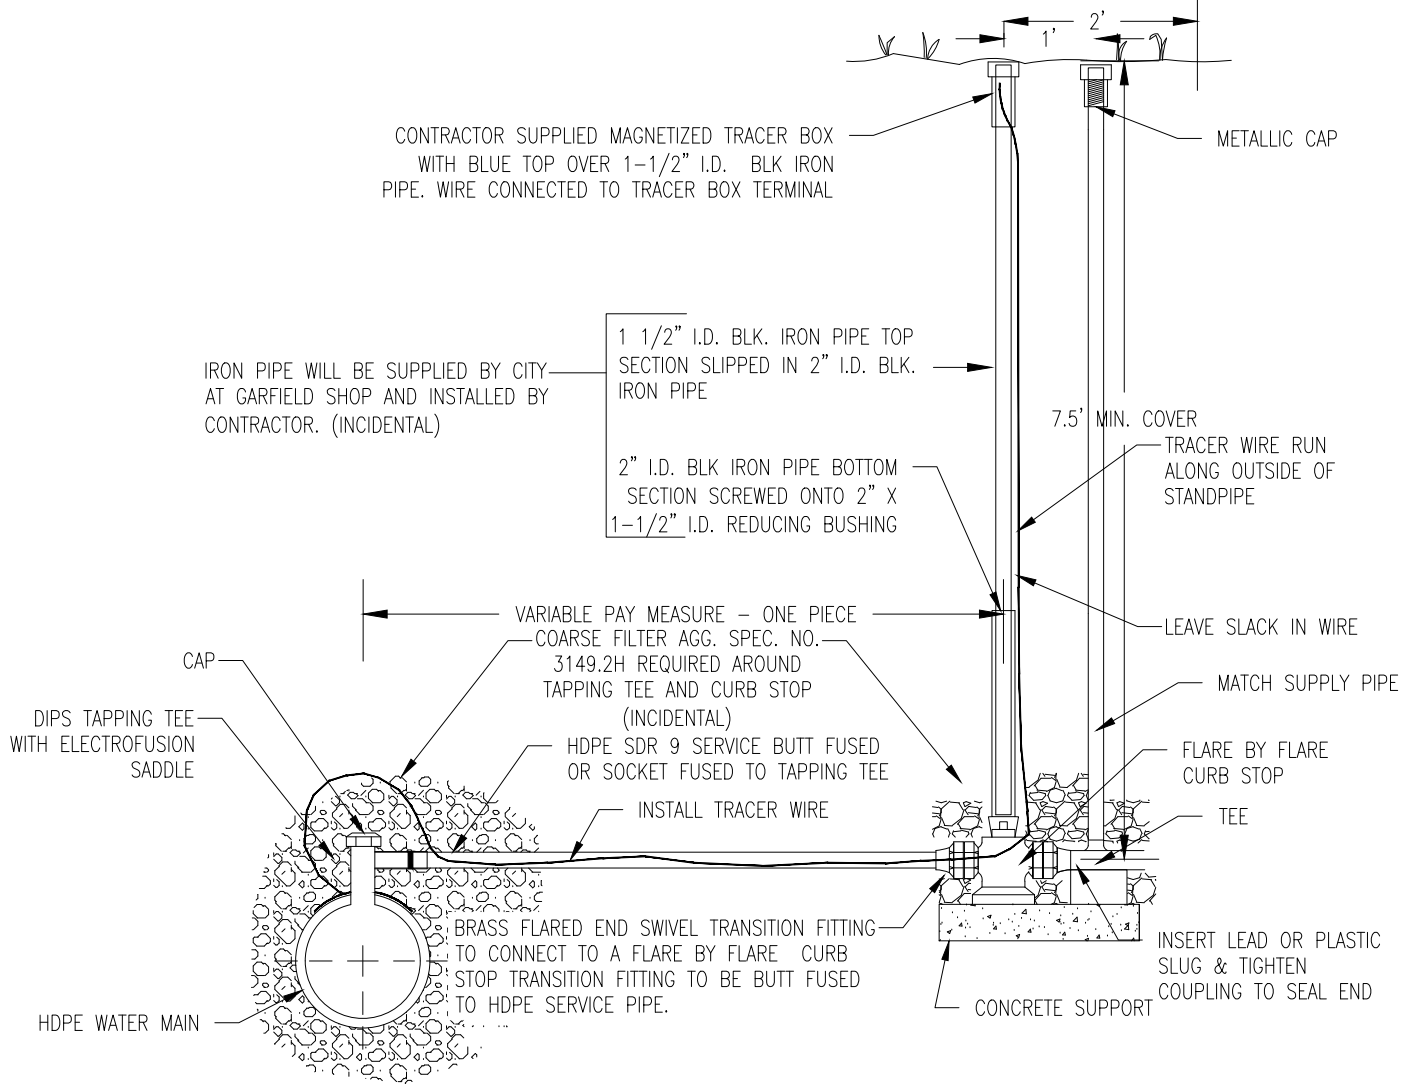
W-13

REVISED/APPROVED 04/05/2019

CITY OF DULUTH STANDARD DETAIL
DEPT. OF PUBLIC WORKS AND UTILITIES

NO SCALE

NOTE: EXCAVATE 6" UNDER IN-PLACE MAIN AND BACKFILL WITH COURSE FILTER AGGREGATE MNDOT SPEC. # 3149.2H. CONTRACTOR SHALL PROVIDE & PLACE A TRENCH BOX WHEN REQUIRED.



NOTE: SERVICE TO BE AIR TESTED PRIOR TO TAPPING MAIN

THE TRACER WIRE SHALL REMAIN CONTINUOUS TO THE GREATEST EXTENT POSSIBLE. SPLICES IN THE TRACER WIRE SHOULD BE MADE WITH SPLIT BOLT CONNECTORS. WIRE NUTS OR CLIP TYPE CONNECTOR SHALL NOT BE USED. A WATER-PROOF CONNECTION IS NECESSARY TO PREVENT CORROSION.

TYPICAL HDPE WATER SERVICE - 1-1/4" WITH BLOW DOWN VALVE

W-5A

REVISED/APPROVED 04/05/2019

CITY OF DULUTH STANDARD DETAIL
DEPT. OF PUBLIC WORKS AND UTILITIES

NO SCALE

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CITY OF DULUTH WATER SERVICE DETAILS



PRV-H

FRAME COLOR: SURREY BEIGE
ROOF COLOR: EVERGREEN
COLORS SHOWN FOR ILLUSTRATIVE PURPOSES ONLY. FOR OTHER
COLOR SELECTIONS, PLEASE SUBMIT AN E1 DRAWING REQUEST.

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01

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DRAWING NO.
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DESIGNED	WDD	<div>I HEREBY CERTIFY THAT THIS PLAN, SPECIFICATION, OR REPORT WAS PREPARED BY ME OR UNDER MY DIRECT SUPERVISION AND THAT I AM A DULY LICENSED ENGINEER UNDER THE LAWS OF THE STATE OF MINNESOTA. DATE: 06/18/20 PRINTED NAME: WILL D. DEROCHE LIC. NO.: 54757</div>
DRAWN	TSM	
CHECKED	WDD	
NO.	DATE	

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PROJECT:

LOCATION:

BUILDING TYPE: PRV-H

ROOF TYPE: MULTI-RIB

DRAWING LIST:

SHEET NUMBER	DRAWING DESCRIPTION
CS	COVER SHEET
1	ARCHITECTURAL ELEVATIONS
2	STRUCTURAL FRAMING PLAN
3	COLUMN LAYOUT

FABRICATOR APPROVALS:

CITY OF PHOENIX, AZ APPROVED FABRICATOR #C08-2010
CITY OF LOS ANGELES, CA APPROVED FABRICATOR #1596
CITY OF RIVERSIDE, CA APPROVED FABRICATOR #SP06-0033
CITY OF HOUSTON, TX APPROVED FABRICATOR #470
CLARK COUNTY, NV APPROVED FABRICATOR #264
STATE OF UTAH APPROVED FABRICATOR 02008-14

CERTIFICATES:

MIAMI-DADE COUNTY CERTIFICATE OF COMPETENCY NO. 16-1025.01
PCI (POWDER COATING INSTITUTE) 4000 CERTIFIED

MATERIALS:

DESCRIPTION
TUBE STEEL
SCHEDULE PIPE
RMT PIPE
LIGHT GAGE COLD FORMED
STRUCTURAL STEEL PLATE
ROOF PANELS (STEEL)

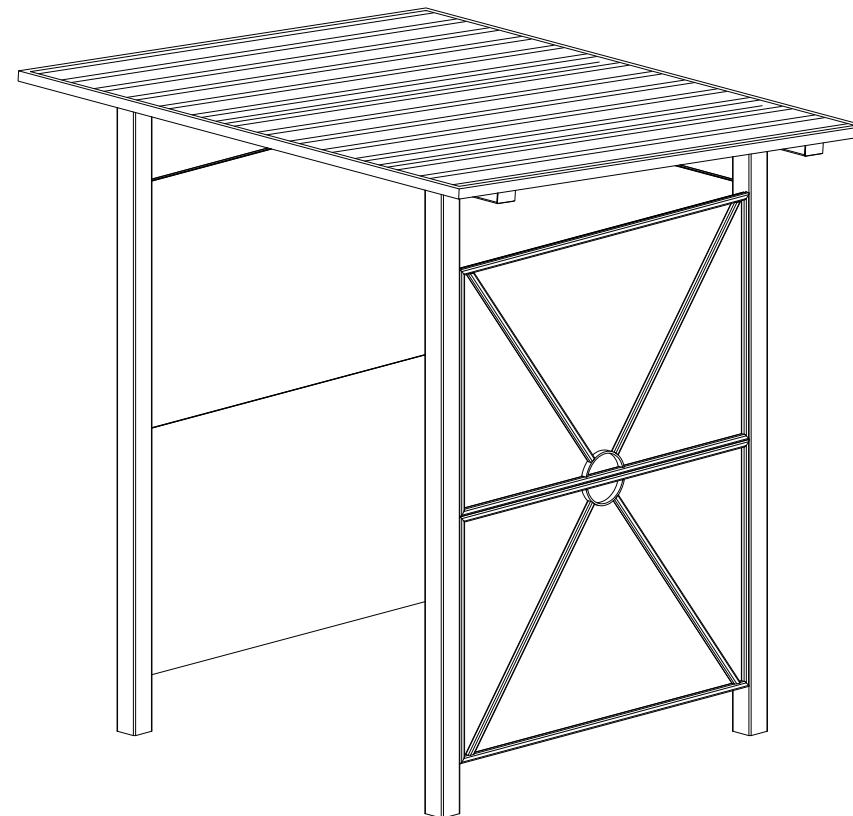
ASTM DESIGNINATION
A500 (GRADE B)
A53 (GRADE B)
A519
A1003 (GRADE 50)
A36
A653

GENERAL NOTES:

UNLESS NOTED OTHERWISE, THIS STRUCTURE WAS DESIGNED TO ONLY SUPPORT WHAT IS SHOWN ON THESE DRAWINGS. POLYGON MUST BE CONTACTED IF ANYTHING ELSE IS TO BE ATTACHED TO THIS STRUCTURE (WALLS, COLUMN WRAPS, RAILINGS, ETC.) SO THE DESIGN OF THIS STRUCTURE CAN BE REVIEWED AND POSSIBLY REVISED.

UNLESS NOTED OTHERWISE, THIS STRUCTURE WAS DESIGNED ASSUMING A 20' SEPARATION BETWEEN ANY ADJACENT STRUCTURE WITH AN EAVE HEIGHT EQUAL TO OR GREATER THAN THE EAVE HEIGHT OF THIS STRUCTURE. IF THAT SEPARATION DOES NOT EXIST, POLIGON MUST BE CONTACTED SO THE DESIGN OF THIS STRUCTURE CAN BE REVIEWED AND POSSIBLY REVISED.

STRUCTURAL STEEL SHALL BE DETAILED, FABRICATED, AND ERECTED IN ACCORDANCE WITH THE LATEST EDITION OF THE AMERICAN INSTITUTE OF STEEL CONSTRUCTION (AISC) SPECIFICATION MANUAL.



ALL WELDING IS PERFORMED BY AMERICAN WELDING SOCIETY
CERTIFIED WELDERS AND CONFORMS TO THE LATEST EDITION OF
AWS D1.1 OR D1.3 AS REQUIRED.

PARTS SHOWN MAY BE UPGRADED DUE TO STANDARDIZED FABRICATION. REFER TO THE SHIPPING BILL OF MATERIALS FOR POSSIBLE SUBSTITUTIONS.

FOR PROPER FIELD INSTALLATION OF THE BUILDING IT IS RECOMMENDED THAT THE PRIMARY FRAME INSTALLER AND THE ROOF INSTALLER HAVE A MINIMUM FIVE (5) YEARS DOCUMENTED EXPERIENCE INSTALLING THIS TYPE OF PRODUCT.

FOR PROPER FIELD INSTALLATION OF THE BUILDING IT IS RECOMMENDED THAT ELECTRIC WIRING, IF REQUIRED, BE RUN THROUGH THE STRUCTURAL MEMBERS BEFORE THE BUILDING IS ERECTED.

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
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SHALL VERIFY ALL DIMENSIONS BY
MEASUREMENT AT THE BUILDING AND/OR SITE

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PROJ. NO.	16893.000
DRAWING NO.	009

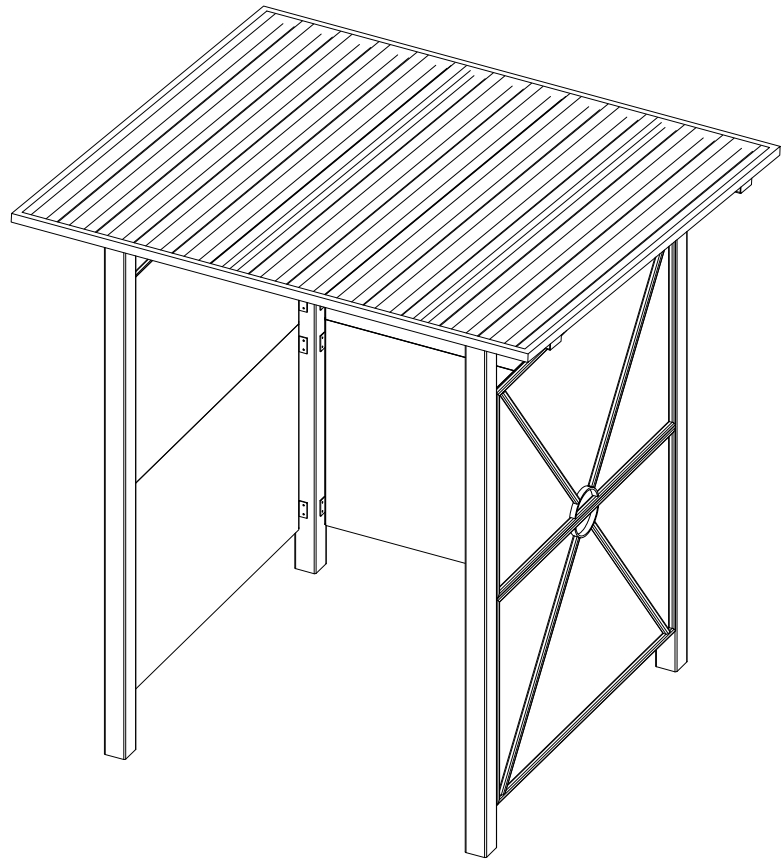
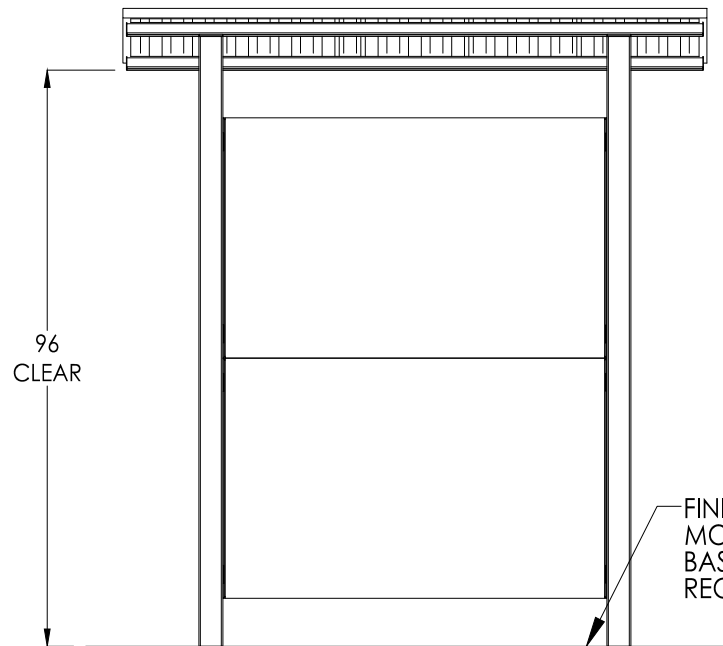
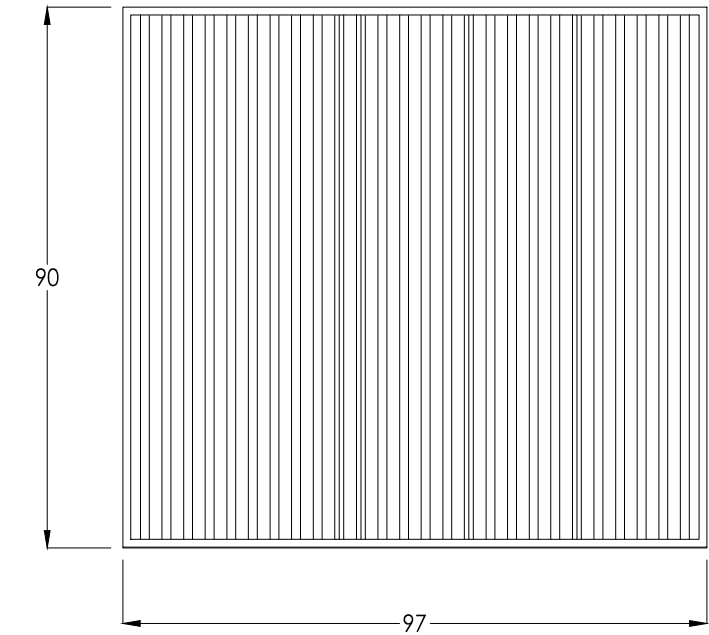
TOILET SCREEN DETAIL 2 OF 5

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NO	DATE	BY	DESCRIPTION OF REVISIONS	SIGNATURE: _____	DATE: 06/18/20
				PRINTED NAME: WILL D. DEROCHE	LIC. NO.: 54757



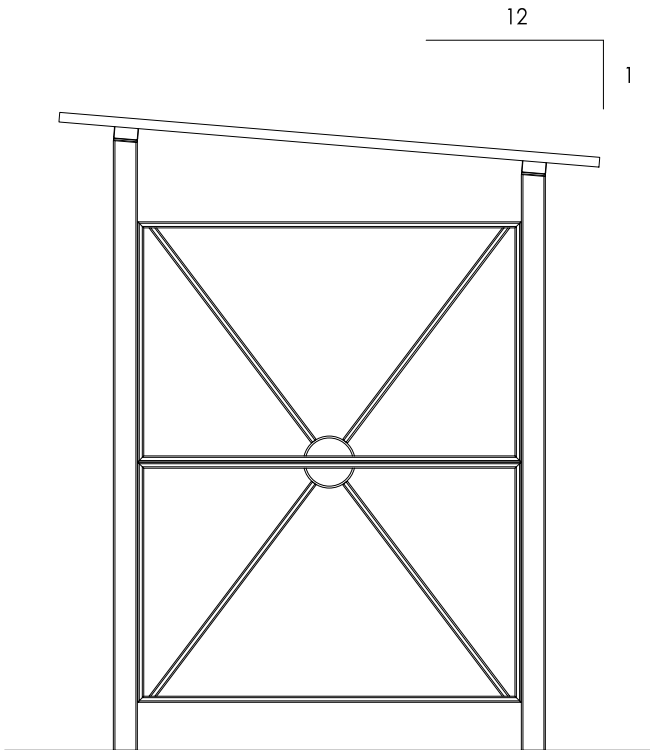
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PLOT DATE: Jul 02, 2020 - 1:25pm
FILE NAME: K:\a-Duluth_City\16893000\04_Production\01_CAD\02_Sheets\16893000 - Keene Creek - Enclosure Screen.dwg



GENERAL ROOF NOTES:

1. METAL ROOFING:
 - 24 GAUGE
 - GALVALUME COATED
 - KYNAR 500 PAINTED
2. TRIM COLOR MATCHES ROOF
3. SEE POLIGON.COM FOR COLOR OPTIONS



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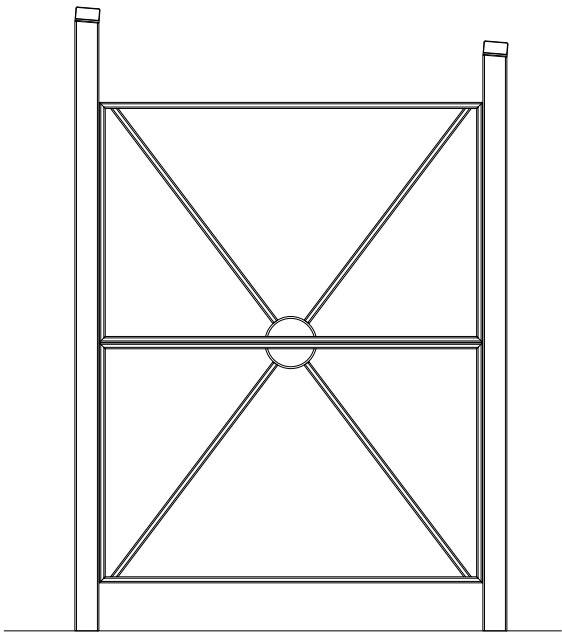
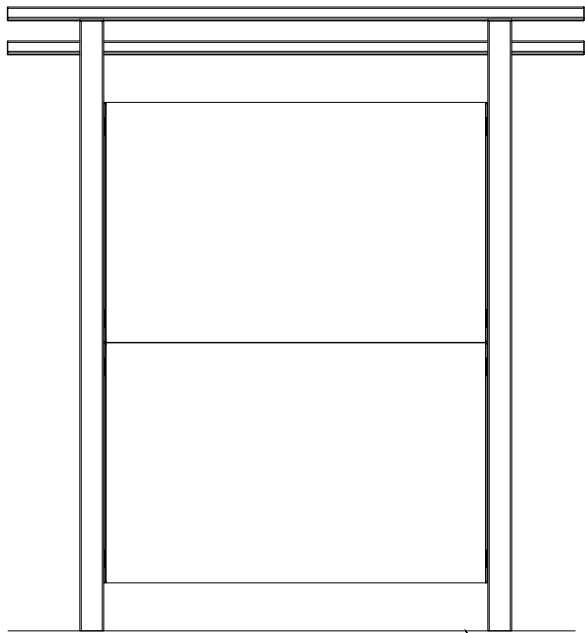
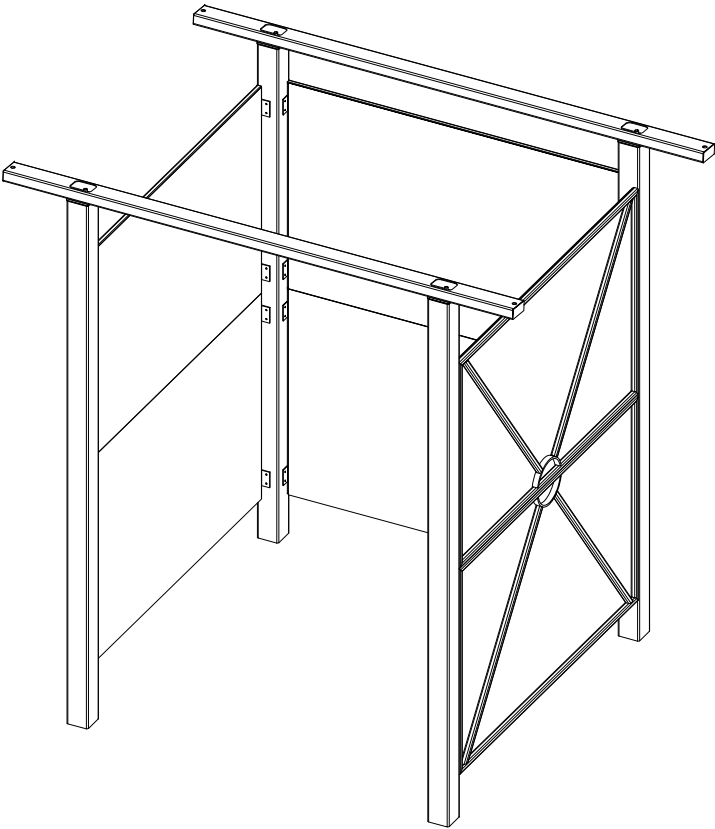
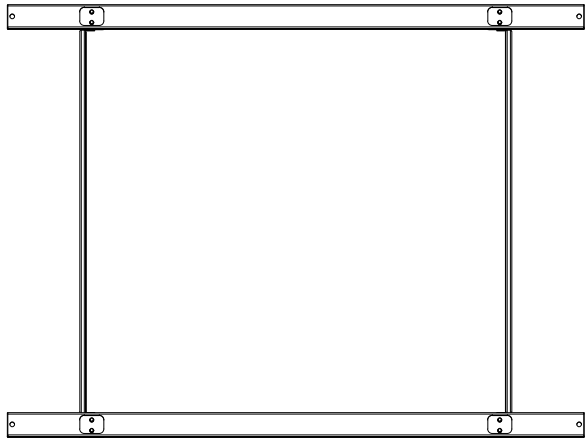
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PRINTED NAME: WILL D. DEROCHE LIC. NO.: 54757



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16893.000
DRAWING NO.
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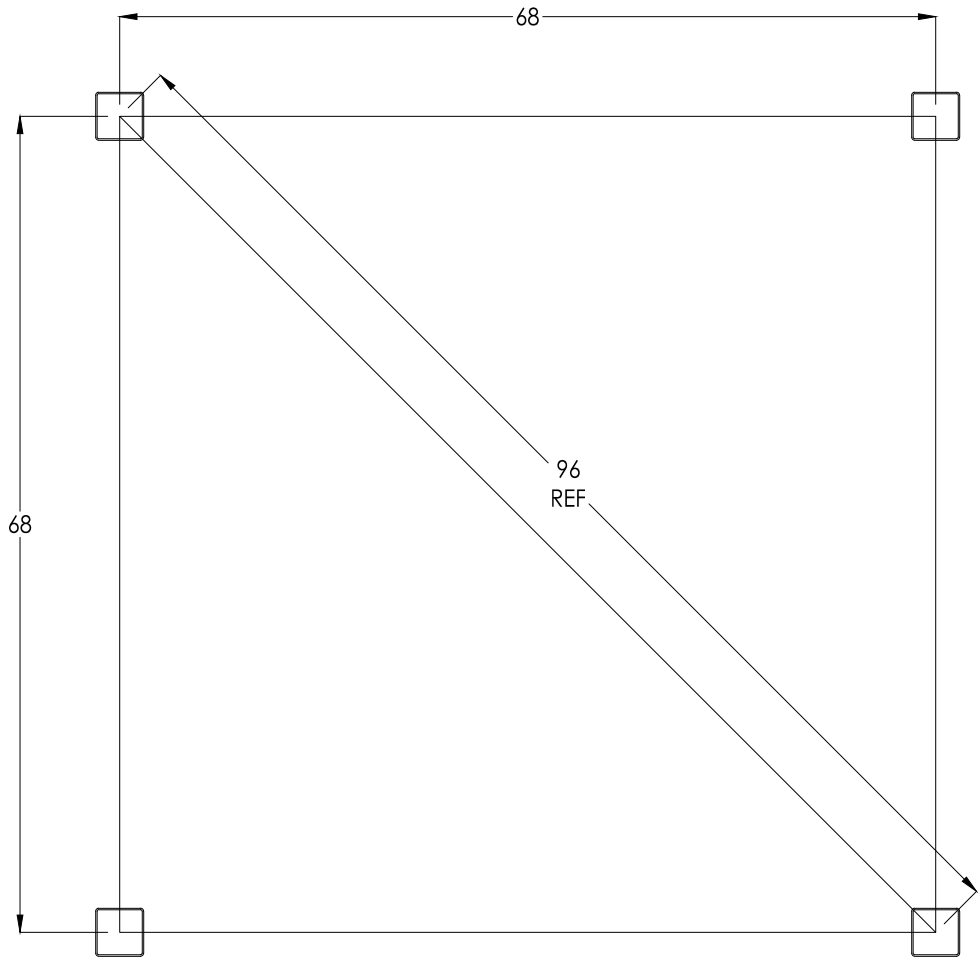
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TOILET SCREEN DETAIL 4 OF 5

Jul 02, 2020 - 1:26pm
K:\a-Duluth_City\16893000\04_Production\01_CAD\02_Sheets\16893000 - Keene Creek - Enclosure Screen.dwg



BASEPLATE NOTES:

- 1. POLIGON ENGINEERING WILL DETERMINE REQUIRED BASEPLATE DESIGN AFTER ENGINEERING PACKAGE IS ORDERED.
- 2. CUSTOMER MAY SUGGEST PREFERRED BASEPLATE DESIGN.

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CHECKED	WDD


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PRINTED NAME: WILL D. DEROCHE LIC. NO.: 54757



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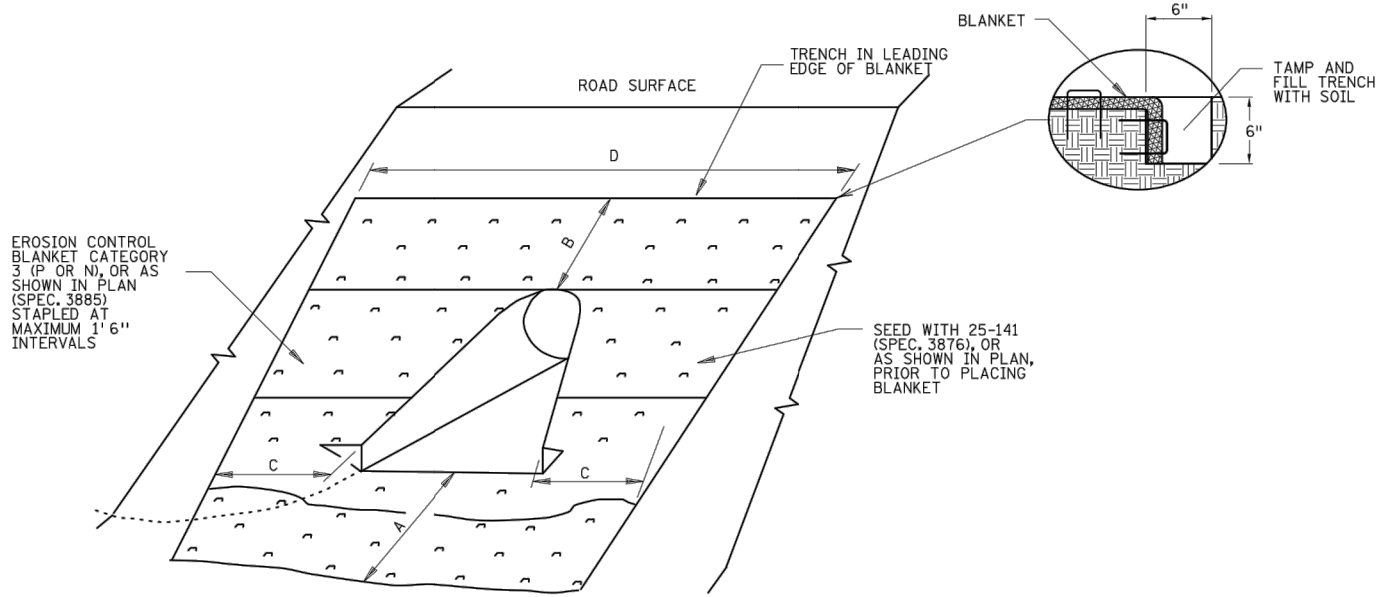
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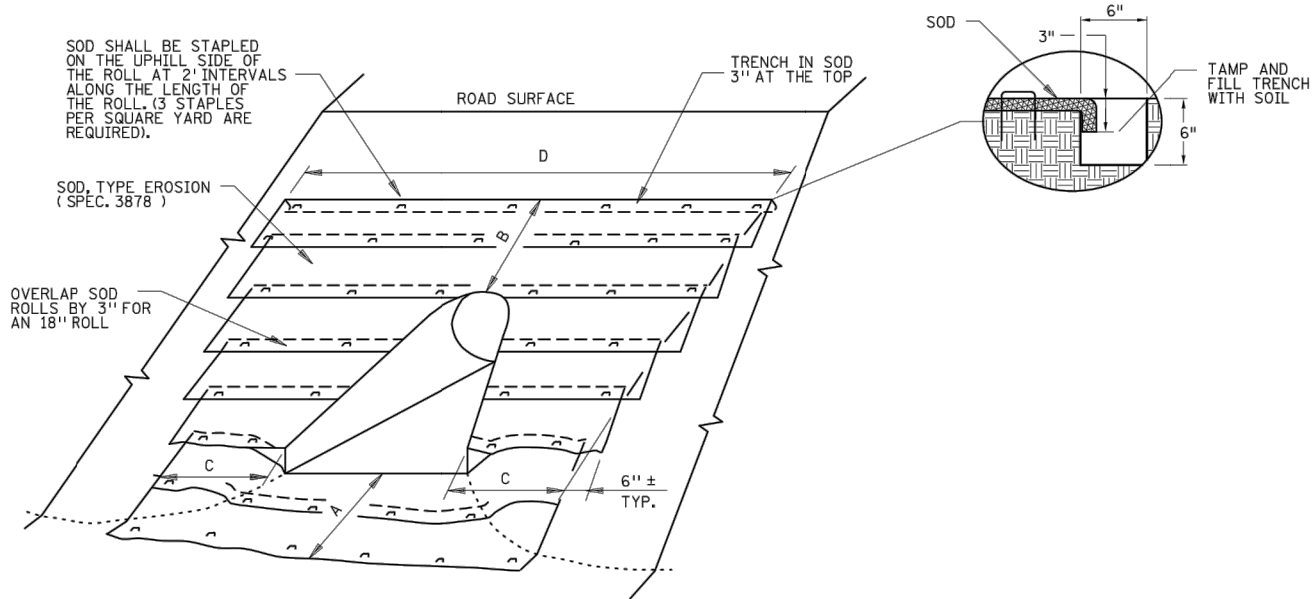
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IFPLOT NAME: s404_2_spn
PATH & FILENAME: OTS\DesignStandards\Development\New Border\400_Series\es04_2_spn.dgn
PLOTTED/REVISED: 4-APR-2018



EROSION CONTROL BLANKET & SEED DETAIL



SODDING DETAIL

CULVERT INLET APRON ①									
CULVERT DIAMETER ②	SOD OR EROSION CONTROL BLANKET (SQ. YDS.)						"A"	"B"	"C"
	CIRCULAR AND ARCH PIPE METAL APRON (PLATE 3123, PLATE 3122)	CIRCULAR AND ARCH PIPE CONCRETE APRON (PLATE 3100, PLATE 3110)	CIRCULAR AND ARCH PIPE METAL SAFETY APRON 1:4 SLOPE (PLATE 3148)	CIRCULAR AND ARCH PIPE METAL SAFETY APRON 1:6 SLOPE (PLATE 3148)	CIRCULAR CORRUGATED METAL PIPE SAFETY APRON 1:6 SLOPE (PLATE 3128)	CIRCULAR CORRUGATED METAL PIPE SAFETY APRON 1:4 SLOPE (PLATE 3128)			
15"	9	9	8	8	N/A	N/A	3'	1.5'	3'
18"	13	12	12	14	16	N/A	3'	3'	3'
21"	14	14	14	16	18	14	3'	3'	17'
24"	16	15	16	19	21	17	3'	3'	18'
27"	N/A	20	N/A	N/A	N/A	N/A	3'	4.5'	3'
30"	23	22	25	30	32	N/A	3'	4.5'	3'
36"	34	34	39	48	51	37	4.5'	4.5'	27'
42"	43	40	51	64	N/A	N/A	4.5'	6'	30'
48"	54	50	66	82	N/A	N/A	4.5'	7.5'	34'
54"	65	58	81	102	N/A	N/A	4.5'	9'	37'
60"	69	59	91	115	N/A	N/A	4.5'	9'	39'
66"	69	63	N/A	N/A	N/A	N/A	4.5'	9'	39'
72"	78	72	99	122	N/A	N/A	4.5'	10.5'	41'

CULVERT OUTLET APRON ①									
CULVERT DIAMETER ②	SOD OR EROSION CONTROL BLANKET (SQ. YDS.)						"A"	"B"	"C"
	CIRCULAR AND ARCH PIPE METAL APRON (PLATE 3123, PLATE 3122)	CIRCULAR AND ARCH PIPE CONCRETE APRON (PLATE 3100, PLATE 3110)	CIRCULAR AND ARCH PIPE METAL SAFETY APRON 1:4 SLOPE (PLATE 3148)	CIRCULAR AND ARCH PIPE METAL SAFETY APRON 1:6 SLOPE (PLATE 3148)	CIRCULAR CORRUGATED METAL PIPE SAFETY APRON 1:6 SLOPE (PLATE 3128)	CIRCULAR CORRUGATED METAL PIPE SAFETY APRON 1:4 SLOPE (PLATE 3128)			
15"	10	10	9	10	N/A	N/A	4.5'	1.5'	3'
18"	13	13	12	14	15	N/A	6'	1.5'	3'
21"	16	14	16	18	19	15	6'	1.5'	15'
24"	18	18	18	21	22	18	7.5'	1.5'	16'
27"	N/A	19	N/A	N/A	N/A	N/A	7.5'	1.5'	17'
30"	23	23	24	28	29	N/A	9'	1.5'	18'
36"	36	35	38	47	48	37	10.5'	1.5'	23'
42"	43	40	47	58	N/A	N/A	12'	1.5'	25'
48"	50	46	57	70	N/A	N/A	13.5'	1.5'	27'
54"	57	50	67	84	N/A	N/A	15'	1.5'	29'
60"	74	63	90	113	N/A	N/A	16.5'	1.5'	33'
66"	75	67	N/A	N/A	N/A	N/A	16.5'	1.5'	33'
72"	77	70	92	114	N/A	N/A	16.5'	1.5'	34'

NOTES:

AREA SHOWN IN SQUARE YARDS IS FOR ONE CULVERT END.

QUANTITIES ARE CALCULATED TO INCLUDE SOD REQUIRED TO PROVIDE A 3" OVERLAP ON ALL 18" WIDE ROLLS. THIS ALLOWS FOR SHRINKAGE OF THE SOD.

FOR PIPE ARCHES USE EQUIVALENT PIPE DIAMETER TO APPROXIMATE AREA.

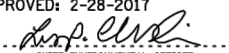
FOR CORRUGATED POLYETHYLENE PIPE METAL APRON (PLATE 3129), USE THE METAL APRON COLUMN (PLATE 3123).

AREAS AND DIMENSIONS ARE APPROXIMATE AND ARE BASED ON APRON SIDE SLOPES OF NO STEEPER THAN 1:2, UNLESS INDICATED AS FOR SAFETY APRONS.

CARE SHOULD BE TAKEN IN SELECTING SOD TO STABILIZE THE APRON. RIP-RAP SHOULD BE USED FOR FLOW VELOCITIES GREATER THAN 6 FPS.

① ADDITIONAL QUANTITIES MAY BE SHOWN IN THE PLAN OR REQUIRED BY THE ENGINEER.

② FOR ARCH PIPE USE CLOSEST CIRCULAR PIPE DIAMETER AND APRON SLOPE. (DIAMETERS LARGER THAN 72" REQUIRE SPECIAL DESIGNS.)

REVISION:
APPROVED: 2-28-2017

CHIEF ENVIRONMENTAL OFFICER



STANDARD PLAN 5-297.404

2 OF 3

APPROVED: 2-28-2017
REVISED:

STATE DESIGN ENGINEER

STATE PROJ. NO.

PERMANENT EROSION CONTROL
TURF ESTABLISHMENT DETAIL AT CULVERT ENDS

(T.H.)

SHEET NO. OF

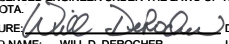
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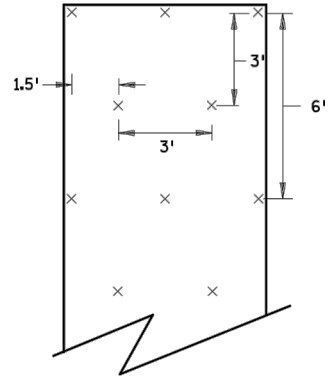
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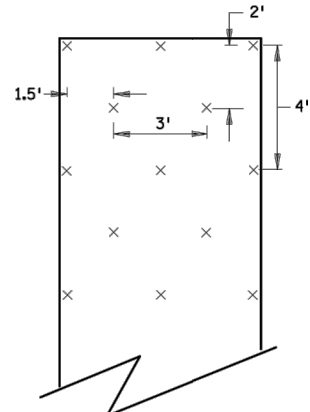
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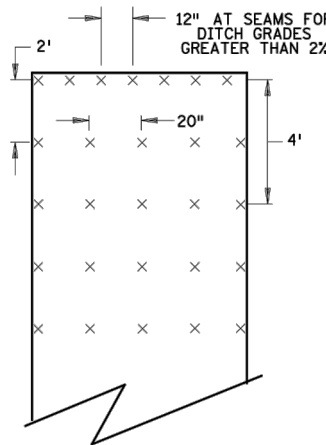
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SLOPES FLATTER THAN 1:2
(120 STAPLES PER 100 SQ YD)

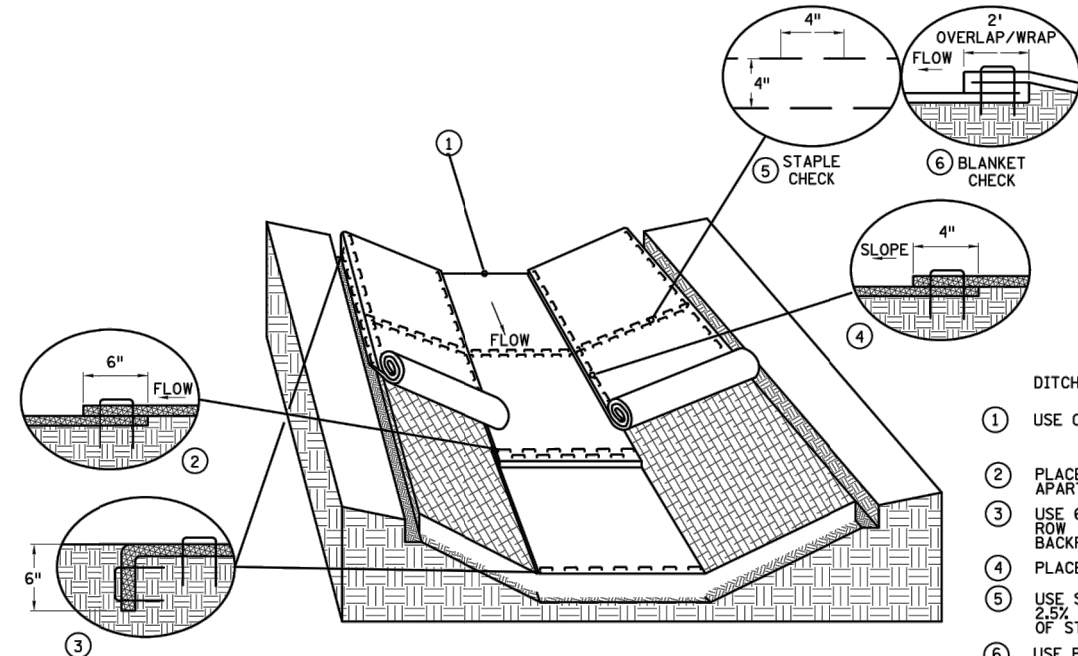


SLOPES 1:2 TO 1:1
(170 STAPLES PER 100 SQ YD)

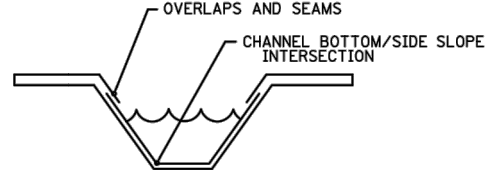


CHANNEL AND DITCH APPLICATIONS
(350 STAPLES PER 100 SQ YD)

BLANKET STAPLE PATTERN

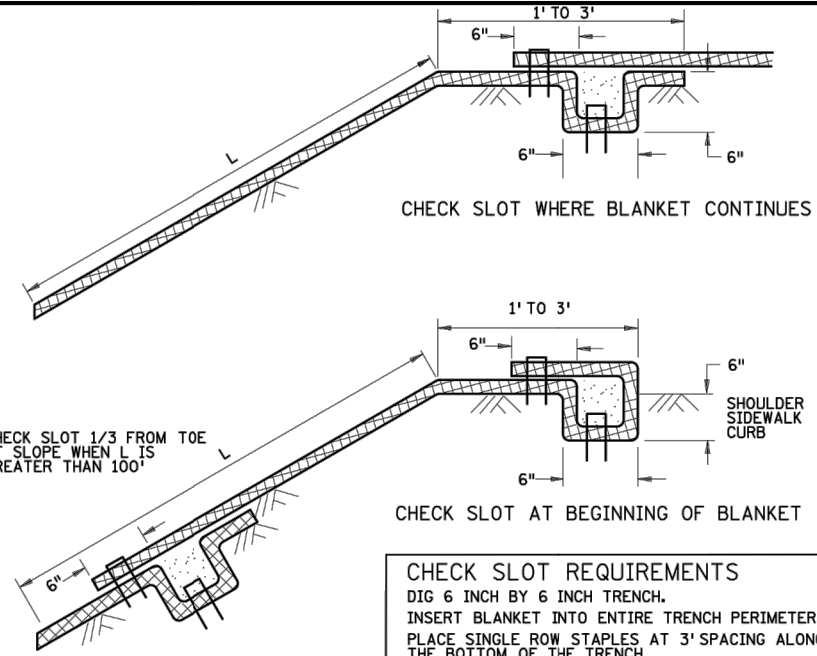


DITCH BLANKET STAPLE DETAIL



DITCH BLANKET CRITICAL POINTS ⑦

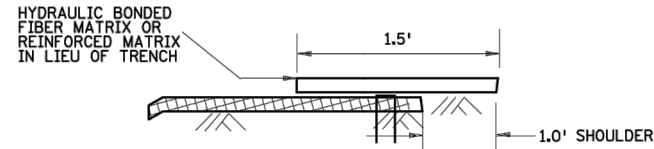
- DITCH BLANKET STAPLE DETAIL NOTES
- 1 USE CHECK SLOT DETAIL (NO ALTERNATES).
 - 2 PLACE DOUBLE ROW OF STAPLES STAGGERED 4" APART AND 4" ON CENTER.
 - 3 USE 6" X 6" TRENCH TO PLACE BLANKET. PLACE SINGLE ROW OF STAPLES ON TOP AND TRENCH SIDES AT 12" SPACING. BACKFILL TRENCH WITH SOIL AND TAMP.
 - 4 PLACE SINGLE ROW OF STAPLES AT 12" SPACING.
 - 5 USE STAPLE CHECK FOR CHANNEL SLOPES LESS THAN 2.5% GRADE AT 100 FOOT INTERVALS. PLACE DOUBLE ROW OF STAPLES STAGGERED 4" APART AND AT 4" SPACING.
 - 6 USE BLANKET CHECKS FOR THE FOLLOWING SLOPES:
2.5%-3% 100 FT INTERVALS
3%-5% 50 FT INTERVALS
5%-7% 25 FT INTERVALS
 - 7 CRITICAL POINTS SHALL BE SECURED WITH PROPER STAPLE PATTERNS.



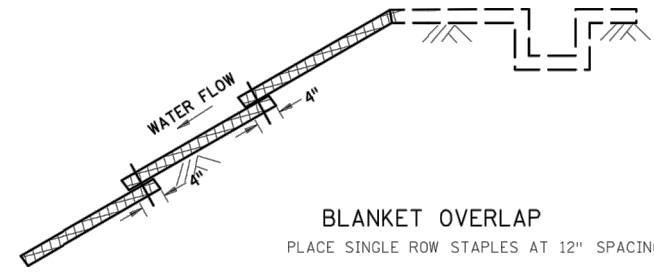
CHECK SLOT WHERE BLANKET CONTINUES

CHECK SLOT AT BEGINNING OF BLANKET

CHECK SLOT REQUIREMENTS
DIG 6 INCH BY 6 INCH TRENCH.
INSERT BLANKET INTO ENTIRE TRENCH PERIMETER.
PLACE SINGLE ROW STAPLES AT 3' SPACING ALONG THE BOTTOM OF THE TRENCH.
BACKFILL TRENCH WITH SOIL AND TAMP.
PLACE SINGLE ROW STAPLES AT 3' SPACING ON OVERLAP.



CHECK SLOT ALTERNATIVE
PLACE SINGLE ROW STAPLES AT 12" SPACING
CHECK SLOT DETAILS



BLANKET OVERLAP
PLACE SINGLE ROW STAPLES AT 12" SPACING

GENERAL BLANKET INSTALLATION REQUIREMENTS
PREPARE SOIL AS PER SPECIFICATION 2574.
LAY PARALLEL OR PERPENDICULAR TO THE DIRECTION OF WATER FLOW.
OVERLAP ADJACENT STRIP EDGES A MINIMUM OF 4 INCHES.
OVERLAP BLANKET 6" (MIN.) AT EACH END. OVERLAP BOTTOM END OF UPPER BLANKET OVER TOP END OF LOWER BLANKET. STAPLE ALONG OVERLAP EVERY 1.5'.
THE UPPERMOST BLANKET OF ALL SLOPE APPLICATIONS MUST START IN A CHECK SLOT. IF SLOPE LENGTH (L) IS 100' OR GREATER, INSERT BLANKET INTO A CHECK SLOT 1/3 FROM THE BOTTOM OF THE SLOPE.

REVISION: 8-6-2019
APPROVED: 2-28-2017
CHIEF ENVIRONMENTAL OFFICER



STANDARD PLAN 5-297.404 3 OF 3
APPROVED: 2-28-2017
REVISED: 8-6-2019
STATE PROJ. NO. (T.H.) SHEET NO. OF SHEETS

PERMANENT EROSION CONTROL
BLANKET STAPLE PATTERN FOR SLOPES

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I HEREBY CERTIFY THAT THIS PLAN, SPECIFICATION, OR REPORT WAS PREPARED BY ME OR UNDER MY DIRECT SUPERVISION AND THAT I AM A DULY LICENSED ENGINEER UNDER THE LAWS OF THE STATE OF MINNESOTA.
SIGNATURE: *Will D. Derocher* DATE: 06/18/20
PRINTED NAME: WILL D. DEROCHE UC. NO.: 54757



11 E. Superior Street, Suite 420
Duluth, MN 55802
218.724.8578
tkda.com

ROLLED EROSION PREVENTION INSTALLATION

PROJ. NO. 16893.000
DRAWING NO. 014

PROJECT DESCRIPTION

THIS PROJECTED WILL IMPROVE STORMWATER CONTROL AND TREATMENT IN KEENE CREEK PARK IN DULUTH, MN. GROUND DISTURBING ACTIVITIES ASSOCIATED WITH THIS PROJECT WILL INCLUDE GRADING, DRAINAGE IMPROVEMENTS, UTILITY IMPROVEMENTS AND PATHWAY CONSTRUCTION. THE TOTAL LAND AREA ANTICIPATED TO BE DISTURBED BY THE PROJECT (EXCLUSIVE OF BORROW AND DISPOSAL AREAS) IS 2.33 ACRES.

SWPPP IMPLEMENTATION CONTACTS			
AGENCY	PERMIT	NAME	PHONE/ EMAIL
PROJECT MANAGER	N/A	T.B.D.	PHONE EMAIL
CONTRACTOR'S EROSION CONTROL SUPERVISOR	N/A	T.B.D.	PHONE EMAIL
CITY OF DULUTH	CONSTRUCTION AND GRADING	JIM SHOBERG	218.730.4316 jshoberg@duluthmn.gov
PROJECT ENGINEER	N/A	WILL DEROCHE, PE	218.491.7384 will.derocher@tdka.com
MPCA	NPDES	JIM DEXTER	218.302.6632 james.dexter@state.mn.us

CONSTRUCTION NOTES

CONSTRUCTION SHALL BE GOVERNED BY THE 2018 MNDOT STANDARD SPECIFICATIONS, CITY OF DULUTH - MINNESOTA STANDARD CONSTRUCTION SPECIFICATIONS AND SPECIAL PROVISIONS.

THE CONTRACTOR SHALL BE RESPONSIBLE FOR IMPLEMENTATION OF THE SWPPP AND THE INSTALLATION, INSPECTION AND MAINTENANCE OF THE EROSION AND SEDIMENT CONTROL BMPS FOR THE DURATION OF THE PROJECT.

THE CONTRACTOR SHALL KEEP THE INSPECTION AND MAINTENANCE LOGS IN ACCORDANCE WITH THIS SWPPP, ALL PERMITS, ALL INSPECTION AND MAINTENANCE RECORDS AND DESIGN CALCULATIONS. THE CONTRACTOR SHALL MAINTAIN A RESPONSIBLY SIZED STOCKPILE OF EROSION CONTROL DEVICES AVAILABLE FOR RAPID DEPLOYMENT WHEN NECESSARY.

CALCULATIONS

TOTAL DISTURBED AREA = 2.33 ACRES
POST CONSTRUCTION IMPERVIOUS AREA = 0.40 ACRES
EXISTING IMPERVIOUS AREA = 0.77 ACRES
IMPERVIOUS NET = 0.37 ACRES (DECREASE)

TIMING OF BMP INSTALLATION

THE EROSION AND SEDIMENTATION CONTROL BMPS SHALL BE INSTALLED PRIOR TO ANY CONSTRUCTION ACTIVITY TO MINIMIZE EROSION FROM DISTURBED SURFACES AND CAPTURE SEDIMENT ON SITE, AND SHALL MEET THE NPDES PERMIT PART IV CONSTRUCTION ACTIVITY REQUIREMENTS.

1. TEMPORARY PERIMETER CONTROL BMPS WILL BE INSTALLED BEFORE ANY UP GRADIENT SOIL DISTURBANCES OCCUR.
2. PERMANENT AND TEMPORARY SEDIMENT TRAPS AND BASINS (IF APPLICABLE) WILL BE CONSTRUCTED BEFORE ANY SITE DISTURBANCES ARE PERMITTED.
3. DITCHES/ WET SWALES SHALL BE EXCAVATED TO GRADING GRADE AND PROTECTED WITH BALE CHECKS AND SILT FENCE UNTIL ROAD AND UTILITY CONSTRUCTION HAS BEEN STABILIZED. FINAL DITCH GRADES AND FILTER MEDIUM SHALL BE PLACED AFTER TURF HAS BEEN ESTABLISHED.
4. TOPSOIL, SEED, EROSION CONTROL BLANKET AND NECESSARY ADDITIONAL TEMPORARY EROSION CONTROL BMPS (IF APPLICABLE) SHALL BE PLACED WITHIN 7 DAYS OF COMPLETION OF ANY EMBANKMENT.
5. PLACEMENT OF RIPRAP SHALL BE COMPLETED WITHIN 24 HOURS OF CULVERT PLACEMENT, AND DONE IN ONE CONTINUOUS OPERATION.
6. DISTURBED AREAS IN WHICH CONSTRUCTION ACTIVITIES HAVE CEASED OR WILL BE SUSPENDED FOR 7 DAYS OR MORE SHALL BE STABILIZED WITH TEMPORARY OR PERMANENT BMPS FOR EROSION.

CONTACTS

THE SWPPP ENGINEER IS:
WILL DEROCHE, P.E.
TKDA -
11 E. SUPERIOR ST. SUITE 420
DULUTH, MN 55802
218.491.7384
will.derocher@tkda.com

PROJECT SUPERVISOR IS: (TBD)
NAME
ADDRESS
PHONE
EMAIL

JUL 02, 2020 - 1:26pm
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DESIGNED	XXX
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SIGNATURE: <i>Will Derocher</i>	DATE: 06/18/20
PRINTED NAME: WILL D. DEROCHE	U.C. NO.: 54757



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ALL CONTRACTORS AND SUBCONTRACTORS SHALL VERIFY ALL DIMENSIONS BY MEASUREMENT AT THE BUILDING AND/OR SITE	0 1 BAR IS ONE INCH ON ORIGINAL DRAWING. IF NOT ONE INCH ON THIS DRAWING ADJUST SCALES ACCORDINGLY.
PROJ. NO. 16893.000	DRAWING NO. 015

STORM WATER POLLUTION PREVENTION PLAN

1.

The current City of Duluth Construction Standards, shall apply.

Contractor will be permittee for the MPCA NPDES stormwater construction permit for this project - Contractor's signature on permit is required.

Submit Initial Erosion Control (EC) schedule at or before the pre-construction meeting.

Submit EC schedule alterations/adjustments weekly thereafter for Engineers approval.
2.

The Contractor is responsible for EC Quality Control on this project. (MnDOT 1717.2 B)

Contractor shall phase/sequence the project to minimize exposure to erosion. Contractor shall place or otherwise construct erosion control and sediment containment devices to minimize the runoff, tracking and sediment loss from disturbed areas of the project site.
3.

Sediment and erosion control devices shall be functional before ground disturbance activities begin.
4.

Total disturbed area is 2.33 acres, beginning impervious area is 0.77 acres, and new impervious area is 0.40 acres.
5.

Receiving water is Keene Creek.
6.

Disturbed slopes not actively worked shall be protected from soil erosion with temporary or permanent cover within permit requirements but in no case greater than 7 days of being worked.

Use erosion control blanket with soil staples, or engineer approved equal.
7.

At minimum, the following controls will be implemented at the construction site:

* Sediment control logs shall be used in conjunction with other erosion BMPs.

* Rock ditch checks or approved equal are to be used to reduce ditch velocities and reduce erosion.

* Storm inlets and outlet area shall be protected with rip rap.

* Stabilized construction entrance shall be used to reduce sediment tracking.

* Storm inlets shall be continuously protected by rock filled socks or specified inlet protection devices.

* Permanent vegetation will be established right after topsoil is re-spread.

* Control all site waste, debris, material storage, concrete washout, to prevent impacts to any drainageway.

* All exposed soil areas with a slope of 3:1 or steeper, that have a continuous positive slope to a special water must have temporary erosion protection or permanent cover within 3 days after the area is no longer actively being worked. All other slopes that have a continuous positive slope to a special water must have temporary erosion protection or permanent cover within 7 days after the area is no longer actively being worked.

8.

All slopes and ditches shall be stabilized prior to opening new culverts into existing drainage ways.

9.

If any stockpile is to remain in place for more than 3 days, sediment and erosion control devices shall be used.

10.

Water pumped or otherwise discharged from the site during construction dewatering shall be directed through effective filtering device(s), and discharged to an energy dissipating device to eliminate erosion at the outlet.

11.

Site dust generation must be controlled by application of water by spray trucks or similarly effective means of dust control.

12.

The contractor shall take all possible precautions to prevent appreciable soil tracking onto roadways. Where sediment has been tracked-out from the site onto the surface of off-site streets, other paved areas or sidewalks, the deposited sediment must be removed by the end of the same work day in which the trackout occurs or by the end of the next work day if track-out occurs on a non-work day. The tracked sediment must be removed by sweeping, shoveling, vacuuming or by using other similarly effective means of sediment removal. Hosing or sweeping tracked out sediment into any stormwater conveyance (unless it is connected to a sediment basin, sediment trap, or similarly effective control), storm drain inlet or surface water is prohibited.

13.

Stabilized construction entrance(s) shall be removed and area restored after grading is complete.

14.

JAW MnDot 1717.2 B, the contractor QC program shall ensure that a competent individual shall inspect erosion and sediment control devices weekly and after each rain event. All nonfunctional devices shall be repaired/replaced/cleaned. Maintain NPDES Log of all weekly and rain event inspections - include the corrective actions that were taken and update the SWPPP to reflect the amended plan. Inspection logs and a current SWPPP shall be maintained on site and available upon request.

15.

Where not otherwise specified use Rolled Erosion Prevention Category 25 erosion control blanket (ECB) [N. American Green S150 or approved equal]. Use with seed mixture 36-311 @ 33.5 lbs per acre and fertilizer 10-10-10 @ 200 lbs per acre. The fertilizer, seed, and blanket shall be placed as per Mn/DOT 2575.5 and 2575.6. The upgrade end of each blanket strip shall be buried at least 6 inches in a vertical check slot. Staples shall be placed at seams and throughout the blanket at a maximum spacing in all directions of 2 feet.
- CONSTRUCTION PRACTICES TO MINIMIZE STORM WATER CONTAMINATION
- TO PREVENT STORM WATER CONTAMINATION FROM OCCURRING, THE FOLLOWING BMPS WILL BE IMPLEMENTED:
1.

All areas that are rough graded must be kept in a smooth condition to allow sheet flow of storm water wherever practical and always ready for surface application of degradable or non-degradable blankets, mulch or other protective covers.

2.

A stabilized construction entrance/exit will be constructed to reduce vehicle tracking of sediments off the project right of way.

3.

All non-hazardous waste materials will be collected and stored in a securely lidded metal dumpster or other approved containment method at the end of each day. Any alternative to a metal dumpster must be submitted in writing for approval by the project engineer. All trash and construction debris from the site will be deposited in the dumpster. The dumpster will be emptied as necessary to function as intended for debris collection. No construction materials will be buried on-site. The contractor's erosion control supervisor will instruct all personnel regarding the correct procedure for disposal.

4.

A licensed sanitary waste management contractor will collect all sanitary waste from the portable units at a rate necessary to maintain design function.

5.

All vehicles on site will be monitored for leaks and receive regular preventative maintenance to reduce the chance of leakage.

6.

Fertilizers will be stored in a covered shed and partially used bags will be transferred to a sealable bin to reduce chance of spillage.

7.

Petroleum products will be stored in tightly sealed containers, which are clearly labeled.

8.

Spill kits will be included with all fueling sources and maintenance activities. Secondary containment measures will be installed and maintained by the contractor.

9.

Any asphalt substances used on site will be applied in accordance with manufacturers recommendations.

10.

All paint containers and curing compounds will be tightly sealed and stored when not required for use. Excess paint will not be discharged to the storm water system but will be properly disposed of according to manufacturer's instructions.

11.

Materials and equipment necessary for spill clean up will be kept in an enclosed trailer or shed on site, Equipment will include, but not limited to, brooms, mops, dust pans, rags, gloves, absorbent (kitty litter). Oil absorbent brooms and diapers, and buckets.

12.

All spills will be contained and cleaned up immediately upon discovery, Spills large enough to reach the stormwater conveyance system will be reported to the Minnesota duty officer at 1.800.422.0798.

13.

Concrete trucks will not be allowed to wash out or discharge surplus concrete or drum wash water on the site. Unless done in an engineered containment system. The engineered system must include site drawings for the project file and written assurance that the system will work as designed and leave no discharge of concrete or concrete residue potential to waters of the state during a minimum of a 100 year storm event.

14.

Form release oil used for concrete work must be applied over a pallet containing absorbent to collect excess liquid. The absorbent material will be replaced and properly disposed of when saturated.



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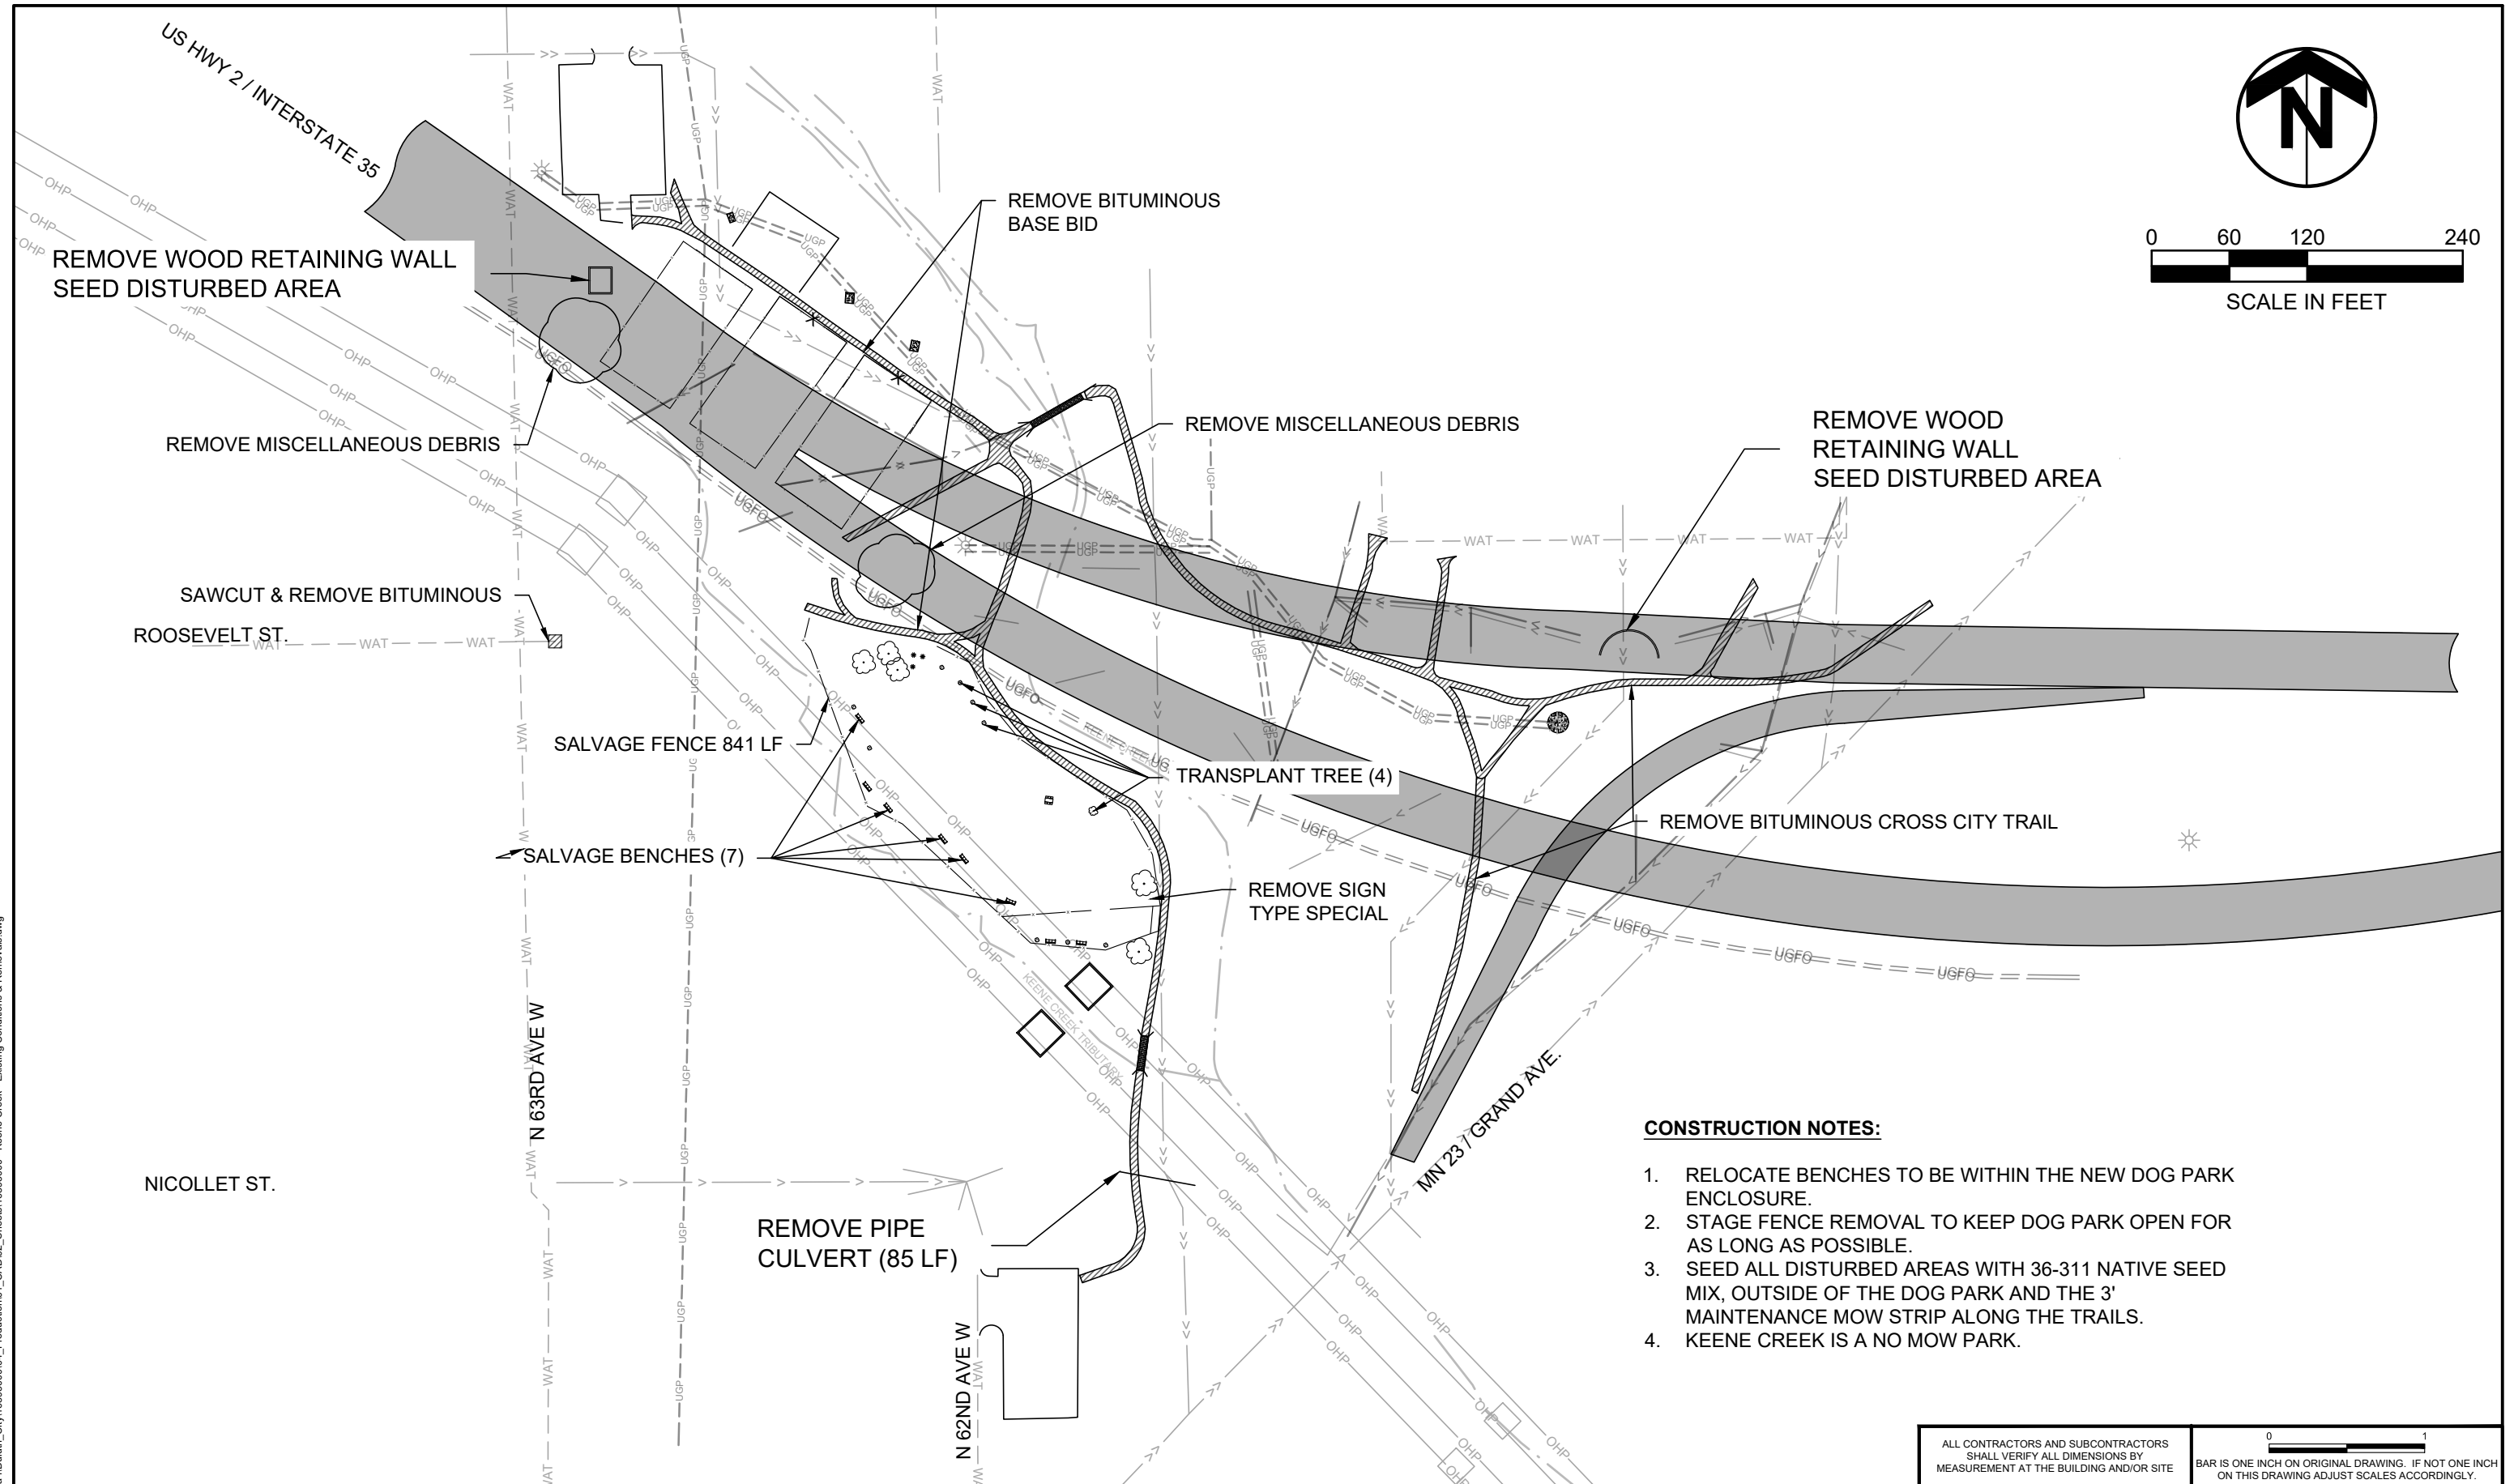
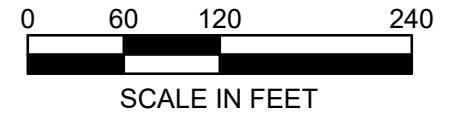
Discharges from basin dewatering operations that are turbid or sediment laden shall be discharged to temporary sediment basins constructed on the site to provide treatment prior to discharge to a water of the state.

16.

Clogged or compromised filters must be replaced. Where there is evidence of sediment accumulation adjacent to the inlet protection measure, deposited sediment shall be removed by the end of the same work day on which it is found or by the end of the following work day if removal by the same work day is not feasible.

17.

Accumulated sediment shall be removed where the depth of sediment has reached half of the working height of the sediment retaining device. Sediment shall be removed by the end of the work day on which it is found or by the end of the following work day if removal by the same work day is not feasible.
- PLOT DATE: Jul 02, 2020 - 1:26pm
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218.724.8578
tkda.com
DATE: 06/18/20
PRINTED NAME: WILL D. DEROCHER UIC NO.: 54757 |  |
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- SWPPP 2 OF 2
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16893.000 |
| | | DRAWING NO. |
| | | 016 |



CONSTRUCTION NOTES:

1. RELOCATE BENCHES TO BE WITHIN THE NEW DOG PARK ENCLOSURE.
2. STAGE FENCE REMOVAL TO KEEP DOG PARK OPEN FOR AS LONG AS POSSIBLE.
3. SEED ALL DISTURBED AREAS WITH 36-311 NATIVE SEED MIX, OUTSIDE OF THE DOG PARK AND THE 3' MAINTENANCE MOW STRIP ALONG THE TRAILS.
4. KEENE CREEK IS A NO MOW PARK.

ALL CONTRACTORS AND SUBCONTRACTORS SHALL VERIFY ALL DIMENSIONS BY MEASUREMENT AT THE BUILDING AND/OR SITE

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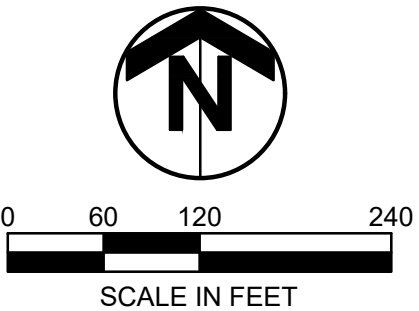
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SIGNATURE: *Will D. Derocher* DATE: 06/18/20
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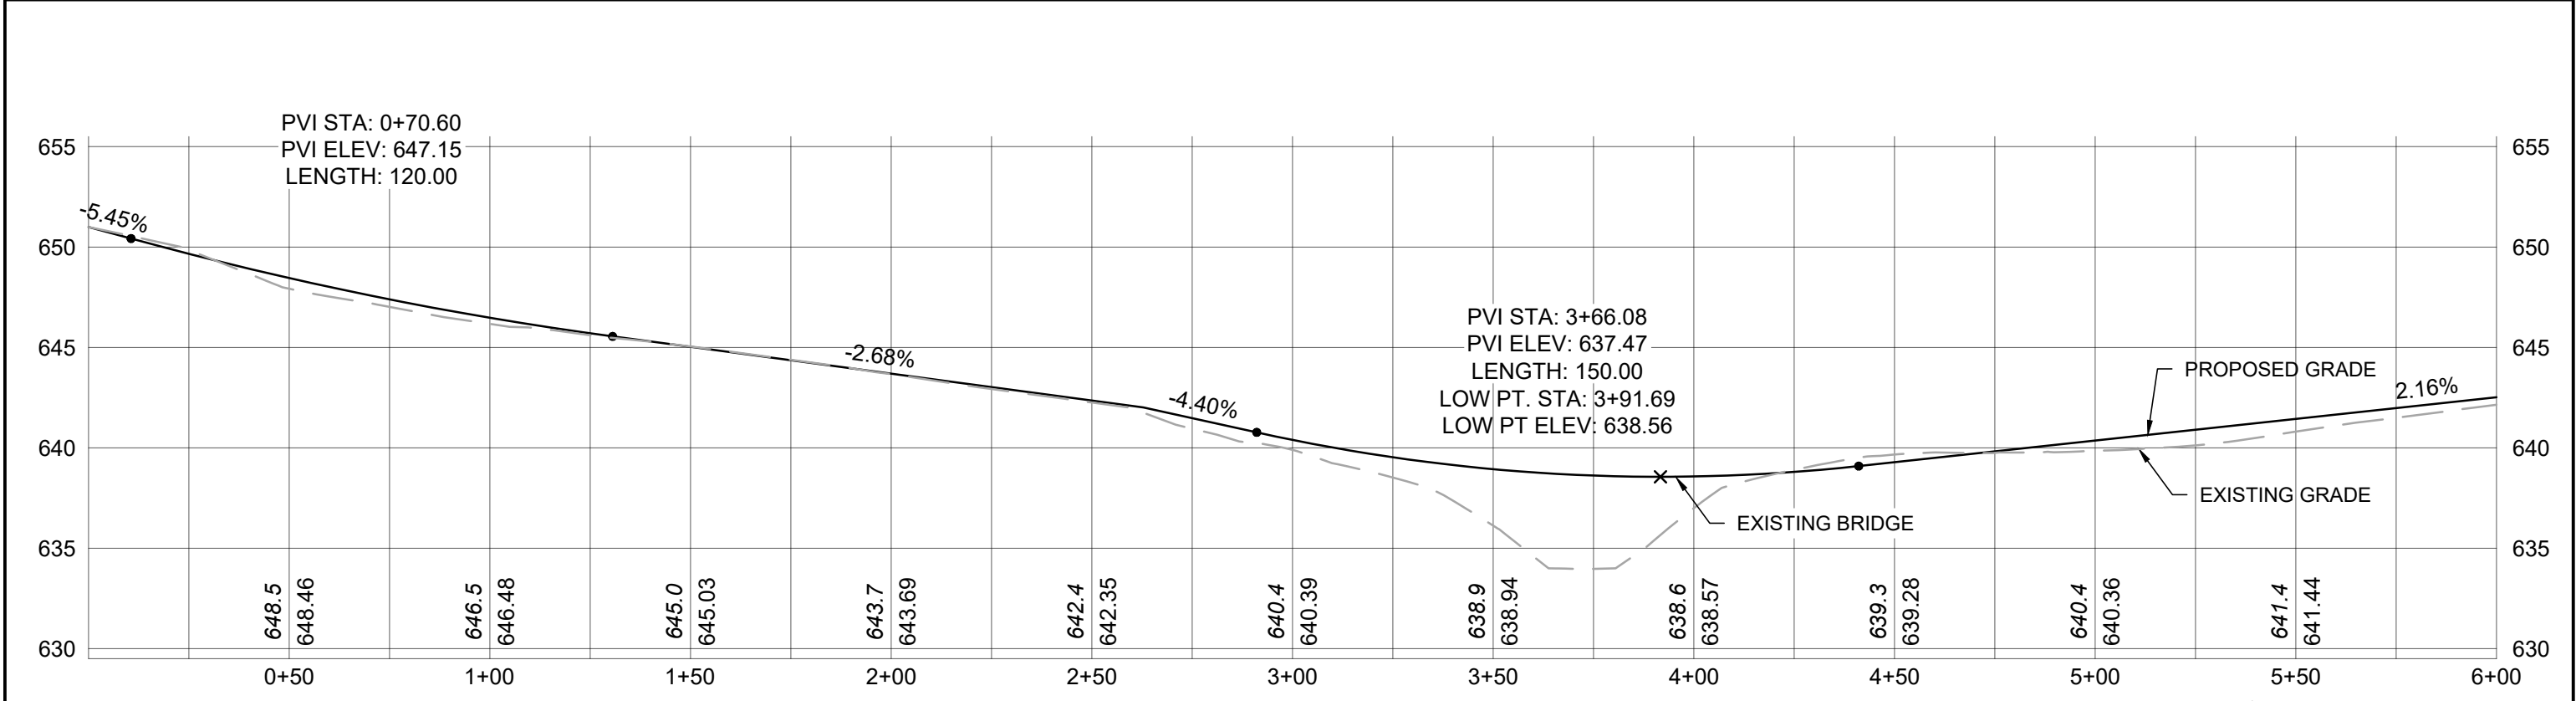
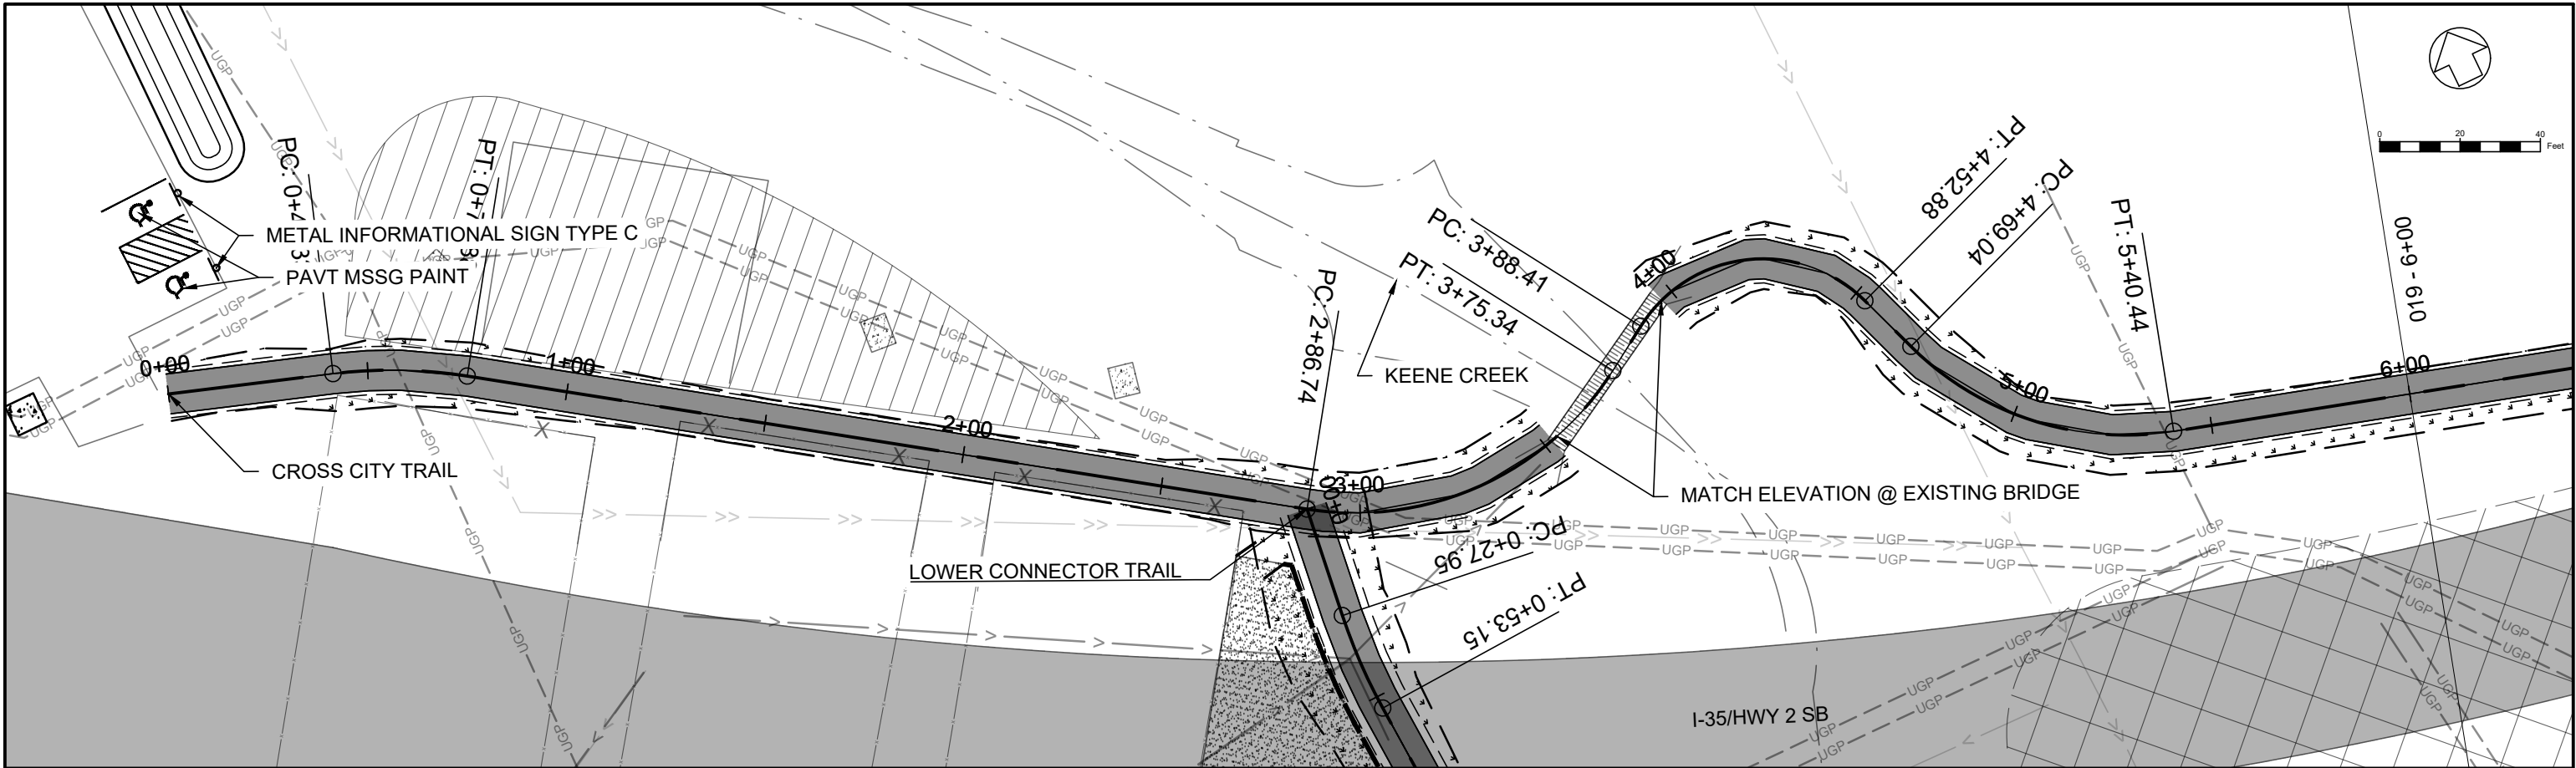
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EXISTING CONDITIONS

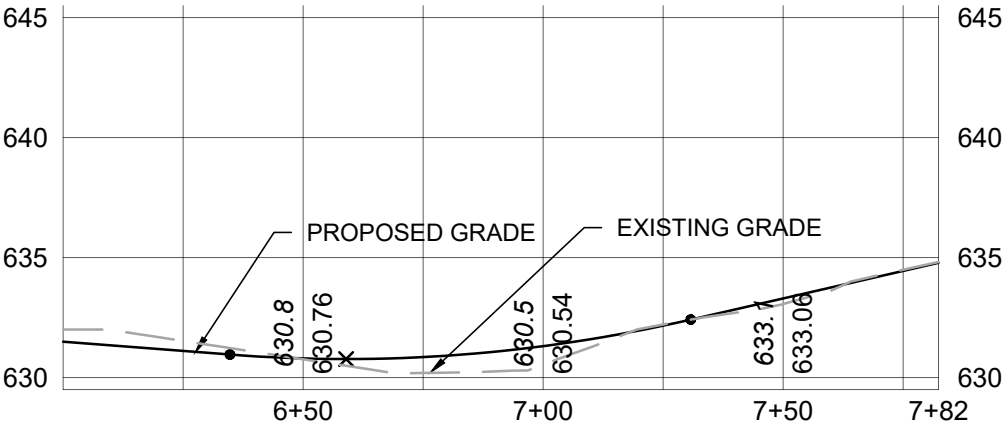
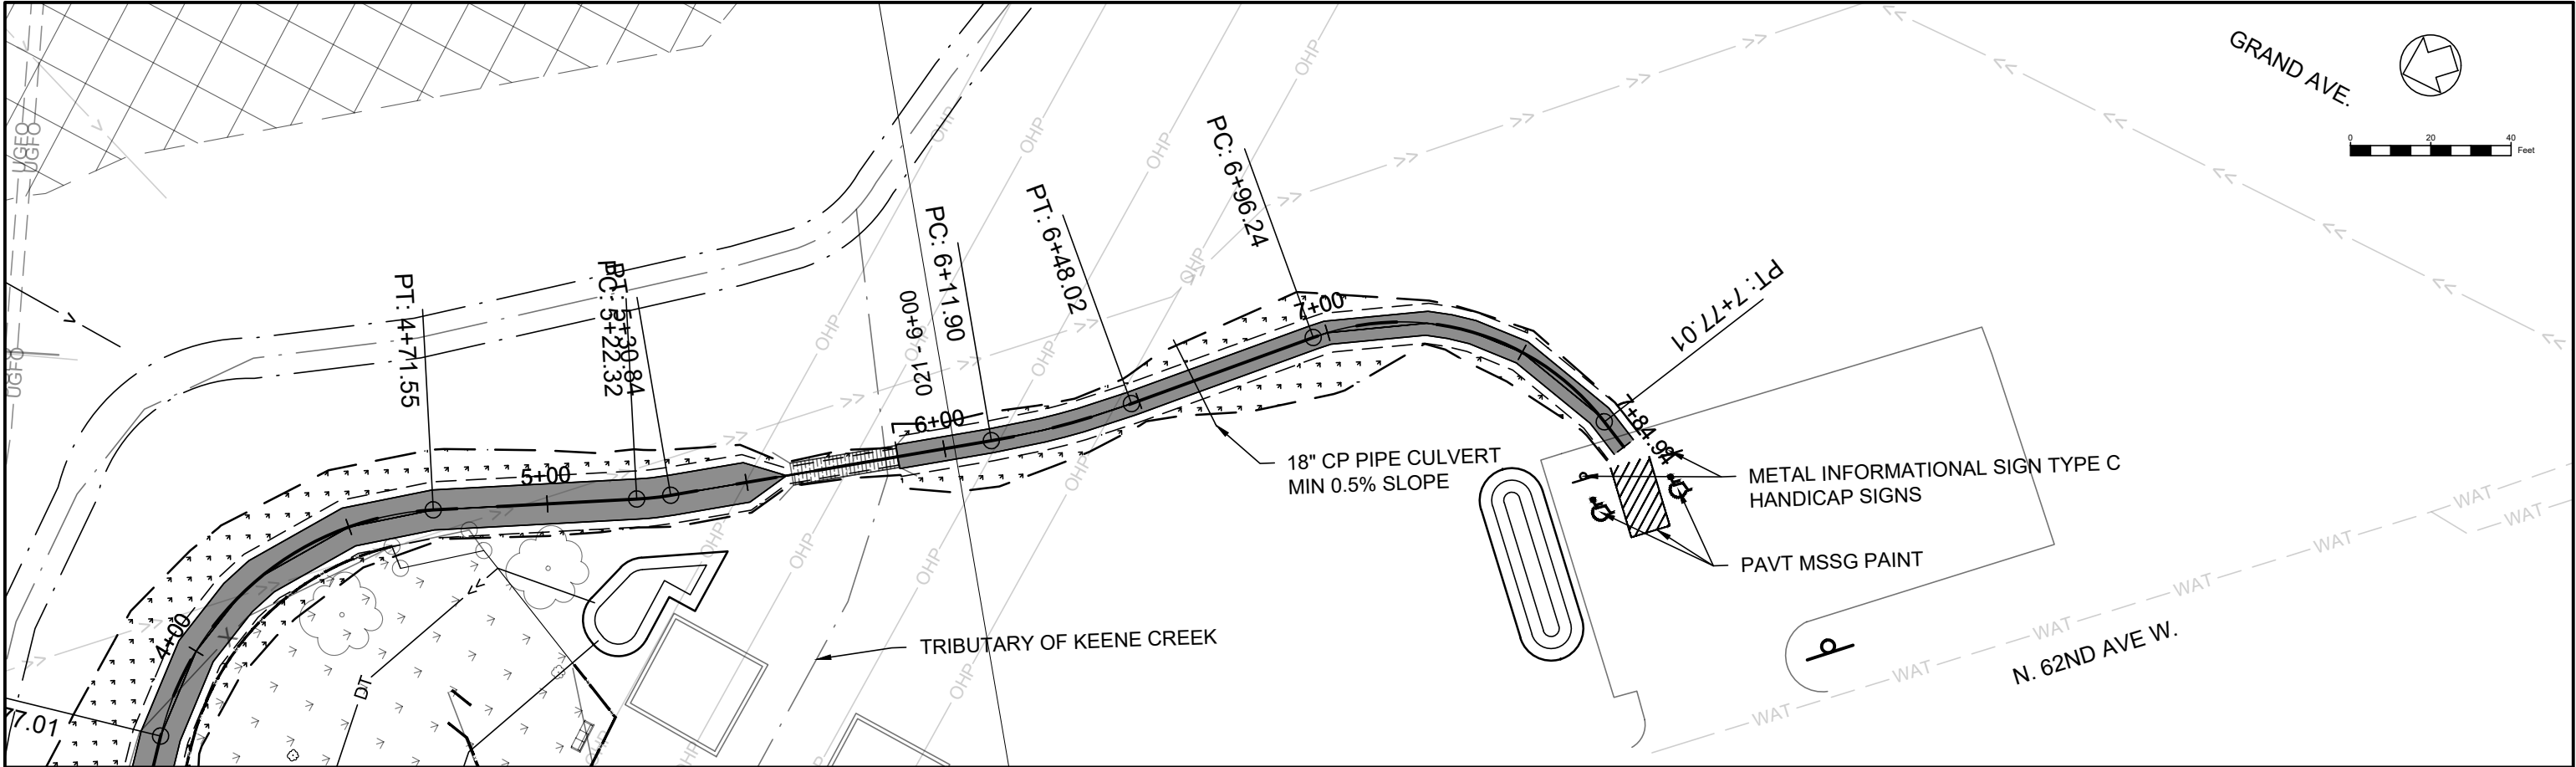
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<div style="text-align: center; font-size: 24px; font-weight: bold;">PROPOSED CONDITIONS</div>	PROJ. NO. 16893.000
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DRAWN WDD				11 E. Superior Street, Suite 420 Duluth, MN 55802 218.724.8578 tkda.com				CROSS CITY TRAIL PLAN & PROFILE				DRAWING NO. 019			
CHECKED JSG				SIGNATURE: <i>Will D. Derocher</i> DATE: 06/18/20 PRINTED NAME: WILL D. DEROCHE UC. NO.: 54757											
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PLOT DATE: Jul 02, 2020 - 1:29pm
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STATION 6+00 - 7+82
DOG PARK TRAIL PLAN & PROFILE

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PROJ. NO. 16893.000	DRAWING NO. 022



